


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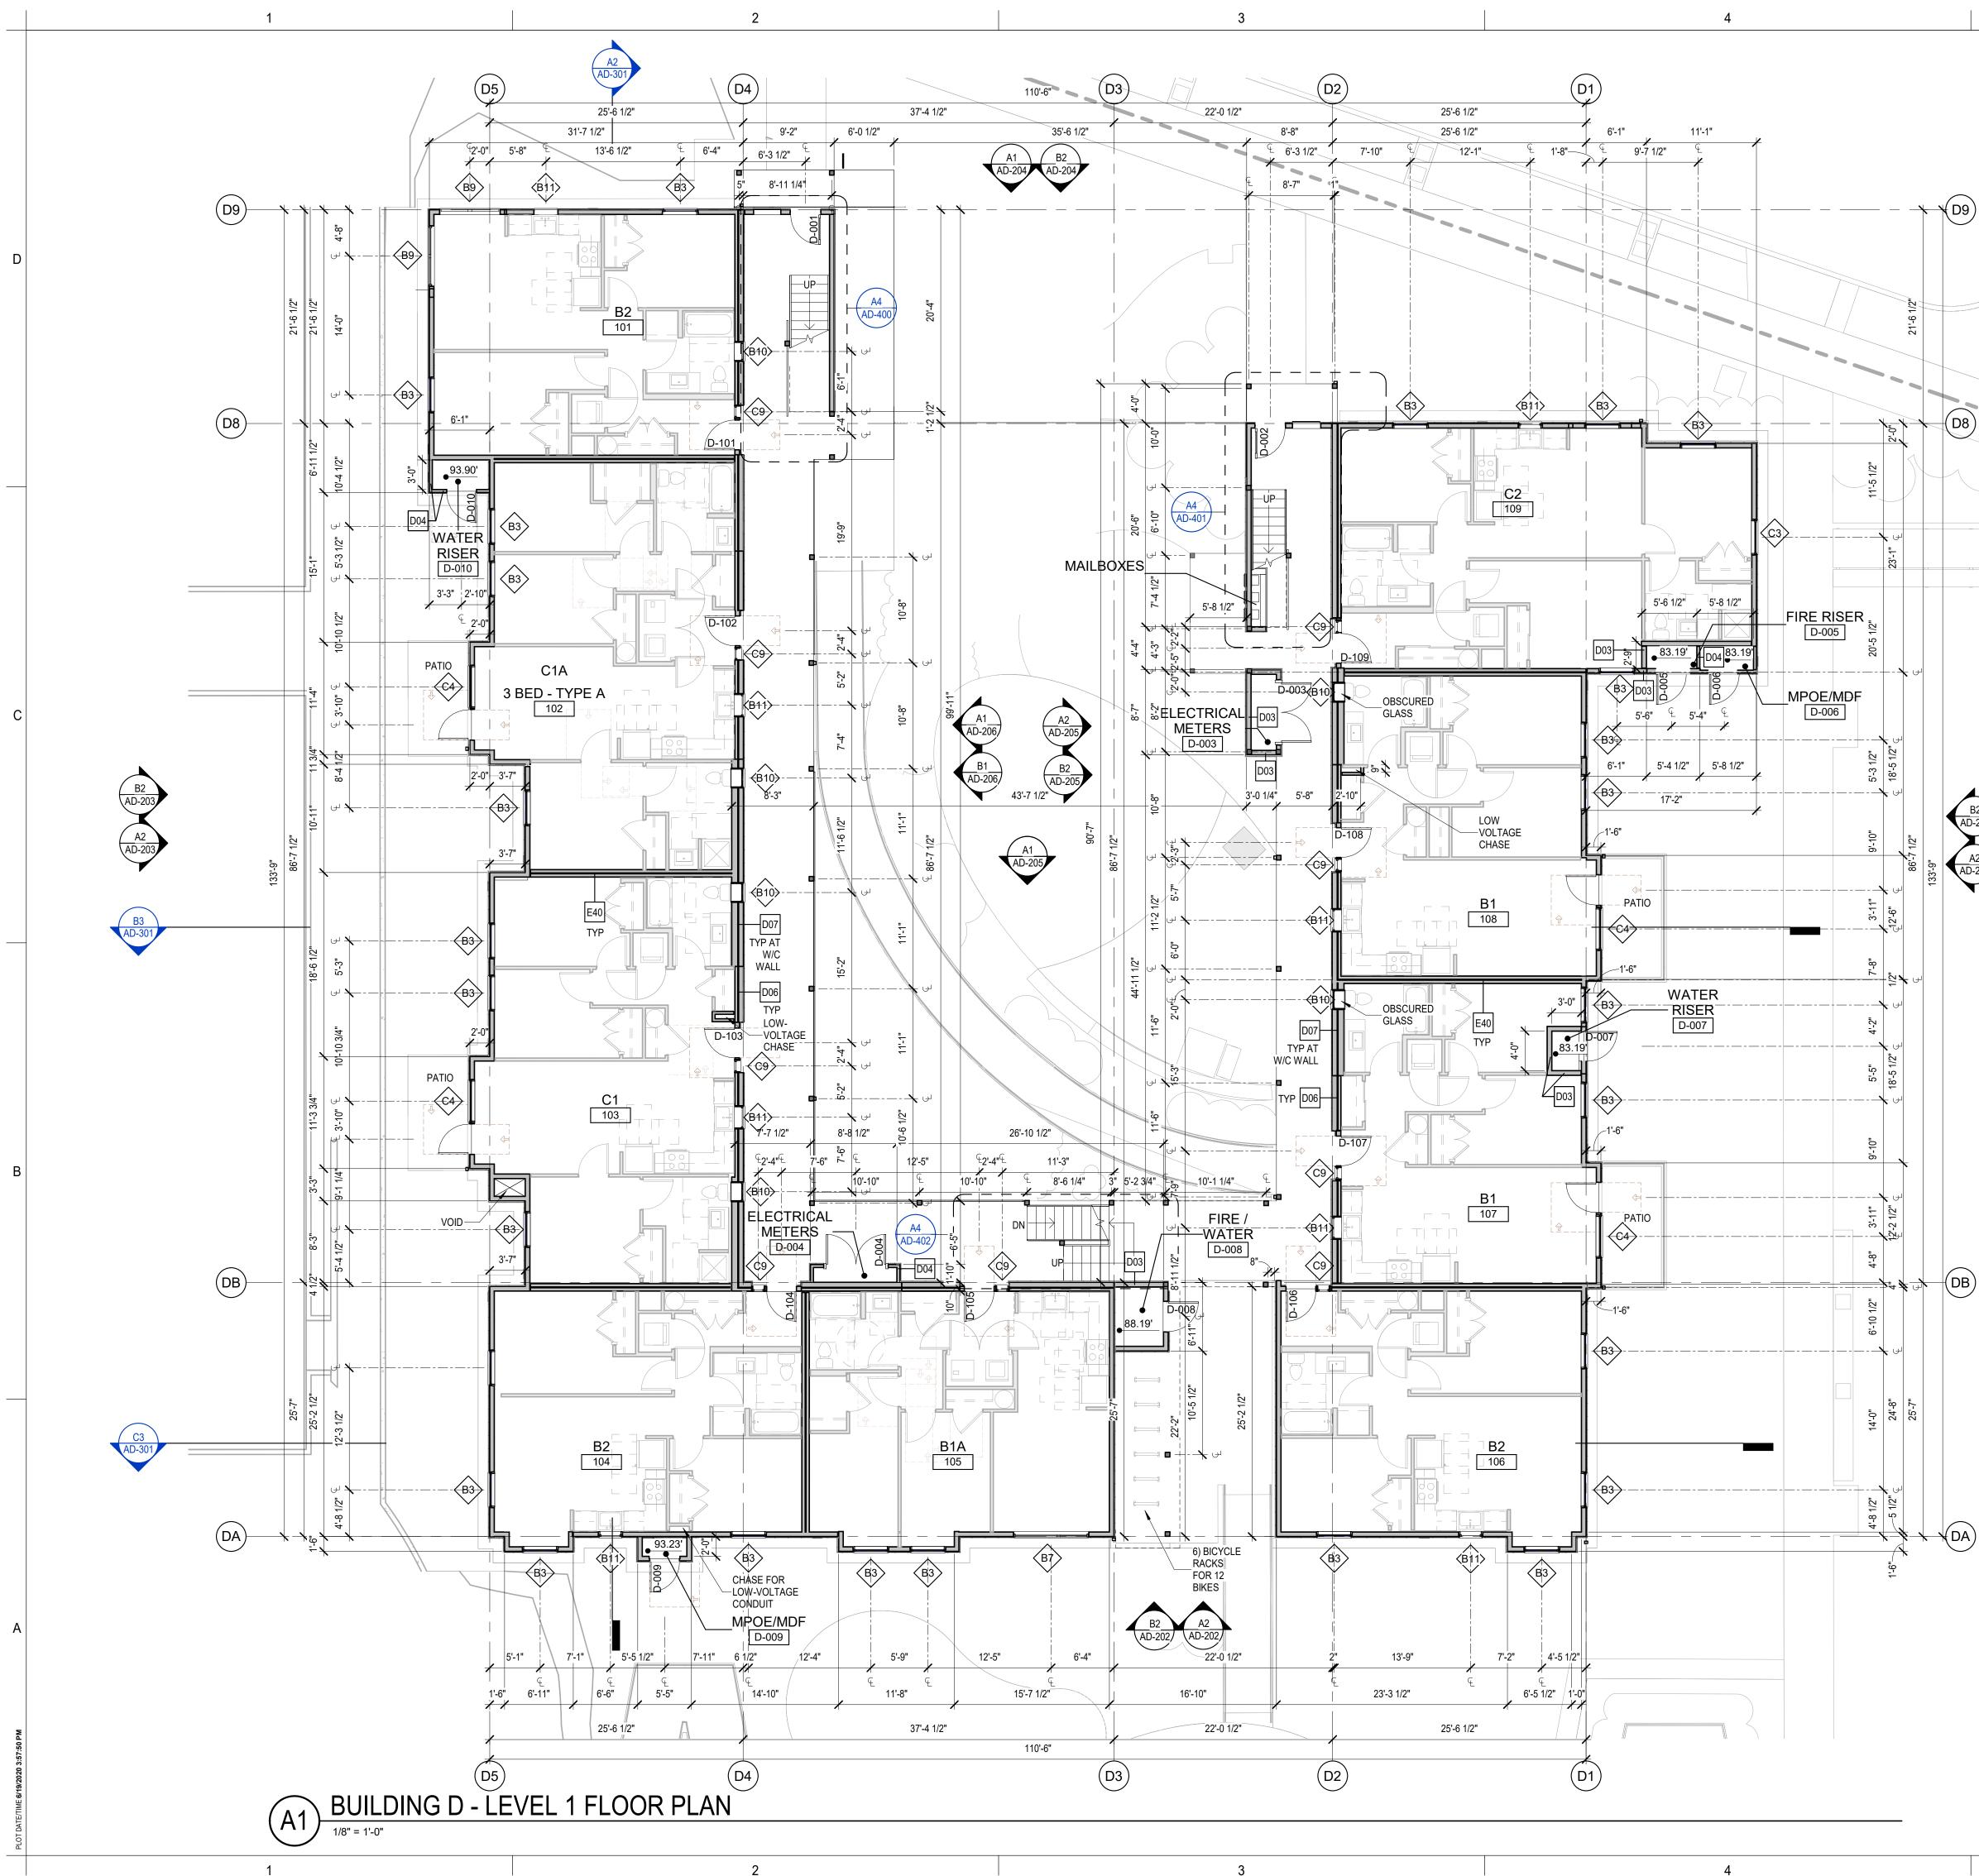
1301 First Avenue, Suite 301 Seattle, WA 98101 http://www.gglo.com

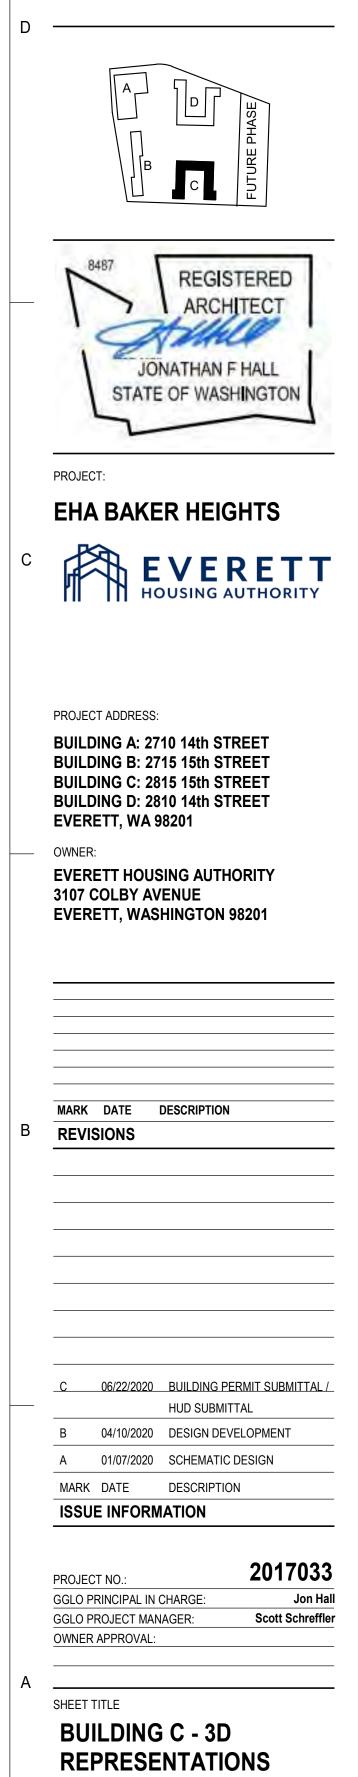

BUILDING PERMIT SUBMITTAL / HUD SUBMI

SHEET NO.

AC-700




GENERAL FLOOR PLAN NOTES

- 1. PLAN DIMENSIONS ARE TO FACE OF STUD, FACE OF CONCRETE WALL, CENTERLINE OF COLUMN, OR CENTERLINE OF ROUGH OPENINGS, UON. CONTACT ARCHITECT FOR CLARIFICATIONS.
- DOORS AND CASED OPENINGS INDICATED ADJACENT TO WALL INTERSECTIONS SHALL BE LOCATED WITH THE EDGE OF FINISH OPENING SIX INCHES FROM THE ADJACENT WALL AT THE EXTERIOR AND FOUR INCHES FROM THE ADJACENT WALL.
- SEE SHEET A-540 & A-620 FOR WINDOW LEGEND AND DETAILS. 3.
- SEE SHEET A-545 & A-615 FOR DOOR SCHEDULE AND DETAILS. 4.
- 5. SEE SHEET A-605 FOR WALL ASSEMBLIES.
- INSTALL BLOCKING FOR GRAB BARS IN ALL BATHROOM WALLS 6. SURROUNDING WATER CLOSET, BATHTUB AND SHOWER. REF A-501.
- HANDRAILS SHALL RETURN TO A WALL, GUARD OR THE WALKING SURFACE OR SHALL BE CONTINUOUS TO THE HANDRAIL OF AN ADJACENT STAIR FLIGHT OR RAMP RUN - PER IBC 1012.5.
- CONTRACTOR SHALL INSTALL FURRING, SHIMS AND ADDITIONAL LAYERS OF GYPSUM BOARD AS NECESSARY TO ACHIEVE FLUSH FINISH WHERE SURFACES OF ADJACENT WALL OR SHAFT ASSEMBLIES ARE NOT, BUT ARE INTENDED TO BE, ALIGNED.
- SEE SHEETS A-190 THROUGH A-193 FOR TYPICAL UNIT PLANS ENLARGED.

BUILDING D - UNIT COUNT

NAME	UNIT TYPE	NUMBER OF UNITS
B1	2 BED - STANDARD	6
B1A	2 BED - TYPE A	1
B2	2 BED - CORNER	9
C1	3 BED - STANDARD	5
C1A	3 BED - TYPE A	1
C2	3 BED - CORNER	1
TOTAL	•	23

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PROJECT ADDRESS:

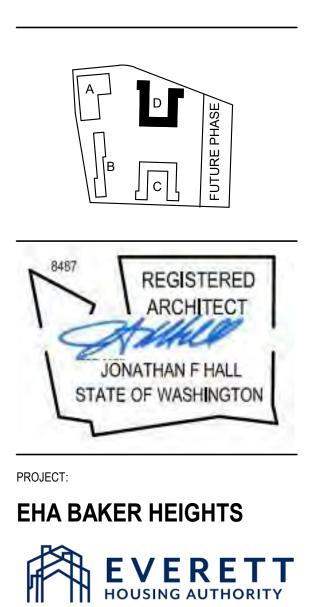BUILDING	A: 2710	14th	STREET
BUILDING	B: 2715	15th	STREET
BUILDING	C: 2815	15th	STREET
BUILDING	D: 2810	14th	STREET
EVERETT,	WA 982	01	
OWNER:			

EVERETT HOUSING AUTHORITY 3107 COLBY AVENUE **EVERETT, WASHINGTON 98201**

MARK	DATE	DESCRIPTION	
1	Date 1	Revision 1	

06/22/2020 BUILDING PERMIT SUBMITTAL

HUD SUBMITTAL

2017033

Scott Schreffler

Jon Hall

04/10/2020 DESIGN DEVELOPMENT

01/07/2020 SCHEMATIC DESIGN

MARK DATE DESCRIPTION

ISSUE INFORMATION

GGLO PRINCIPAL IN CHARGE:

MARK	DATE

1	Date 1
MARK	DATE
REVIS	SIONS

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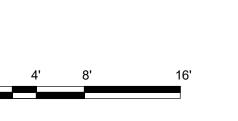
BUILDIN

	GGLO PROJECT MANAGER:	Scott Schr
	OWNER APPROVAL:	
А		
	SHEET TITLE	
	BUILDING D - LE	EVEL 1 -
	FLOOR PLAN	

SHEET NO.

AD-110

PROJECT NO .:



PLAN NORTH

5


COPYRIGHT GGLO. ALL RIGHTS RESERVED. ORIGINAL SHEET SIZE IS 24"x36"

H D8 B2 AD-20 A2 AD-201

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GGLO^N



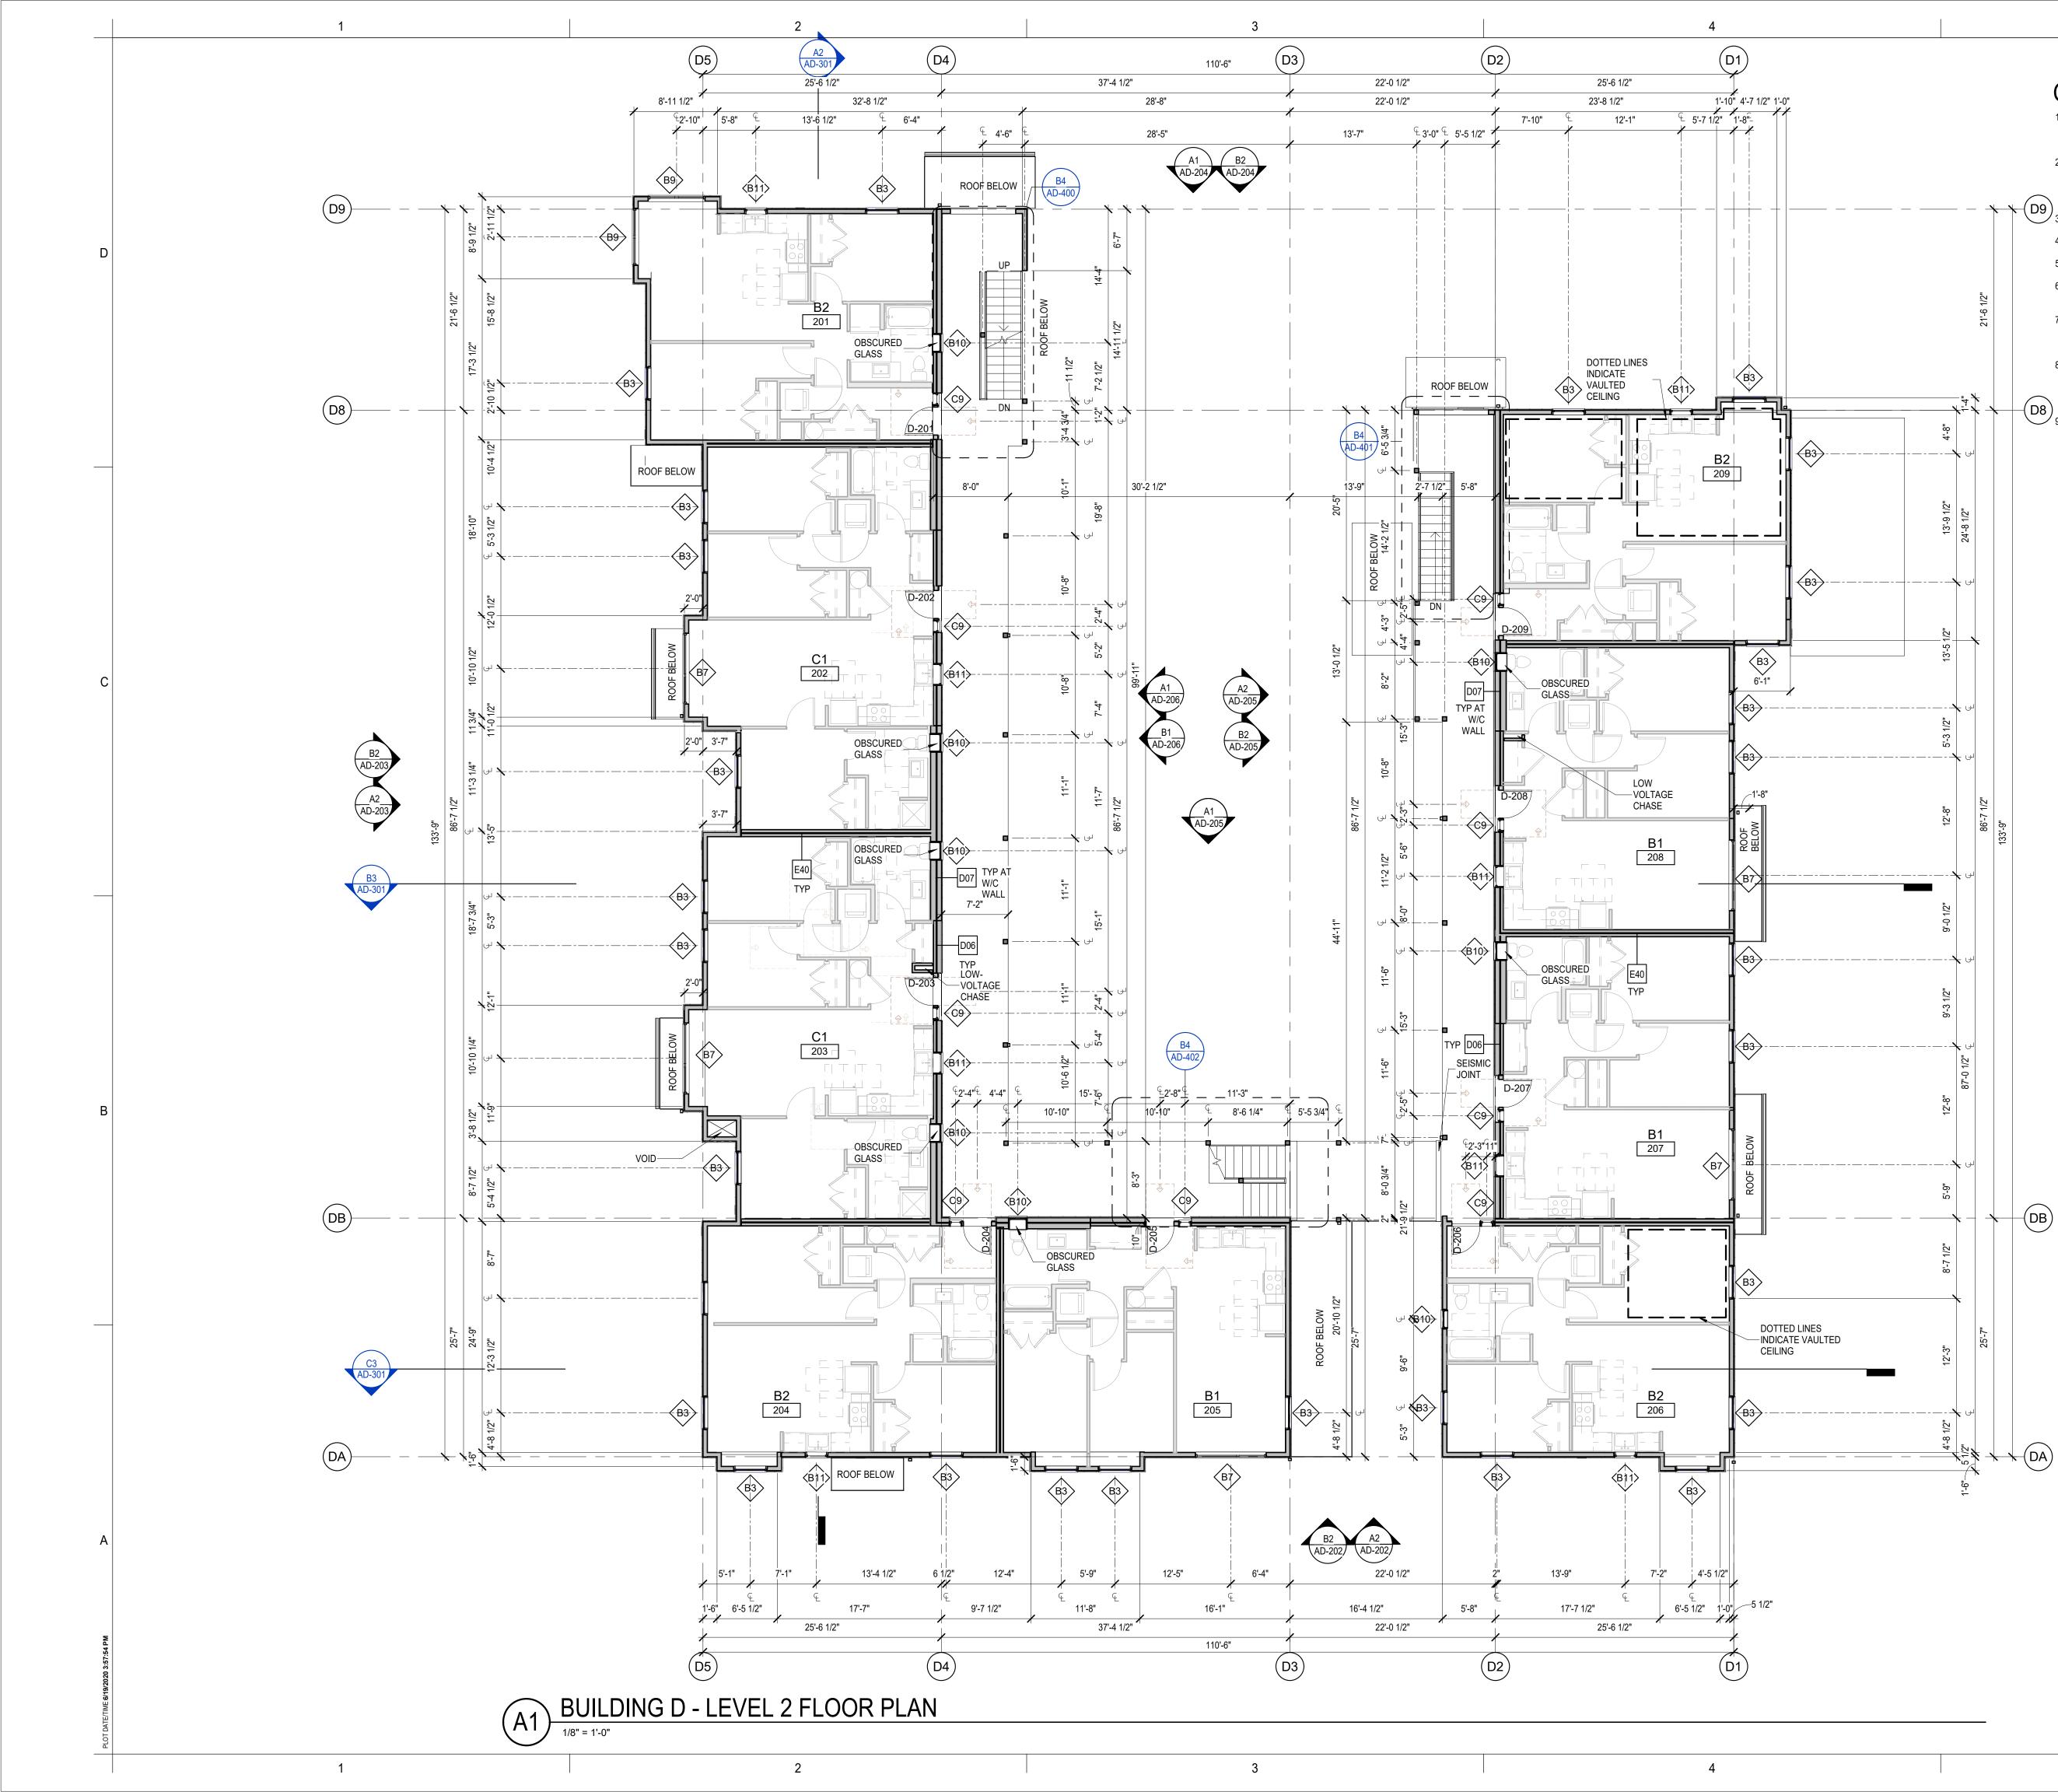

PLAN DIMENSIONS ARE TO FACE OF STUD, FACE OF CONCRETE WALL, CENTERLINE OF COLUMN, OR CENTERLINE OF ROUGH OPENINGS, UON. CONTACT ARCHITECT FOR CLARIFICATIONS.

DOORS AND CASED OPENINGS INDICATED ADJACENT TO WALL INTERSECTIONS SHALL BE LOCATED WITH THE EDGE OF FINISH OPENING SIX INCHES FROM THE ADJACENT WALL AT THE EXTERIOR AND FOUR INCHES FROM THE ADJACENT WALL.

SEE SHEET A-540 & A-620 FOR WINDOW LEGEND AND DETAILS.

SEE SHEET A-545 & A-615 FOR DOOR SCHEDULE AND DETAILS.

SEE SHEET A-605 FOR WALL ASSEMBLIES.

<u>+ + (</u>D9)


-(D8)

- INSTALL BLOCKING FOR GRAB BARS IN ALL BATHROOM WALLS SURROUNDING WATER CLOSET, BATHTUB AND SHOWER. REF A-501.
- HANDRAILS SHALL RETURN TO A WALL, GUARD OR THE WALKING SURFACE OR SHALL BE CONTINUOUS TO THE HANDRAIL OF AN ADJACENT STAIR FLIGHT OR RAMP RUN - PER IBC 1012.5.

CONTRACTOR SHALL INSTALL FURRING, SHIMS AND ADDITIONAL LAYERS OF GYPSUM BOARD AS NECESSARY TO ACHIEVE FLUSH FINISH WHERE SURFACES OF ADJACENT WALL OR SHAFT ASSEMBLIES ARE NOT, BUT ARE INTENDED TO BE, ALIGNED.

SEE SHEETS A-190 THROUGH A-193 FOR TYPICAL UNIT PLANS ENLARGED.

BU	ILDING D - UN	NIT COUNT
NAME	UNIT TYPE	NUMBER OF UNITS
B1	2 BED - STANDARD	6
B1A	2 BED - TYPE A	1
B2	2 BED - CORNER	g
C1	3 BED - STANDARD	5
C1A	3 BED - TYPE A	1
C2	3 BED - CORNER	1
TOTAL		23

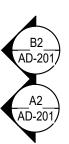





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8487 REGISTERED ARCHITECT JONATHAN F HALL STATE OF WASHINGTON PROJECT: **EHA BAKER HEIGHTS** HOUSING AUTHORITY PROJECT ADDRESS: BUILDING A: 2710 14th STREET BUILDING B: 2715 15th STREET BUILDING C: 2815 15th STREET BUILDING D: 2810 14th STREET **EVERETT, WA 98201** OWNER: EVERETT HOUSING AUTHORITY 3107 COLBY AVENUE **EVERETT, WASHINGTON 98201** Date 1 Revision 1 MARK DATE DESCRIPTION REVISIONS 06/22/2020 BUILDING PERMIT SUBMITTAL HUD SUBMITTAL 04/10/2020 DESIGN DEVELOPMENT A 01/07/2020 SCHEMATIC DESIGN MARK DATE DESCRIPTION **ISSUE INFORMATION** 2017033 PROJECT NO .: Jon Hall GGLO PRINCIPAL IN CHARGE: Scott Schreffler GGLO PROJECT MANAGER: OWNER APPROVAL SHEET TITLE **BUILDING D - LEVEL 2 -**FLOOR PLAN

GGLO^{NO}


1301 First Avenue, Suite 301

Seattle, WA 98101

http://www.gglo.com

SHEET NO.

AD-111

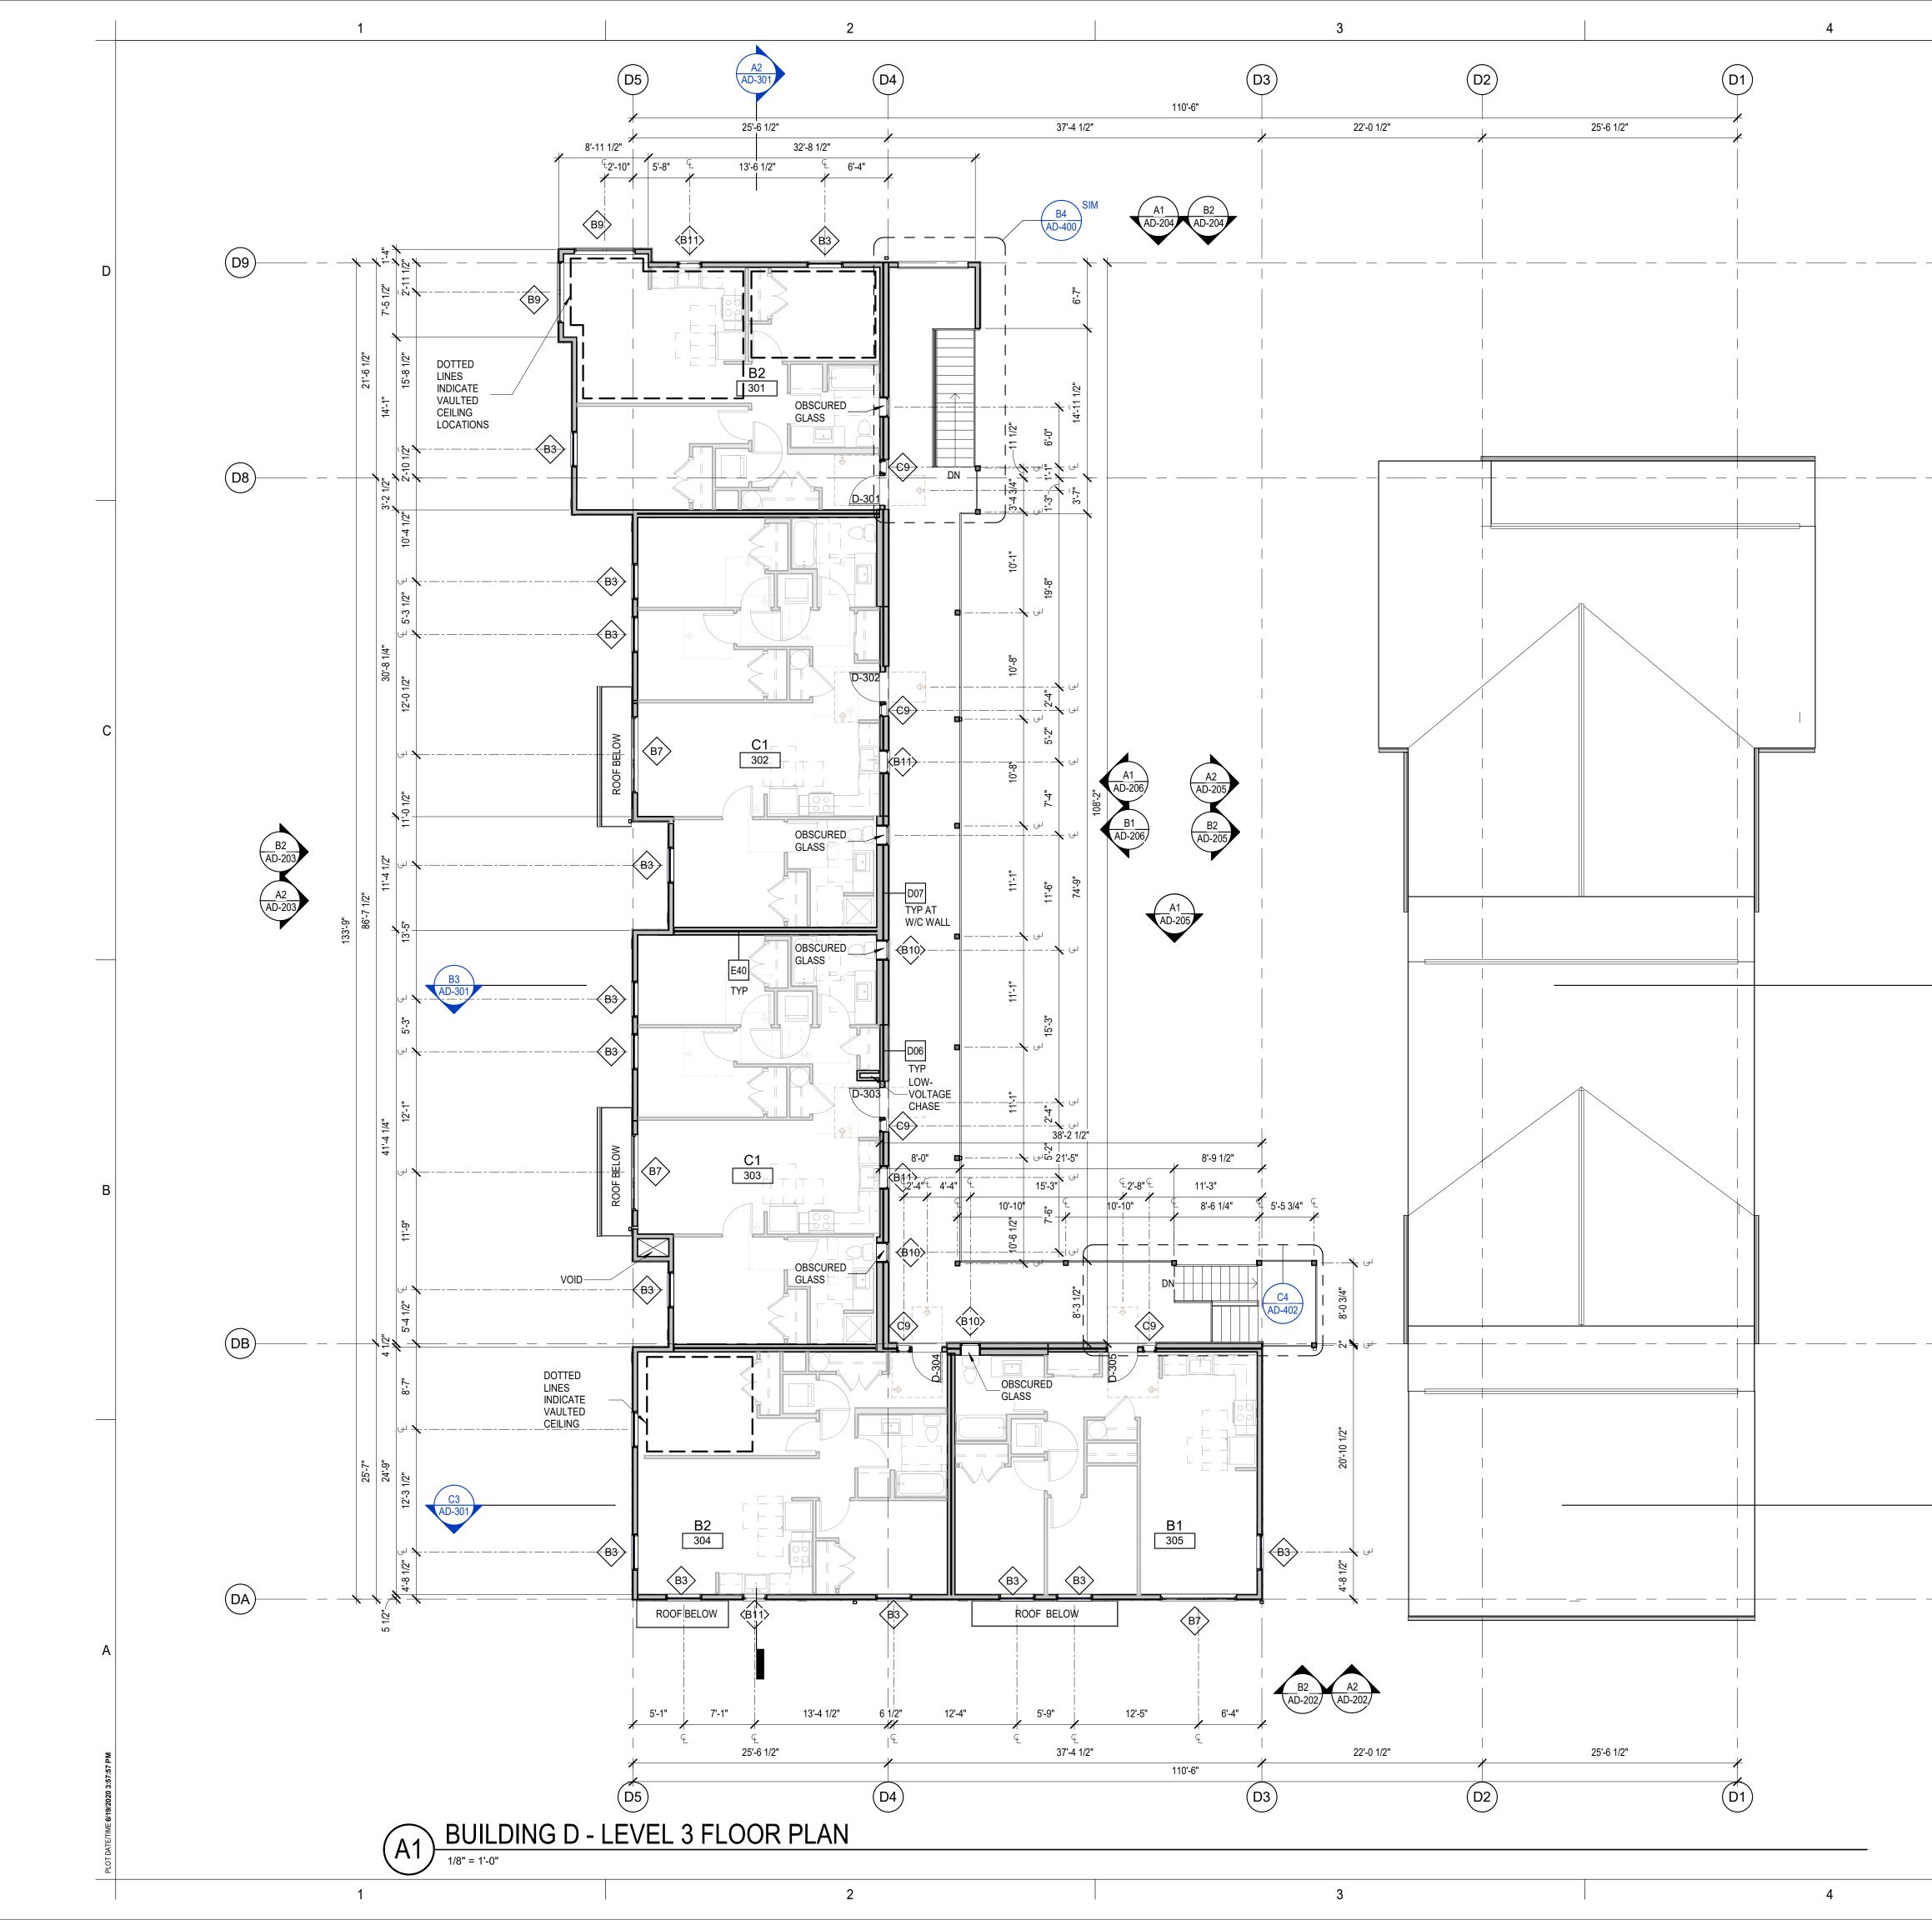

GENERAL FLOOR PLAN NOTES

- 1. PLAN DIMENSIONS ARE TO FACE OF STUD, FACE OF CONCRETE WALL, CENTERLINE OF COLUMN, OR CENTERLINE OF ROUGH OPENINGS, UON. CONTACT ARCHITECT FOR CLARIFICATIONS.
- DOORS AND CASED OPENINGS INDICATED ADJACENT TO WALL 2. INTERSECTIONS SHALL BE LOCATED WITH THE EDGE OF FINISH OPENING SIX INCHES FROM THE ADJACENT WALL AT THE EXTERIOR AND FOUR INCHES FROM THE ADJACENT WALL.
- 3. SEE SHEET A-540 & A-620 FOR WINDOW LEGEND AND DETAILS.
- SEE SHEET A-545 & A-615 FOR DOOR SCHEDULE AND DETAILS.
- SEE SHEET A-605 FOR WALL ASSEMBLIES. 5.

-(D9)

-(D8)

PLAN NORTH


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- INSTALL BLOCKING FOR GRAB BARS IN ALL BATHROOM WALLS 6. SURROUNDING WATER CLOSET, BATHTUB AND SHOWER. REF A-501.
- HANDRAILS SHALL RETURN TO A WALL, GUARD OR THE WALKING 7 SURFACE OR SHALL BE CONTINUOUS TO THE HANDRAIL OF AN ADJACENT STAIR FLIGHT OR RAMP RUN - PER IBC 1012.5.
- CONTRACTOR SHALL INSTALL FURRING, SHIMS AND ADDITIONAL 8. LAYERS OF GYPSUM BOARD AS NECESSARY TO ACHIEVE FLUSH FINISH WHERE SURFACES OF ADJACENT WALL OR SHAFT ASSEMBLIES ARE NOT, BUT ARE INTENDED TO BE, ALIGNED.
- 9. SEE SHEETS A-190 THROUGH A-193 FOR TYPICAL UNIT PLANS ENLARGED.

BL	JILDING D - UN	IIT COUNT
NAME	UNIT TYPE	NUMBER OF UNITS
B1	2 BED - STANDARD	6
B1A	2 BED - TYPE A	1
B2	2 BED - CORNER	9
C1	3 BED - STANDARD	5
C1A	3 BED - TYPE A	1
C2	3 BED - CORNER	1
TOTAL		23

GGLO

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PROJECT ADDRESS:

BUILDING A: 2710 14th STREET BUILDING B: 2715 15th STREET BUILDING C: 2815 15th STREET BUILDING D: 2810 14th STREET **EVERETT, WA 98201**

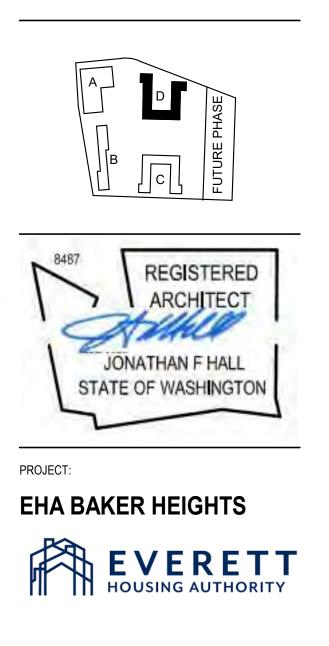OWNER:

EVERETT HOUSING AUTHORITY 3107 COLBY AVENUE **EVERETT, WASHINGTON 98201**

Date 1 Revision 1 MARK DATE DESCRIPTION REVISIONS

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BUILDIN

PROJECT NO .: GGLO PRINCIPAL IN CHARGE: GGLO PROJECT MANAGER: **OWNER APPROVAL**

SHEET TITLE

2017033 Jon Hall

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Scott Schreffler

C 06/22/2020 BUILDING PERMIT SUBMITTAL HUD SUBMITTAL

04/10/2020 DESIGN DEVELOPMENT

BUILDING D - LEVEL 3 -

ISSUE INFORMATION

MARK DATE DESCRIPTION








A 01/07/2020 SCHEMATIC DESIGN





AD-112


FLOOR PLAN

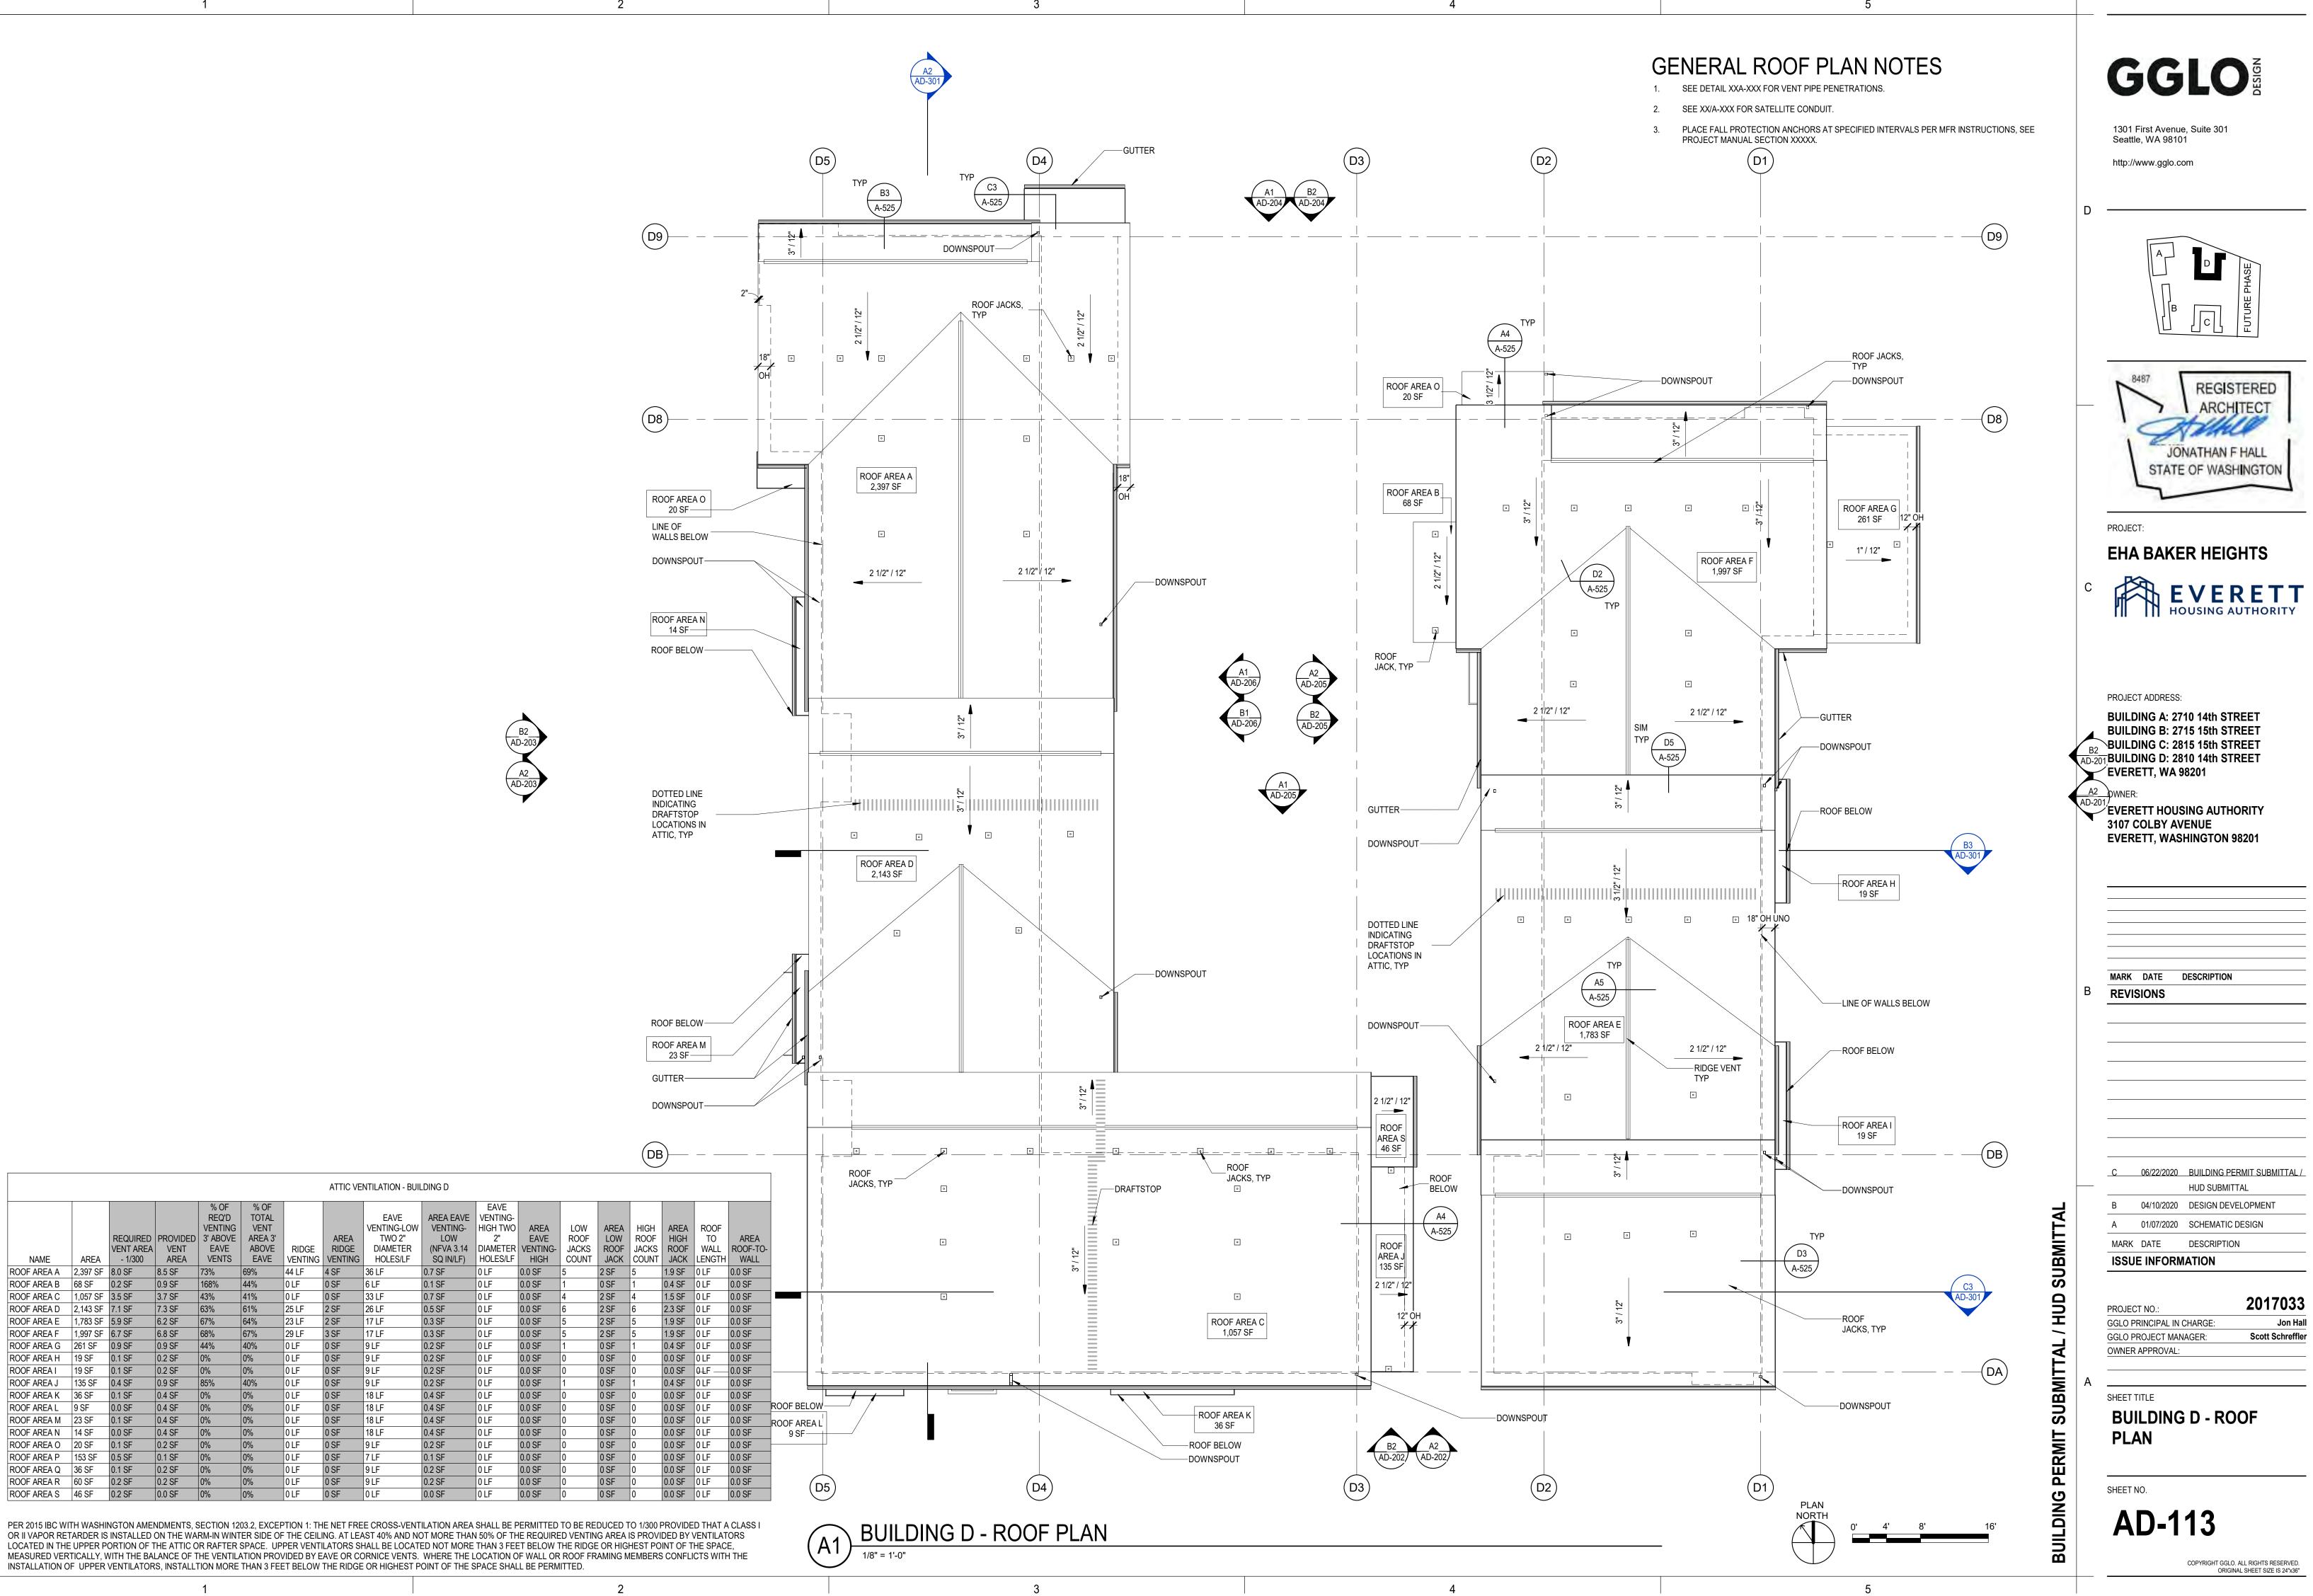

_		ATTIC VENTILATION - BUILDING D																
	NAME	AREA	REQUIRED VENT AREA - 1/300	PROVIDED VENT AREA	% OF REQ'D VENTING 3' ABOVE EAVE VENTS	% OF TOTAL VENT AREA 3' ABOVE EAVE	RIDGE	AREA RIDGE VENTING	EAVE VENTING-LOW TWO 2" DIAMETER HOLES/LF	AREA EAVE VENTING- LOW (NFVA 3.14 SQ IN/LF)	EAVE VENTING- HIGH TWO 2" DIAMETER HOLES/LF	EAVE	LOW ROOF JACKS COUNT	AREA LOW ROOF JACK	HIGH ROOF JACKS COUNT	AREA HIGH ROOF JACK	ROOF TO WALL LENGTH	ARE ROOF- WAL
	ROOF AREA A	2,397 SF	8.0 SF	8.5 SF	73%	69%	44 LF	4 SF	36 LF	0.7 SF	0 LF	0.0 SF	5	2 SF	5	1.9 SF	0 LF	0.0 SF
	ROOF AREA B	68 SF	0.2 SF	0.9 SF	168%	44%	0 LF	0 SF	6 LF	0.1 SF	0 LF	0.0 SF	1	0 SF	1	0.4 SF	0 LF	0.0 SF
	ROOF AREA C	1,057 SF	3.5 SF	3.7 SF	43%	41%	0 LF	0 SF	33 LF	0.7 SF	0 LF	0.0 SF	4	2 SF	4	1.5 SF	0 LF	0.0 SF
	ROOF AREA D	2,143 SF	7.1 SF	7.3 SF	63%	61%	25 LF	2 SF	26 LF	0.5 SF	0 LF	0.0 SF	6	2 SF	6	2.3 SF	0 LF	0.0 SF
	ROOF AREA E	1,783 SF	5.9 SF	6.2 SF	67%	64%	23 LF	2 SF	17 LF	0.3 SF	0 LF	0.0 SF	5	2 SF	5	1.9 SF	0 LF	0.0 SF
	ROOF AREA F	1,997 SF	6.7 SF	6.8 SF	68%	67%	29 LF	3 SF	17 LF	0.3 SF	0 LF	0.0 SF	5	2 SF	5	1.9 SF	0 LF	0.0 SF
	ROOF AREA G	261 SF	0.9 SF	0.9 SF	44%	40%	0 LF	0 SF	9 LF	0.2 SF	0 LF	0.0 SF	1	0 SF	1	0.4 SF	0 LF	0.0 SF
	ROOF AREA H	19 SF	0.1 SF	0.2 SF	0%	0%	0 LF	0 SF	9 LF	0.2 SF	0 LF	0.0 SF	0	0 SF	0	0.0 SF	0 LF	0.0 SF
	ROOF AREA I	19 SF	0.1 SF	0.2 SF	0%	0%	0 LF	0 SF	9 LF	0.2 SF	0 LF	0.0 SF	0	0 SF	0	0.0 SF	0-LF	0.0 SF
4	ROOF AREA J	135 SF	0.4 SF	0.9 SF	85%	40%	0 LF	0 SF	9 LF	0.2 SF	0 LF	0.0 SF	1	0 SF	1	0.4 SF	0 LF	0.0 SF
	ROOF AREA K	36 SF	0.1 SF	0.4 SF	0%	0%	0 LF	0 SF	18 LF	0.4 SF	0 LF	0.0 SF	0	0 SF	0	0.0 SF	0 LF	0.0 SF
	ROOF AREA L	9 SF	0.0 SF	0.4 SF	0%	0%	0 LF	0 SF	18 LF	0.4 SF	0 LF	0.0 SF	0	0 SF	0	0.0 SF	0 LF	0.0 SF
	ROOF AREA M	23 SF	0.1 SF	0.4 SF	0%	0%		0 SF	18 LF	0.4 SF	0 LF	0.0 SF		0 SF			0 LF	0.0 SF
	ROOF AREA N	14 SF	0.0 SF	0.4 SF	0%	0%	0 LF	0 SF	18 LF	0.4 SF	0 LF	0.0 SF	0	0 SF	0	0.0 SF	0 LF	0.0 SF
	ROOF AREA O	20 SF	0.1 SF	0.2 SF	0%	0%	0 LF	0 SF	9 LF	0.2 SF	0 LF	0.0 SF	0	0 SF	0	0.0 SF	0 LF	0.0 SF
	ROOF AREA P	153 SF	0.5 SF	0.1 SF	0%	0%	0 LF	0 SF	7 LF	0.1 SF	0 LF	0.0 SF	0	0 SF	0	0.0 SF	0 LF	0.0 SF
Σ	ROOF AREA Q	36 SF	0.1 SF	0.2 SF	0%	0%	0 LF	0 SF	9 LF	0.2 SF	0 LF	0.0 SF	0	0 SF	0	0.0 SF	0 LF	0.0 SF
:29	ROOF AREA R	60 SF	0.2 SF	0.2 SF	0%	0%	0 LF	0 SF	9 LF	0.2 SF		0.0 SF	0	0 SF	0		0 LF	0.0 SF
3:57	ROOF AREA S	46 SF	0.2 SF	0.0 SF	0%	0%	0 LF	0 SF	0 LF	0.0 SF	0 LF	0.0 SF	0	0 SF	0	0.0 SF	0 LF	0.0 SF

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LOCATED IN THE UPPER PORTION OF THE ATTIC OR RAFTER SPACE. UPPER VENTILATORS SHALL BE LOCATED NOT MORE THAN 3 FEET BELOW THE RIDGE OR HIGHEST POINT OF THE SPACE. INSTALLATION OF UPPER VENTILATORS, INSTALLTION MORE THAN 3 FEET BELOW THE RIDGE OR HIGHEST POINT OF THE SPACE SHALL BE PERMITTED.

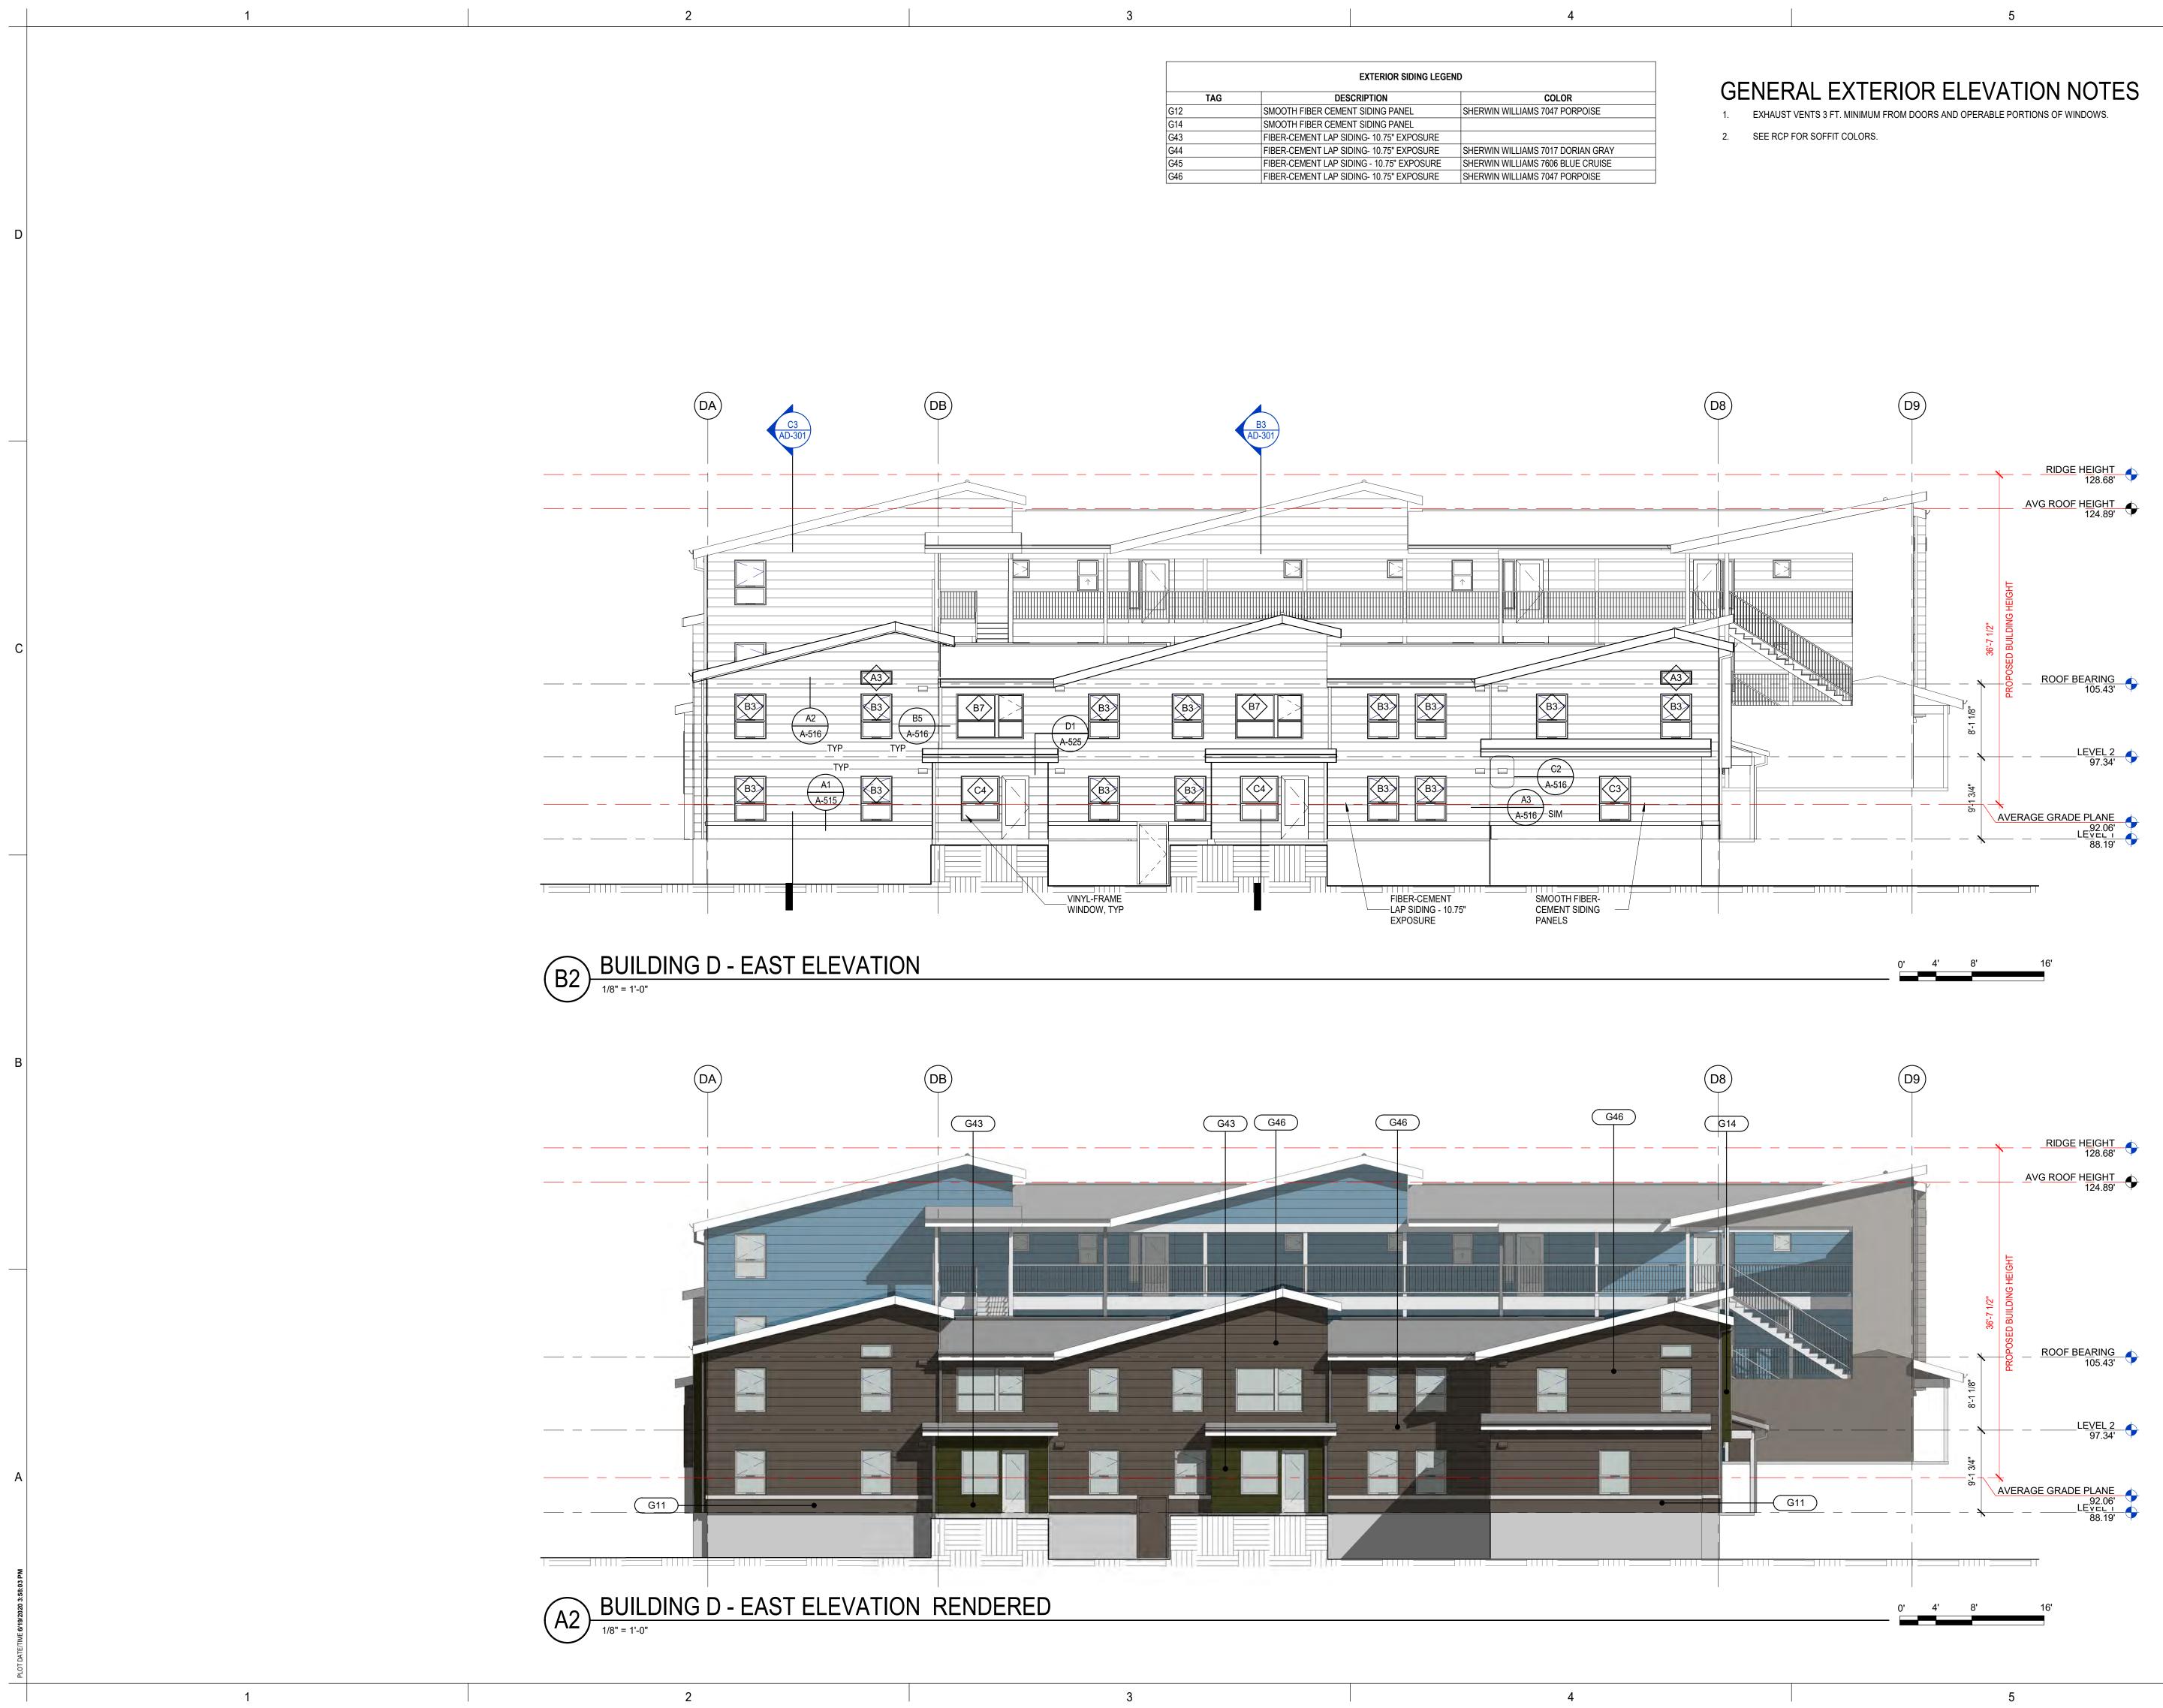

EXTERIOR SIDING LEGEND				
TAG	DESCRIPTION	COLOR		
G12	SMOOTH FIBER CEMENT SIDING PANEL	SHERWIN WILLIAMS 7047 PORPOISE		
G14	SMOOTH FIBER CEMENT SIDING PANEL			
G43	FIBER-CEMENT LAP SIDING- 10.75" EXPOSURE			
G44	FIBER-CEMENT LAP SIDING- 10.75" EXPOSURE	SHERWIN WILLIAMS 7017 DORIAN GRAY		
G45	FIBER-CEMENT LAP SIDING - 10.75" EXPOSURE	SHERWIN WILLIAMS 7606 BLUE CRUISE		
G46	FIBER-CEMENT LAP SIDING- 10.75" EXPOSURE	SHERWIN WILLIAMS 7047 PORPOISE		

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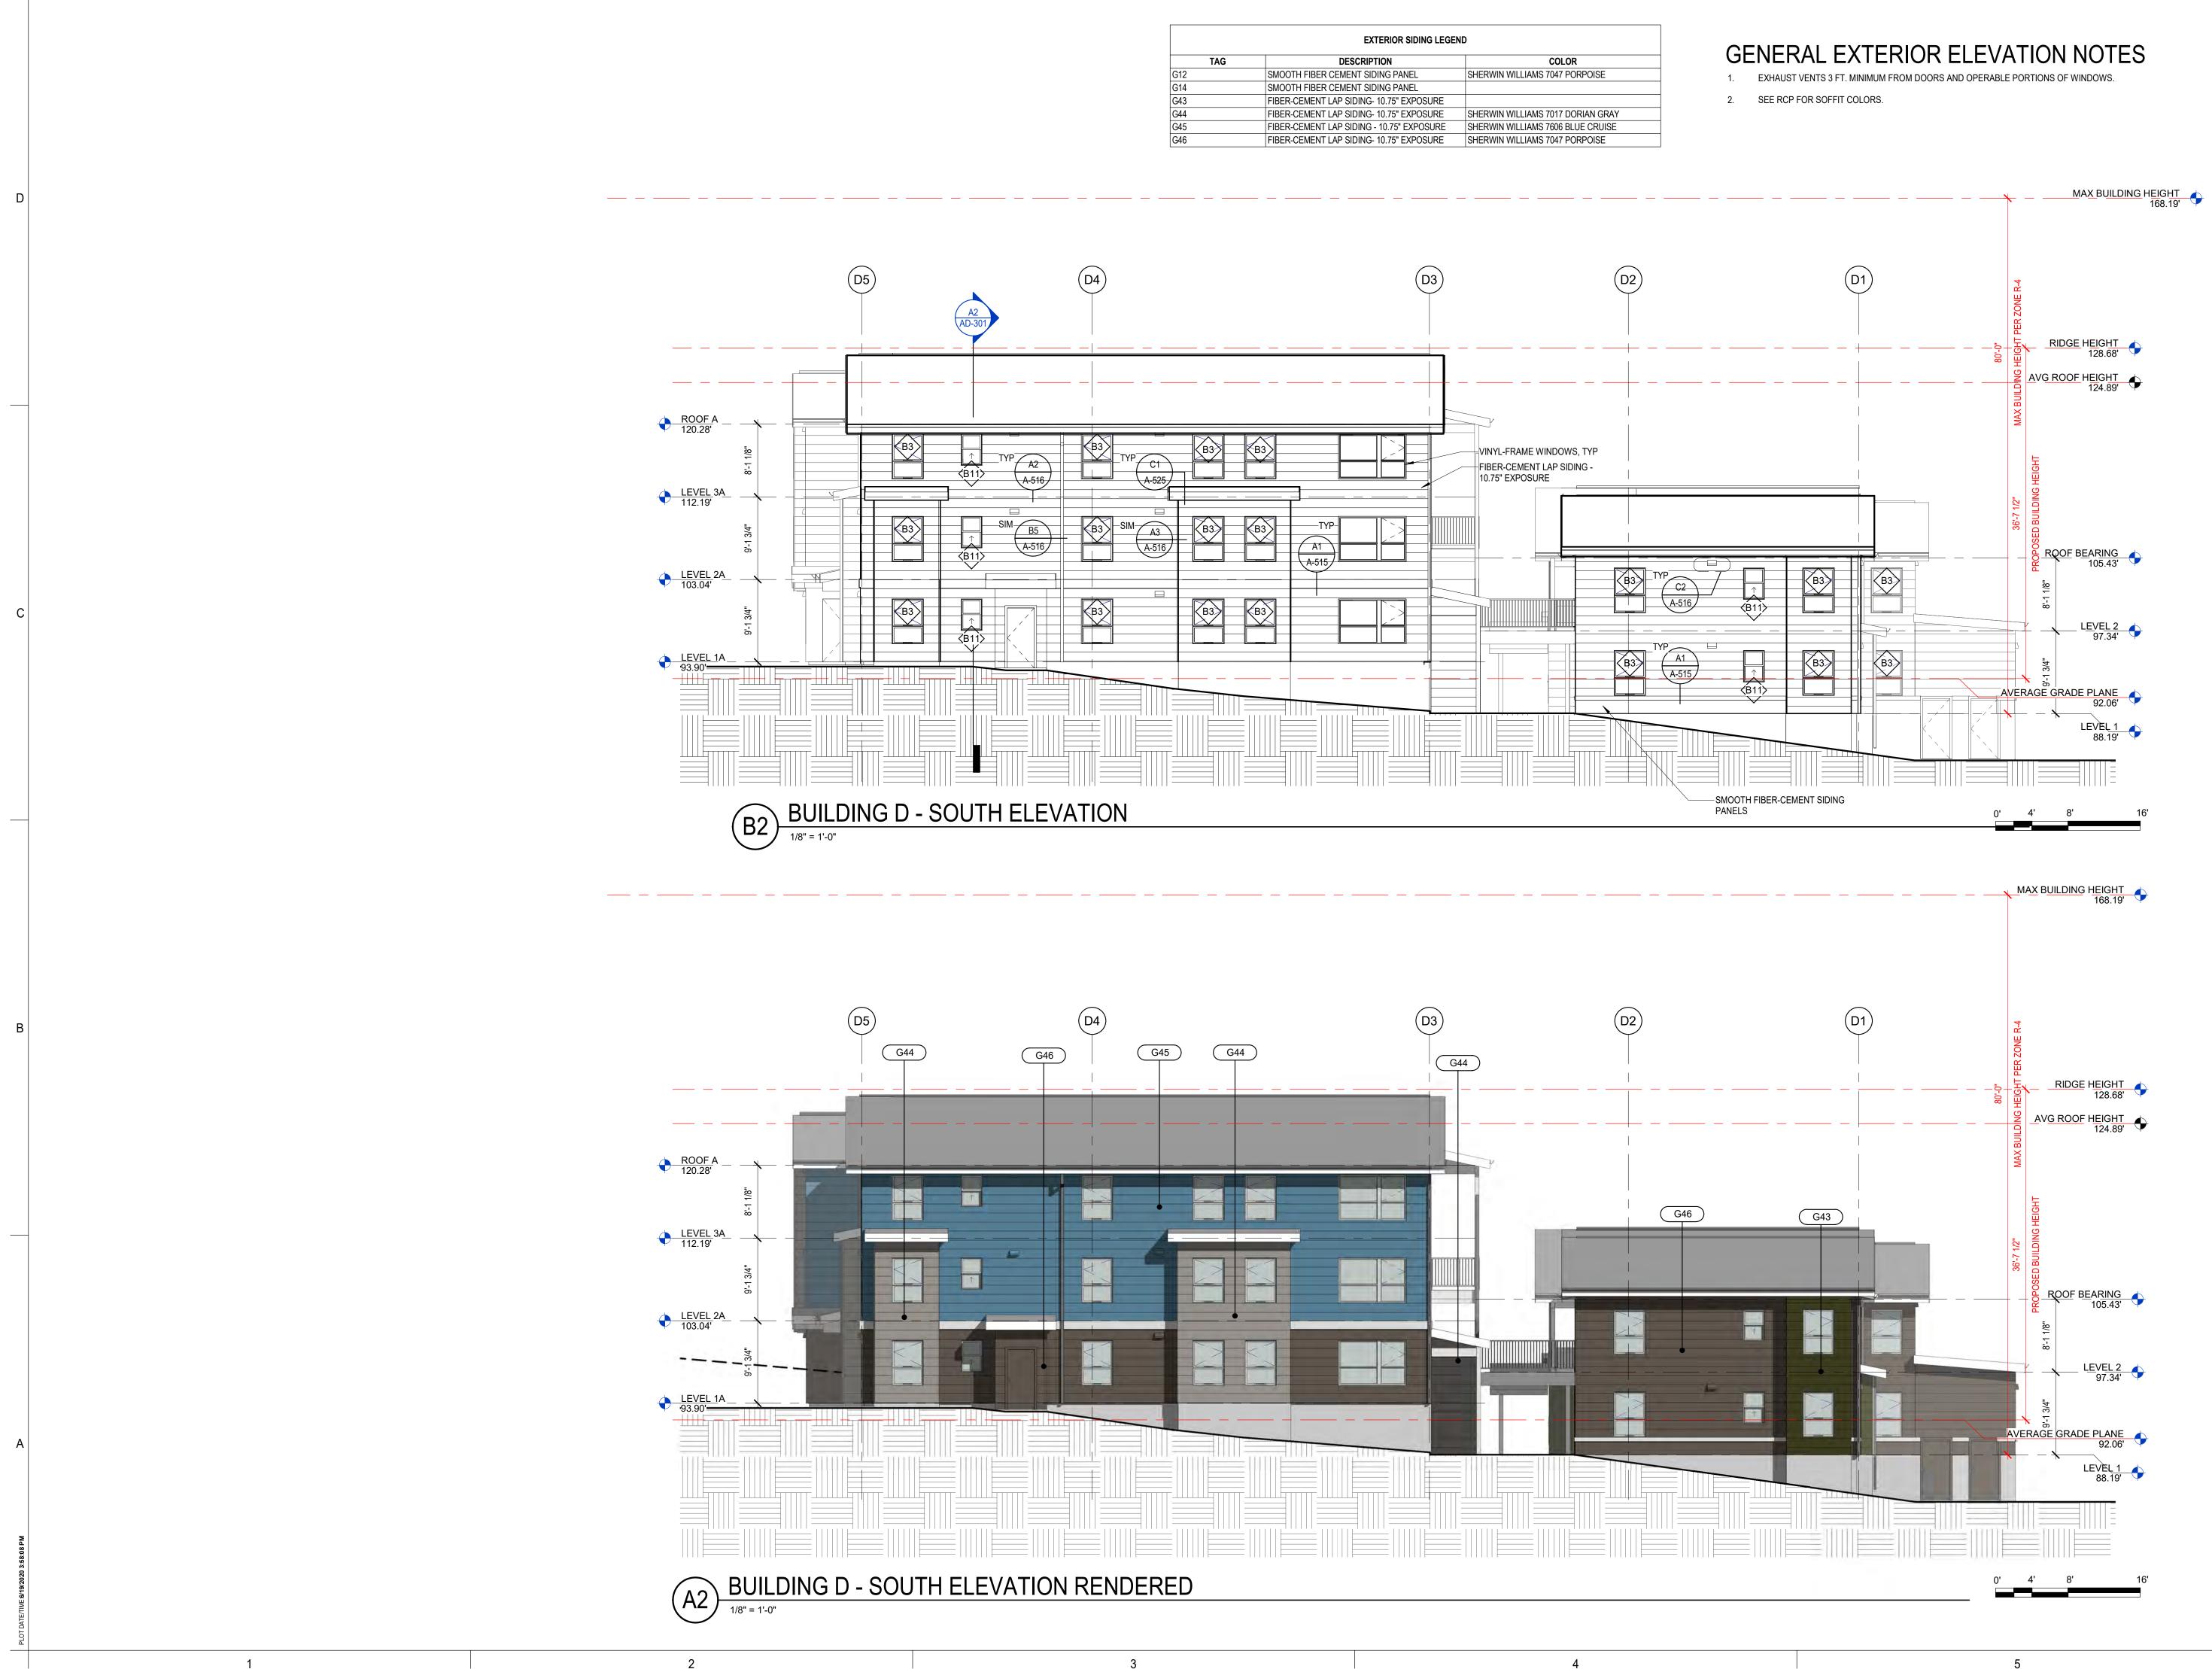
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1301 First Avenue, Suite 301 Seattle, WA 98101 http://www.gglo.com 8487 REGISTERED ARCHITECT JONATHAN F HALL STATE OF WASHINGTON PROJECT: EHA BAKER HEIGHTS **EVERETT** HOUSING AUTHORITY PROJECT ADDRESS: BUILDING A: 2710 14th STREET BUILDING B: 2715 15th STREET BUILDING C: 2815 15th STREET BUILDING D: 2810 14th STREET **EVERETT, WA 98201** OWNER: EVERETT HOUSING AUTHORITY 3107 COLBY AVENUE EVERETT, WASHINGTON 98201 MARK DATE DESCRIPTION REVISIONS C 06/22/2020 BUILDING PERMIT SUBMITTAL / HUD SUBMITTAL 04/10/2020 DESIGN DEVELOPMENT A 01/07/2020 SCHEMATIC DESIGN MARK DATE DESCRIPTION **ISSUE INFORMATION** 2017033 PROJECT NO .: Jon Hall GGLO PRINCIPAL IN CHARGE: Scott Schreffler GGLO PROJECT MANAGER: OWNER APPROVAL SHEET TITLE **BUILDING D - BUILDING**

GGLO

SHEET NO.

ELEVATION - EAST



EXTERIOR SIDING LEGEND					
TAG	DESCRIPTION	COLOR			
G12	SMOOTH FIBER CEMENT SIDING PANEL	SHERWIN WILLIAMS 7047 PORPOISE			
G14	SMOOTH FIBER CEMENT SIDING PANEL				
G43	FIBER-CEMENT LAP SIDING- 10.75" EXPOSURE				
G44	FIBER-CEMENT LAP SIDING- 10.75" EXPOSURE	SHERWIN WILLIAMS 7017 DORIAN GRAY			
G45	FIBER-CEMENT LAP SIDING - 10.75" EXPOSURE	SHERWIN WILLIAMS 7606 BLUE CRUISE			
G46	FIBER-CEMENT LAP SIDING- 10.75" EXPOSURE	SHERWIN WILLIAMS 7047 PORPOISE			

8487 REGISTERED ARCHITECT JONATHAN F HALL STATE OF WASHINGTON PROJECT: EHA BAKER HEIGHTS **EVERETT** HOUSING AUTHORITY PROJECT ADDRESS: BUILDING A: 2710 14th STREET BUILDING B: 2715 15th STREET BUILDING C: 2815 15th STREET BUILDING D: 2810 14th STREET EVERETT, WA 98201 OWNER: EVERETT HOUSING AUTHORITY 3107 COLBY AVENUE **EVERETT, WASHINGTON 98201** MARK DATE DESCRIPTION REVISIONS 06/22/2020 BUILDING PERMIT SUBMITTAL / HUD SUBMITTAL 04/10/2020 DESIGN DEVELOPMENT 01/07/2020 SCHEMATIC DESIGN А MARK DATE DESCRIPTION **ISSUE INFORMATION** 2017033 PROJECT NO .: Jon Hall GGLO PRINCIPAL IN CHARGE: Scott Schreffler GGLO PROJECT MANAGER:

GGLO^{NO}

1301 First Avenue, Suite 301 Seattle, WA 98101

http://www.gglo.com

SHEET NO.

SHEET TITLE

OWNER APPROVAL

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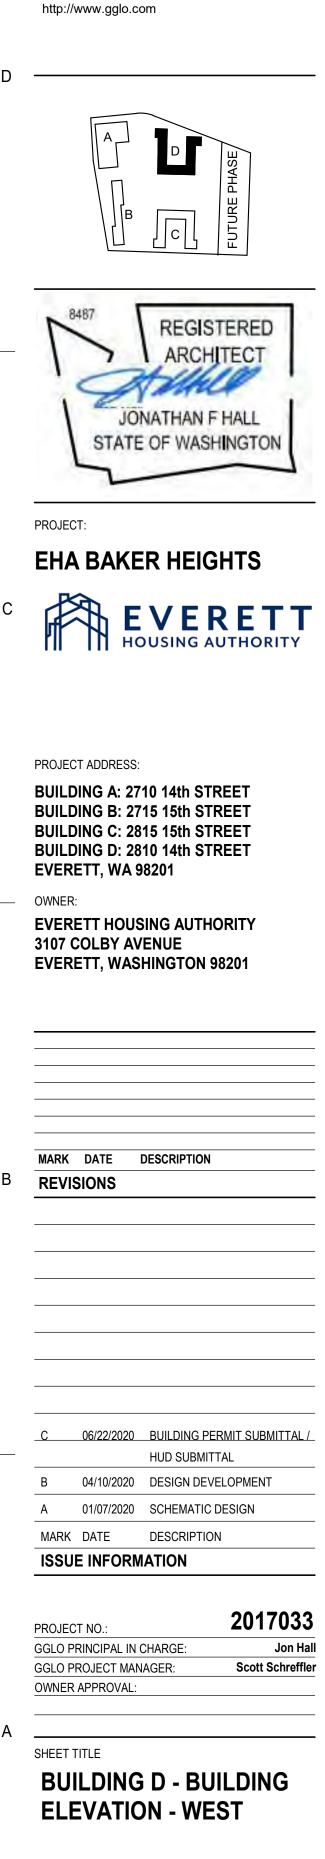
BUILDING D - BUILDING ELEVATION - SOUTH

AD-202



EXTERIOR SIDING LEGEND			
TAG	DESCRIPTION	COLOR	
G12	SMOOTH FIBER CEMENT SIDING PANEL	SHERWIN WILLIAMS 7047 PORPOISE	
G14	SMOOTH FIBER CEMENT SIDING PANEL		
G43	FIBER-CEMENT LAP SIDING- 10.75" EXPOSURE		
G44	FIBER-CEMENT LAP SIDING- 10.75" EXPOSURE	SHERWIN WILLIAMS 7017 DORIAN GRAY	
G45	FIBER-CEMENT LAP SIDING - 10.75" EXPOSURE	SHERWIN WILLIAMS 7606 BLUE CRUISE	
G46	FIBER-CEMENT LAP SIDING- 10.75" EXPOSURE	SHERWIN WILLIAMS 7047 PORPOISE	

			(
G45 G11	G44	G45 G44	



GGLO^{NO}

1301 First Avenue, Suite 301


Seattle, WA 98101

SHEET NO.

AD-203





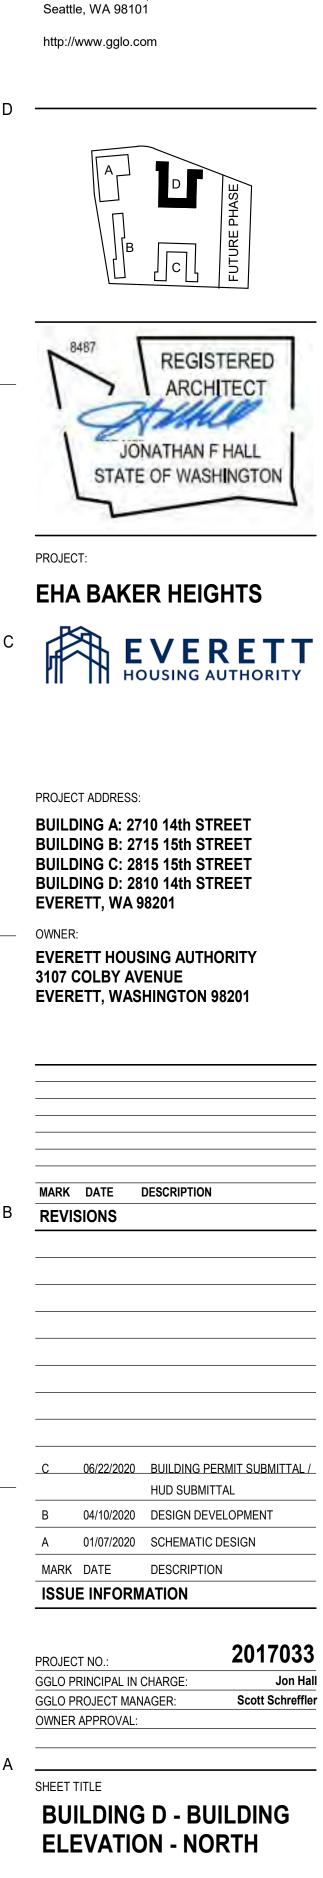

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1301 First Avenue, Suite 301

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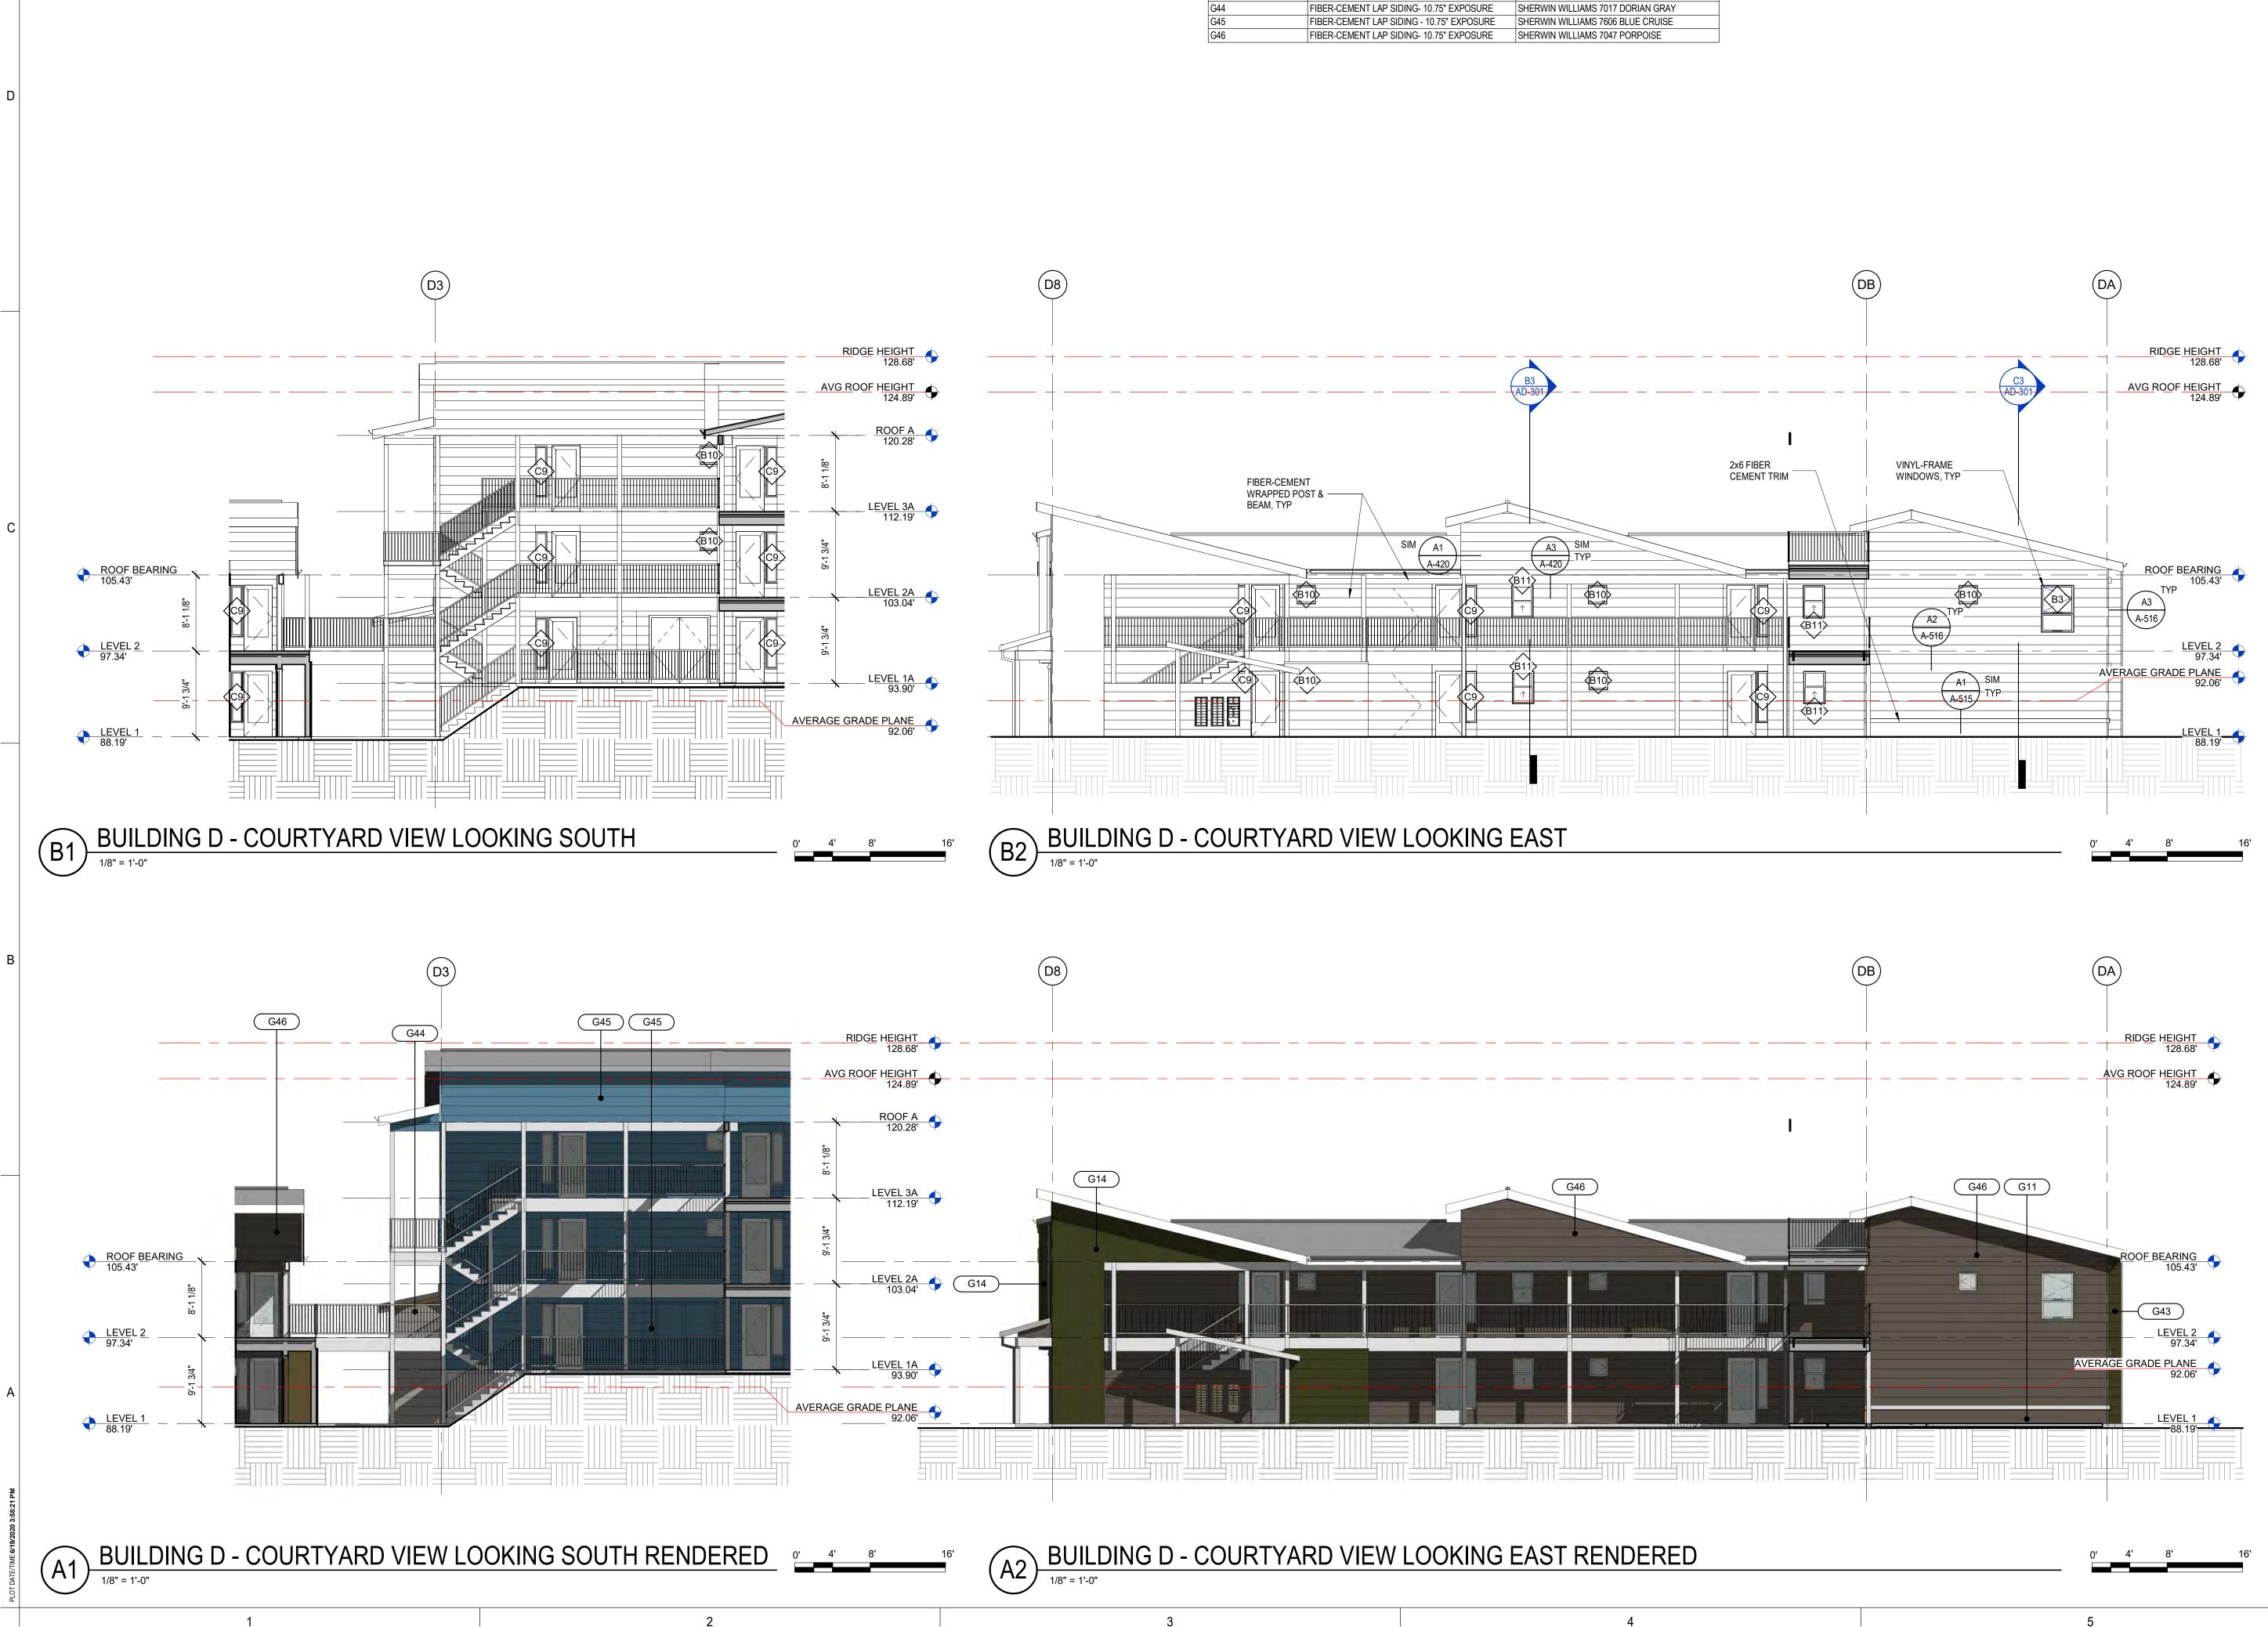
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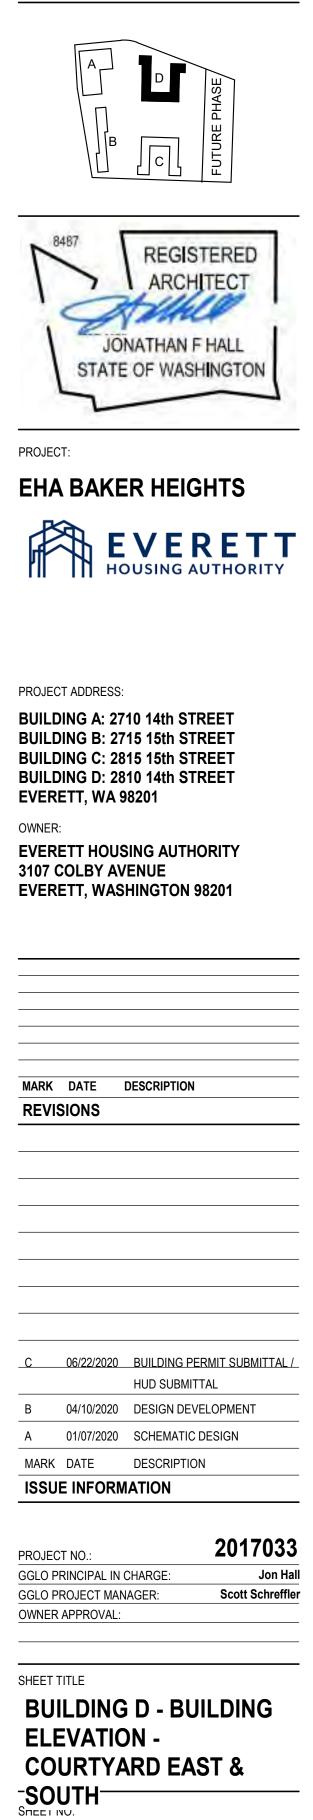
AD-204



EXTERIOR SIDING LEGEND					
TAG DESCRIPTION		COLOR			
2	SMOOTH FIBER CEMENT SIDING PANEL	SHERWIN WILLIAMS 7047 PORPOISE			
4	SMOOTH FIBER CEMENT SIDING PANEL				
3	FIBER-CEMENT LAP SIDING- 10.75" EXPOSURE				
4	FIBER-CEMENT LAP SIDING- 10.75" EXPOSURE	SHERWIN WILLIAMS 7017 DORIAN GRAY			
5	FIBER-CEMENT LAP SIDING - 10.75" EXPOSURE	SHERWIN WILLIAMS 7606 BLUE CRUISE			
6	FIBER-CEMENT LAP SIDING- 10.75" EXPOSURE	SHERWIN WILLIAMS 7047 PORPOISE			

GENERAL EXTERIOR ELEVATION NOTES

- 1. EXHAUST VENTS 3 FT. MINIMUM FROM DOORS AND OPERABLE PORTIONS OF WINDOWS.
- 2. SEE RCP FOR SOFFIT COLORS.



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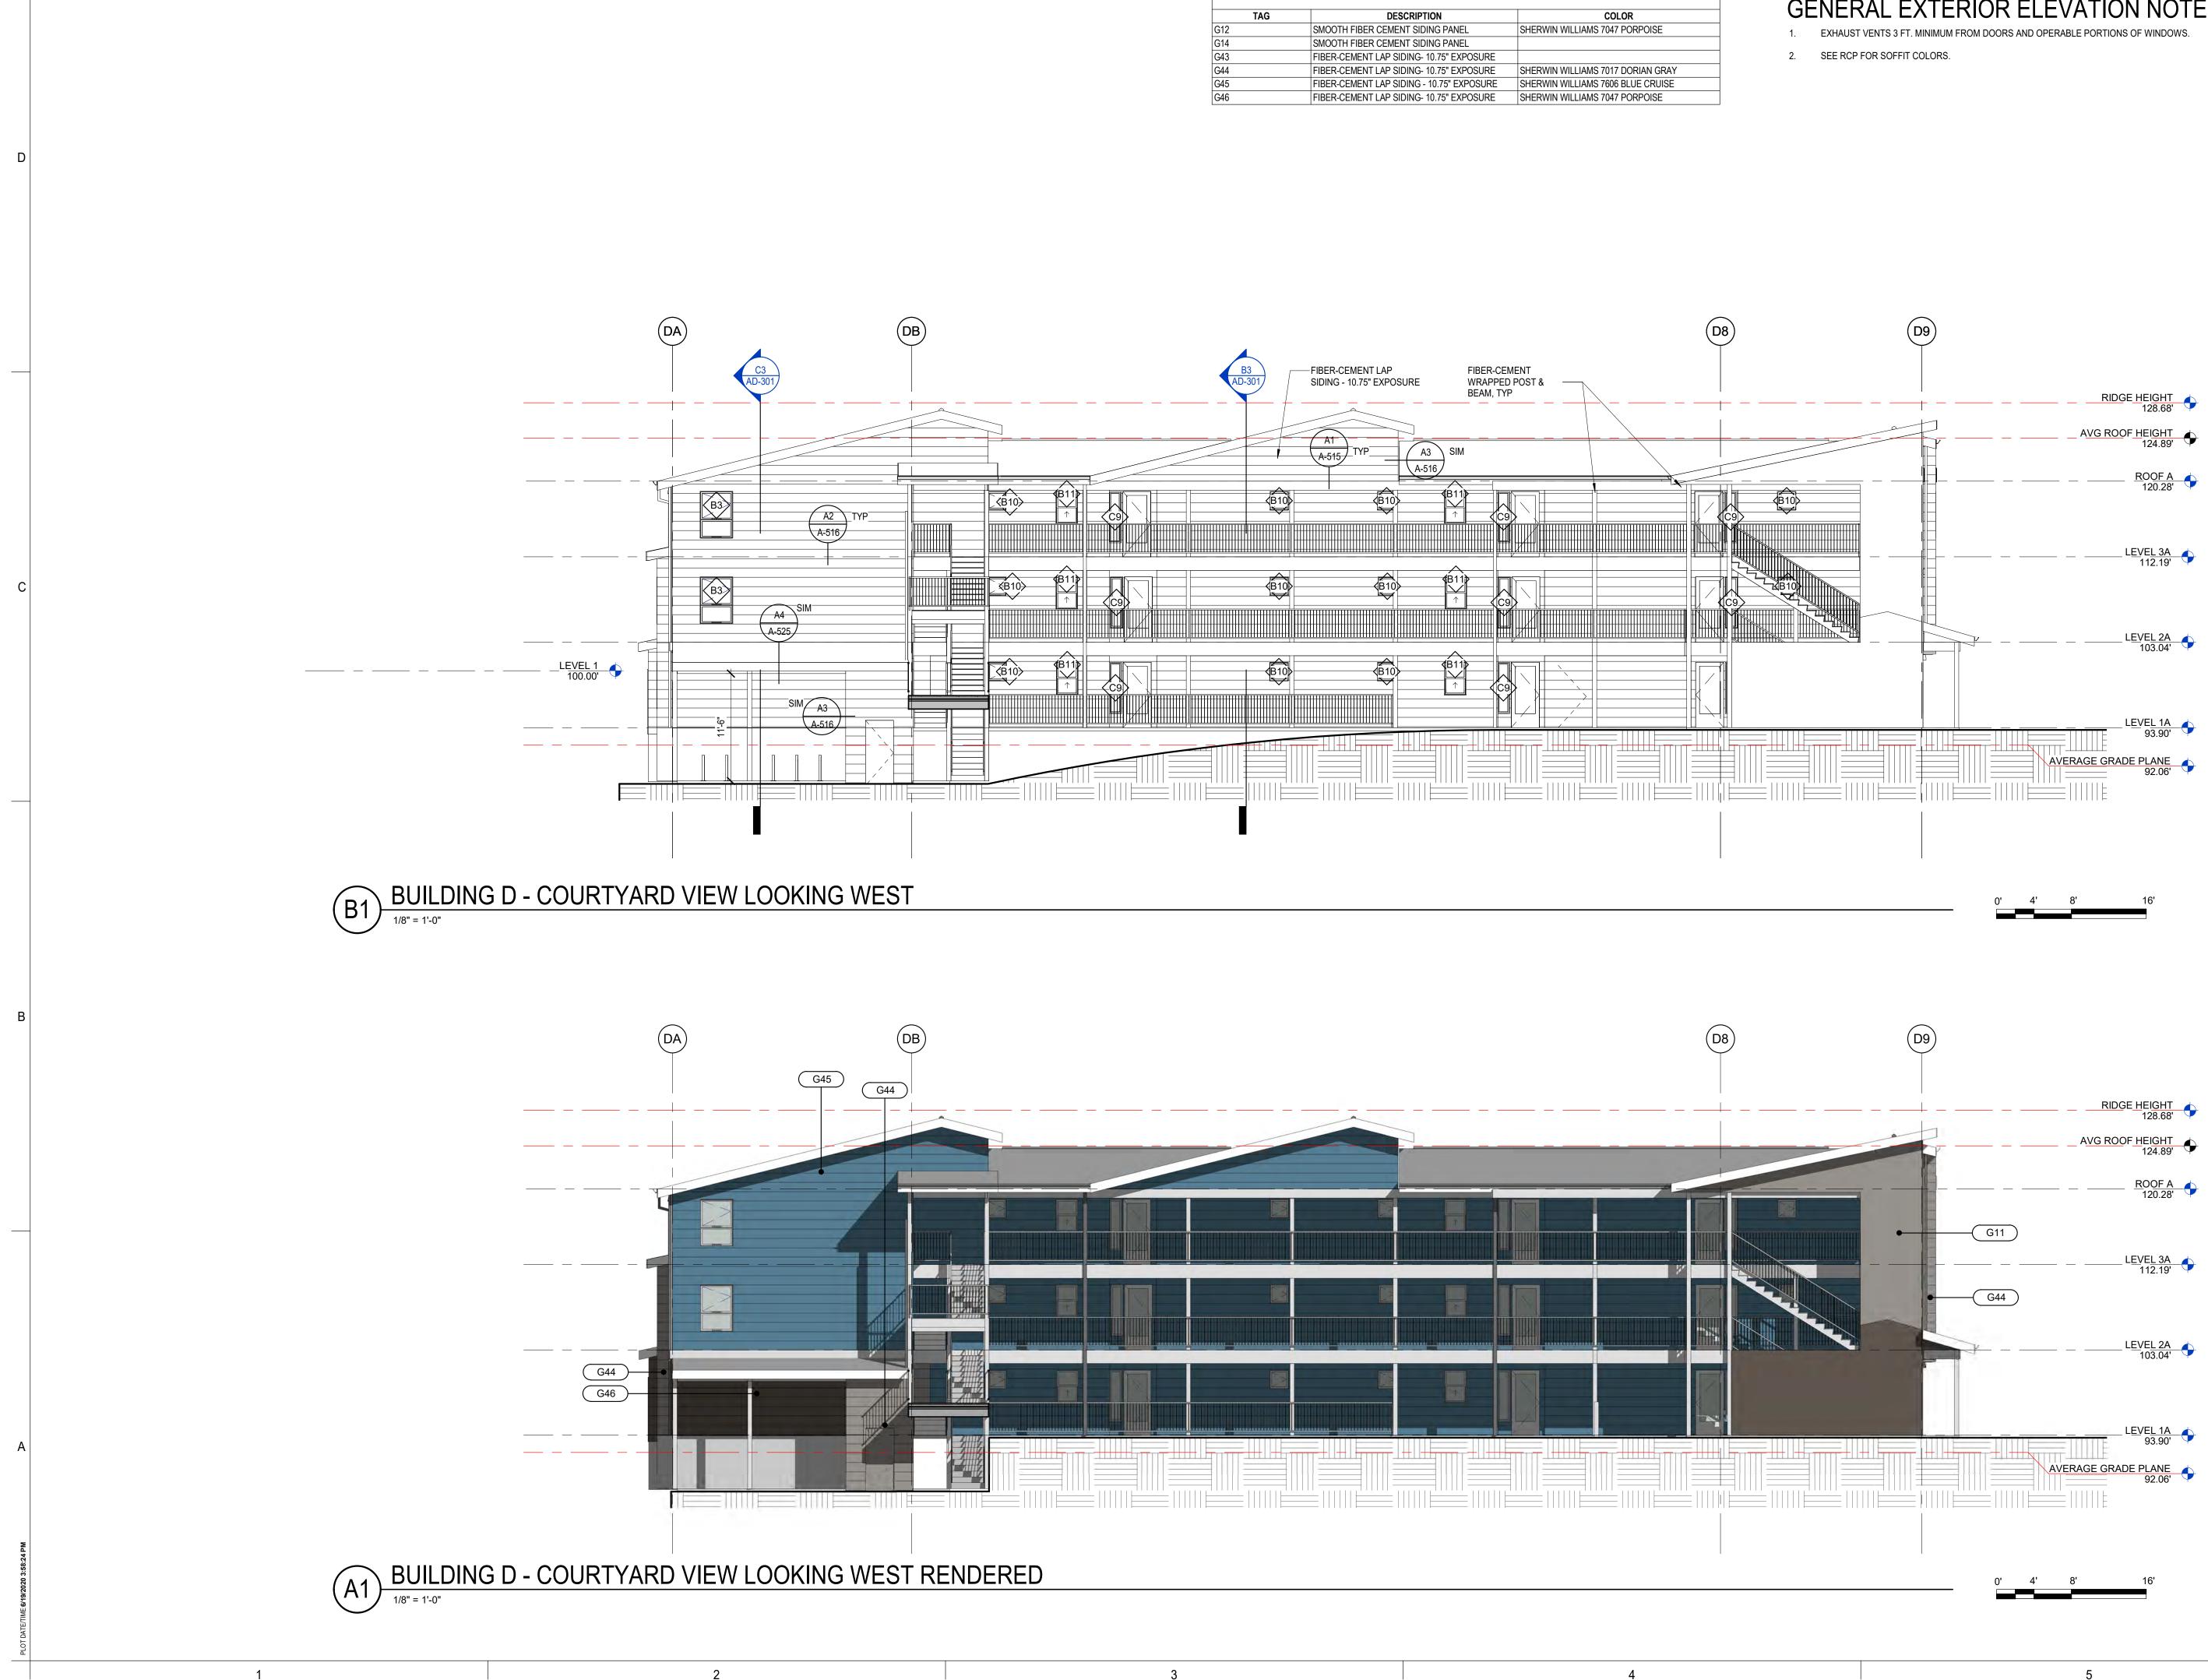
BUILDIN

AD-205

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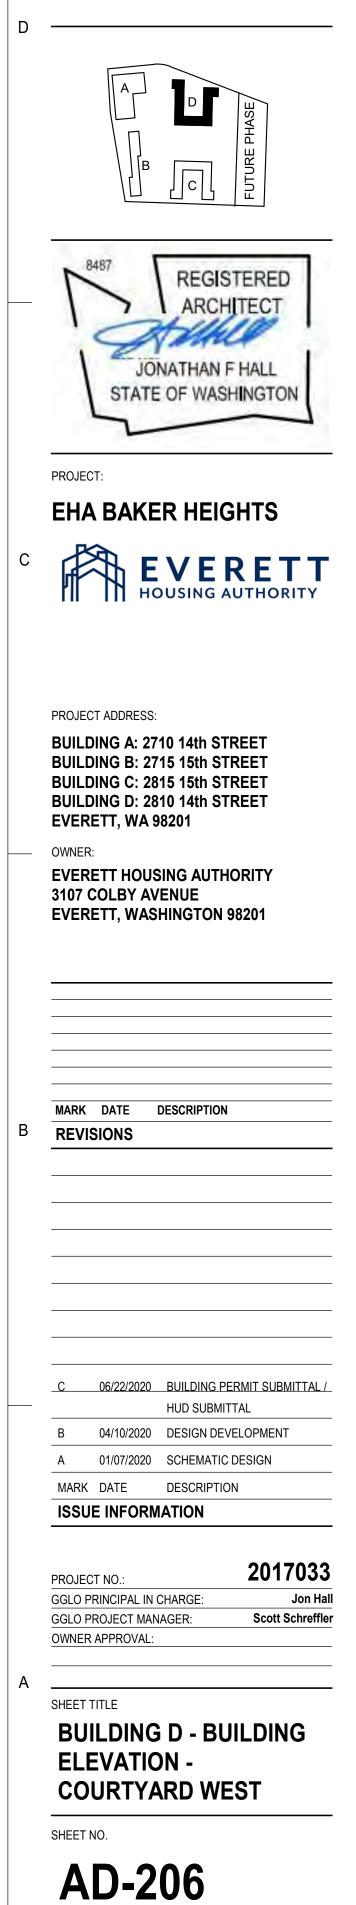
EXTERIOR SIDING LEGEND			
TAG	DESCRIPTION	COLOR	
G12	SMOOTH FIBER CEMENT SIDING PANEL	SHERWIN WILLIAMS 7047 PORPOISE	
G14	SMOOTH FIBER CEMENT SIDING PANEL		
G43	FIBER-CEMENT LAP SIDING- 10.75" EXPOSURE		
G44	FIBER-CEMENT LAP SIDING- 10.75" EXPOSURE	SHERWIN WILLIAMS 7017 DORIAN GRAY	
G45	FIBER-CEMENT LAP SIDING - 10.75" EXPOSURE	SHERWIN WILLIAMS 7606 BLUE CRUISE	
G46	FIBER-CEMENT LAP SIDING- 10.75" EXPOSURE	SHERWIN WILLIAMS 7047 PORPOISE	




GENERAL EXTERIOR ELEVATION NOTES



1301 First Avenue, Suite 301 Seattle, WA 98101 http://www.gglo.com



HUD SUBMIT **SUBMITTAL** PERM BUILDING

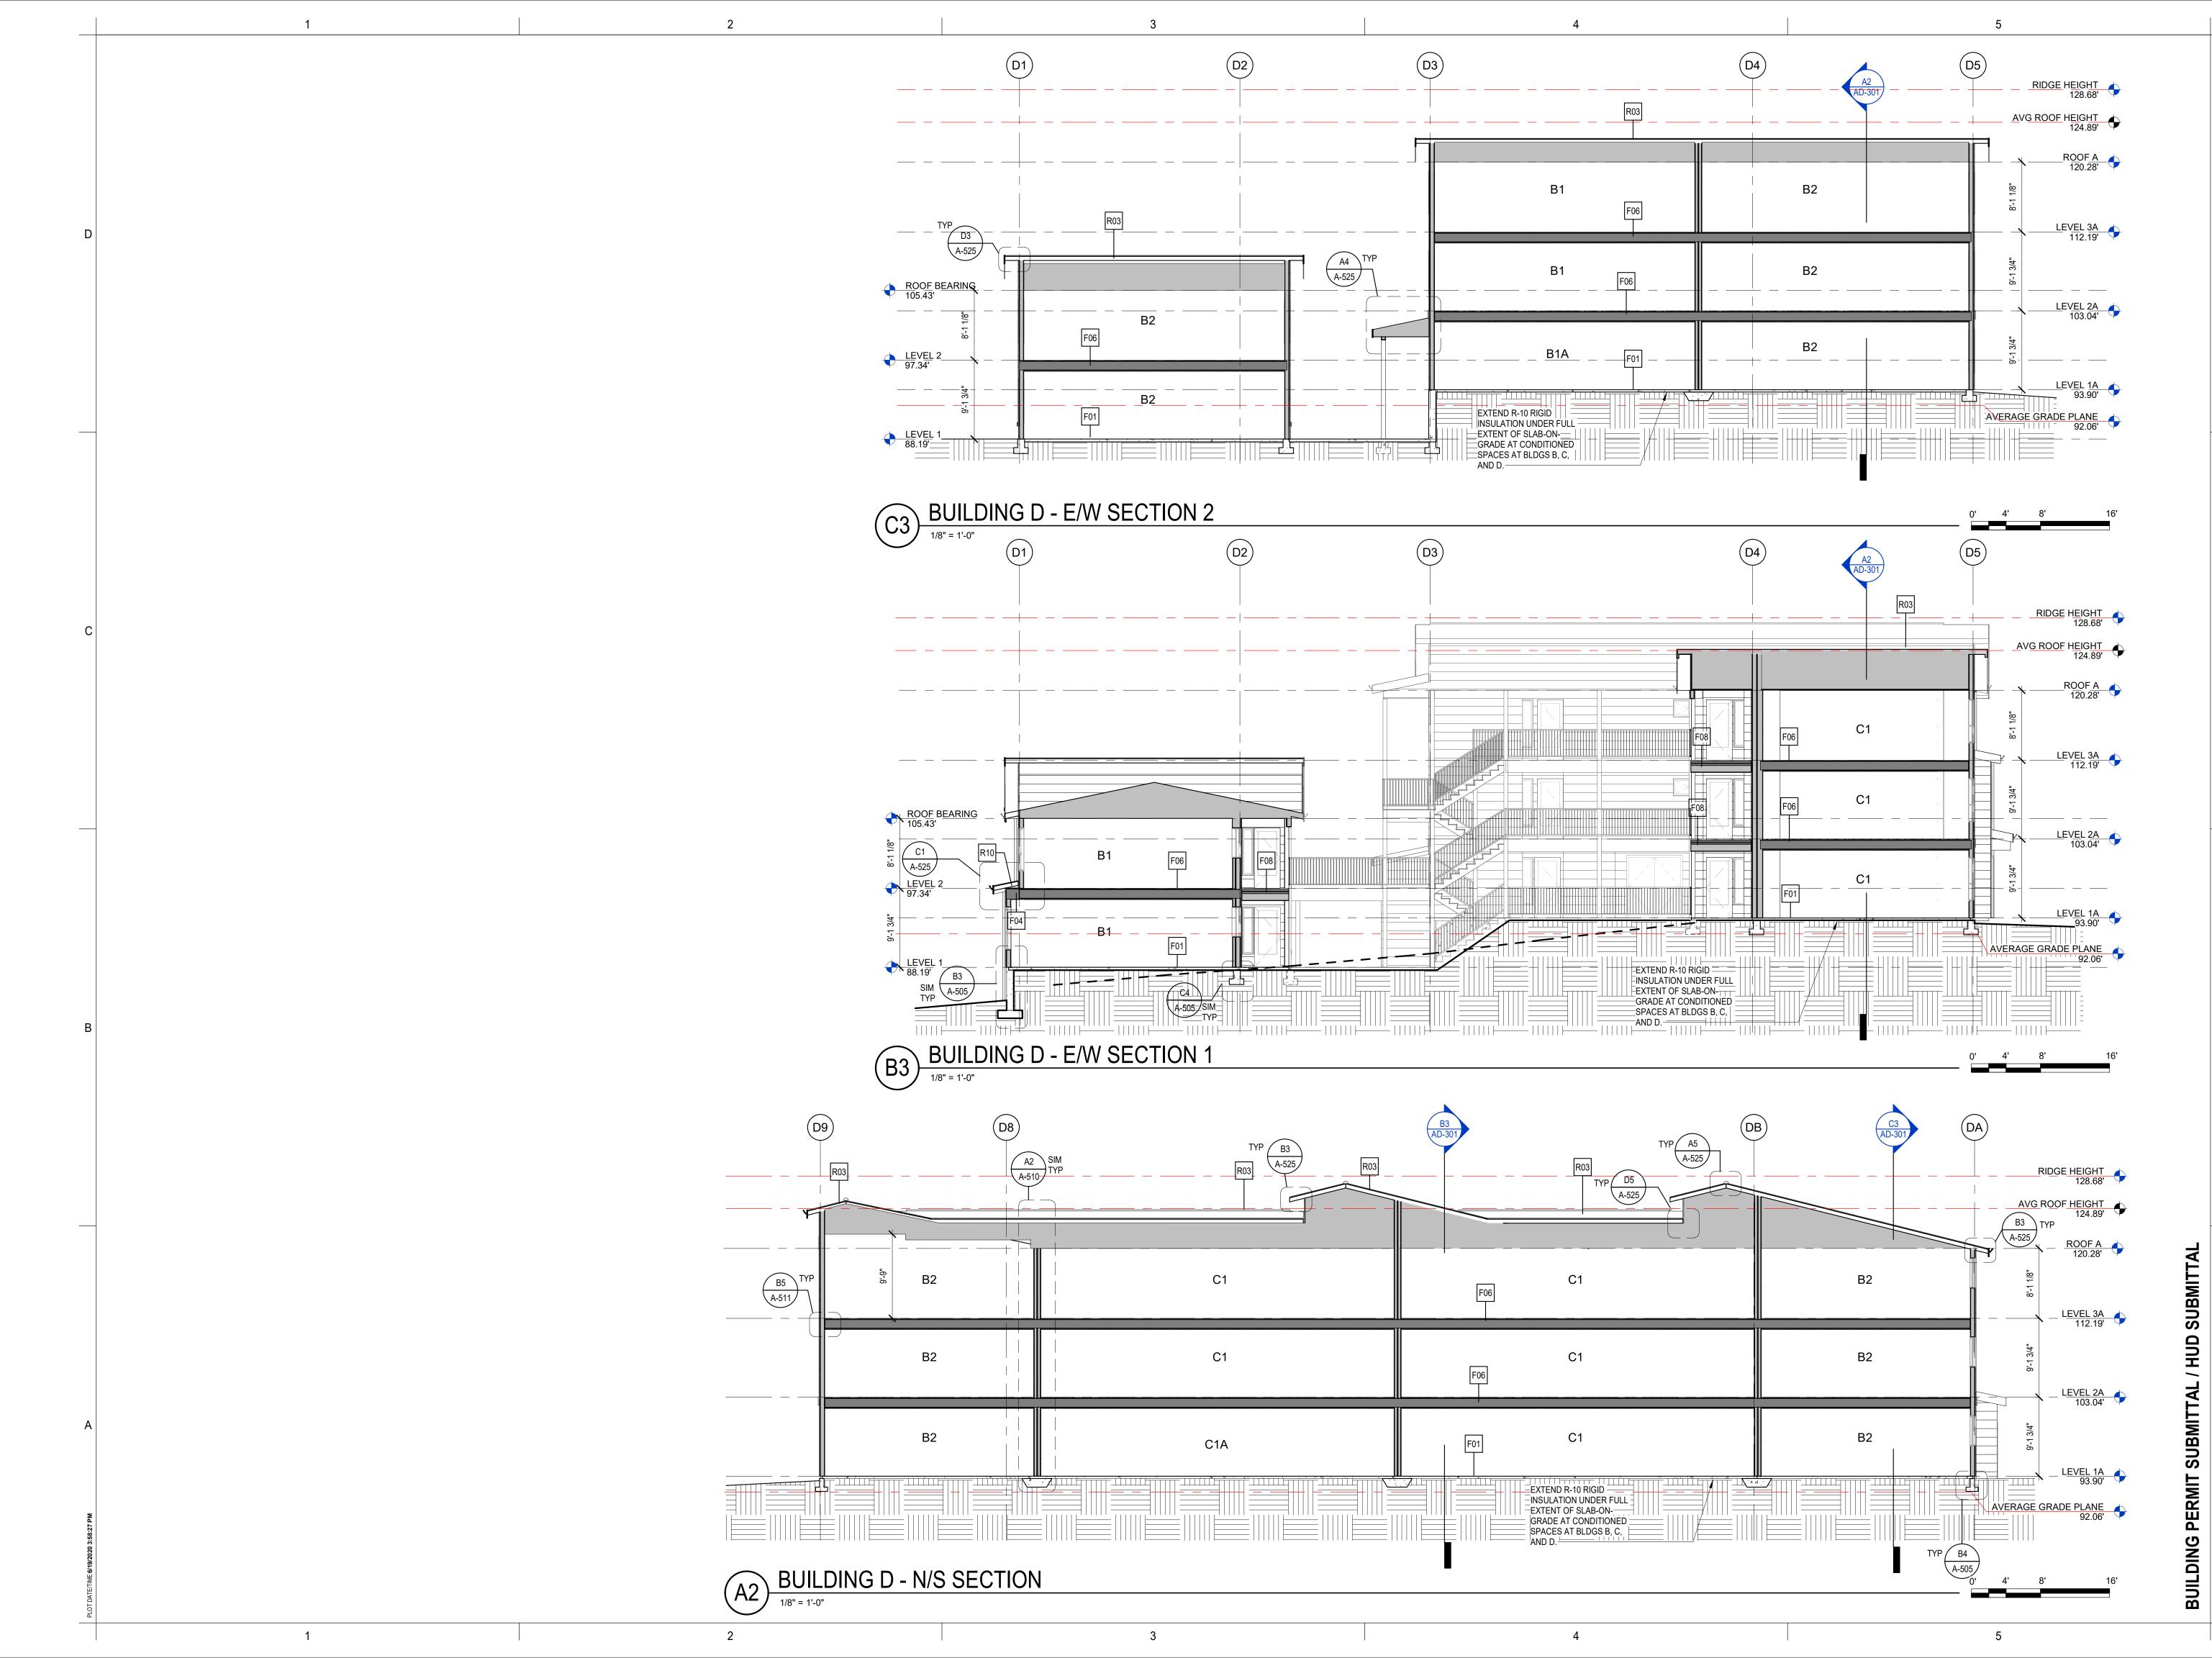



D	GGGLOG 1301 First Avenue, Suite 301 Seattle, WA 98101 http://www.gglo.com
_	A D B Enture Phase
	8487 REGISTERED JONATHAN F HALL JONATHAN F HALL STATE OF WASHINGTON PROJECT: EHA BAKER HEIGHTS
C	PROJECT ADDRESS: BUILDING A: 2710 14th STREET BUILDING B: 2715 15th STREET BUILDING C: 2815 15th STREET BUILDING C: 2815 15th STREET BUILDING D: 2810 14th STREET EVERETT, WA 98201 OWNER: EVERETT HOUSING AUTHORITY
	STORE AND ADDRESSING ADDITION 3107 COLBY AVENUE EVERETT, WASHINGTON 98201
В	REVISIONS
	C06/22/2020BUILDING PERMIT SUBMITTAL / HUD SUBMITTALB04/10/2020DESIGN DEVELOPMENTA01/07/2020SCHEMATIC DESIGNMARKDATEDESCRIPTIONISSUE INFORMATION
А	PROJECT NO.: 2017033 GGLO PRINCIPAL IN CHARGE: Jon Hall GGLO PROJECT MANAGER: Scott Schreffler OWNER APPROVAL:

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SHEET NO.

AD-301



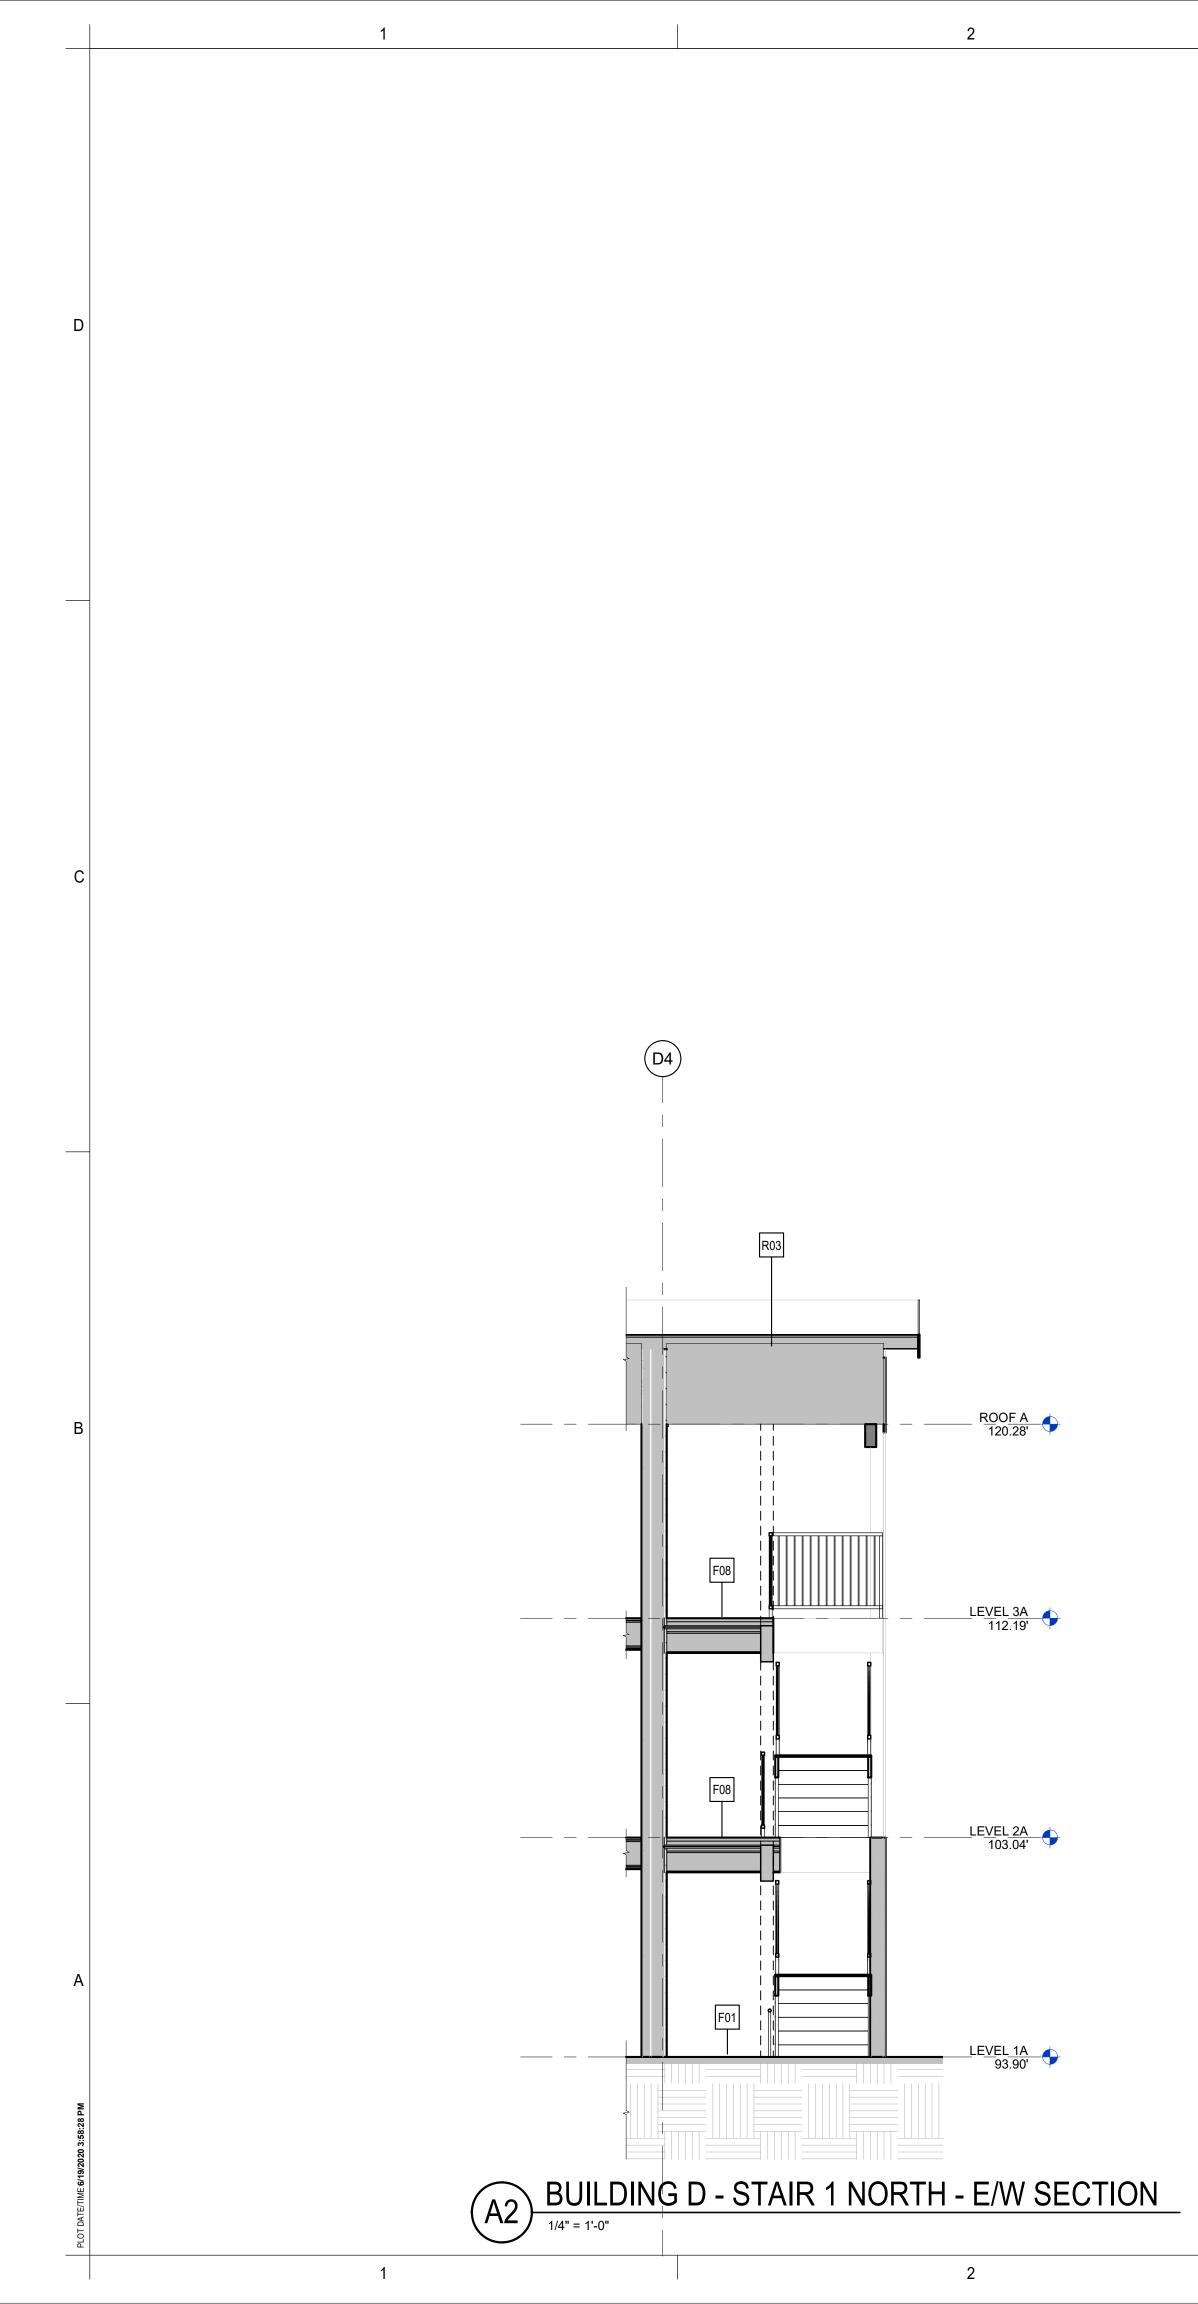


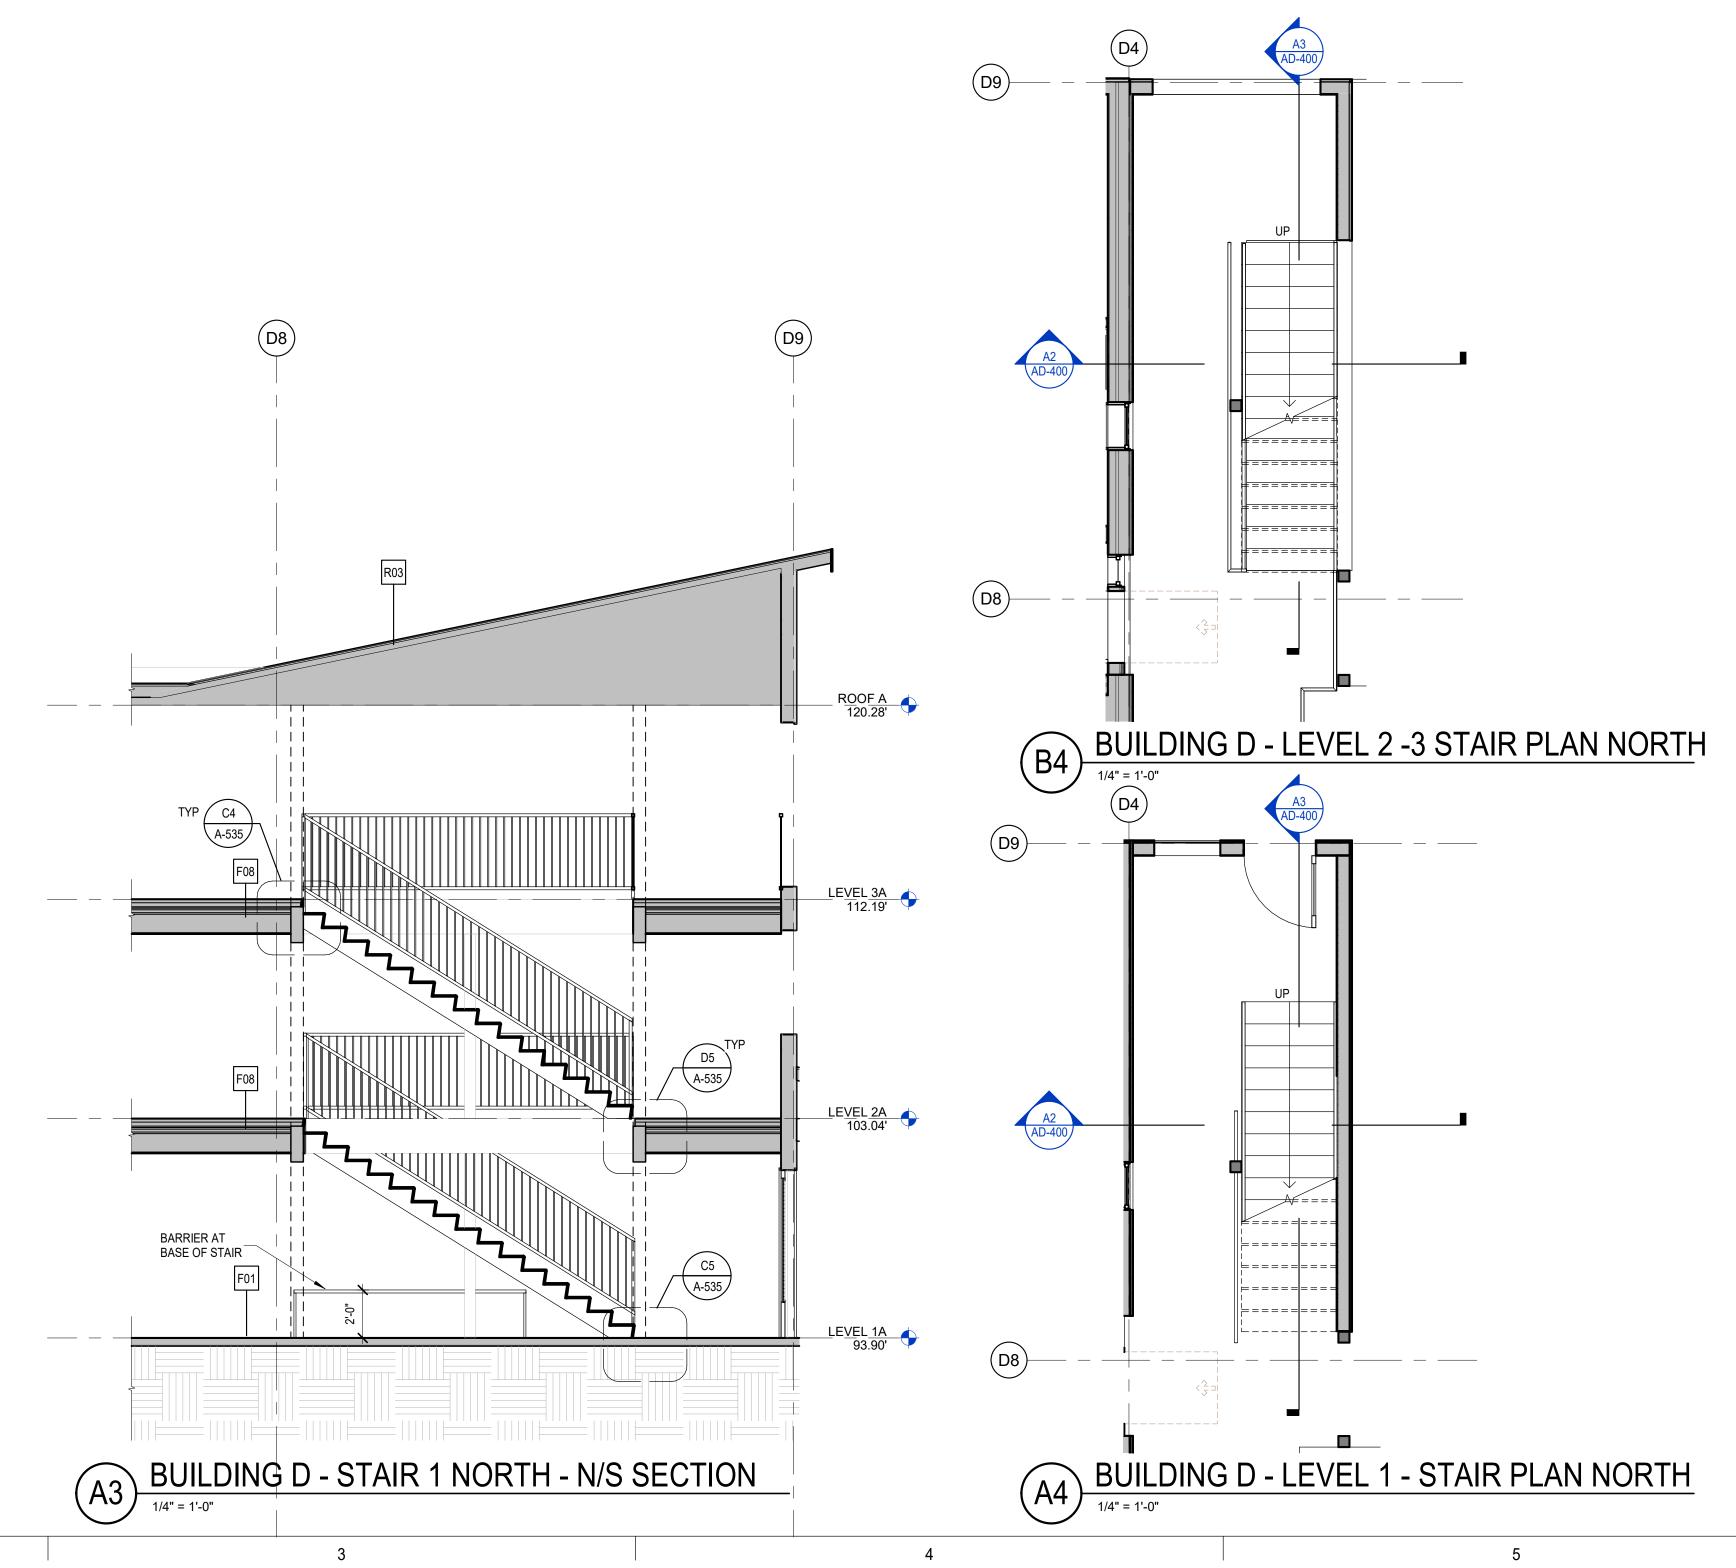
GENERAL STAIR NOTES


- 1. MIN HEADROOM CLEARANCE IN STAIRS 80" MEASURED VERTICALLY FROM THE STAIR NOSING.
- HANDRAIL HEIGHT 34"-38", MEASURED VERTICALLY FROM THE NOSING.
 TOP HANDRAIL EXTENSIONS NON CONTINUOUS HANDRAILS SHOULD EXTEND 12"
- HORIZONTALLY BEYOND THE TOP RISER.
- 4. BOTTOM HANDRAIL EXTENSIONS CONTINUE TO SLOPE FOR THE DEPTH OF ONE TREAD BEYOND THE BOTTOM RISER.
- TREADS AND RISERS IN MEANS OF EGRESS TREADS 11" MIN AND RISERS 7" MAX
 PROVIDE SIGN AT EACH LANDING OF EACH INTERIOR EXIT STAIRWAY PER IBC 1023.8 AS SHOWN IN DETAIL - / ---




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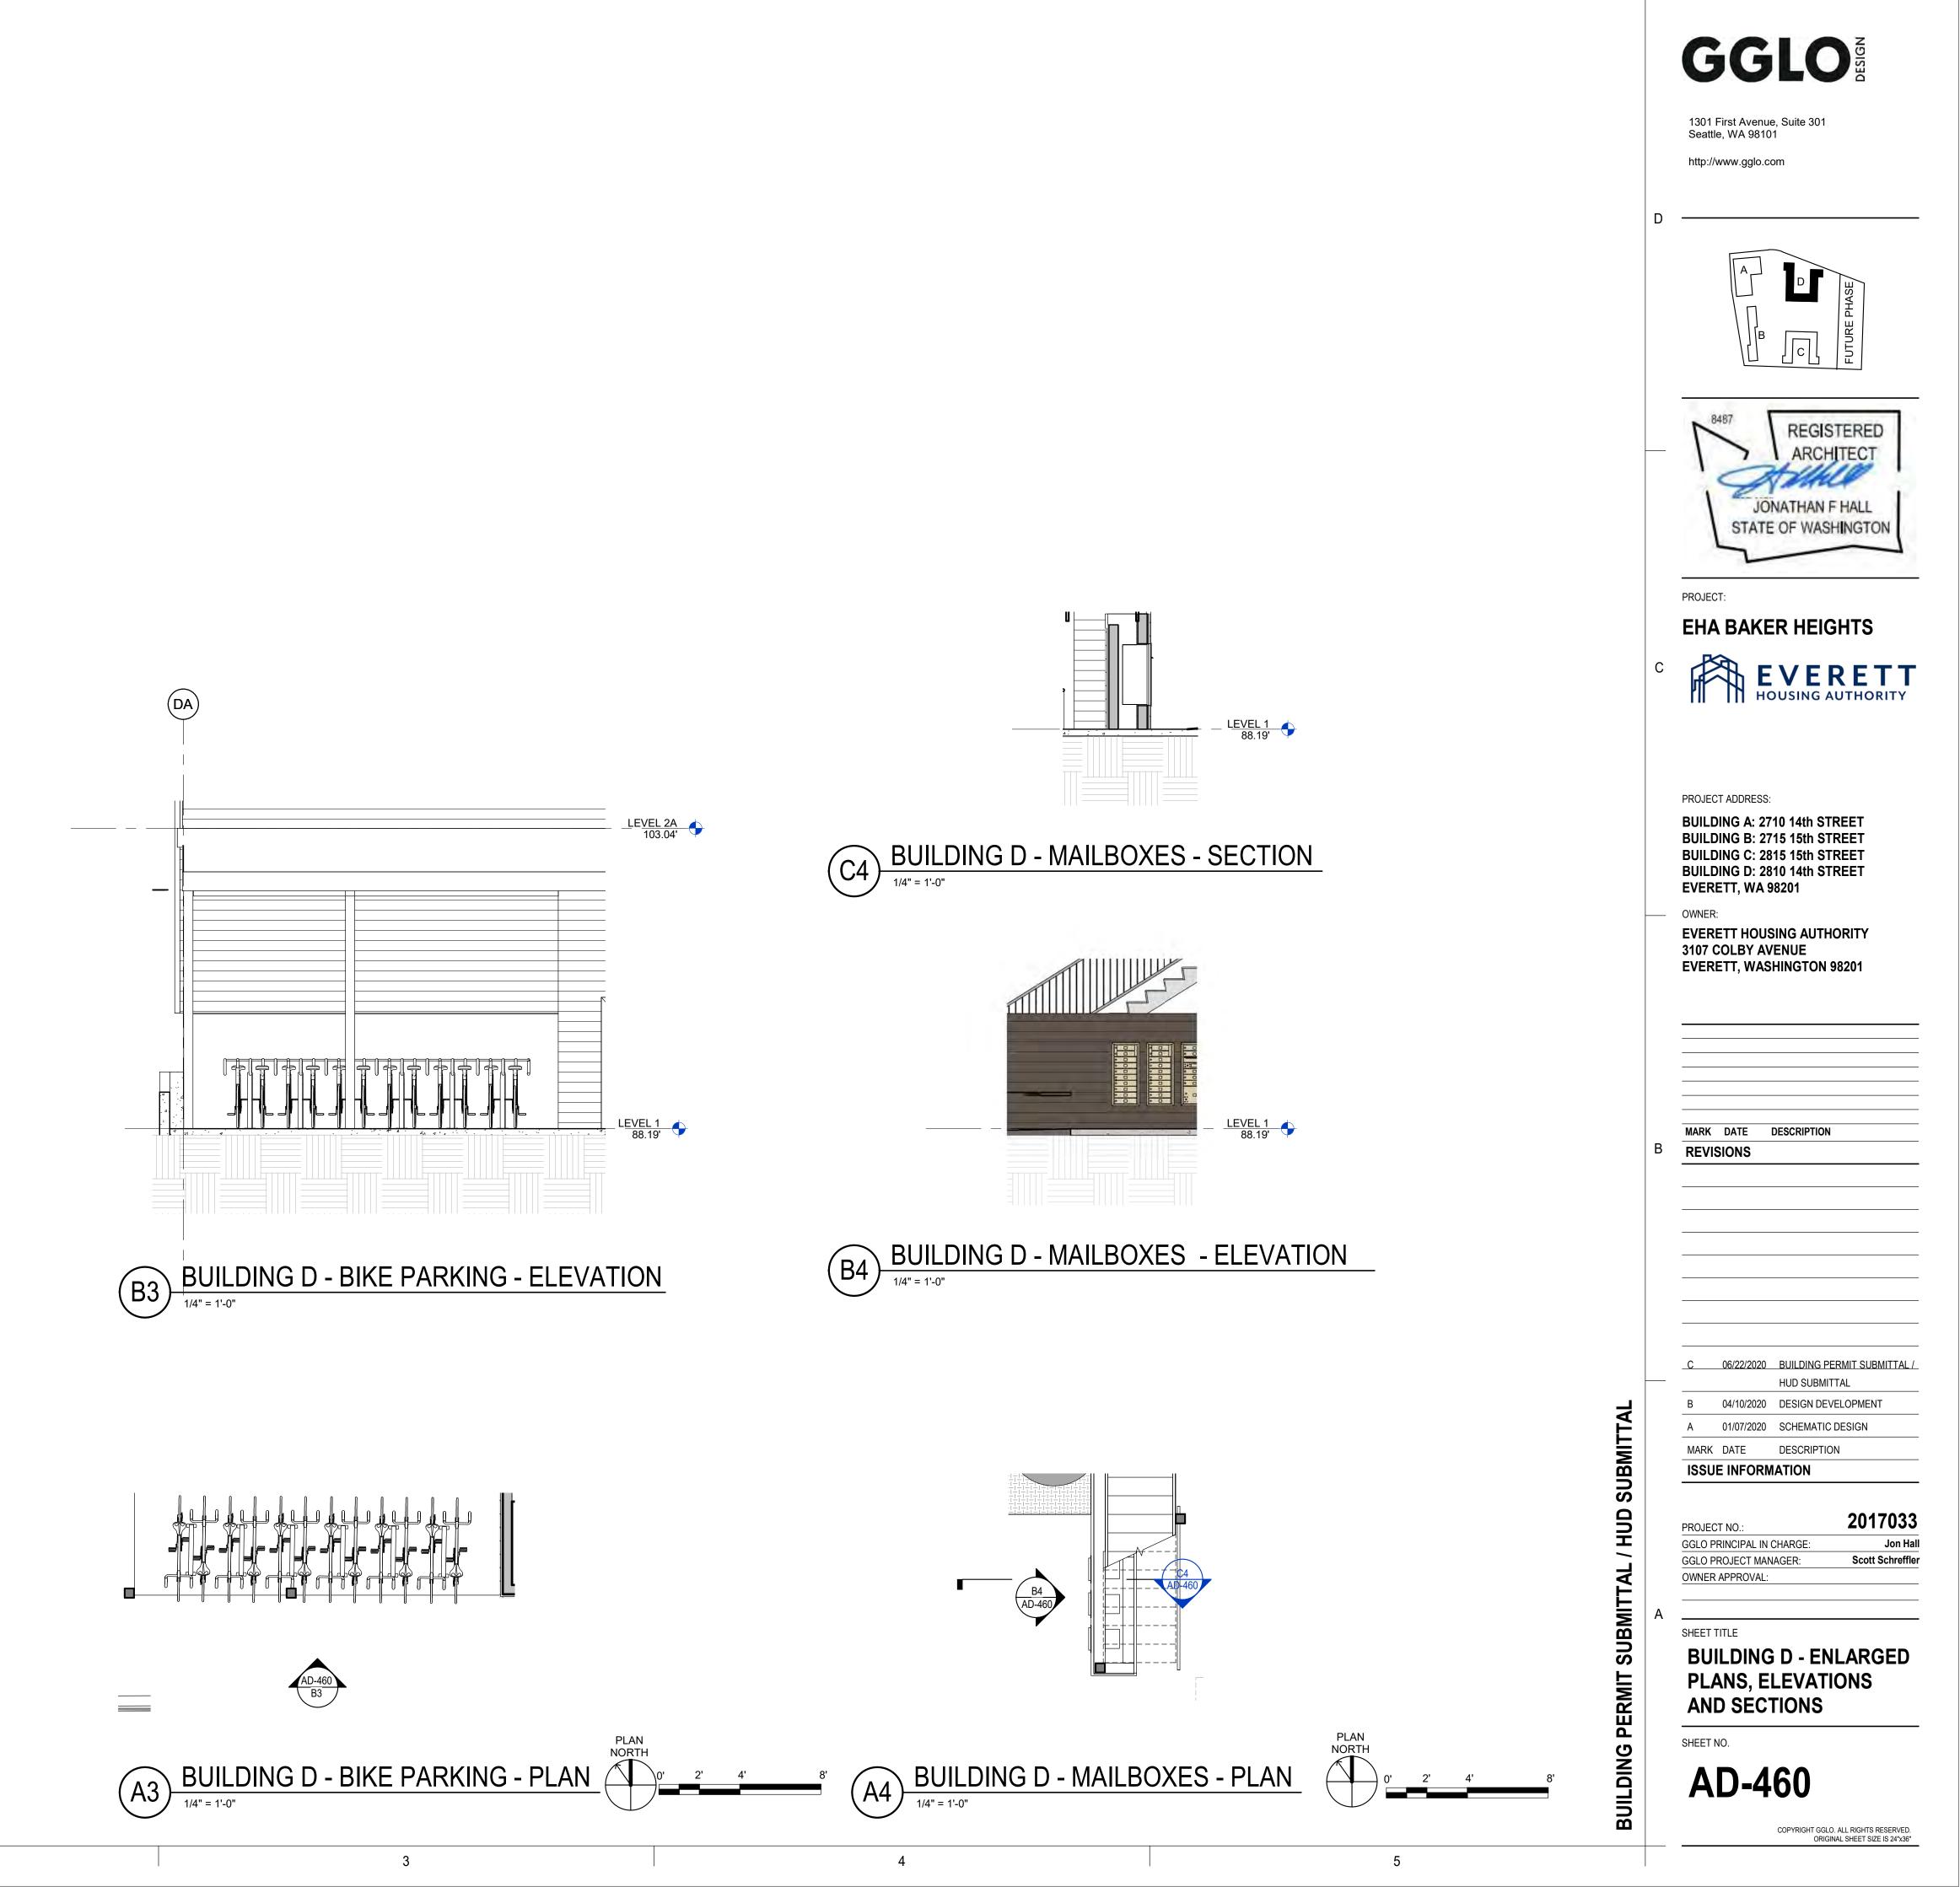


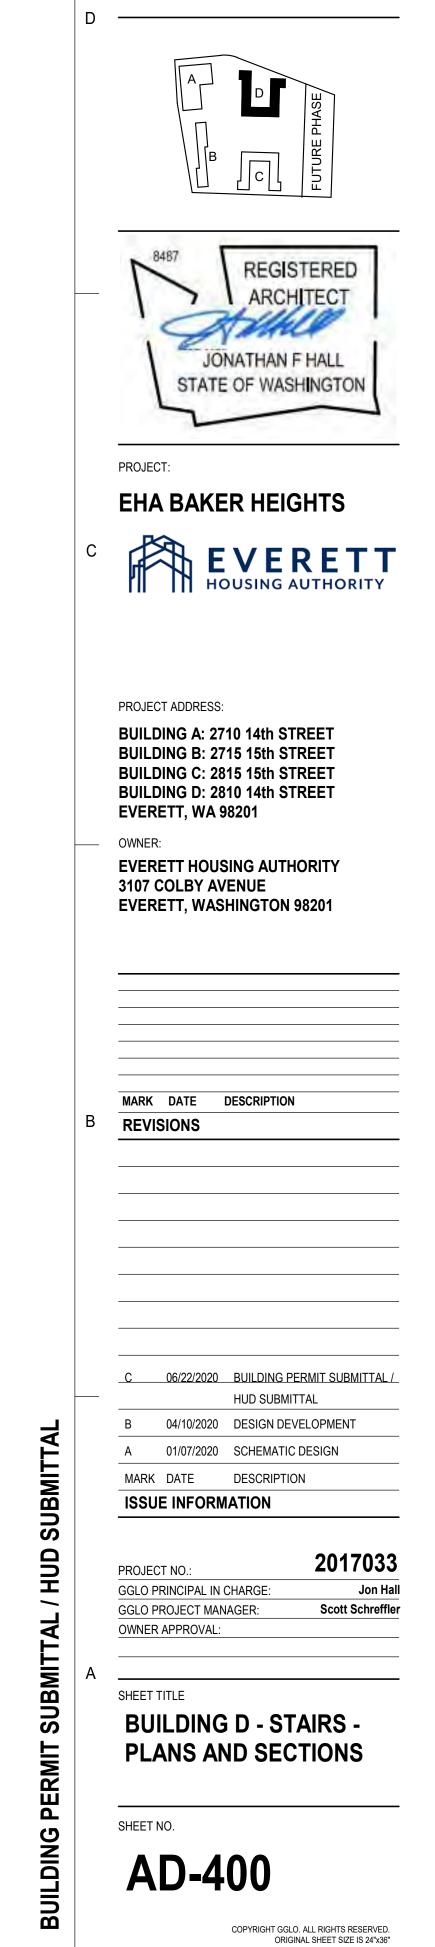

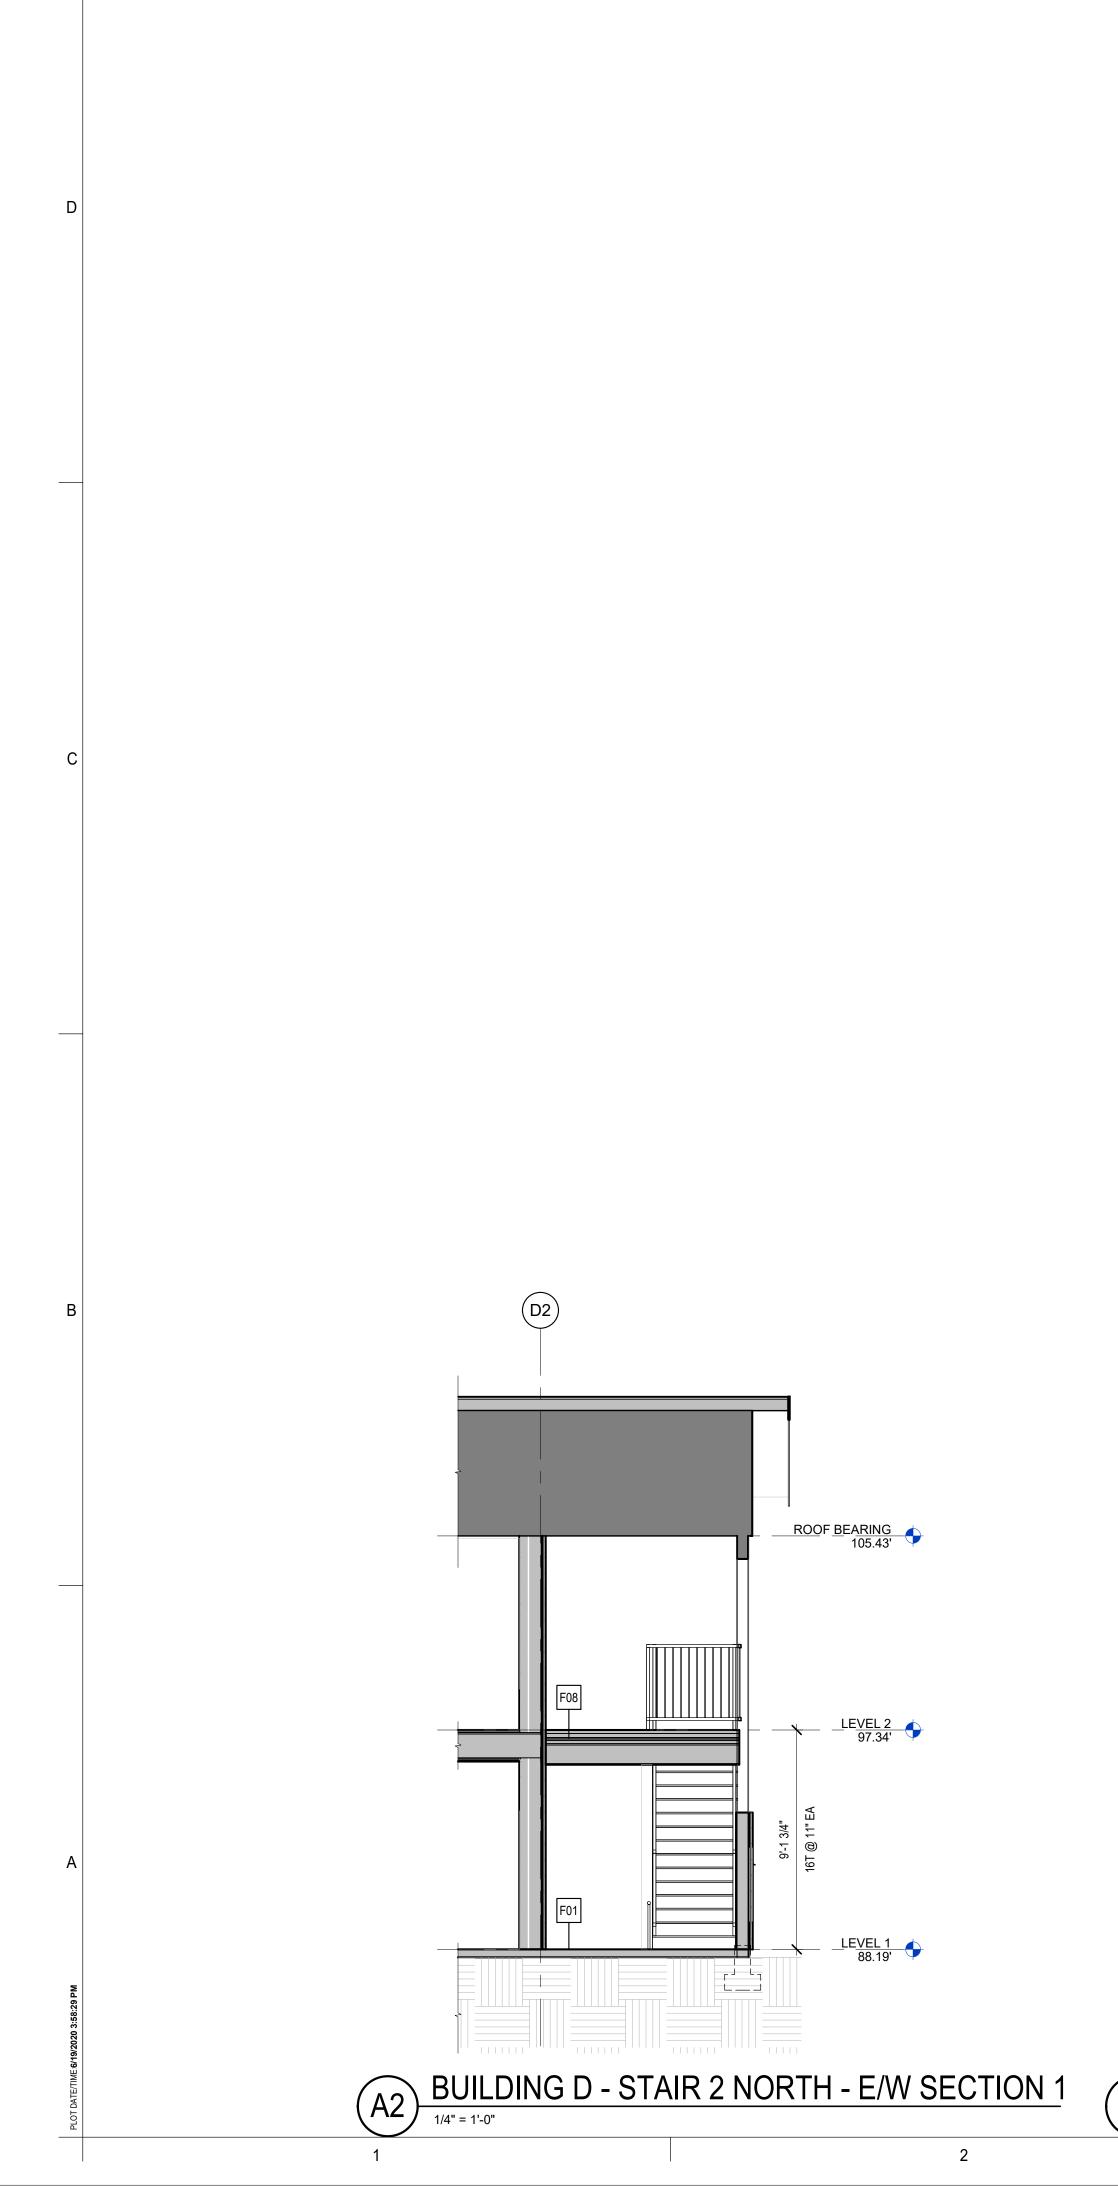

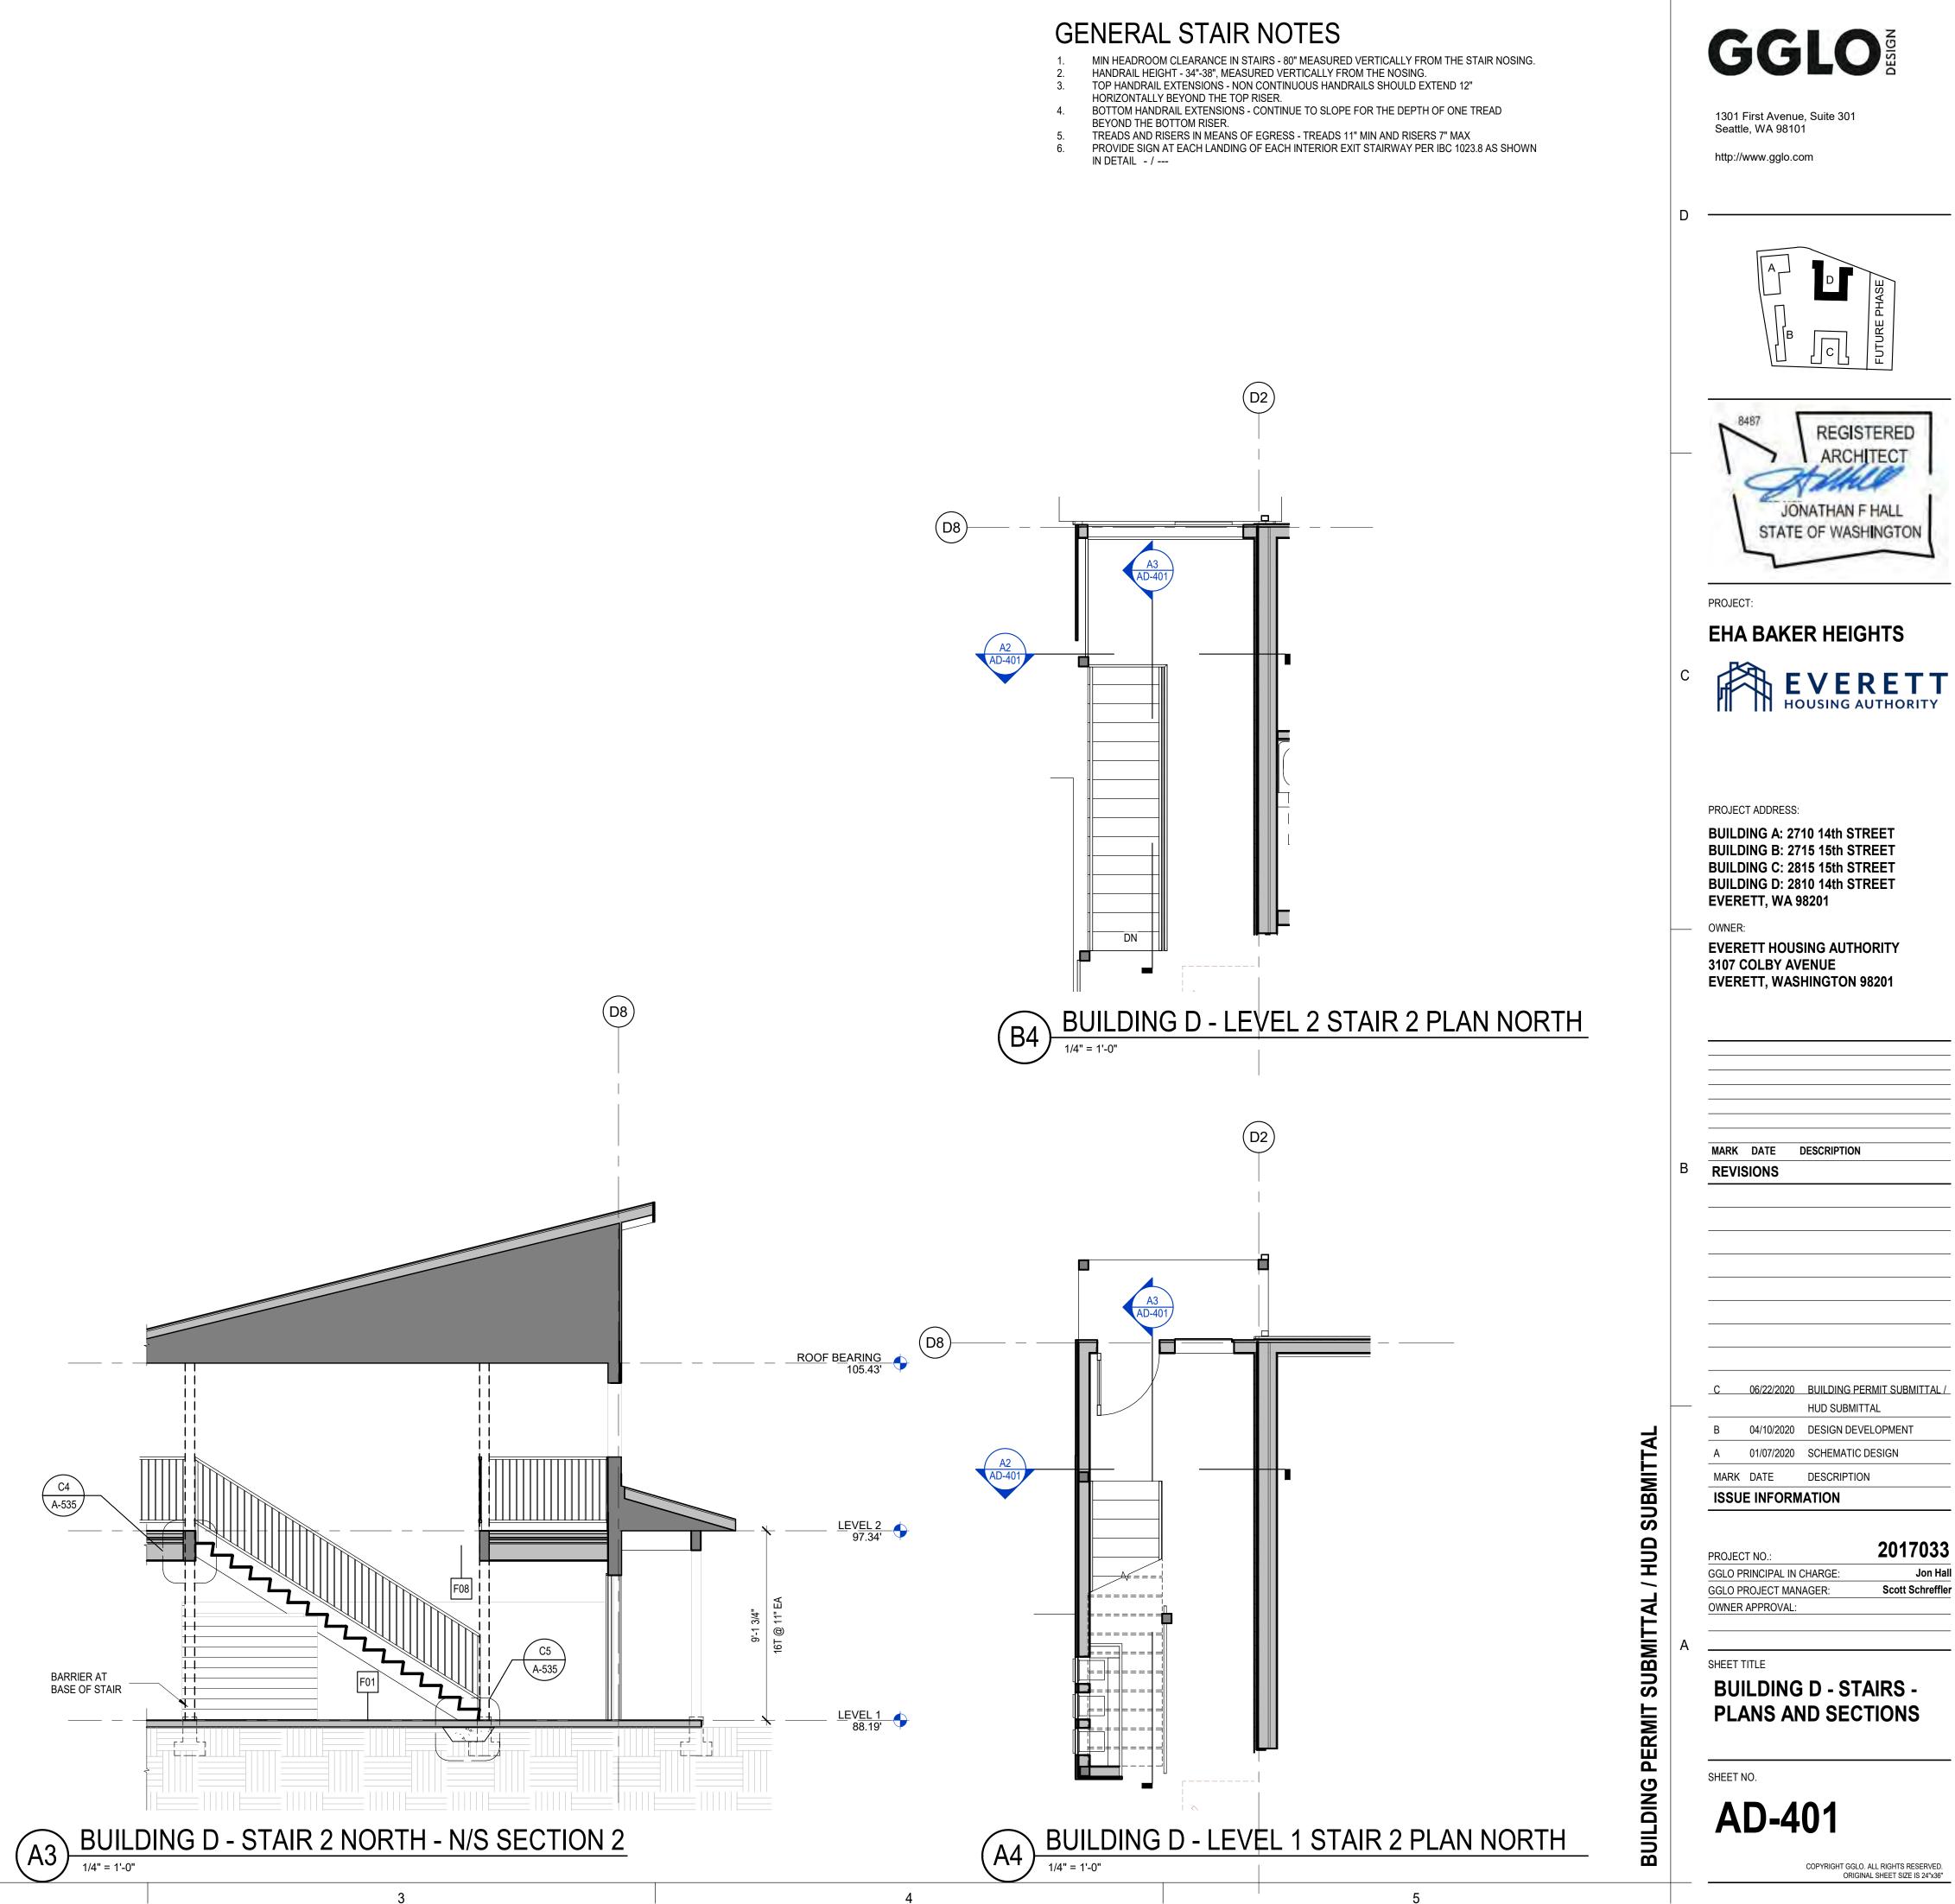

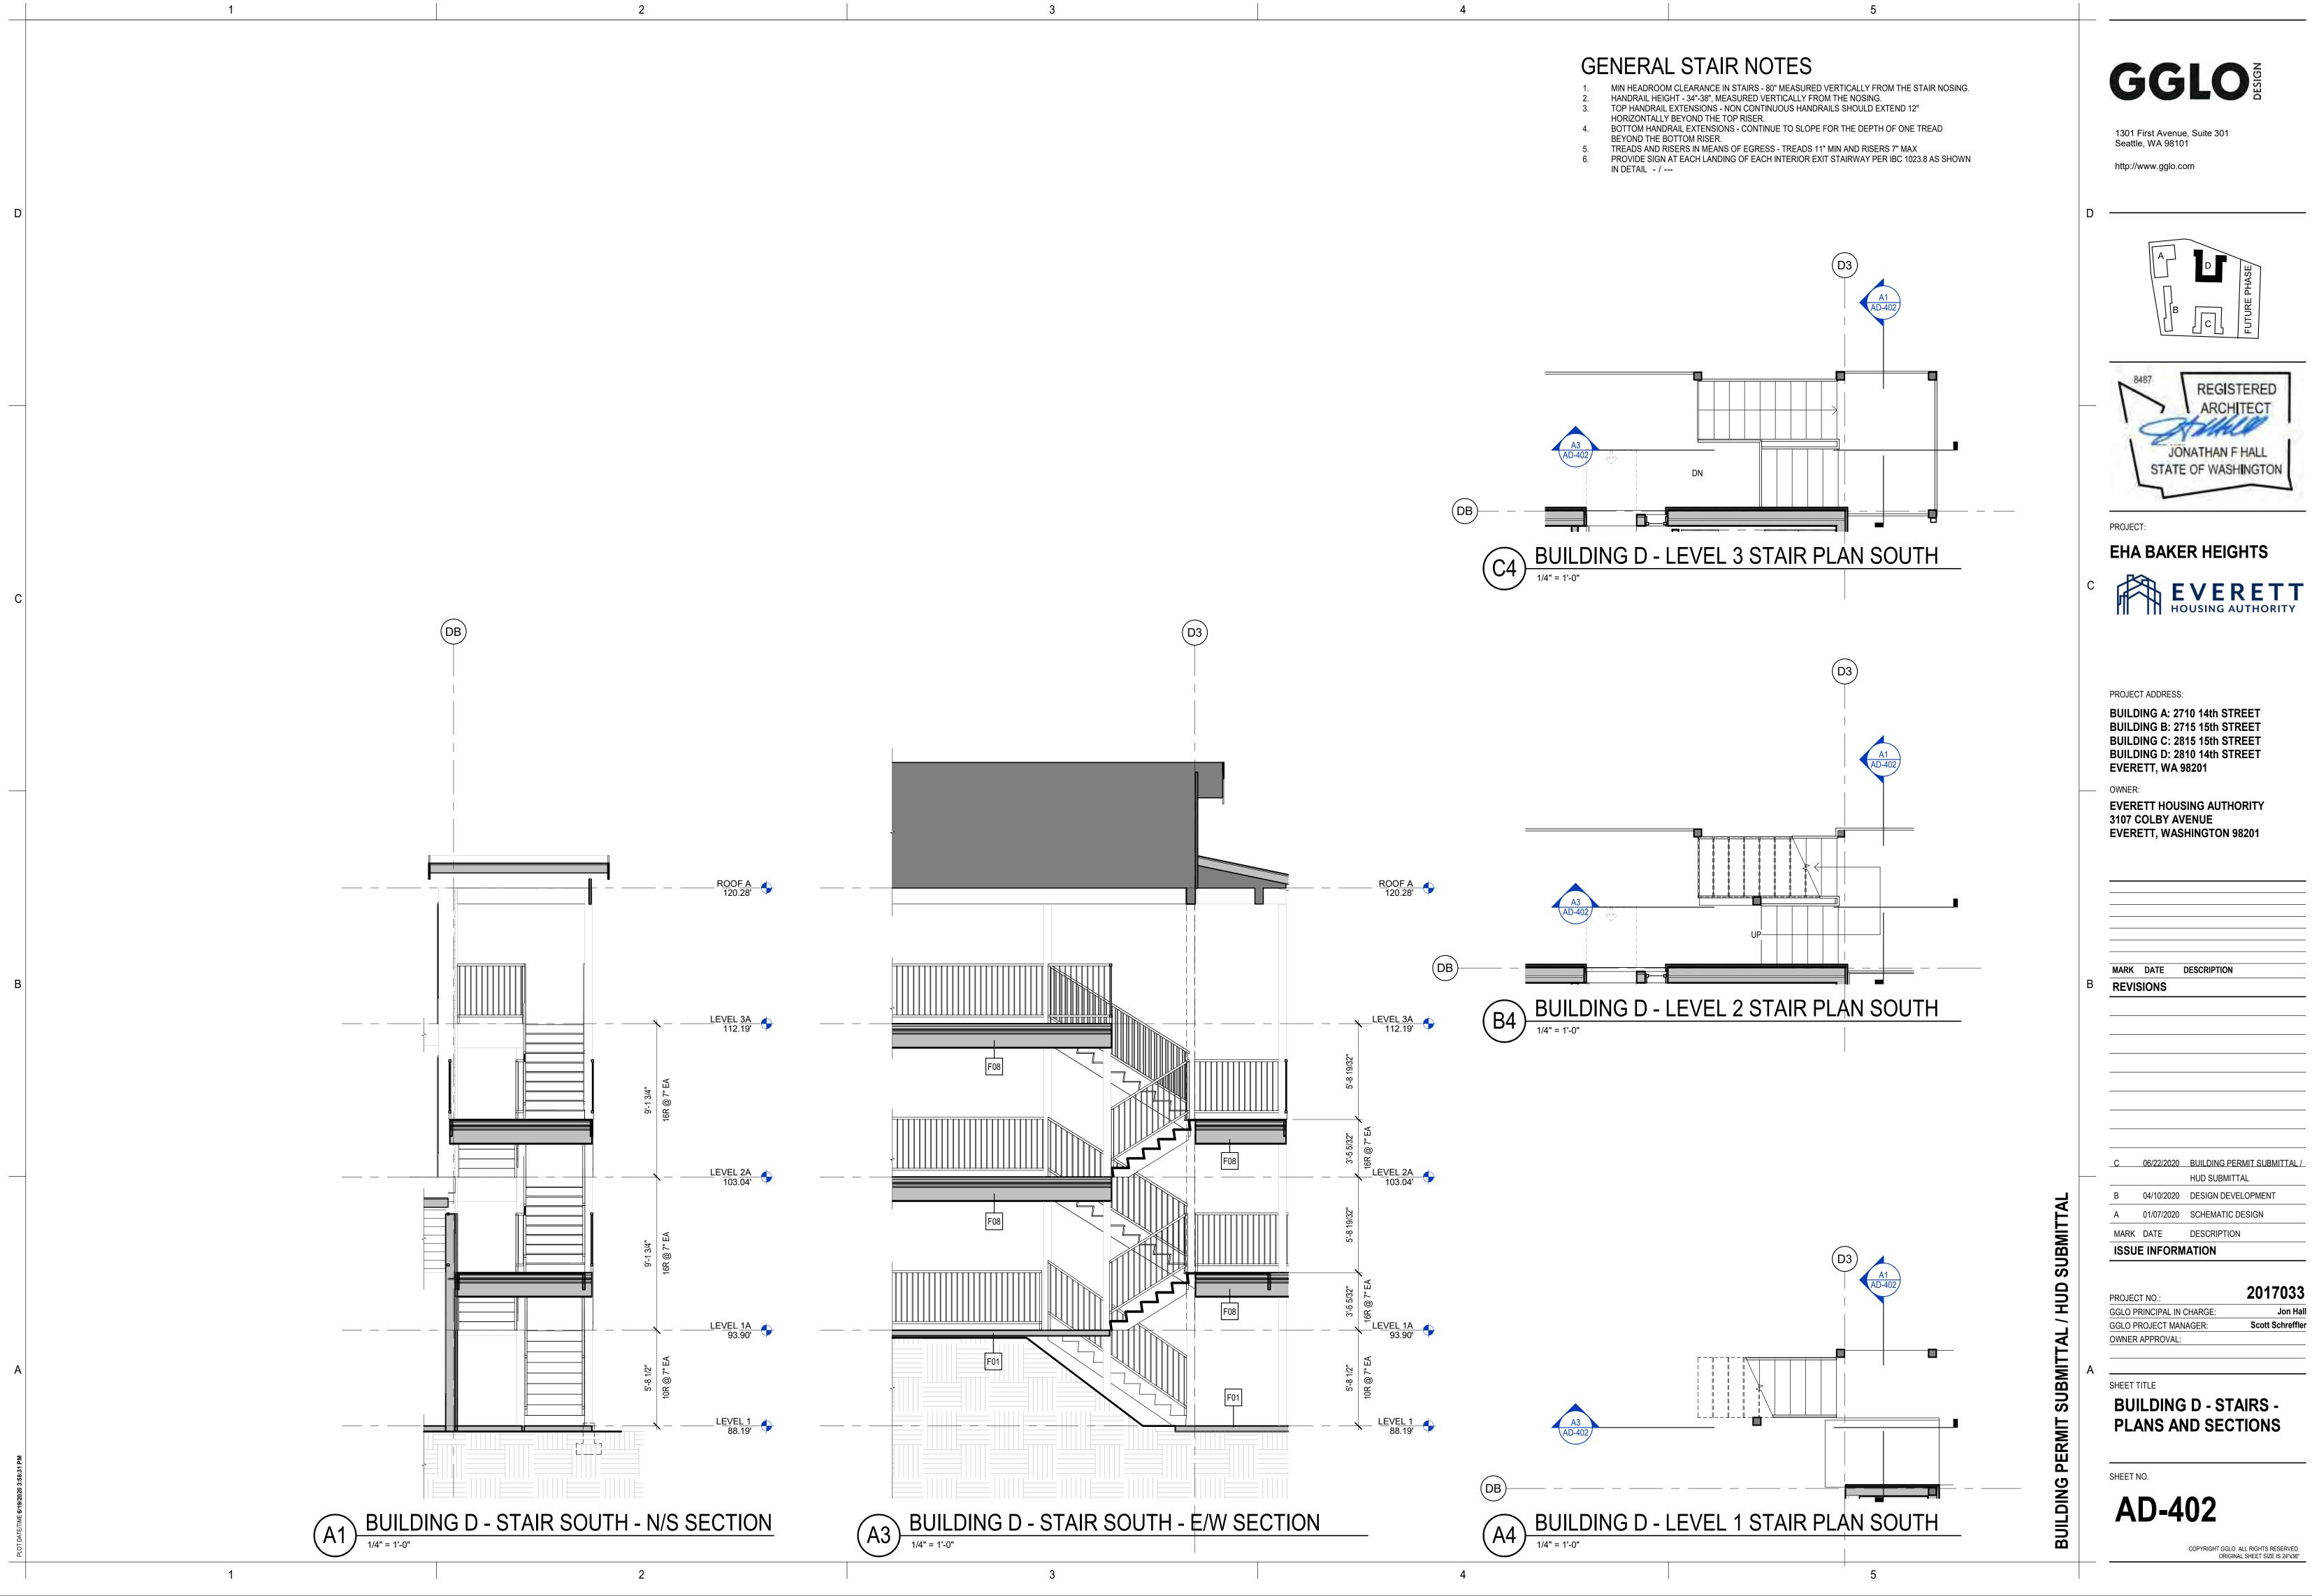





	A D SHASE
	REGISTERED ARCHITECT JONATHAN F HALL STATE OF WASHINGTON
С	EHA BAKER HEIGHTS EVERETT HOUSING AUTHORITY
	PROJECT ADDRESS: BUILDING A: 2710 14th STREET BUILDING B: 2715 15th STREET BUILDING C: 2815 15th STREET BUILDING D: 2810 14th STREET EVERETT, WA 98201 OWNER: EVERETT HOUSING AUTHORITY 3107 COLBY AVENUE EVERETT, WASHINGTON 98201
	MARK DATE DESCRIPTION
В	REVISIONS
	C06/22/2020BUILDING PERMIT SUBMITTAL / HUD SUBMITTALB04/10/2020DESIGN DEVELOPMENTA01/07/2020SCHEMATIC DESIGNMARKDATEDESCRIPTIONISSUE INFORMATION
А	PROJECT NO.: 2017033 GGLO PRINCIPAL IN CHARGE: Jon Hall GGLO PROJECT MANAGER: Scott Schreffler OWNER APPROVAL:
	SHEET TITLE BUILDING D - 3D

GGLO

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REPRESENTATIONS


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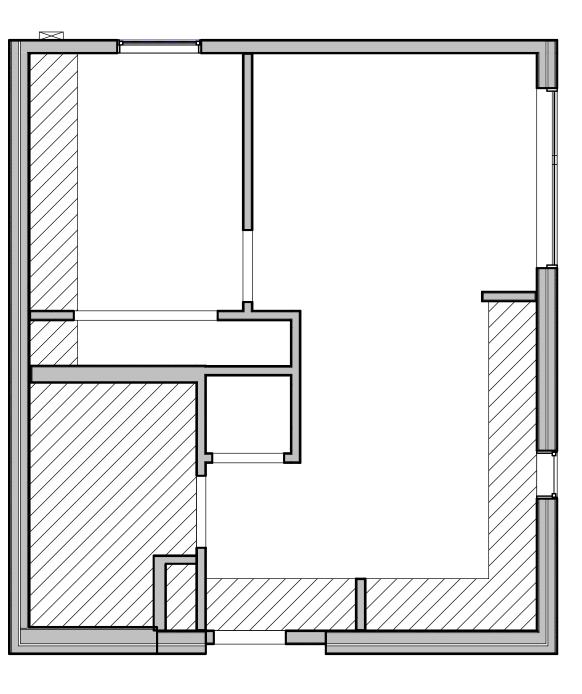
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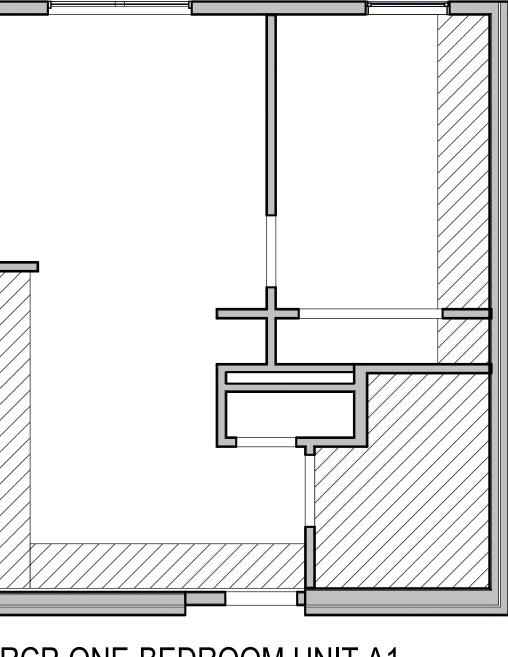
GENERAL UNIT PLAN NOTES

- PLAN DIMENSIONS ARE TO FACE OF STUD, FACE OF CONCRETE WALL, CENTERLINE OF COLUMN, OR CENTERLINE OF ROUGH OPENINGS, UON. CONTACT ARCHITECT FOR CLARIFICATIONS.
- DOORS AND CASED OPENINGS INDICATED ADJACENT TO WALL INTERSECTIONS SHALL BE 2. LOCATED WITH THE EDGE OF FINISH OPENING SIX INCHES FROM THE ADJACENT WALL AT THE EXTERIOR AND FOUR INCHES FROM THE ADJACENT WALL.
- 3. SEE SHEET A-XXX & A-XXX FOR WINDOW SCHEDULE AND DETAILS.
- SEE SHEET A-XXX & A-XXX FOR DOOR SCHEDULE AND DETAILS. 4.
- SEE SHEET A-XXX & A-XXX FOR WALL ASSEMBLIES. 5.
- INSTALL BLOCKING FOR GRAB BARS IN ALL BATHROOM WALLS SURROUNDING WATER CLOSET, BATHTUB AND SHOWER. REF A-XXX. 6.
- HANDRAILS SHALL RETURN TO A WALL, GUARD OR THE WALKING SURFACE OR SHALL BE 7 CONTINUOUS TO THE HANDRAIL OF AN ADJACENT STAIR FLIGHT OR RAMP RUN - PER IBC 1012.5.



(B5) RCP-ONE-BEDROOM UNIT A1A TYPE A

1/4" = 1'-0"

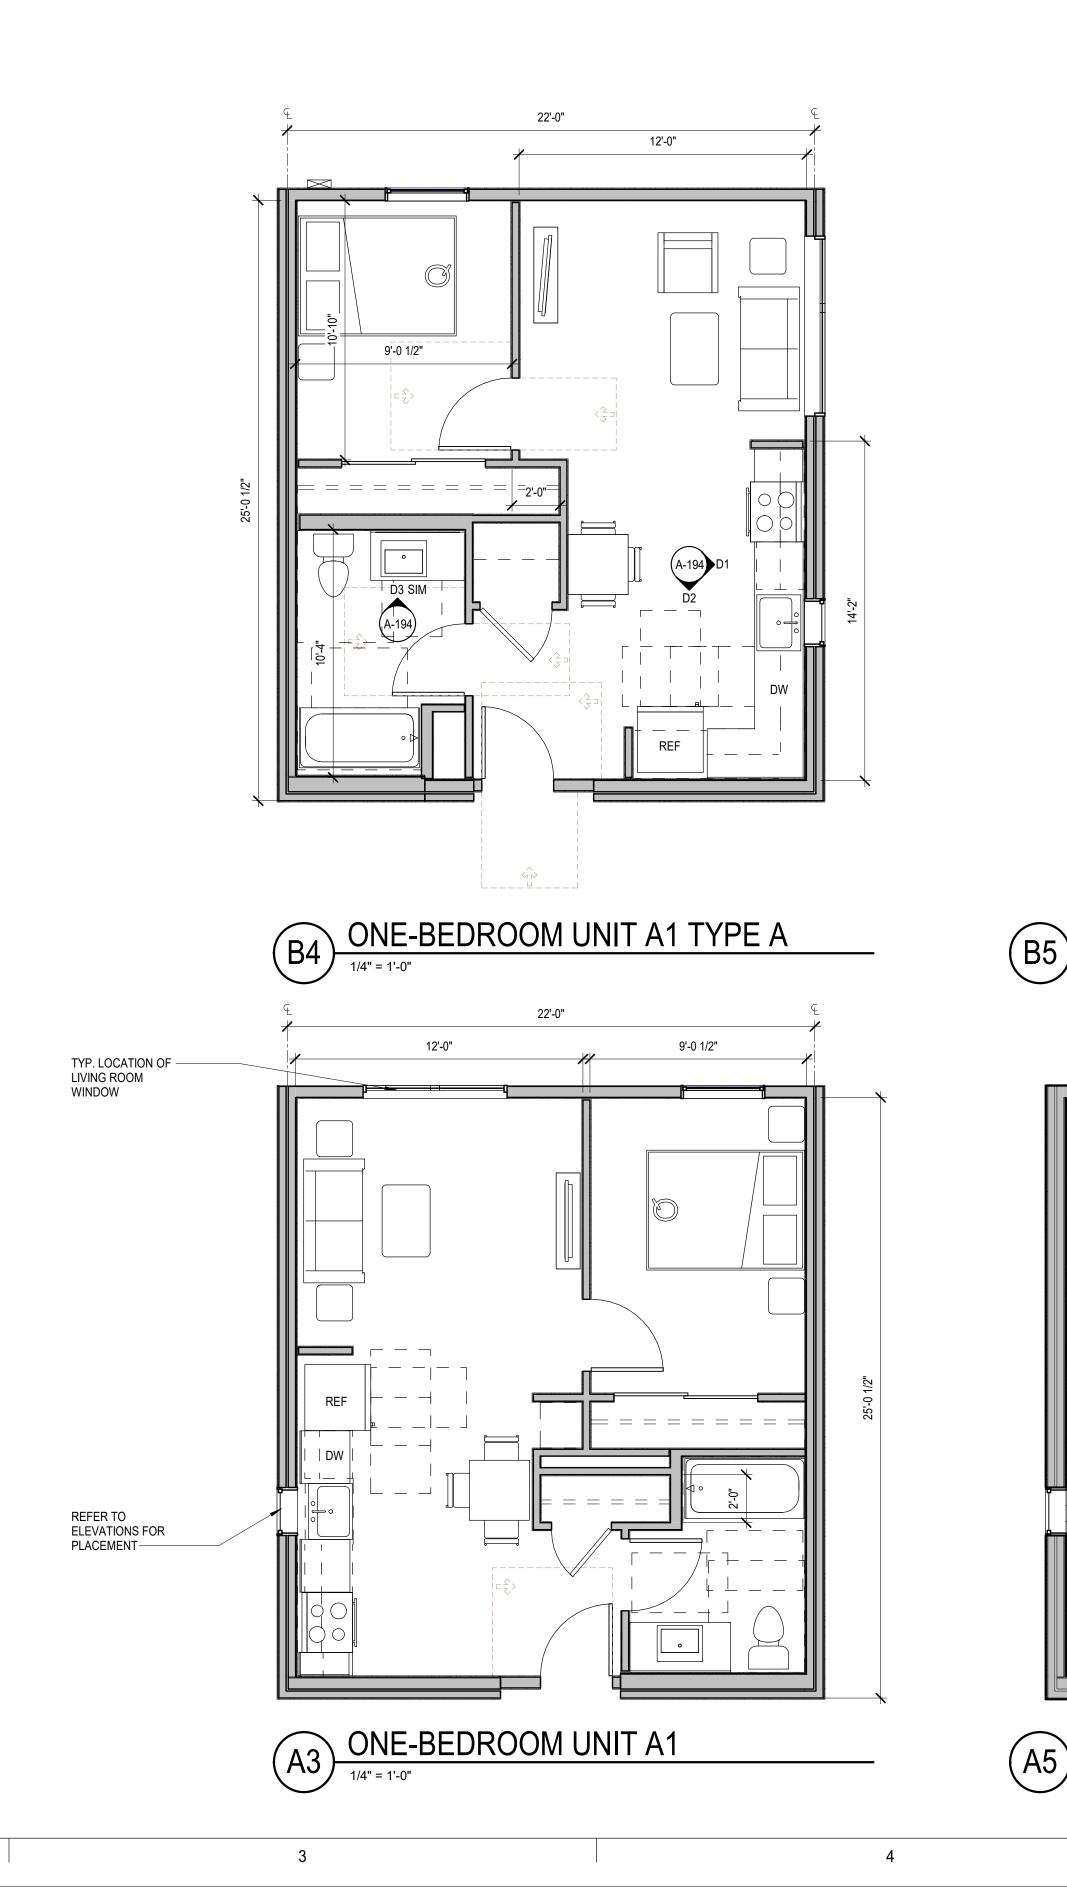

RCP-ONE-BEDROOM UNIT A1 1/4" = 1'-0"

5

HUD SUBMITTA **SUBMITTAL** F **BUILDING PERM**

848 REGISTERED JONATHAN F HALL STATE OF WASHINGTON PROJECT: EHA BAKER HEIGHTS HOUSING AUTHORITY PROJECT ADDRESS: BUILDING A: 2710 14th STREET BUILDING B: 2715 15th STREET BUILDING C: 2815 15th STREET BUILDING D: 2810 14th STREET **EVERETT, WA 98201** OWNER: EVERETT HOUSING LEGACY LLLP MARK DATE DESCRIPTION REVISIONS C 06/22/2020 BUILDING PERMIT SUBMITTAL / HUD SUBMITTAL 04/10/2020 DESIGN DEVELOPMENT A 01/07/2020 SCHEMATIC DESIGN MARK DATE DESCRIPTION **ISSUE INFORMATION** 2017033.00 PROJECT NO .: JON HALL GGLO PRINCIPAL IN CHARGE: GGLO PROJECT MANAGER: SCOTT SCHREFFLER OWNER APPROVAL SHEET TITLE **ONE BEDROOM UNIT** PLANS

GGLO


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Seattle, WA 98101


http://www.gglo.com


SHEET NO.

A-190



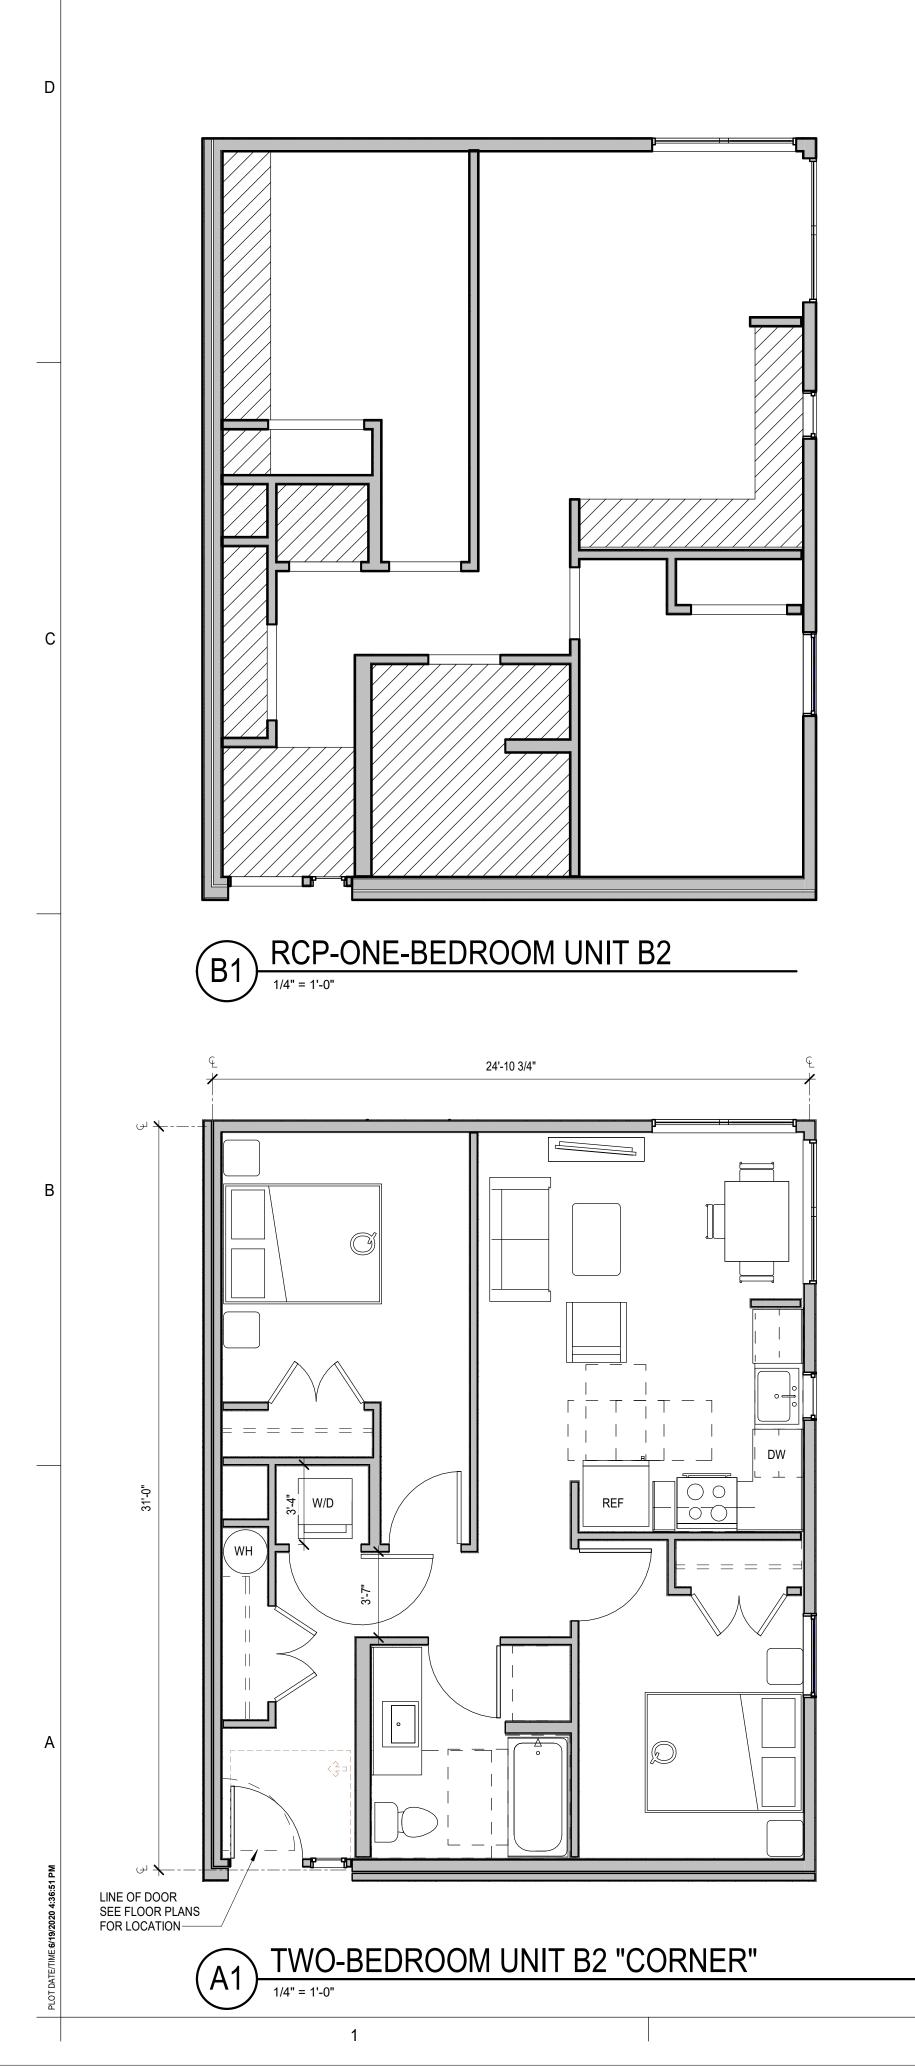


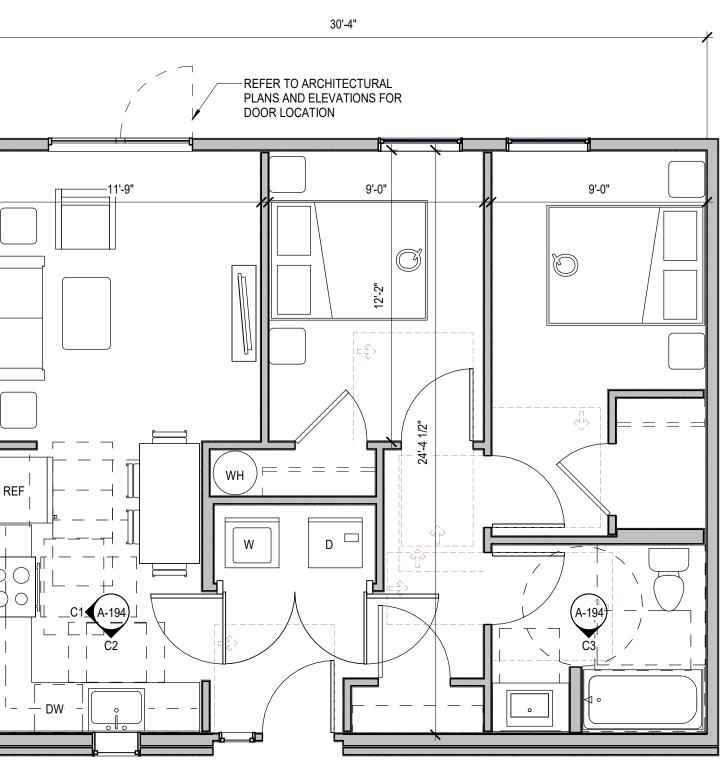


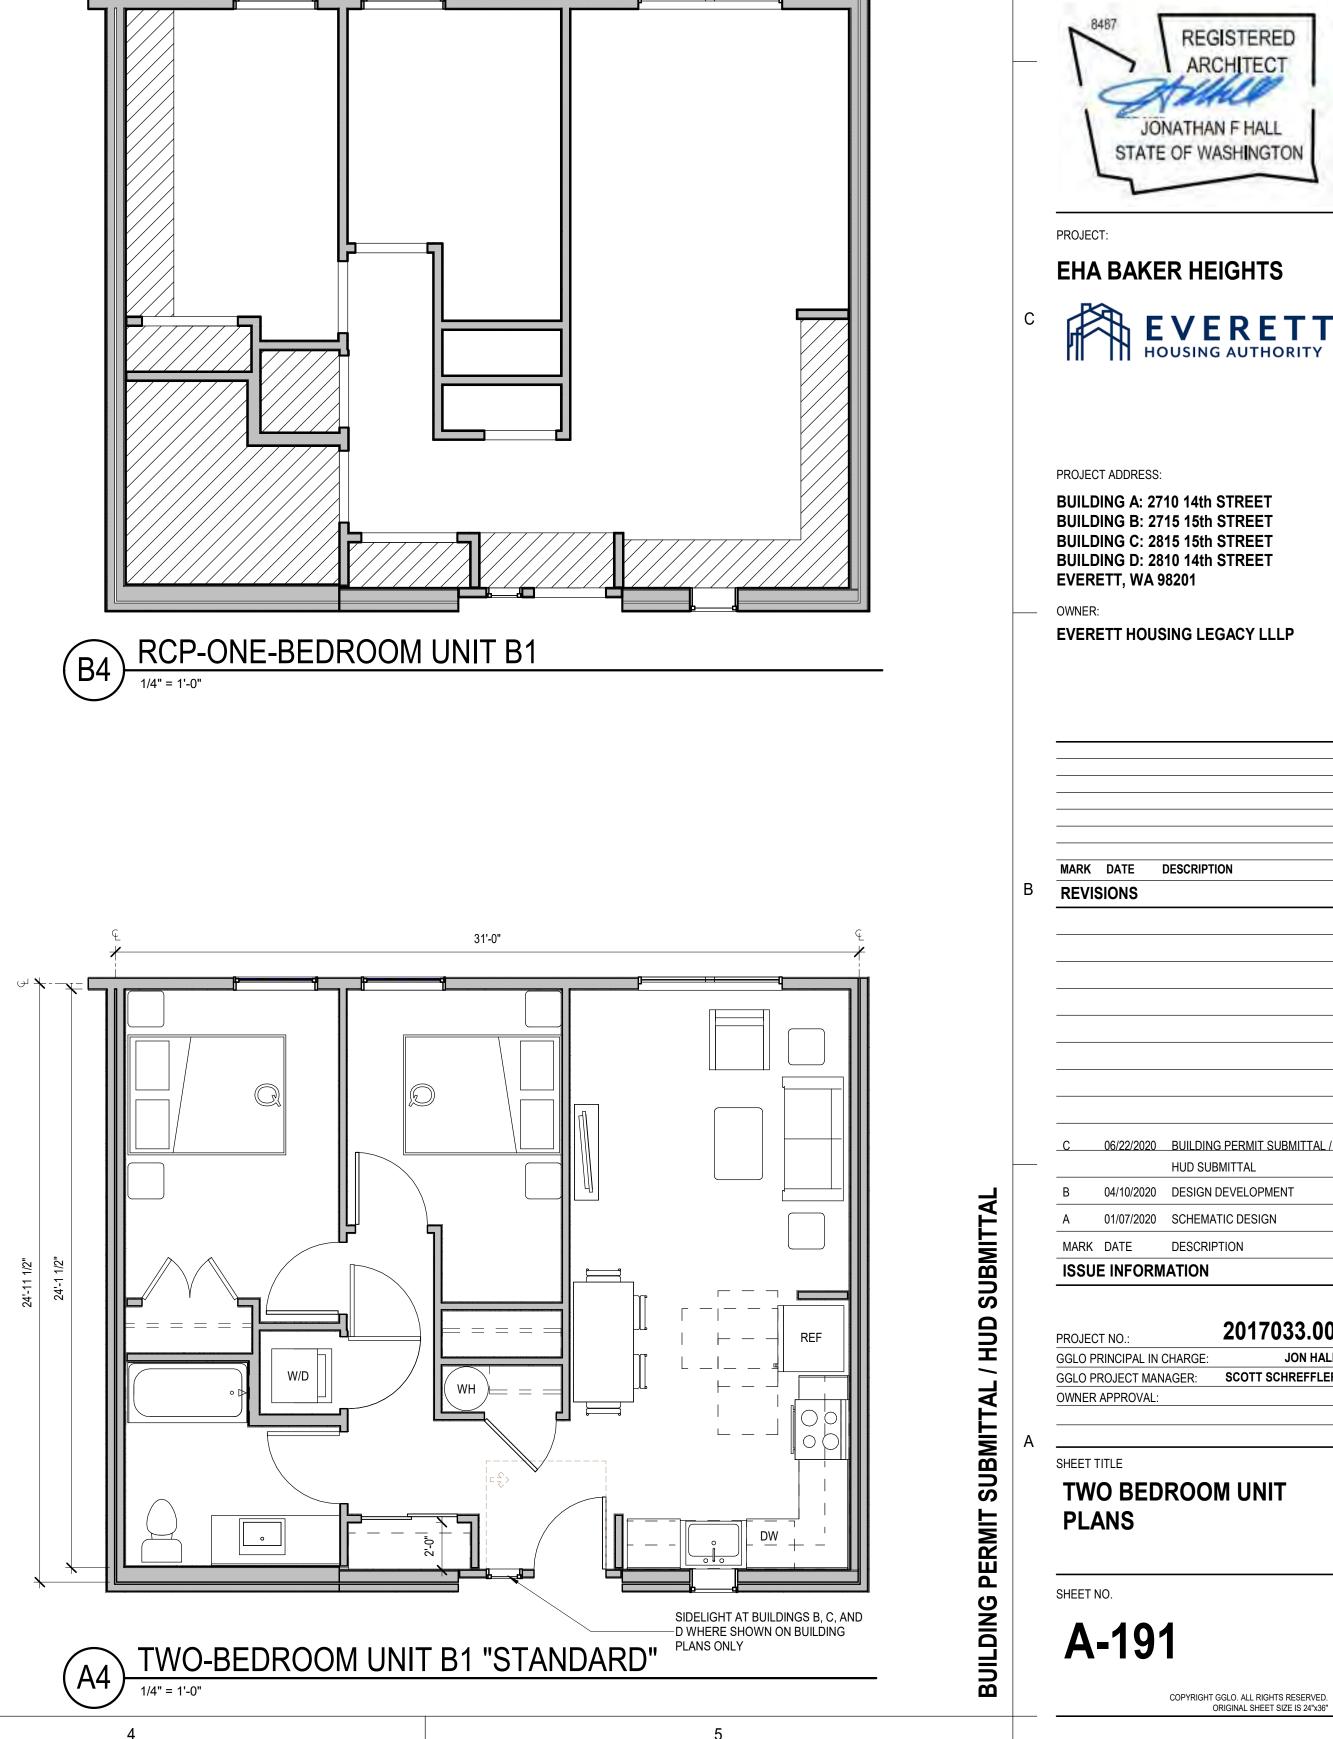



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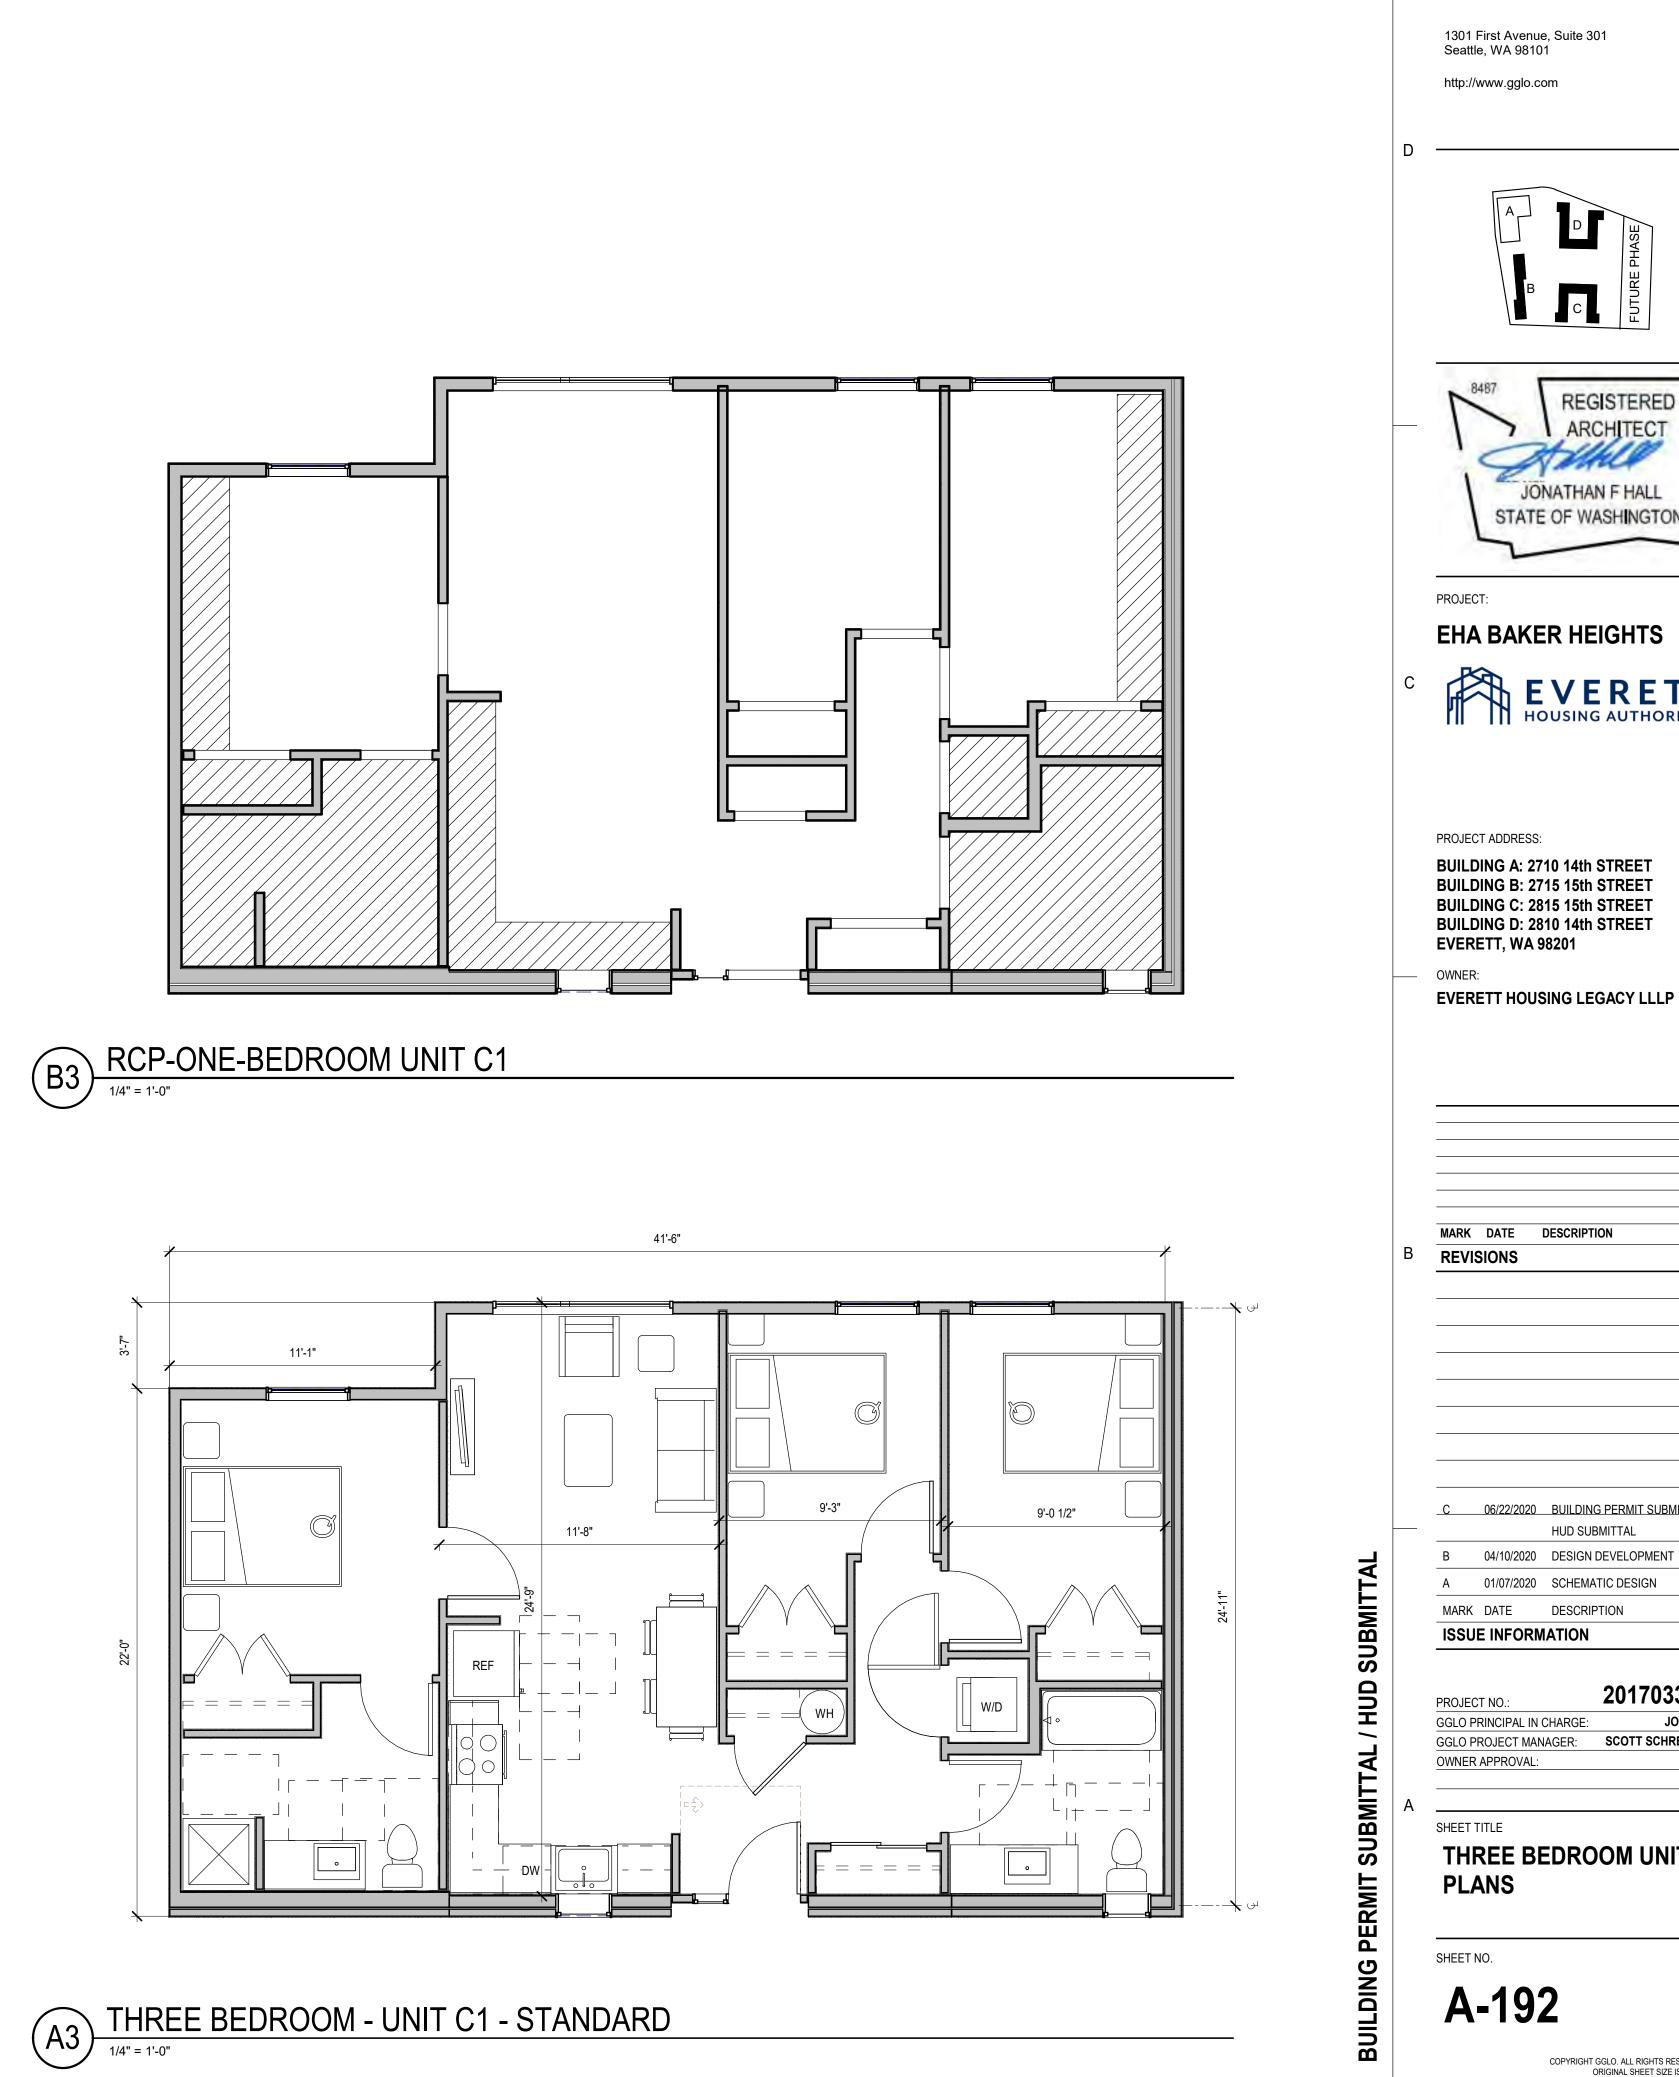


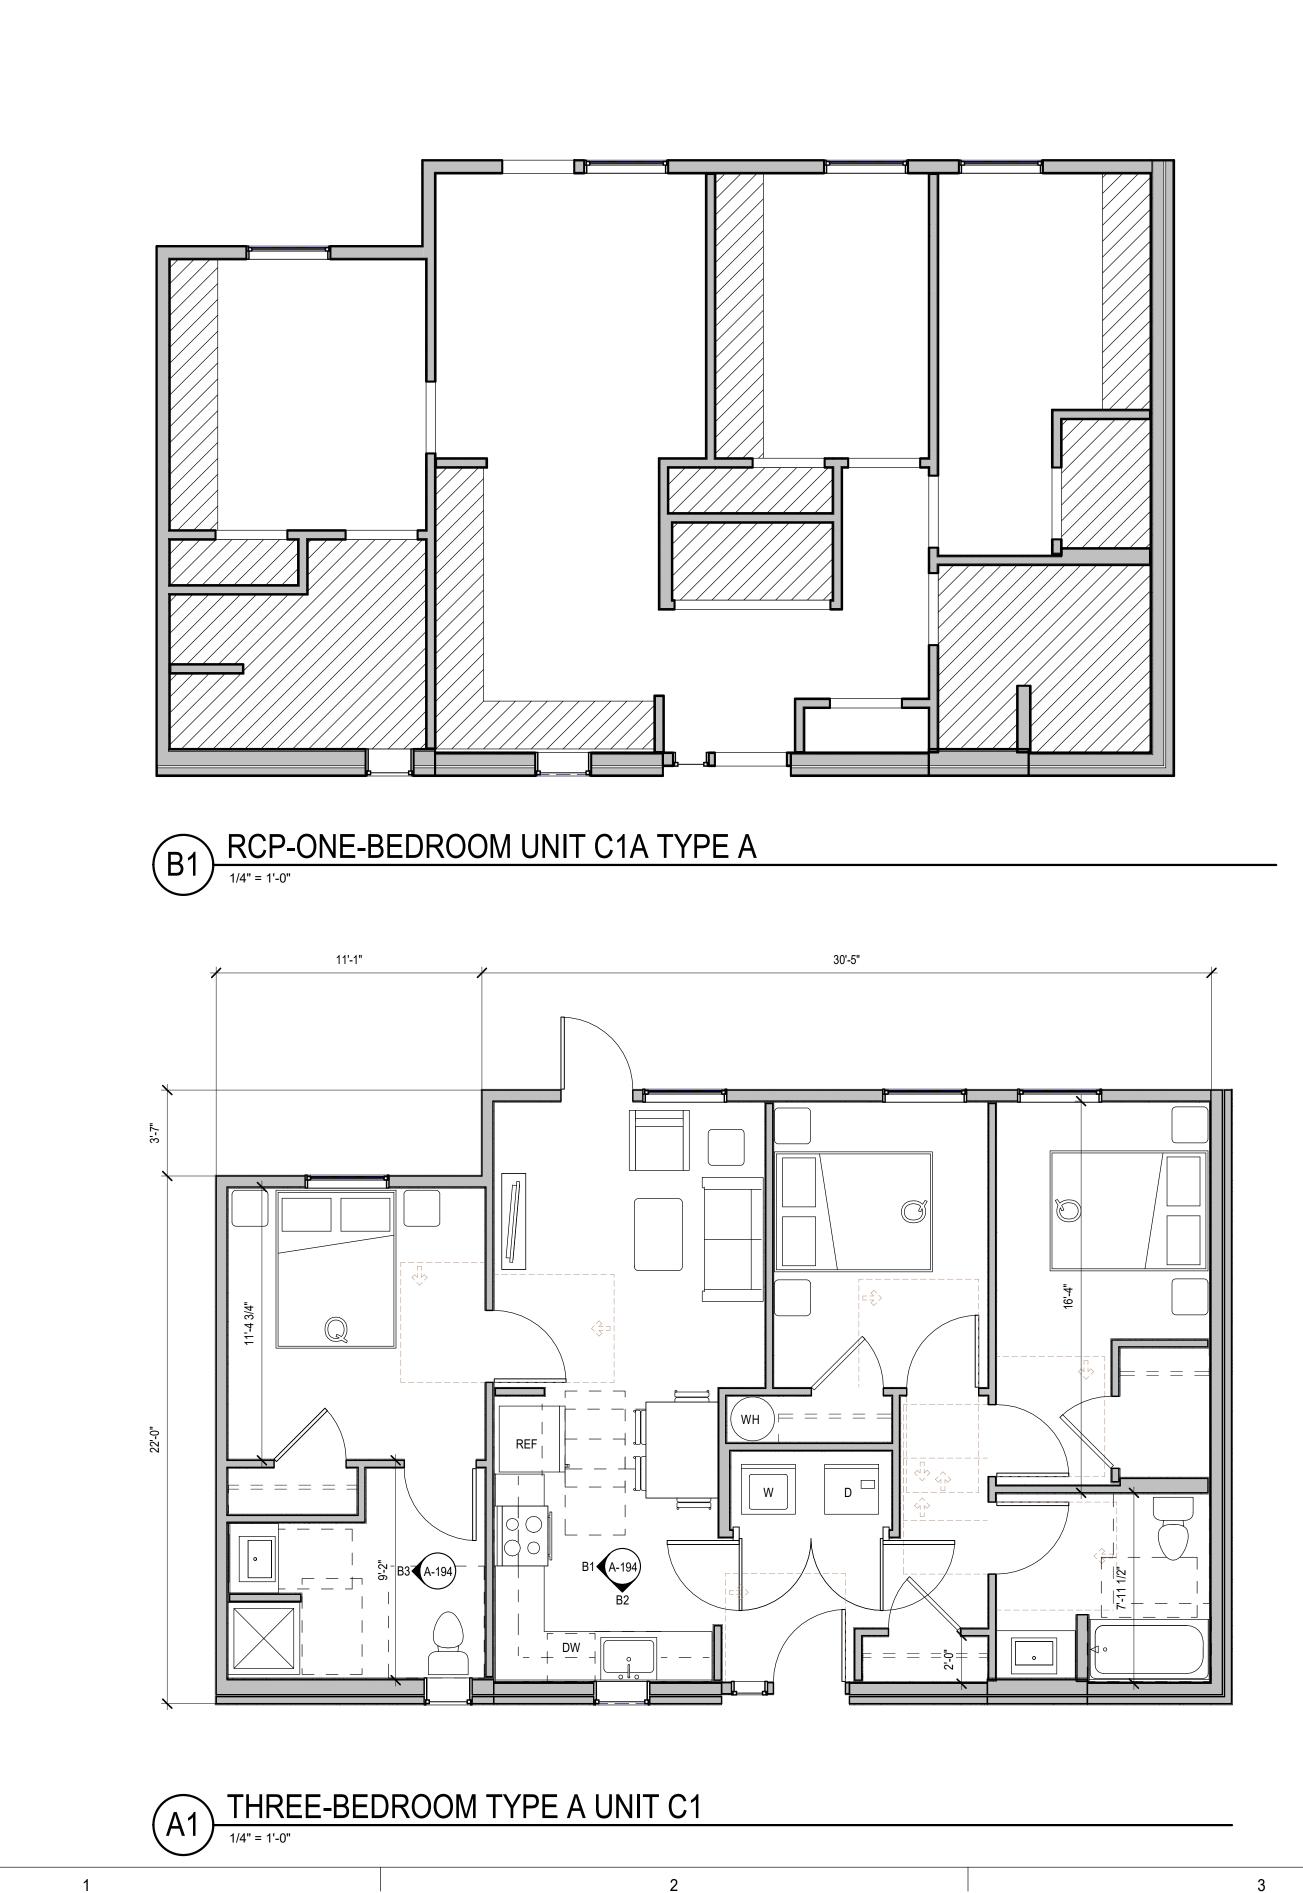

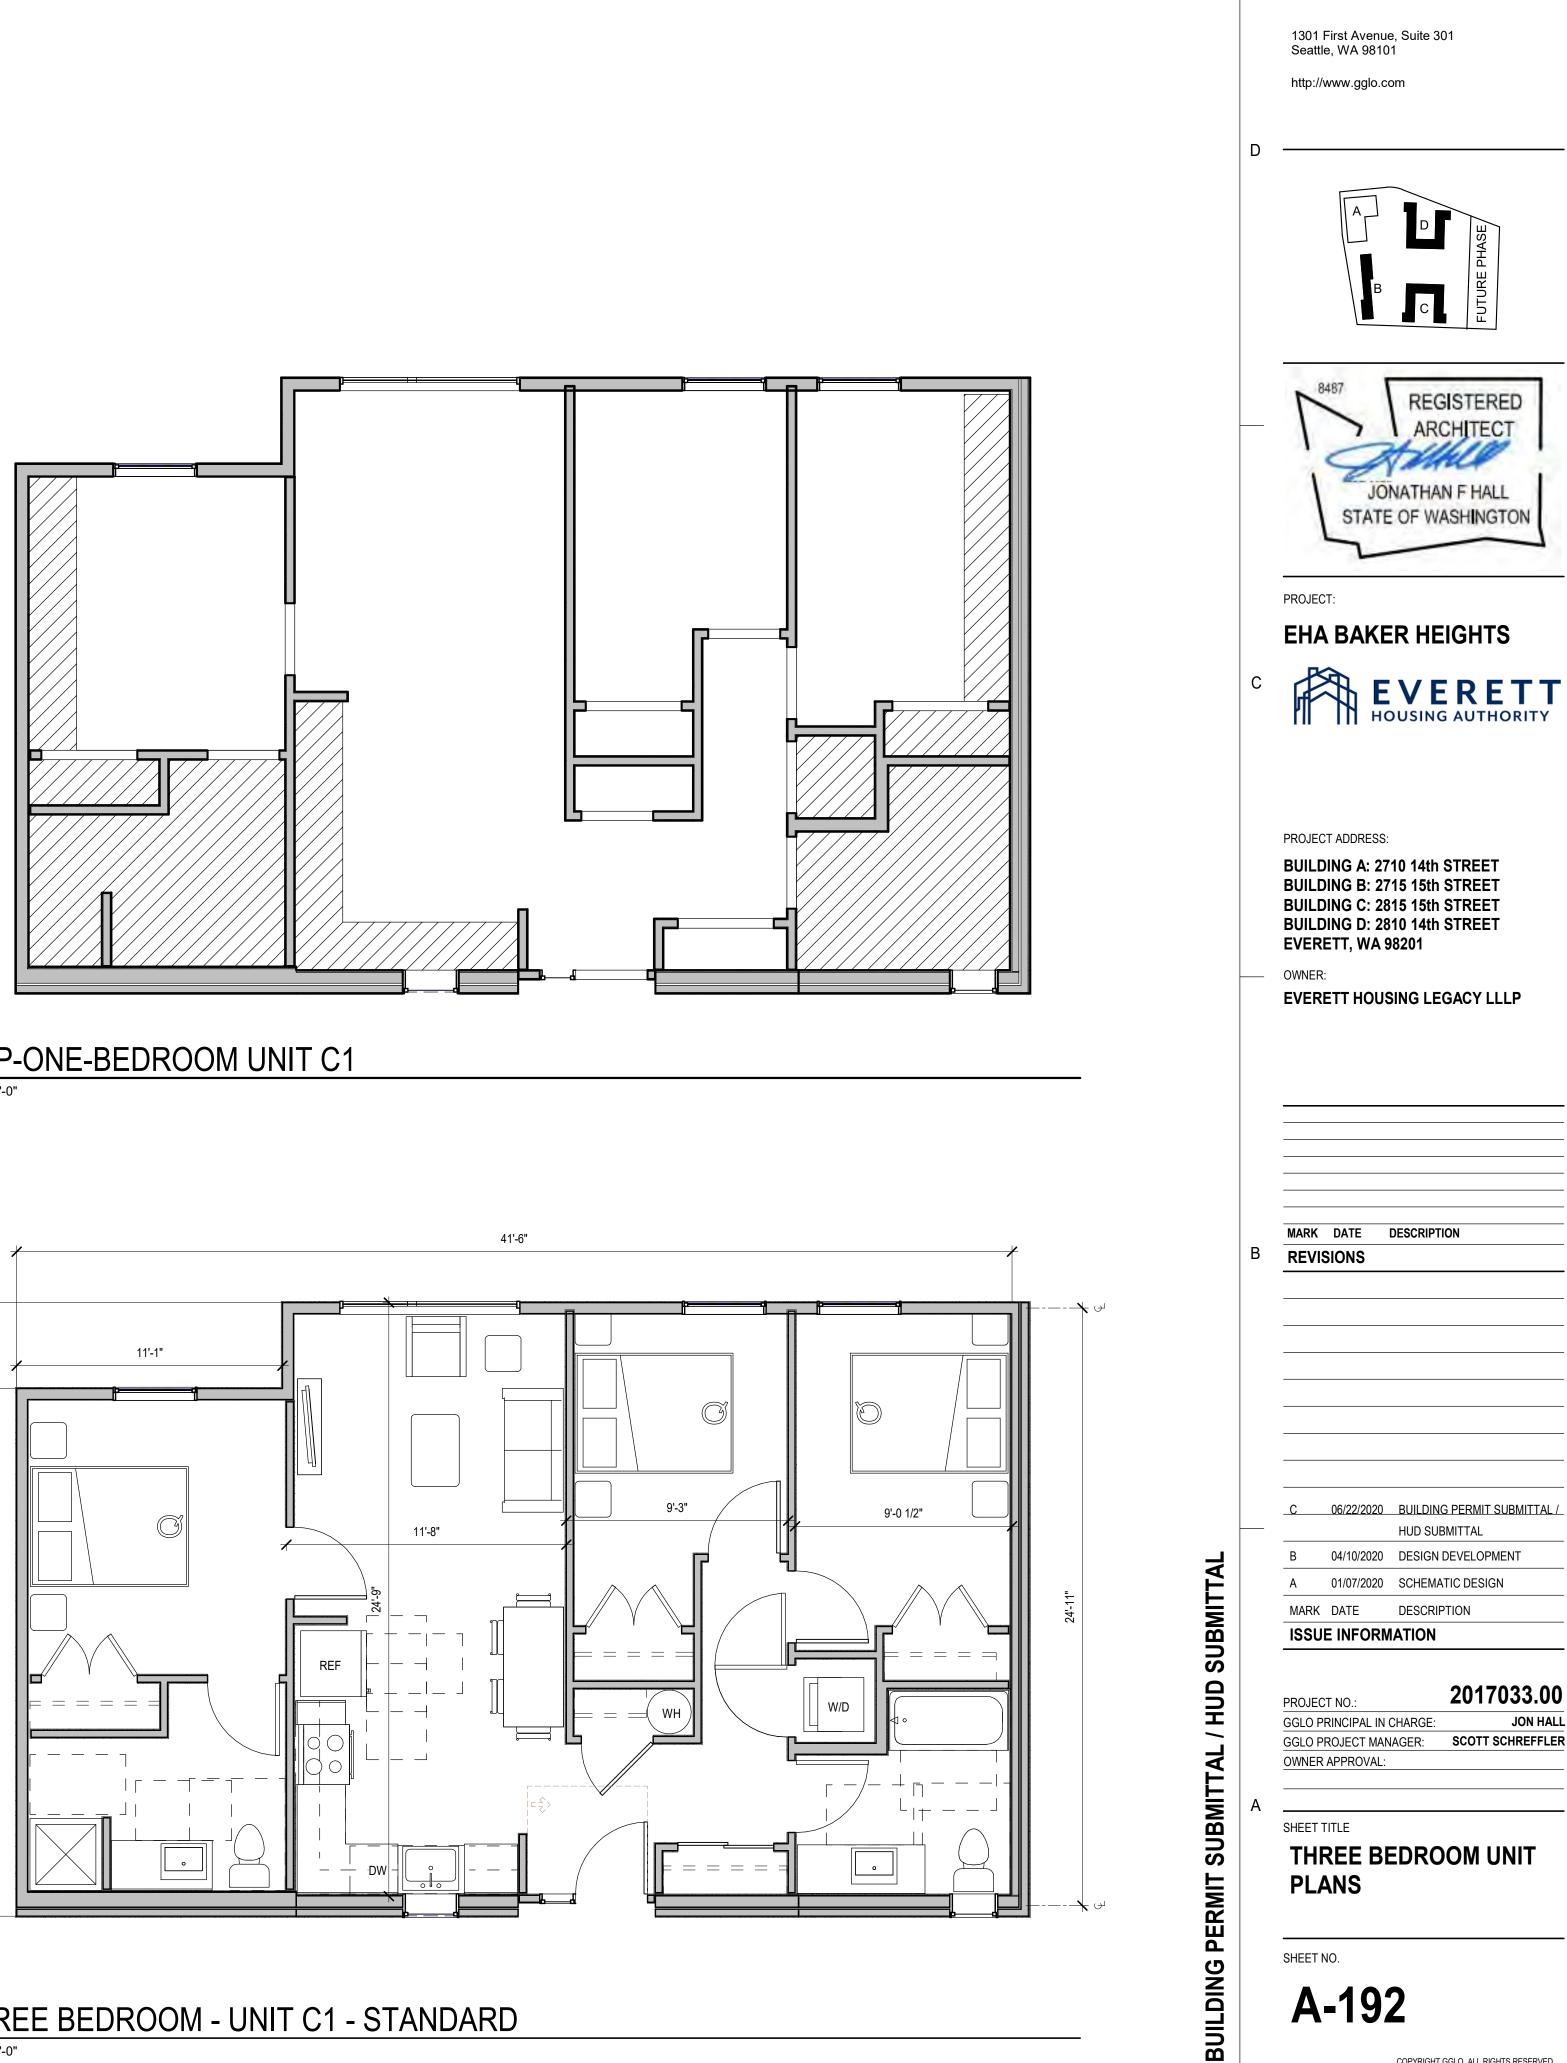
GGLO

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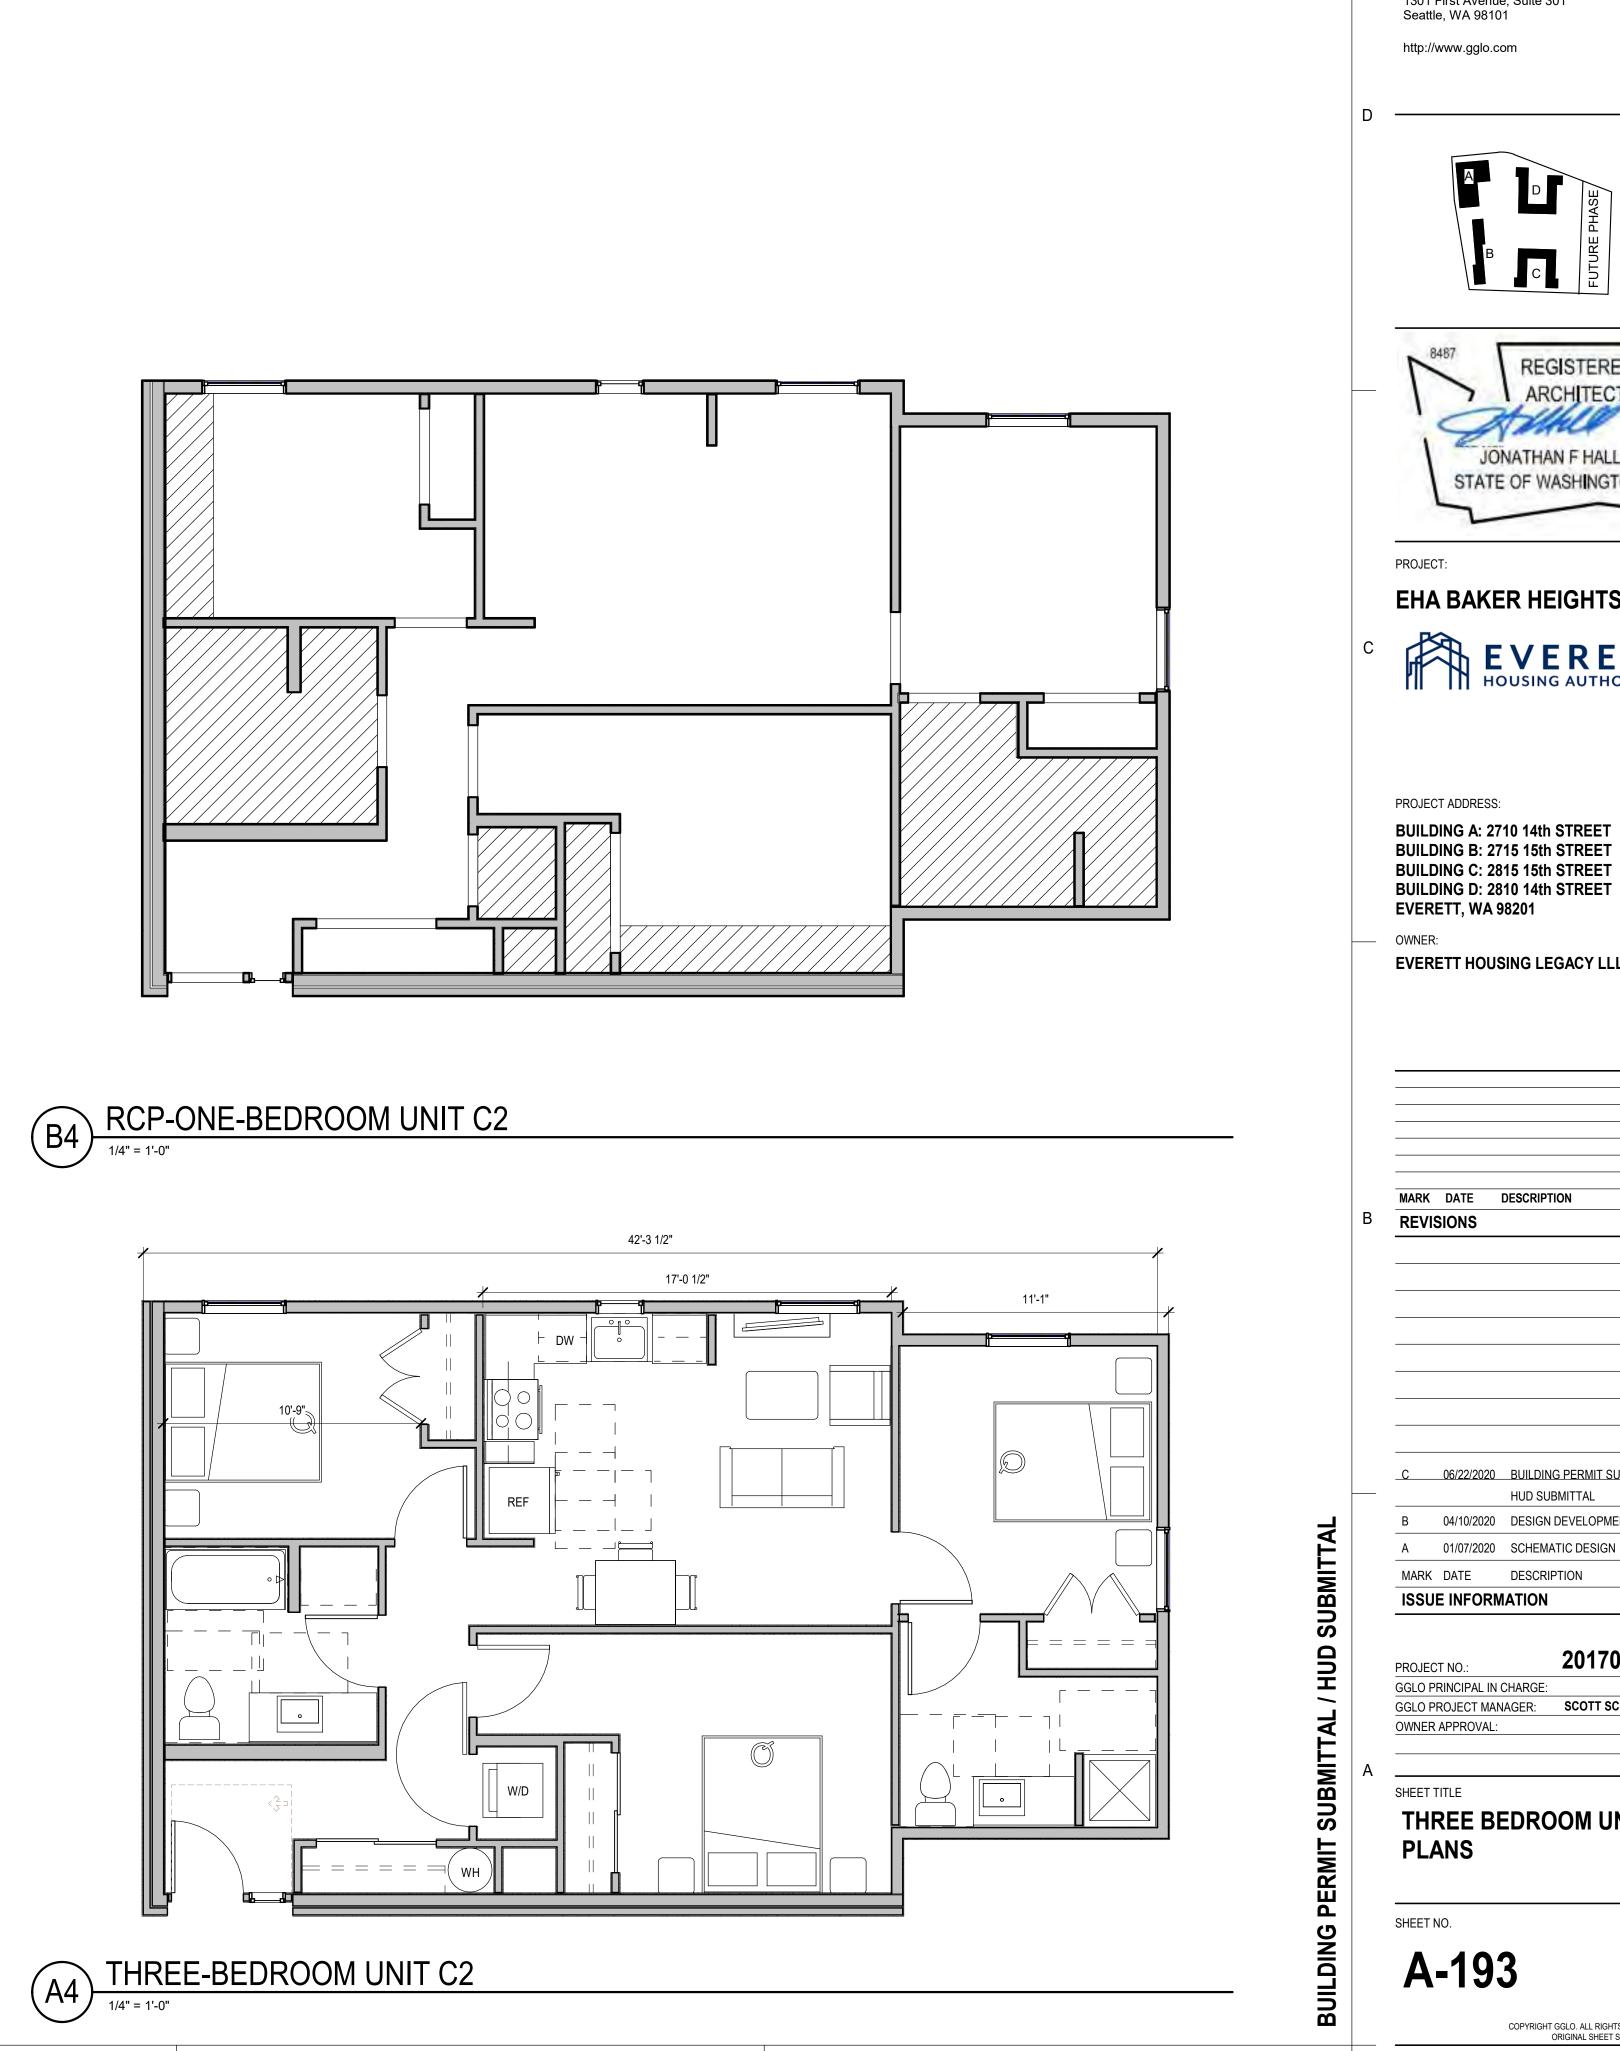


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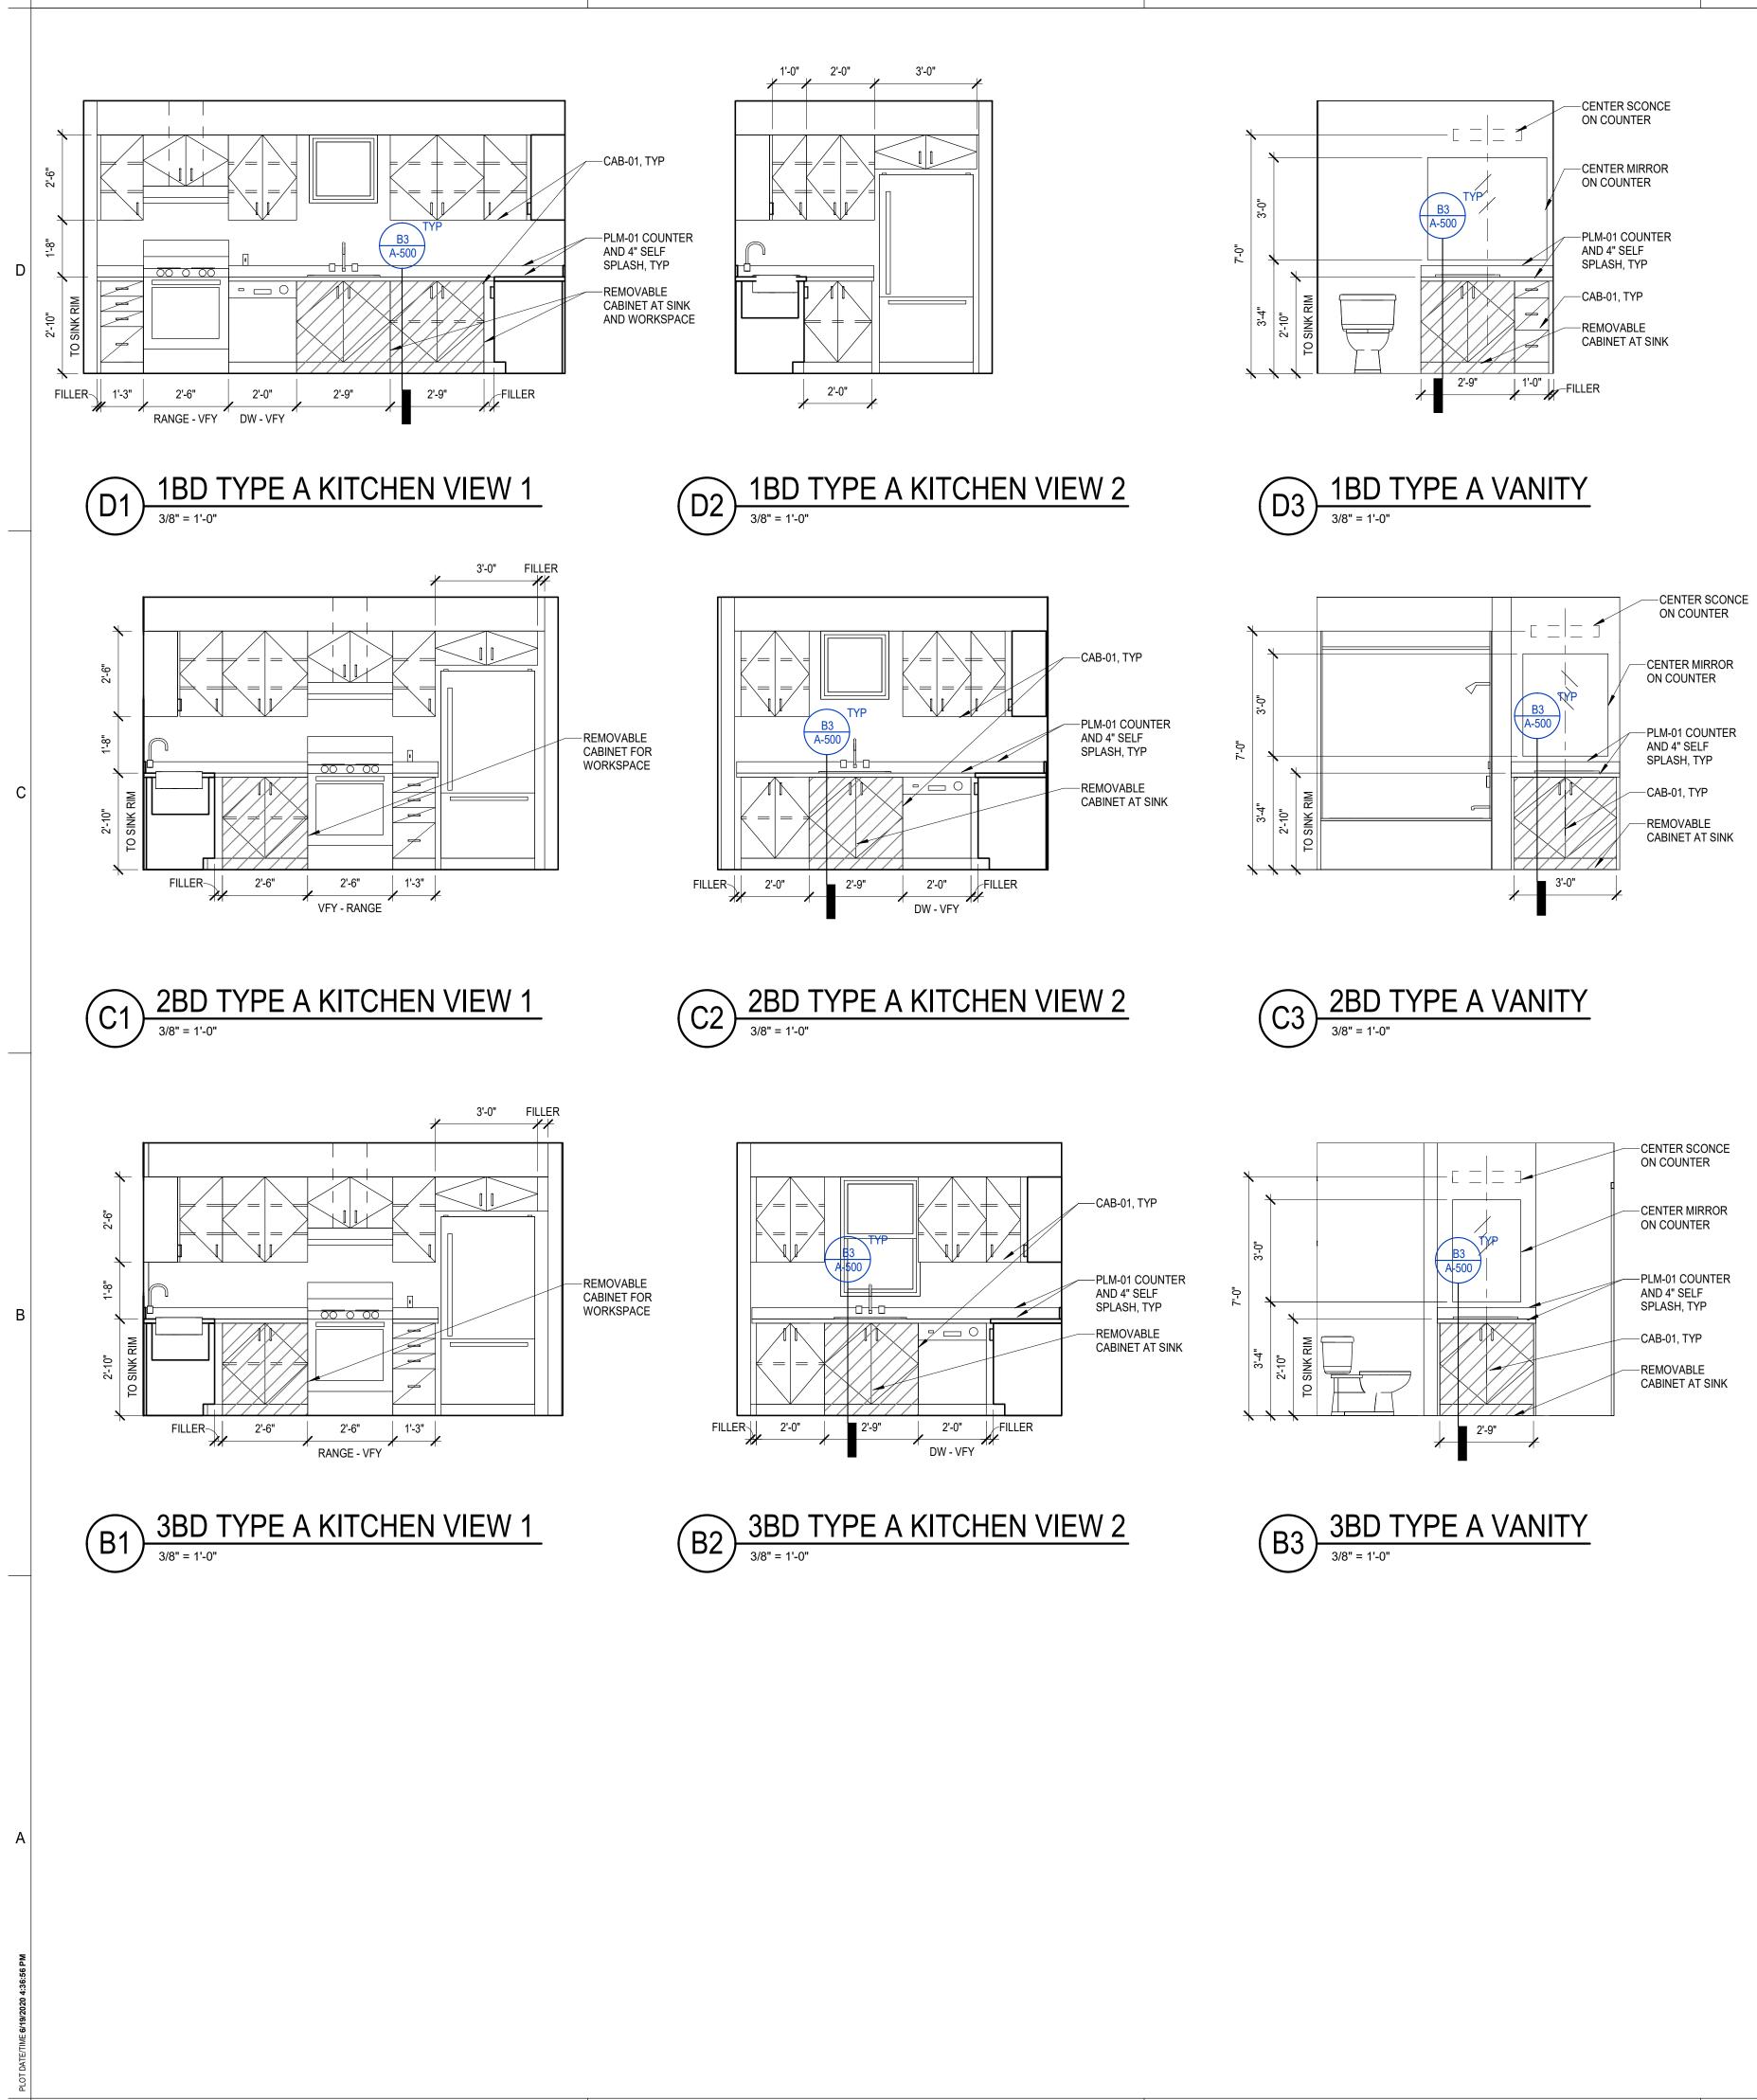


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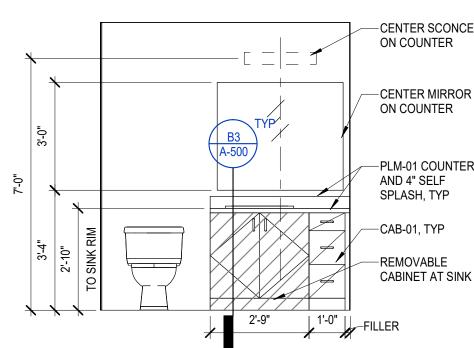


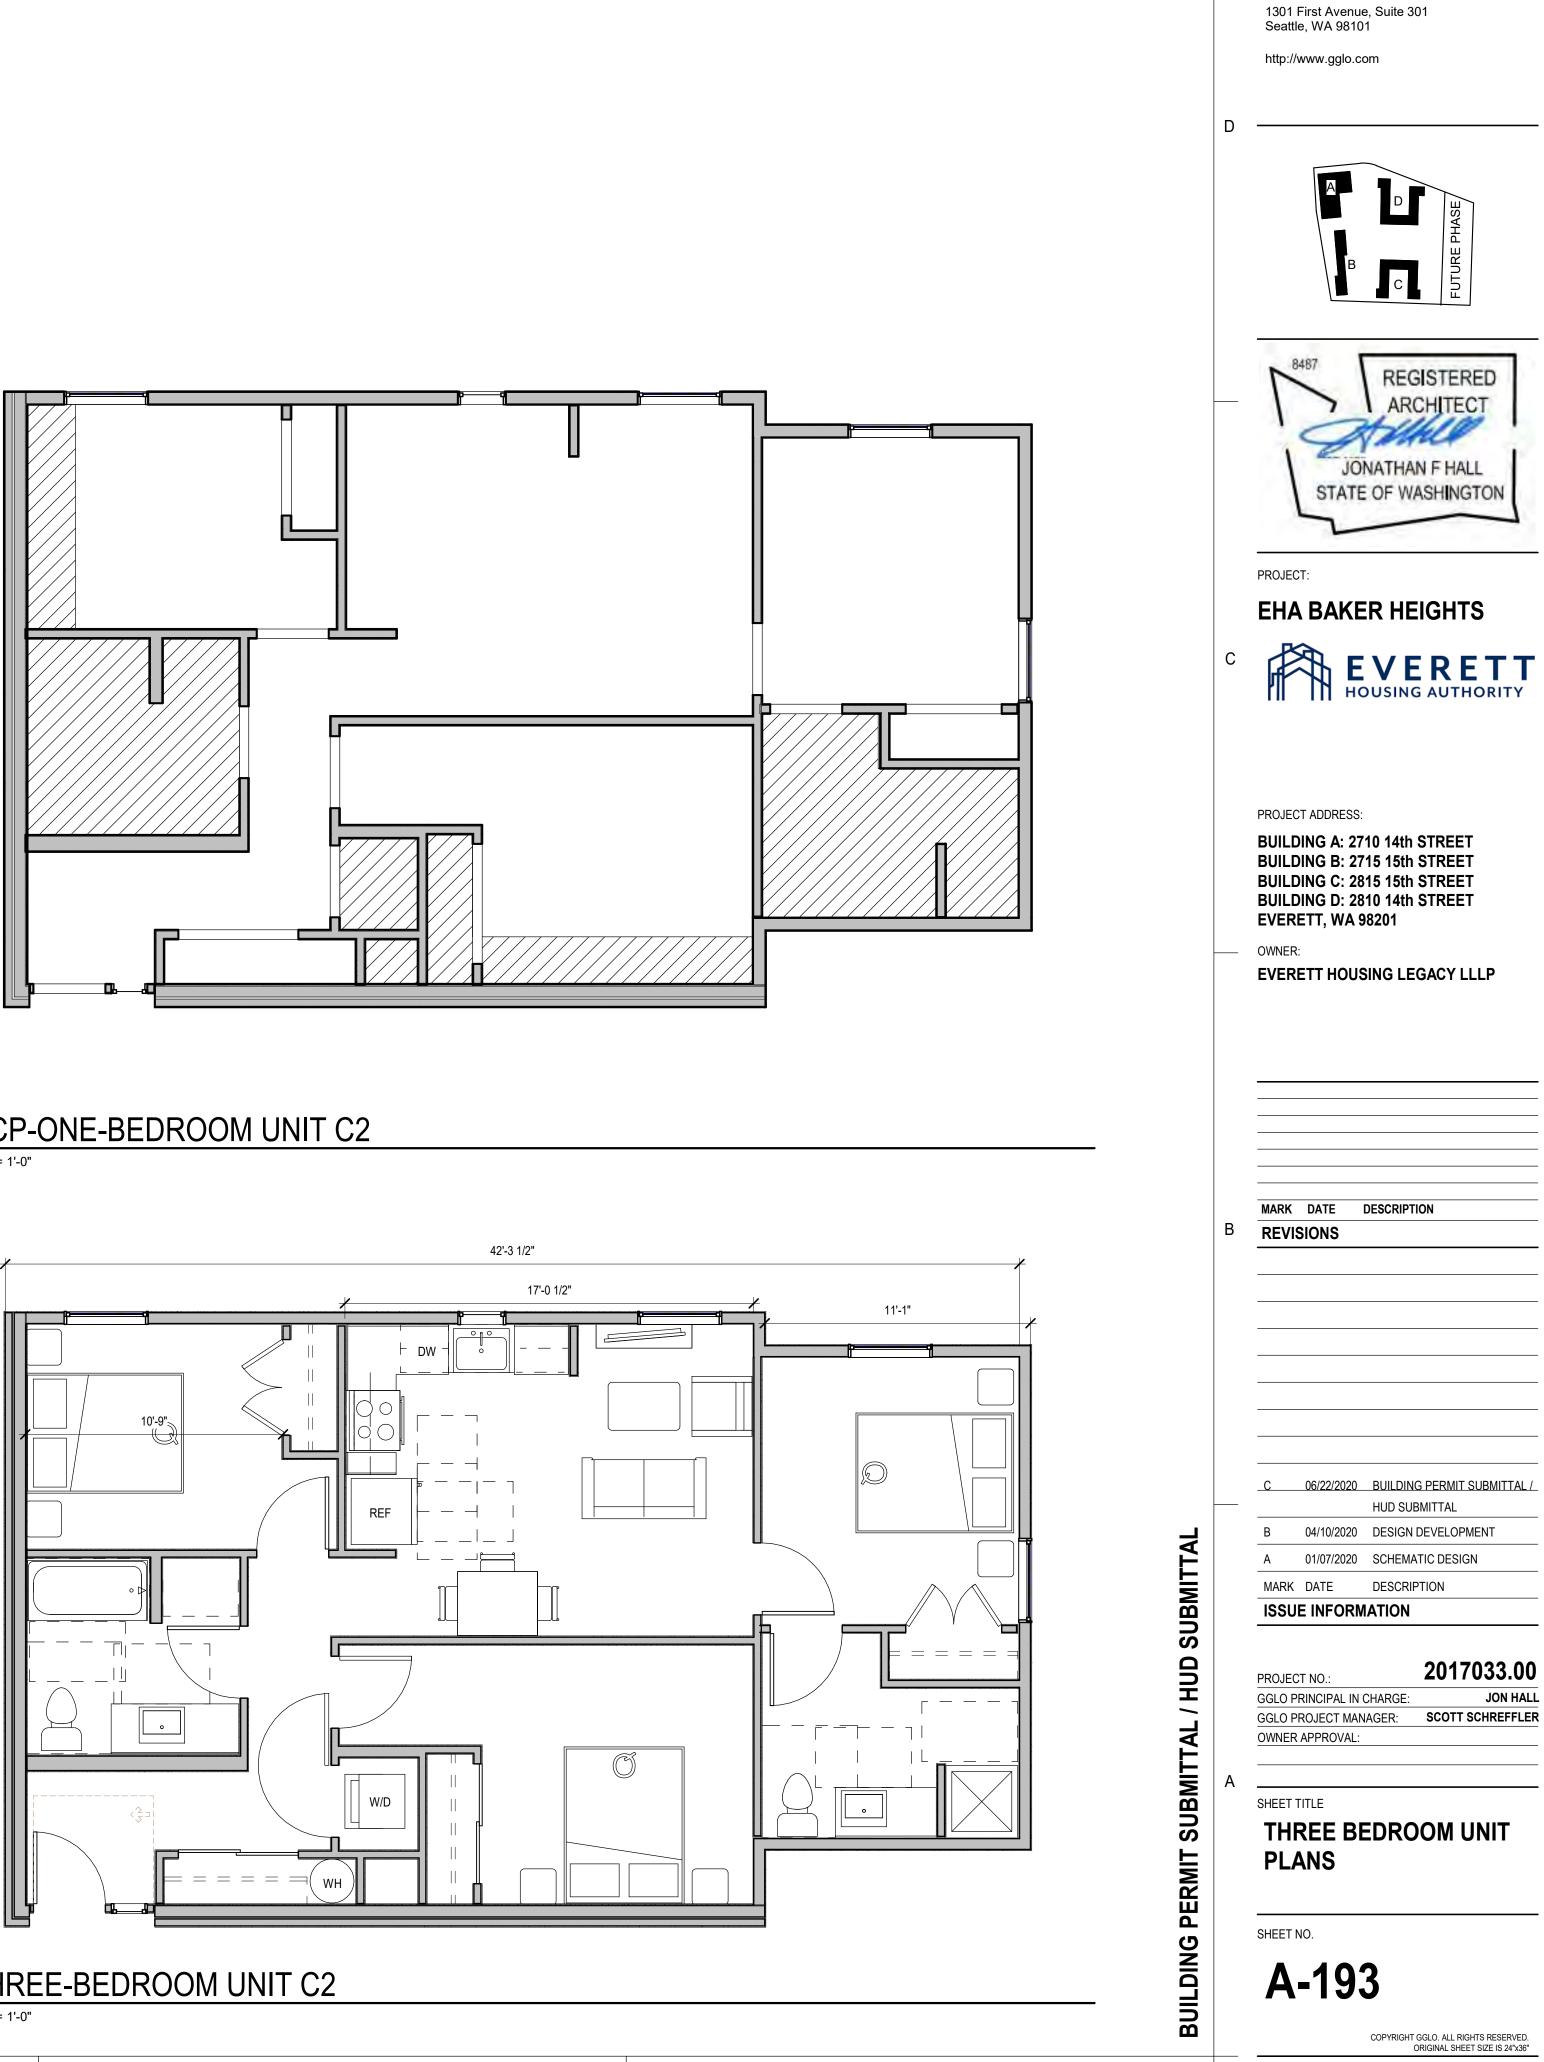

(A4)



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GENERAL INTERIOR ELEVATION NOTES

- SEE A-500 & A-501 FOR ADDITIONAL ACCESSIBLE INFORMATION REQUIREMENTS. 1.
- INSTALL 2x6 BLOCKING FOR GRAB BARS IN ALL BATHROOMS ON WALLS SURROUNDING WATER 2. CLOSET, BATHTUB & SHOWER. SEE SHEET A-500 FOR BLOCKING LENGTH & LOCATIONS. INSTALL GRAB BARS ONLY IN TYPE A UNITS.
- 3. SEE ARCHITECTURAL FLOOR PLANS FOR BATHROOM ACCESSORIES QUANTITY & LOCATIONS. INSTALL TOWEL BAR @ 48" AFF U.N.O. INSTALL TOILET PAPER HOLDER @ 20" AFF.
- 4. SEE ARCHITECTURAL FLOOR PLANS FOR SOFFIT LOCATIONS.



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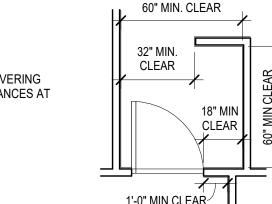
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	A D B C L D
	REGISTERED ARCHITECT
	PROJECT:
	EVERETT HOUSING AUTHORITY
	PROJECT ADDRESS: BUILDING A: 2710 14th STREET BUILDING B: 2715 15th STREET BUILDING C: 2815 15th STREET BUILDING D: 2810 14th STREET EVERETT, WA 98201 OWNER: EVERETT HOUSING LEGACY LLLP
	MARK DATE DESCRIPTION REVISIONS
	REVISIONS
	REVISIONS

BUILDING PERMIT SUBMITTAL / HUD SUBMITTAL


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SHEET NO.

A-194



BASEBOARD.

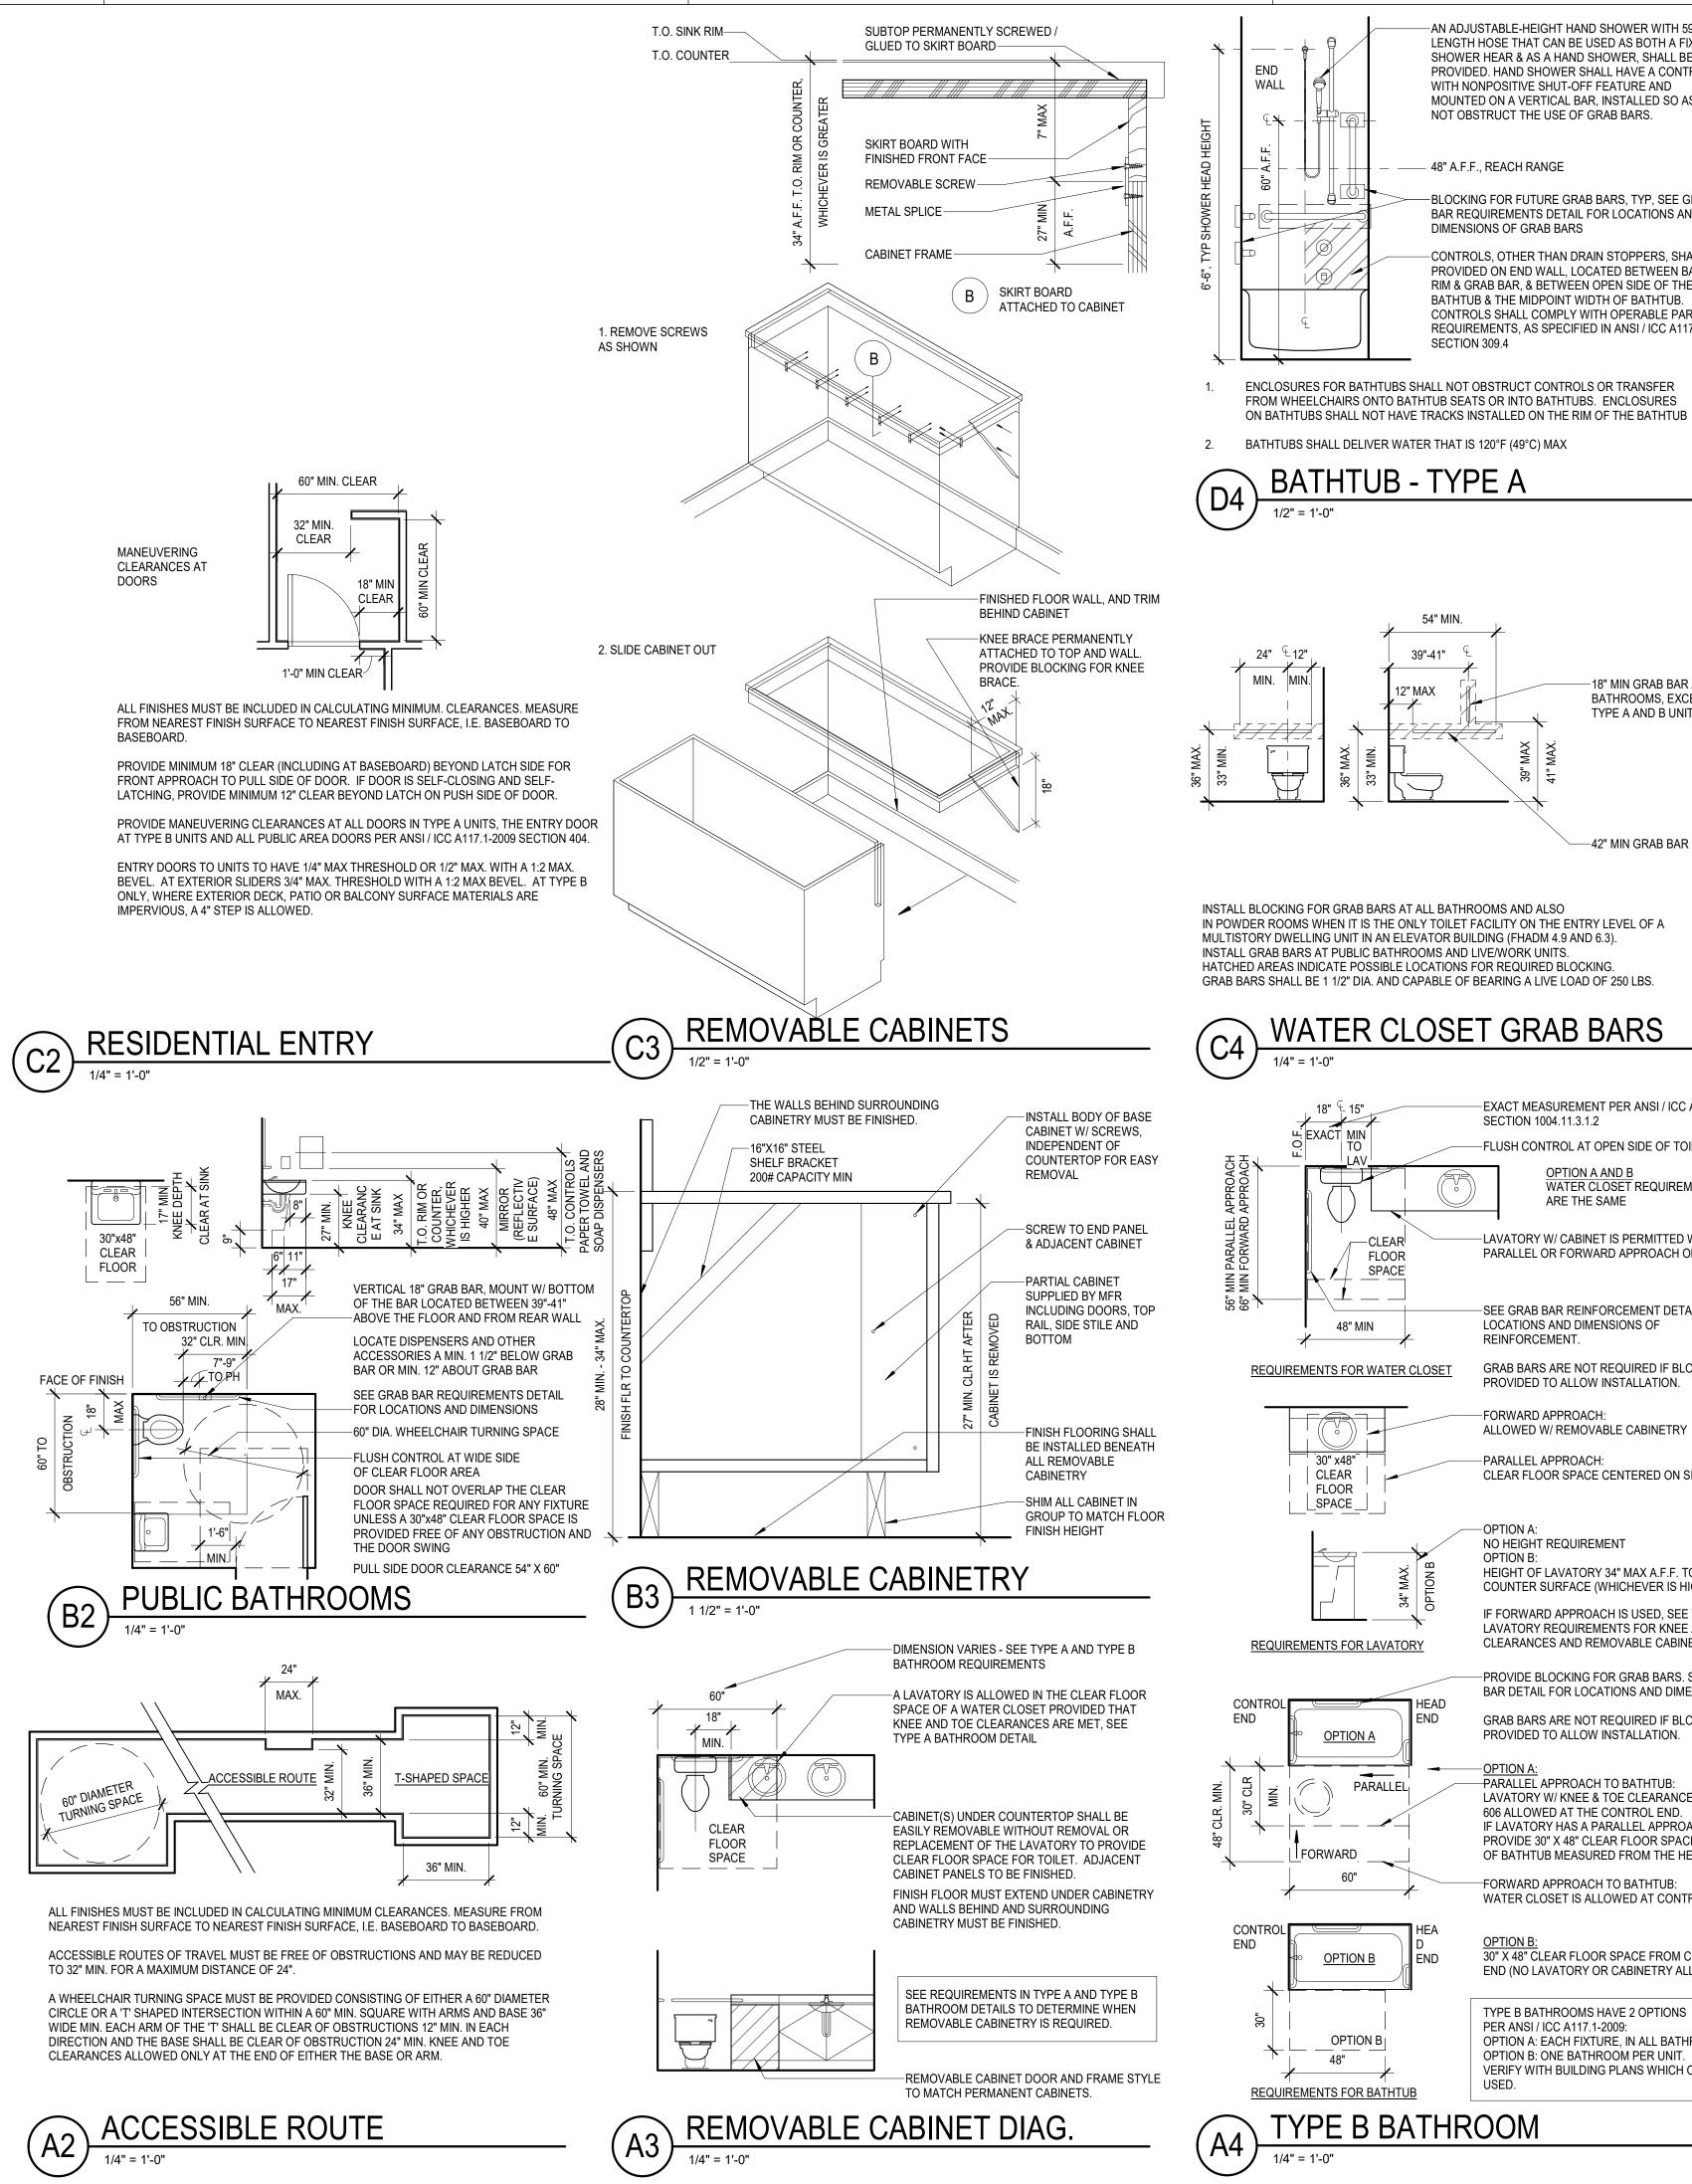

END (NO LAVATORY OR CABINETRY ALLOWED) TYPE B BATHROOMS HAVE 2 OPTIONS PER ANSI / ICC A117.1-2009: OPTION A: EACH FIXTURE, IN ALL BATHROOMS OPTION B: ONE BATHROOM PER UNIT. VERIFY WITH BUILDING PLANS WHICH OPTION IS USED. YPE B BATHROOM

FORWARD APPROACH: ALLOWED W/ REMOVABLE CABINETRY

PARALLEL APPROACH:

NO HEIGHT REQUIREMENT

-OPTION A

OPTION B:

CLEAR FLOOR SPACE CENTERED ON SINK

HEIGHT OF LAVATORY 34" MAX A.F.F. TO RIM OR

COUNTER SURFACE (WHICHEVER IS HIGHER)

IF FORWARD APPROACH IS USED, SEE TYPE A

LAVATORY REQUIREMENTS FOR KNEE AND TOE

BAR DETAIL FOR LOCATIONS AND DIMENSIONS.

GRAB BARS ARE NOT REQUIRED IF BLOCKING IS

PROVIDED TO ALLOW INSTALLATION.

PARALLEL APPROACH TO BATHTUB

606 ALLOWED AT THE CONTROL END.

FORWARD APPROACH TO BATHTUB:

IF LAVATORY HAS A PARALLEL APPROACH,

OF BATHTUB MEASURED FROM THE HEAD END.

WATER CLOSET IS ALLOWED AT CONTROL END,

30" X 48" CLEAR FLOOR SPACE FROM CONTROL

CLEARANCES AND REMOVABLE CABINETRY

GRAB BARS ARE NOT REQUIRED IF BLOCKING IS PROVIDED TO ALLOW INSTALLATION.

SEE GRAB BAR REINFORCEMENT DETAIL FOR LOCATIONS AND DIMENSIONS OF REINFORCEMENT.

LAVATORY W/ CABINET IS PERMITTED WITH PARALLEL OR FORWARD APPROACH ONLY.

OPTION A AND B WATER CLOSET REQUIREMENTS ARE THE SAME

-FLUSH CONTROL AT OPEN SIDE OF TOILET

EXACT MEASUREMENT PER ANSI / ICC A117.1-2009 SECTION 1004.11.3.1.2


INSTALL GRAB BARS AT PUBLIC BATHROOMS AND LIVE/WORK UNITS. HATCHED AREAS INDICATE POSSIBLE LOCATIONS FOR REQUIRED BLOCKING GRAB BARS SHALL BE 1 1/2" DIA. AND CAPABLE OF BEARING A LIVE LOAD OF 250 LBS.

-42" MIN GRAB BAR

18" MIN GRAB BAR AT ALL BATHROOMS, EXCEPT IN TYPE A AND B UNITS

48" A.F.F., REACH RANGE BLOCKING FOR FUTURE GRAB BARS, TYP, SEE GRAB BAR REQUIREMENTS DETAIL FOR LOCATIONS AND DIMENSIONS OF GRAB BARS CONTROLS. OTHER THAN DRAIN STOPPERS, SHALL BE PROVIDED ON END WALL, LOCATED BETWEEN BATHTUB RIM & GRAB BAR, & BETWEEN OPEN SIDE OF THE BATHTUB & THE MIDPOINT WIDTH OF BATHTUB. CONTROLS SHALL COMPLY WITH OPERABLE PARTS REQUIREMENTS, AS SPECIFIED IN ANSI / ICC A117.1-2009 SECTION 309.4 ENCLOSURES FOR BATHTUBS SHALL NOT OBSTRUCT CONTROLS OR TRANSFER

AN ADJUSTABLE-HEIGHT HAND SHOWER WITH 59" MIN LENGTH HOSE THAT CAN BE USED AS BOTH A FIXED SHOWER HEAR & AS A HAND SHOWER, SHALL BE PROVIDED. HAND SHOWER SHALL HAVE A CONTROL WITH NONPOSITIVE SHUT-OFF FEATURE AND MOUNTED ON A VERTICAL BAR, INSTALLED SO AS TO NOT OBSTRUCT THE USE OF GRAB BARS.

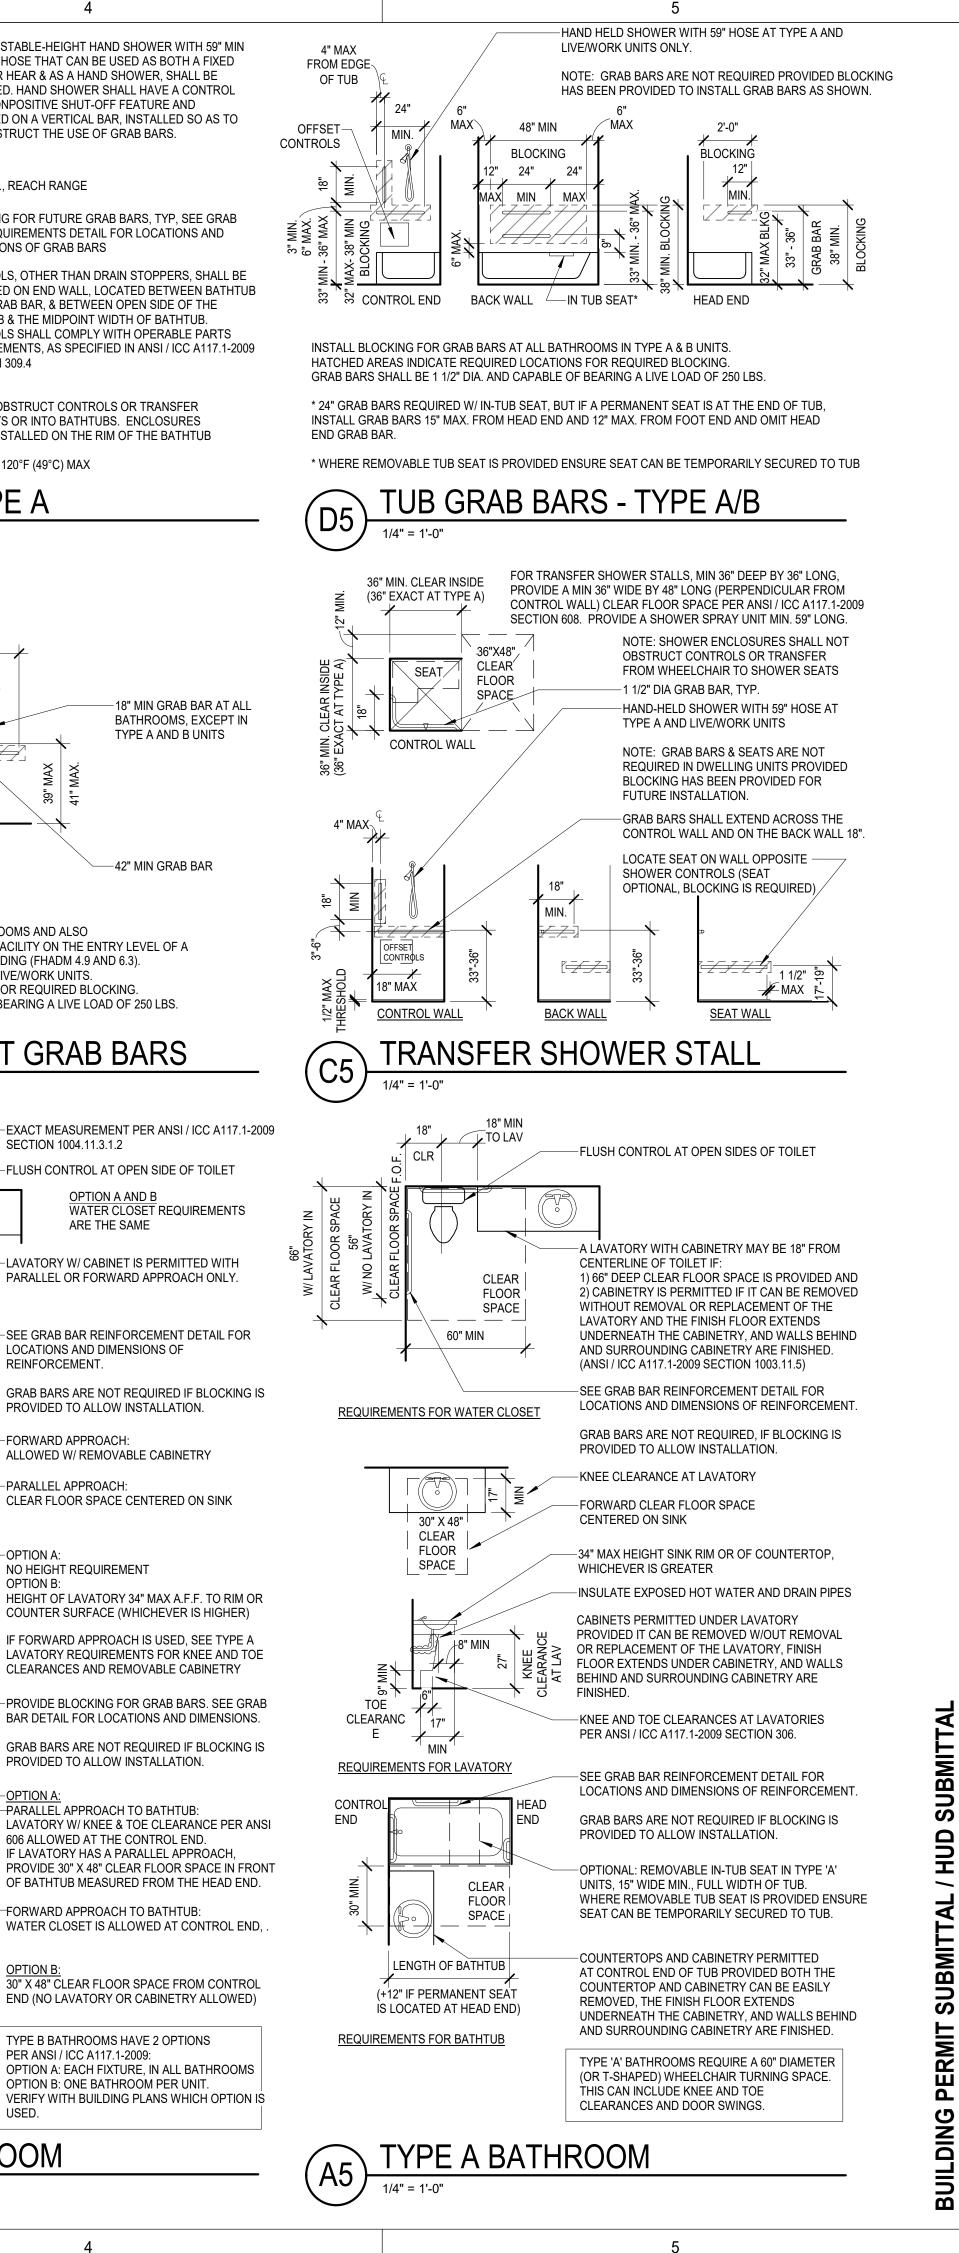

GGLO 1301 First Avenue, Suite 301 Seattle, WA 98101 http://www.gglo.com 8487 REGISTERED ARCHITEC JONATHAN F HALL STATE OF WASHINGTON PROJECT: **EHA BAKER HEIGHTS** HOUSING AUTHORIT PROJECT ADDRESS: BUILDING A: 2710 14th STREET BUILDING B: 2715 15th STREET BUILDING C: 2815 15th STREET BUILDING D: 2810 14th STREET **EVERETT, WA 98201** OWNER: EVERETT HOUSING LEGACY LLLP 2916 SOUTH MCCLELLAN STREET SEATTLE, WA 98144 MARK DATE DESCRIPTION REVISIONS 06/22/2020 BUILDING PERMIT SUBMITTAL / HUD SUBMITTAL 04/10/2020 DESIGN DEVELOPMENT 01/07/2020 SCHEMATIC DESIGN MARK DATE DESCRIPTION **ISSUE INFORMATION** 2017033.00 PROJECT NO .: GGLO PRINCIPAL IN CHARGE JON HALL SCOTT SCHREFFLER GGLO PROJECT MANAGER: OWNER APPROVAL SHEET TITLE **ACCESSIBILITY DETAILS**

SHEET NO.

UBM

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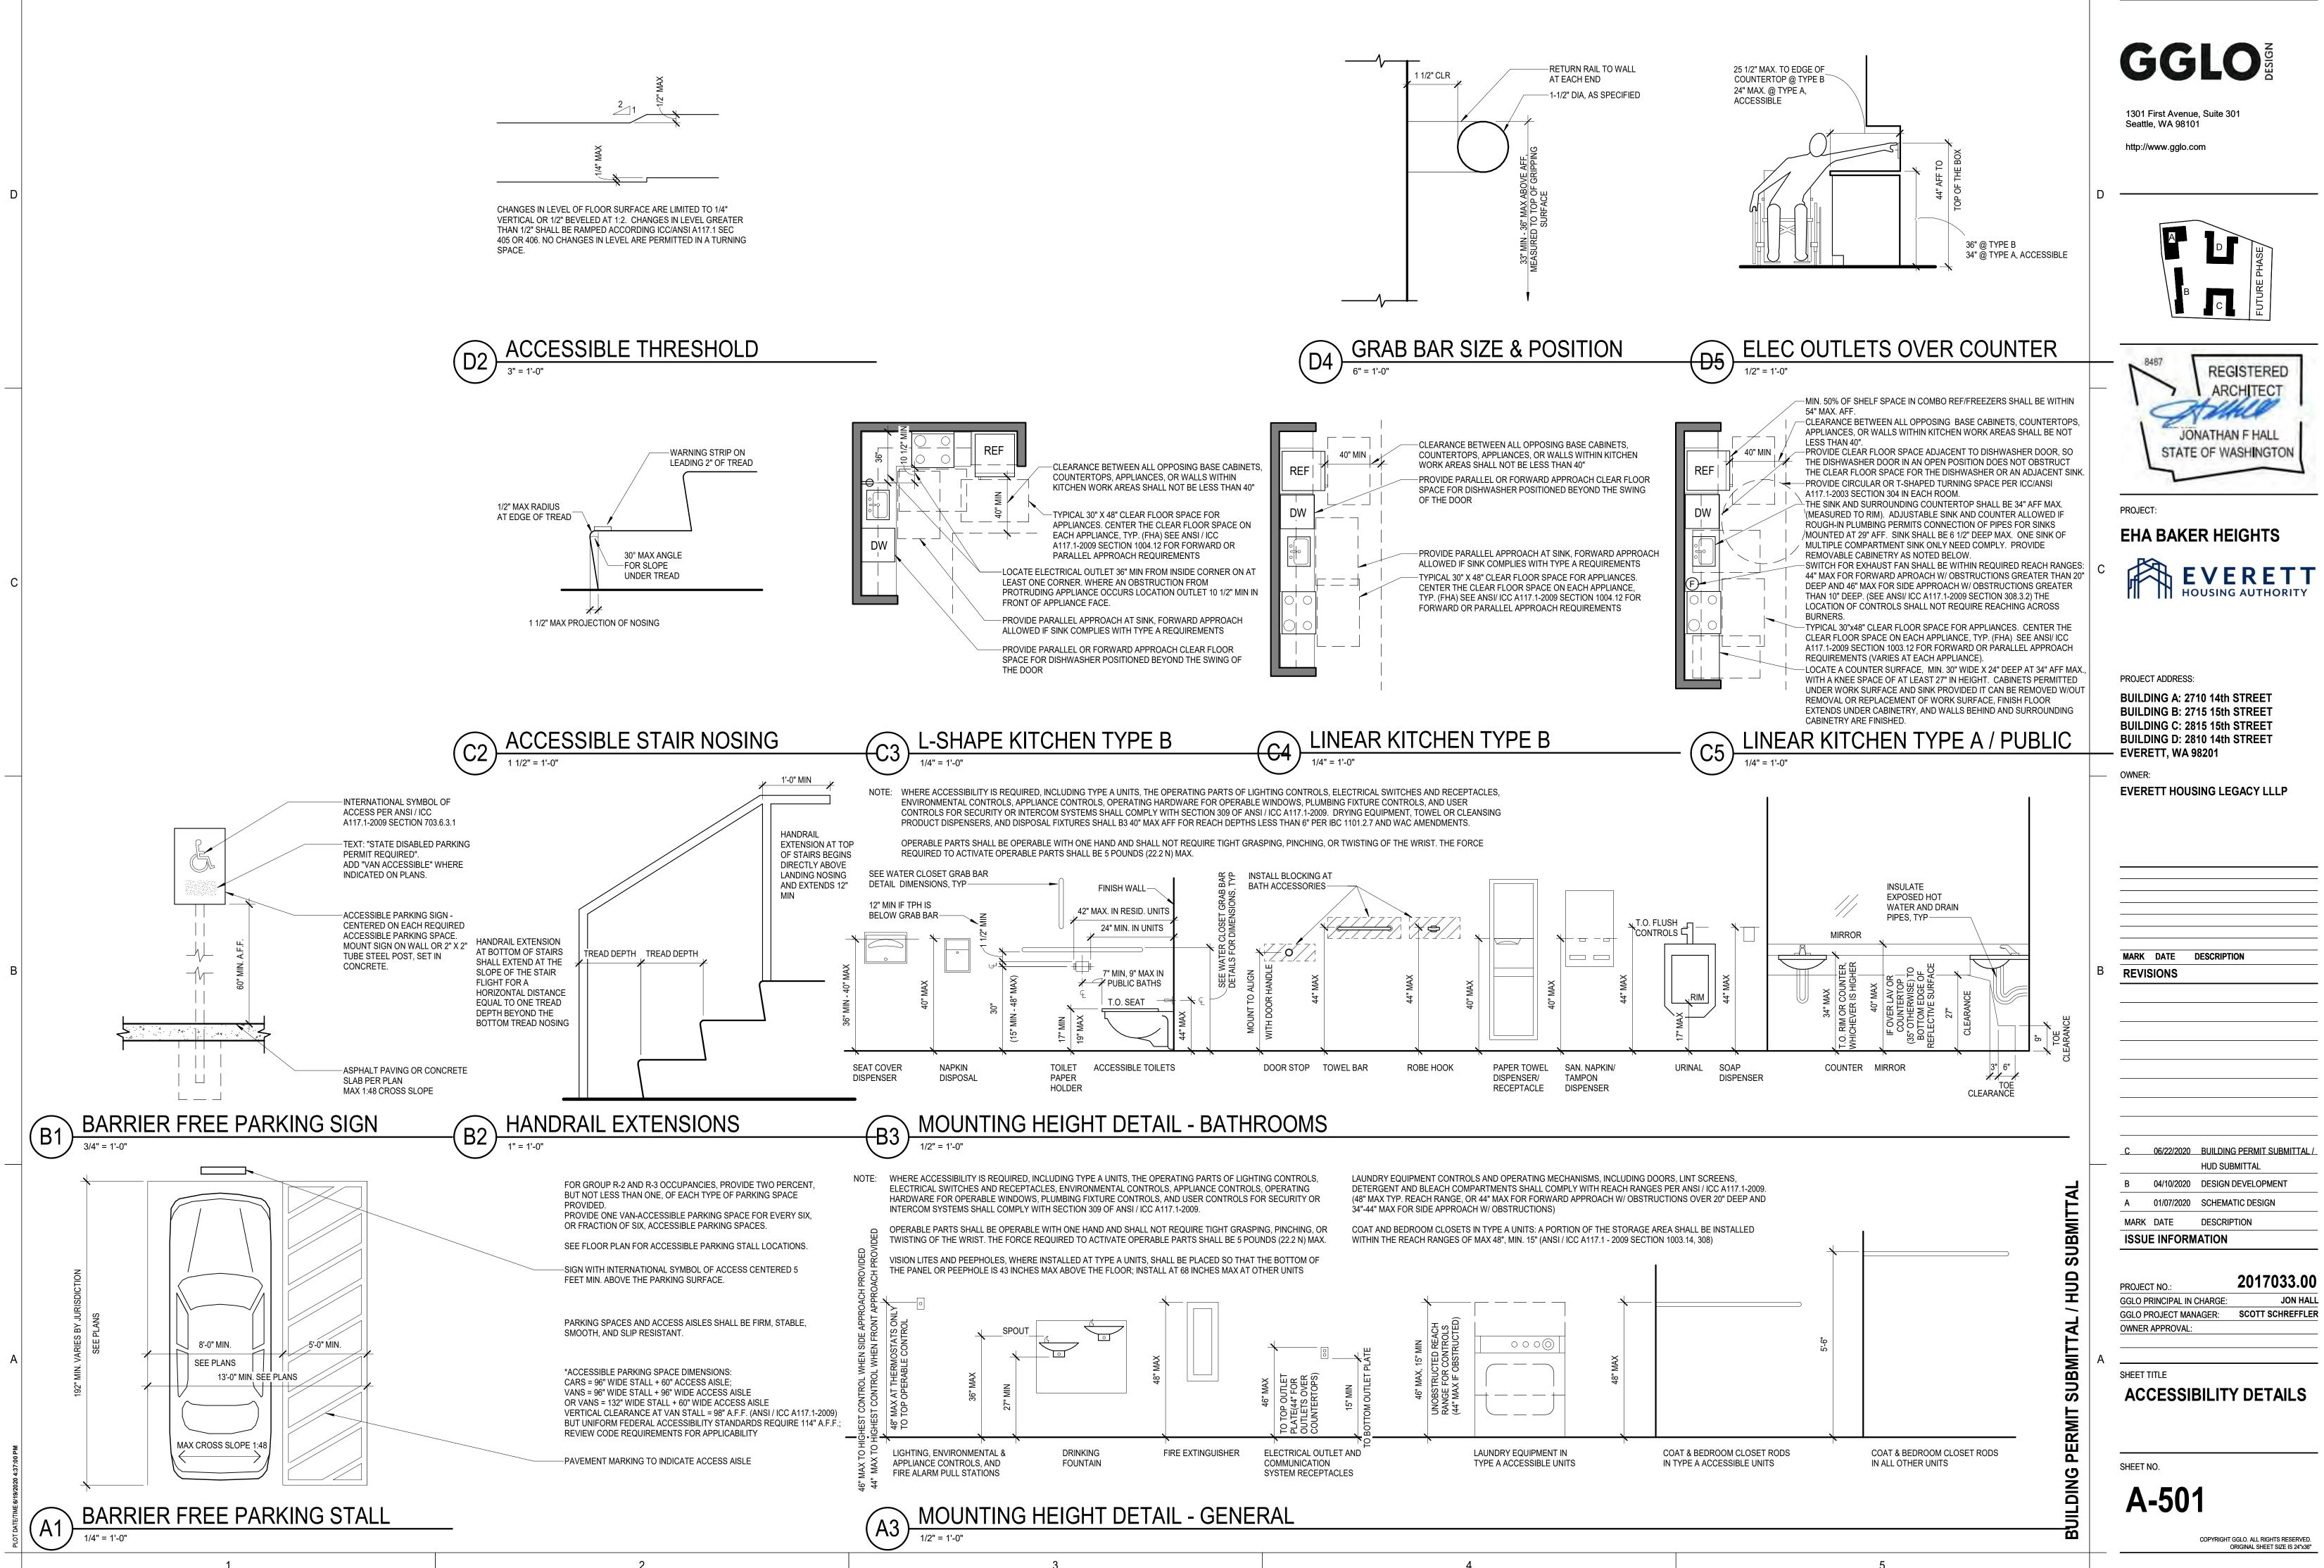
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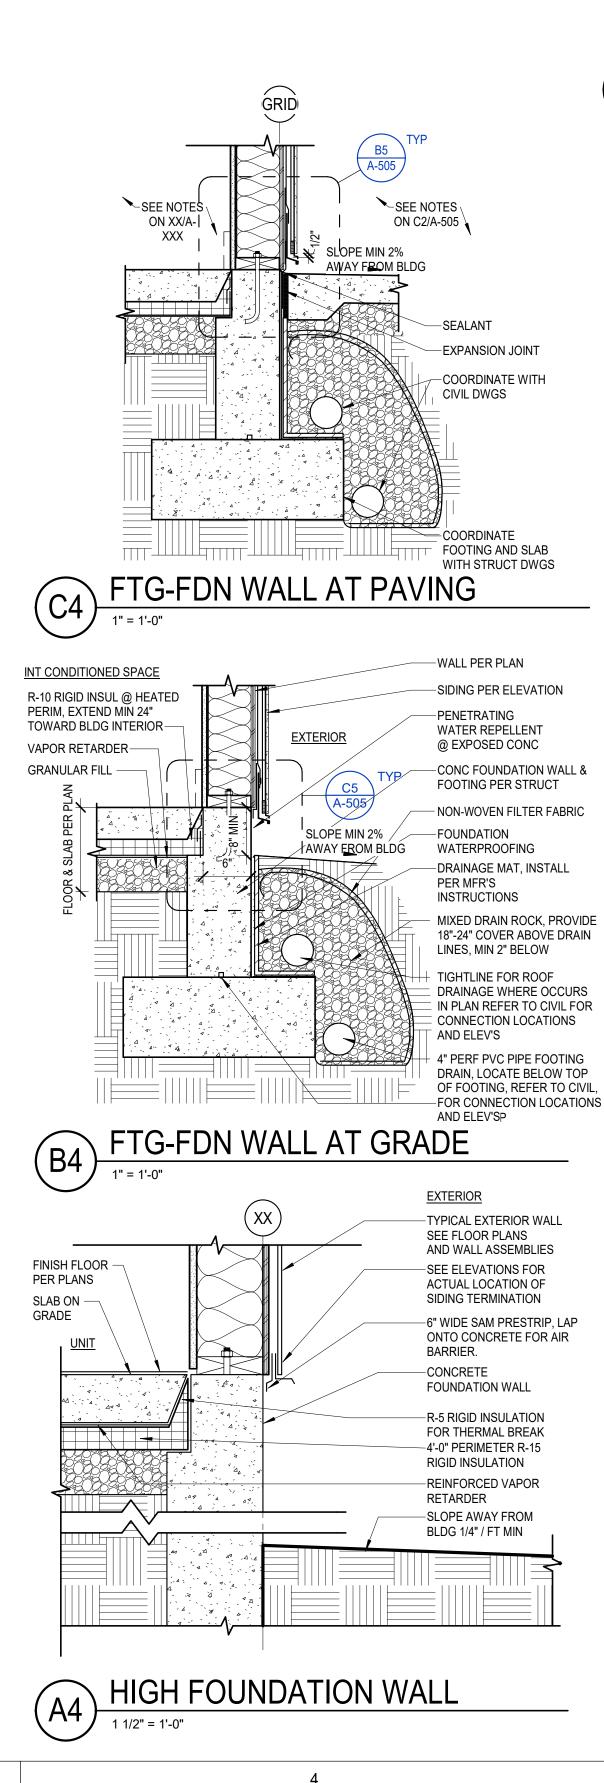
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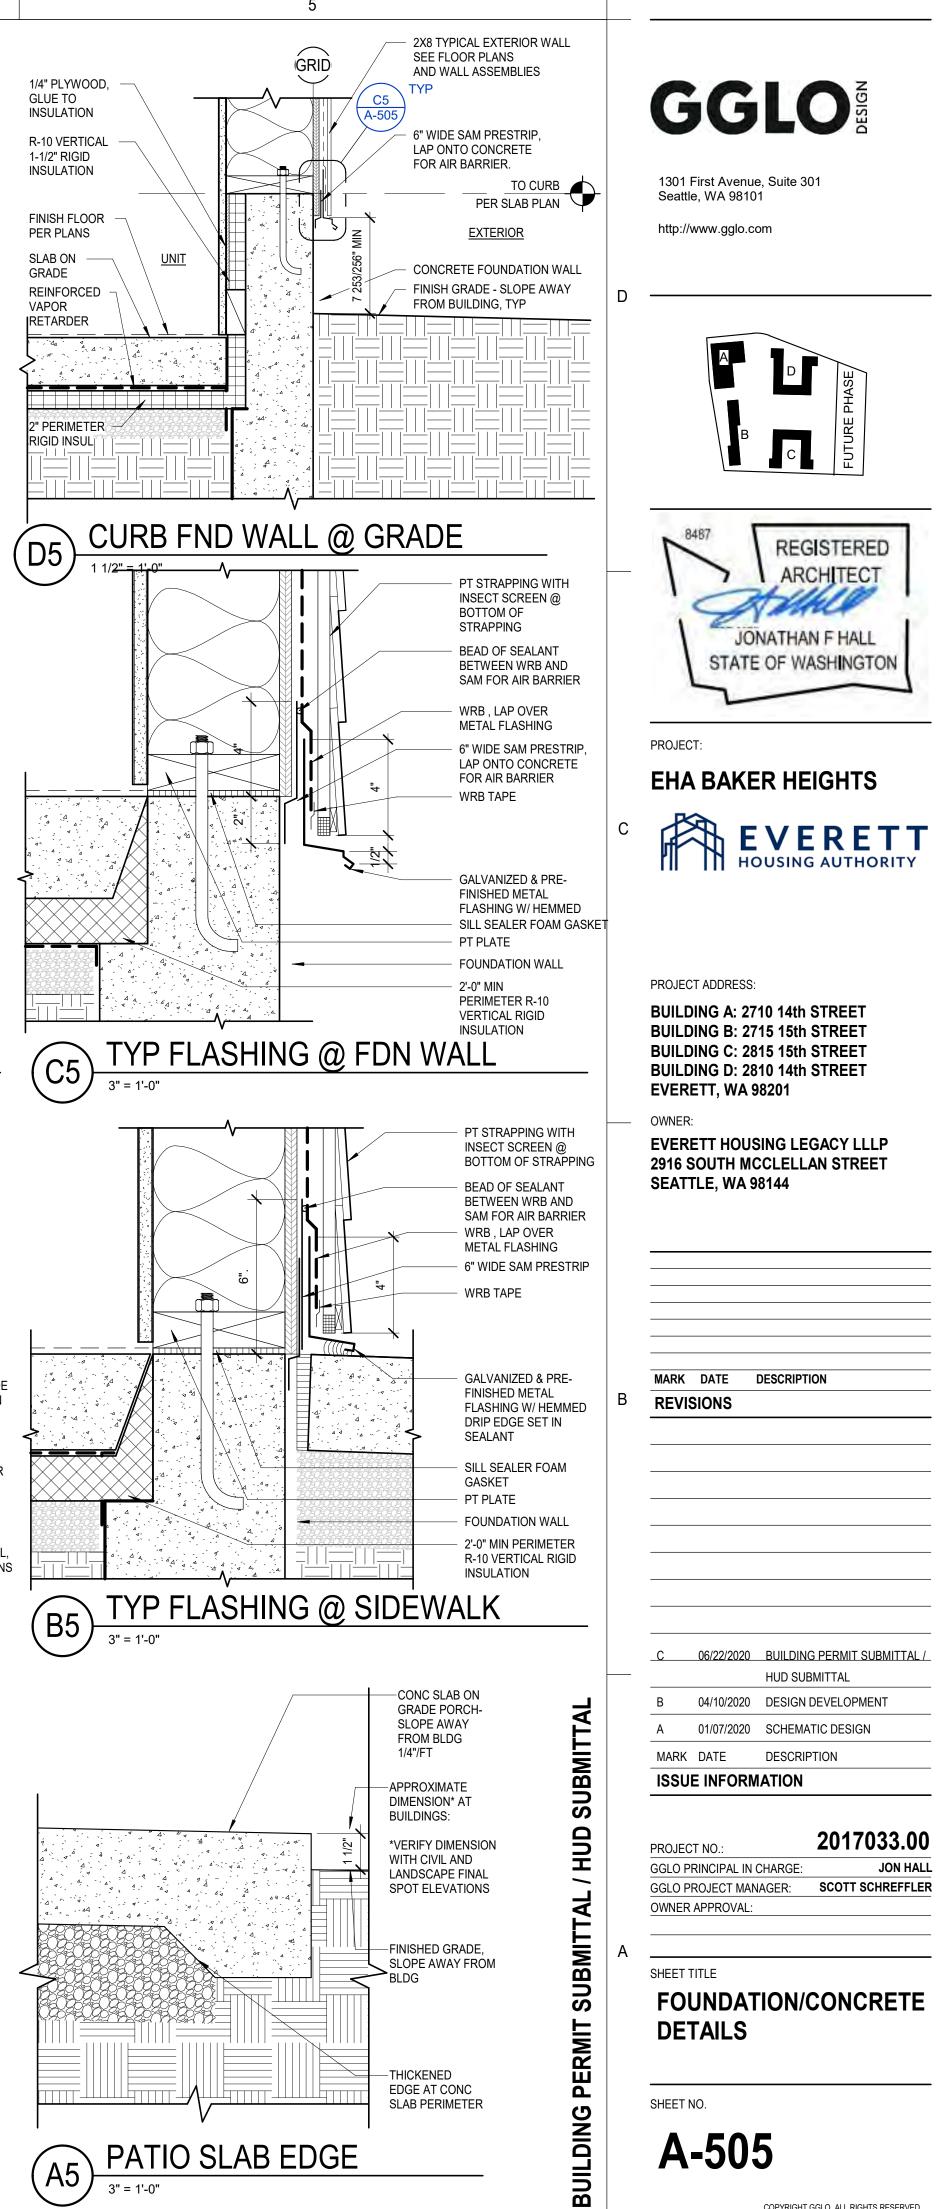
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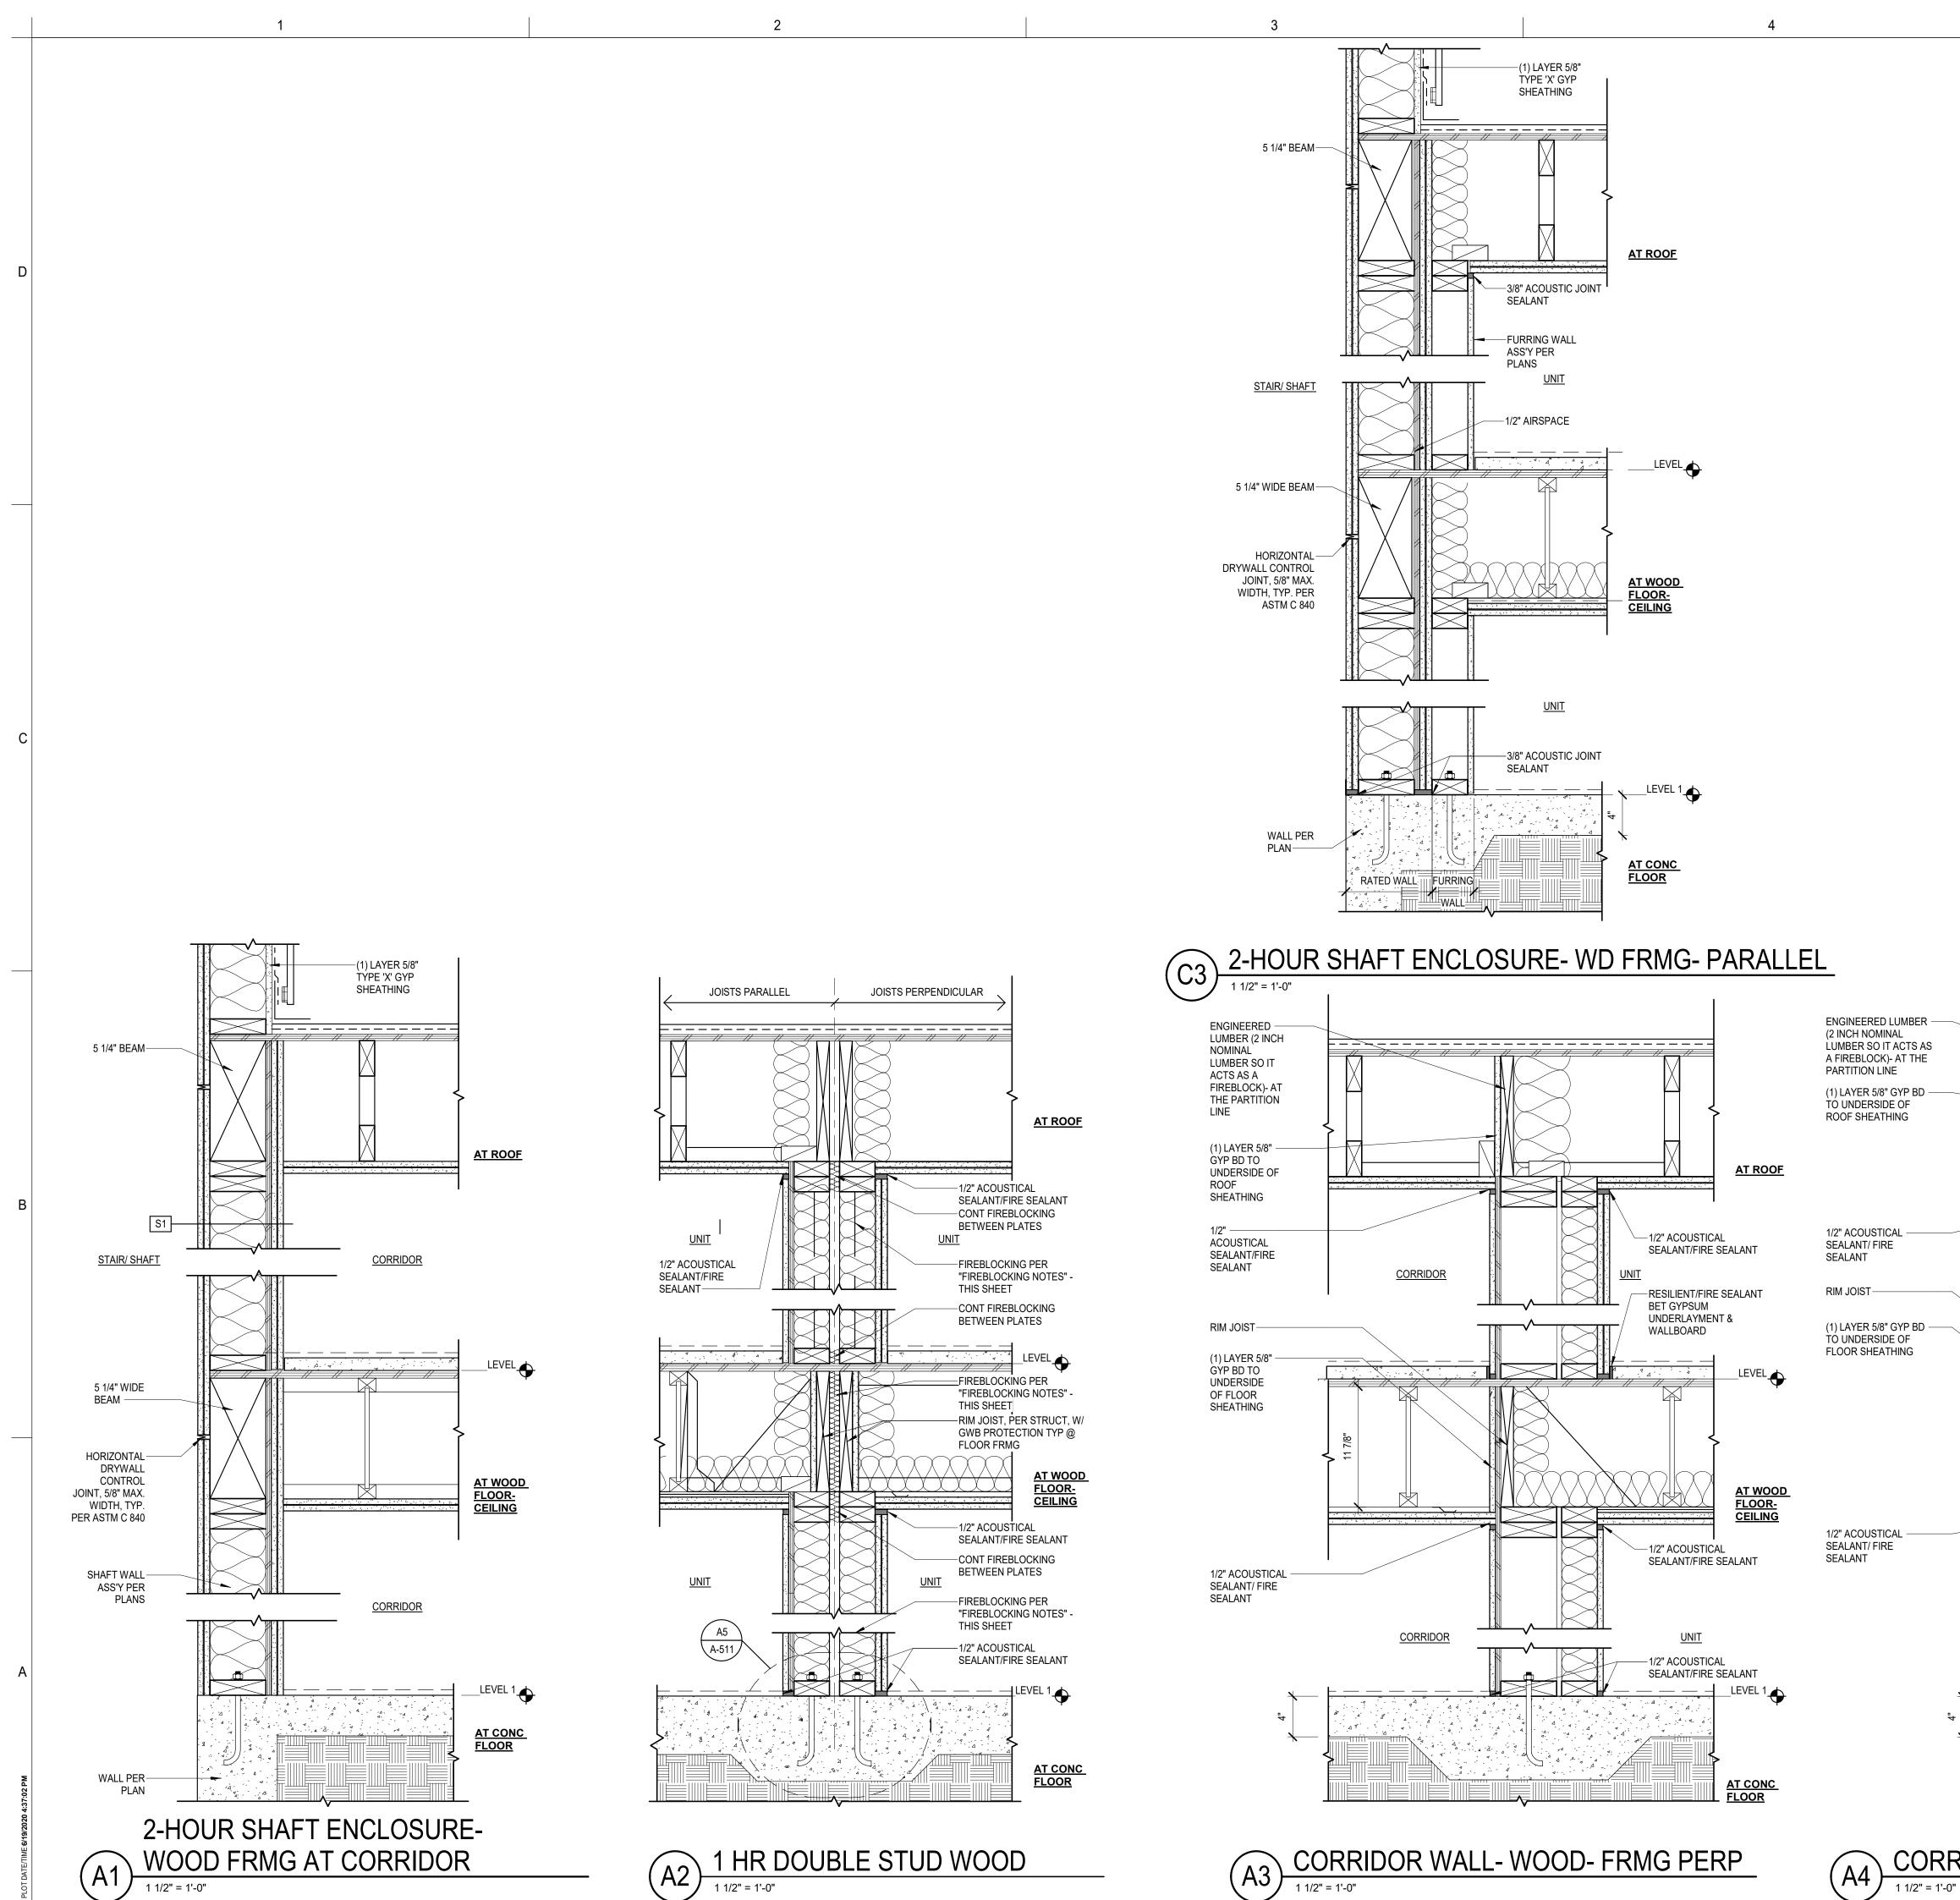
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FIREBLOCKING IS REQUIRED (IBC 718.2.2):

N CONCEALED SPACES OF STUD WALLS AND PARTITIONS, INCLUDING FURRED SPACES, AND PARALLEL ROWS OF STUDS, OR STAGGERED STUDS AS FOLLOWS: 1. VERTICALLY AT THE CEILING & FLOOR LEVELS

2. HORIZONTALLY AT INTERVALS NOT EXCEEDING 10 FEET.

BATTS OR BLANKETS OF MINERAL WOOL OR MINERAL FIBER (IBC 718.2.1.1) BATTS OR BLANKETS OF MINERAL WOOL OR MINERAL FIBER OR ANOTHER APPROVED NON-RIGID MATERIALS SHALL BE PERMITTED FOR COMPLIANCE WITHT THE 10-FOOR HORIZ FIREBLOCKING IN WALLS CONSTRUCTED USING PARALLEL ROWS OF STUDS OR STAGGERED STUDS.

DRAFTSTOPPING NOTES:

DRAFTSTOPPING IN GROUP R-2 (IBC 718.2.2): DRAFTSTOPPING SHALL BE PROVIDED IN FLOOR/CEILING SPACES IN GROUP R-2 BUILDINGS WITH 3 OR MORE DWELLING UNITS. DRAFTSTOPPING SHALL BE LOCATED ABOVE AND IN LINE WITH THE DWELLING UNIT AND SLEEPING UNIT SEPARATIONS.

EXCEPTIO

1. DRAFTSTOPPING IS NOT REQUIRED IN BUILDINGS EQUIPPED THROUGHOUT WITH AN AUTOMATIC SPRINKLER SYSTEM IN ACCORDANCE WITH SECION 903.3.1.1

GYPSUM CONSTRUCTION NOTES (GYPSUM CONSTRUCTION TO BE PER IBC 2508.) A. GYPSUM WALLBOARD SHALL NOT BE USED IN ANY EXTERIOR SURFACE WHERE SUCH GYPSUM CONSTRUCTION WILL BE EXPOSED DIRECTLY TO WEATHER. GYPSUM WALLBOARD SHALL NOT BE USED WHERE THERE WILL BE DIRECT EXPOSURE TO WATER OR CONTINUOUS HIGH HUMIDITY CONDITIONS. GYPSUM SHEATHING SHALL BE INSTALLED ON EXTERIOR SURFACES IN

ACCORDANCE WITH ASTM C 1280. B. GYPSUM WALLBOARD OR GYPSUM PLASTER SHALL NOT BE INSTALLED UNTIL WEATHER

PROTECTION FOR THE INSTALLATION IS PROVIDED. C. FASTENERS AT THE TOP AND BOTTOM PLATES OF VERTICAL ASSEMBLIES, OR THE EDGES AND ENDS OF HORIZONTAL ASSEMBLIES PERPENDICULAR TO SUPPORTS, AND AT THE WALL LINE ARE PERMITTED TO BE OMITTED EXCEPT ON SHEAR RESISTING ELEMENTS OR FIRE-RESISTANCE-


RATED ASSEMBLIES. D. GYPSUM BOARD FIRE-RESISTANCE-RATED ASSEMBLIES SHALL HAVE JOINTS AND FASTENERS TREATED.

EXCEPTION: 1. ON SINGLE LAYER SYSTEMS WHERE JOINTS OCCUR OVER WOOD FRAMING MEMBERS. 1. ON SINGLE LAYER SYSTEMS WHERE JOINTS OCCUR OVER WOOD FRAMING MEMBERS. 2. ON MULTILAYER SYSTEMS WHERE THE JOINTS OF ADJACENT LAYERS ARE OFFSET FROM ONE ANOTHER.



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PROJECT:

EHA BAKER HEIGHTS

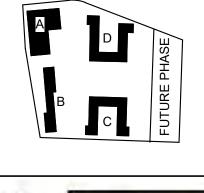


PROJECT ADDRESS:

BUILDING A: 2710 14th STREET BUILDING B: 2715 15th STREET BUILDING C: 2815 15th STREET BUILDING D: 2810 14th STREET **EVERETT, WA 98201**

OWNER:

EVERETT HOUSING LEGACY LLLP 2916 SOUTH MCCLELLAN STREET SEATTLE, WA 98144

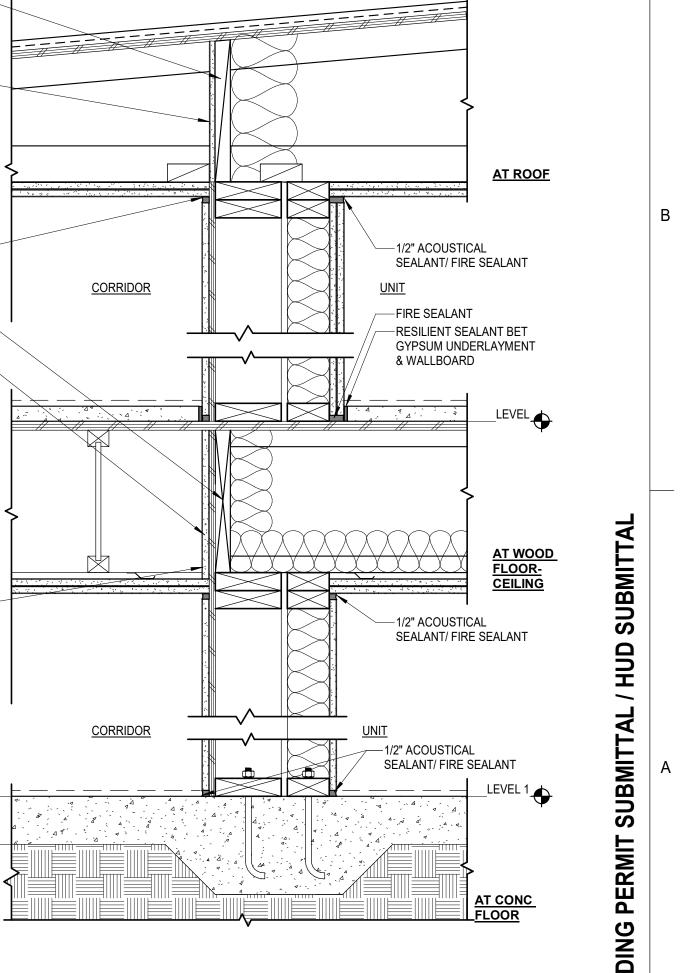

CORRIDOR WALL- WOOD- FRMG PARALLEL

Ω

MARK DATE DESCRIPTION REVISIONS 06/22/2020 BUILDING PERMIT SUBMITTAL HUD SUBMITTAL 04/10/2020 DESIGN DEVELOPMENT 01/07/2020 SCHEMATIC DESIGN Α MARK DATE DESCRIPTION **ISSUE INFORMATION** 2017033.00 PROJECT NO .: GGLO PRINCIPAL IN CHARGE: JON HALI SCOTT SCHREFFLER GGLO PROJECT MANAGER: OWNER APPROVAL SHEET TITLE **INTERIOR WALL -**

DETAILS & WALL - ROOF DETAILS

SHEET NO.

A-510

DRAFTSTOPPING NOTES:

DRAFTSTOPPING IN GROUP R-2 (IBC 718.2.2): DRAFTSTOPPING SHALL BE PROVIDED IN FLOOR/CEILING SPACES IN GROUP R-2 BUILDINGS WITH 3 OR MORE DWELLING UNITS. DRAFTSTOPPING SHALL BE LOCATED ABOVE AND IN LINE WITH THE DWELLING UNIT AND SLEEPING UNIT SEPARATIONS.

EXCEPTION: 1. DRAFTSTOPPING IS NOT REQUIRED IN BUILDINGS EQUIPPED THROUGHOUT WITH AN AUTOMATIC SPRINKLER SYSTEM IN ACCORDANCE WITH SECION 903.3.1.1 FIREBLOCKING NOTES:

FIREBLOCKING IS REQUIRED (IBC 718.2.2): IN CONCEALED SPACES OF STUD WALLS AND PARTITIONS, INCLUDING FURRED SPACES, AND PARALLEL ROWS OF STUDS, OR STAGGERED STUDS AS FOLLOWS: 1. VERTICALLY AT THE CEILING & FLOOR LEVELS


2. HORIZONTALLY AT INTERVALS NOT EXCEEDING 10 FEET.


BATTS OR BLANKETS OF MINERAL WOOL OR MINERAL FIBER (IBC 718.2.1.1) BATTS OR BLANKETS OF MINERAL WOOL OR MINERAL FIBER OR ANOTHER APPROVED NON-RIGID MATERIALS SHALL BE PERMITTED FOR COMPLIANCE WITHT THE 10-FOOR HORIZ FIREBLOCKING IN WALLS CONSTRUCTED USING PARALLEL ROWS OF STUDS OR STAGGERED STUDS.


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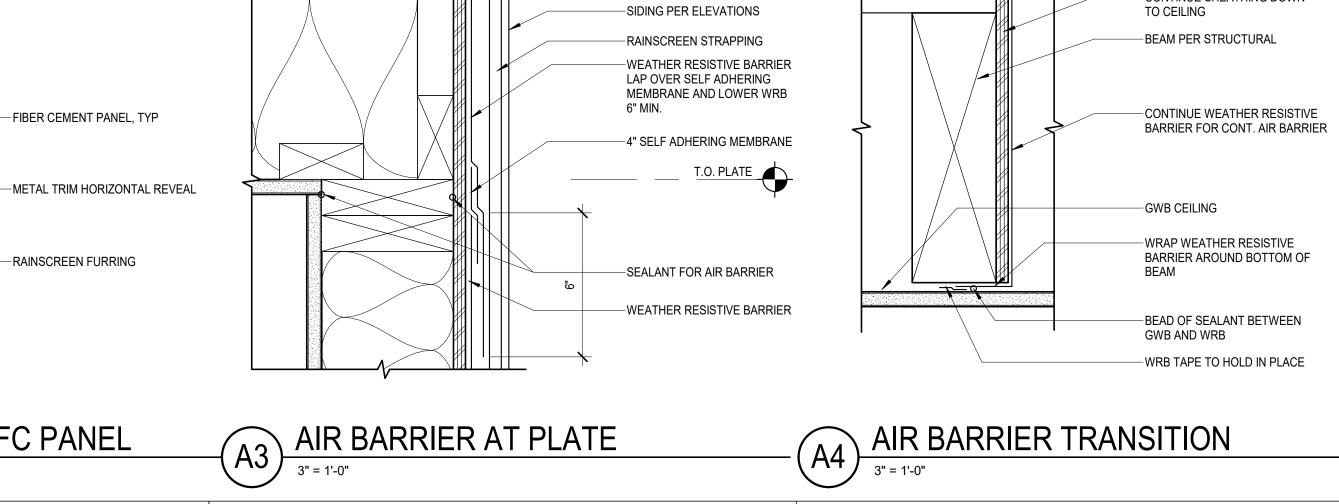
2. ON MULTILAYER SYSTEMS WHERE THE JOINTS OF ADJACENT LAYERS ARE OFFSET FROM ONE ANOTHER.





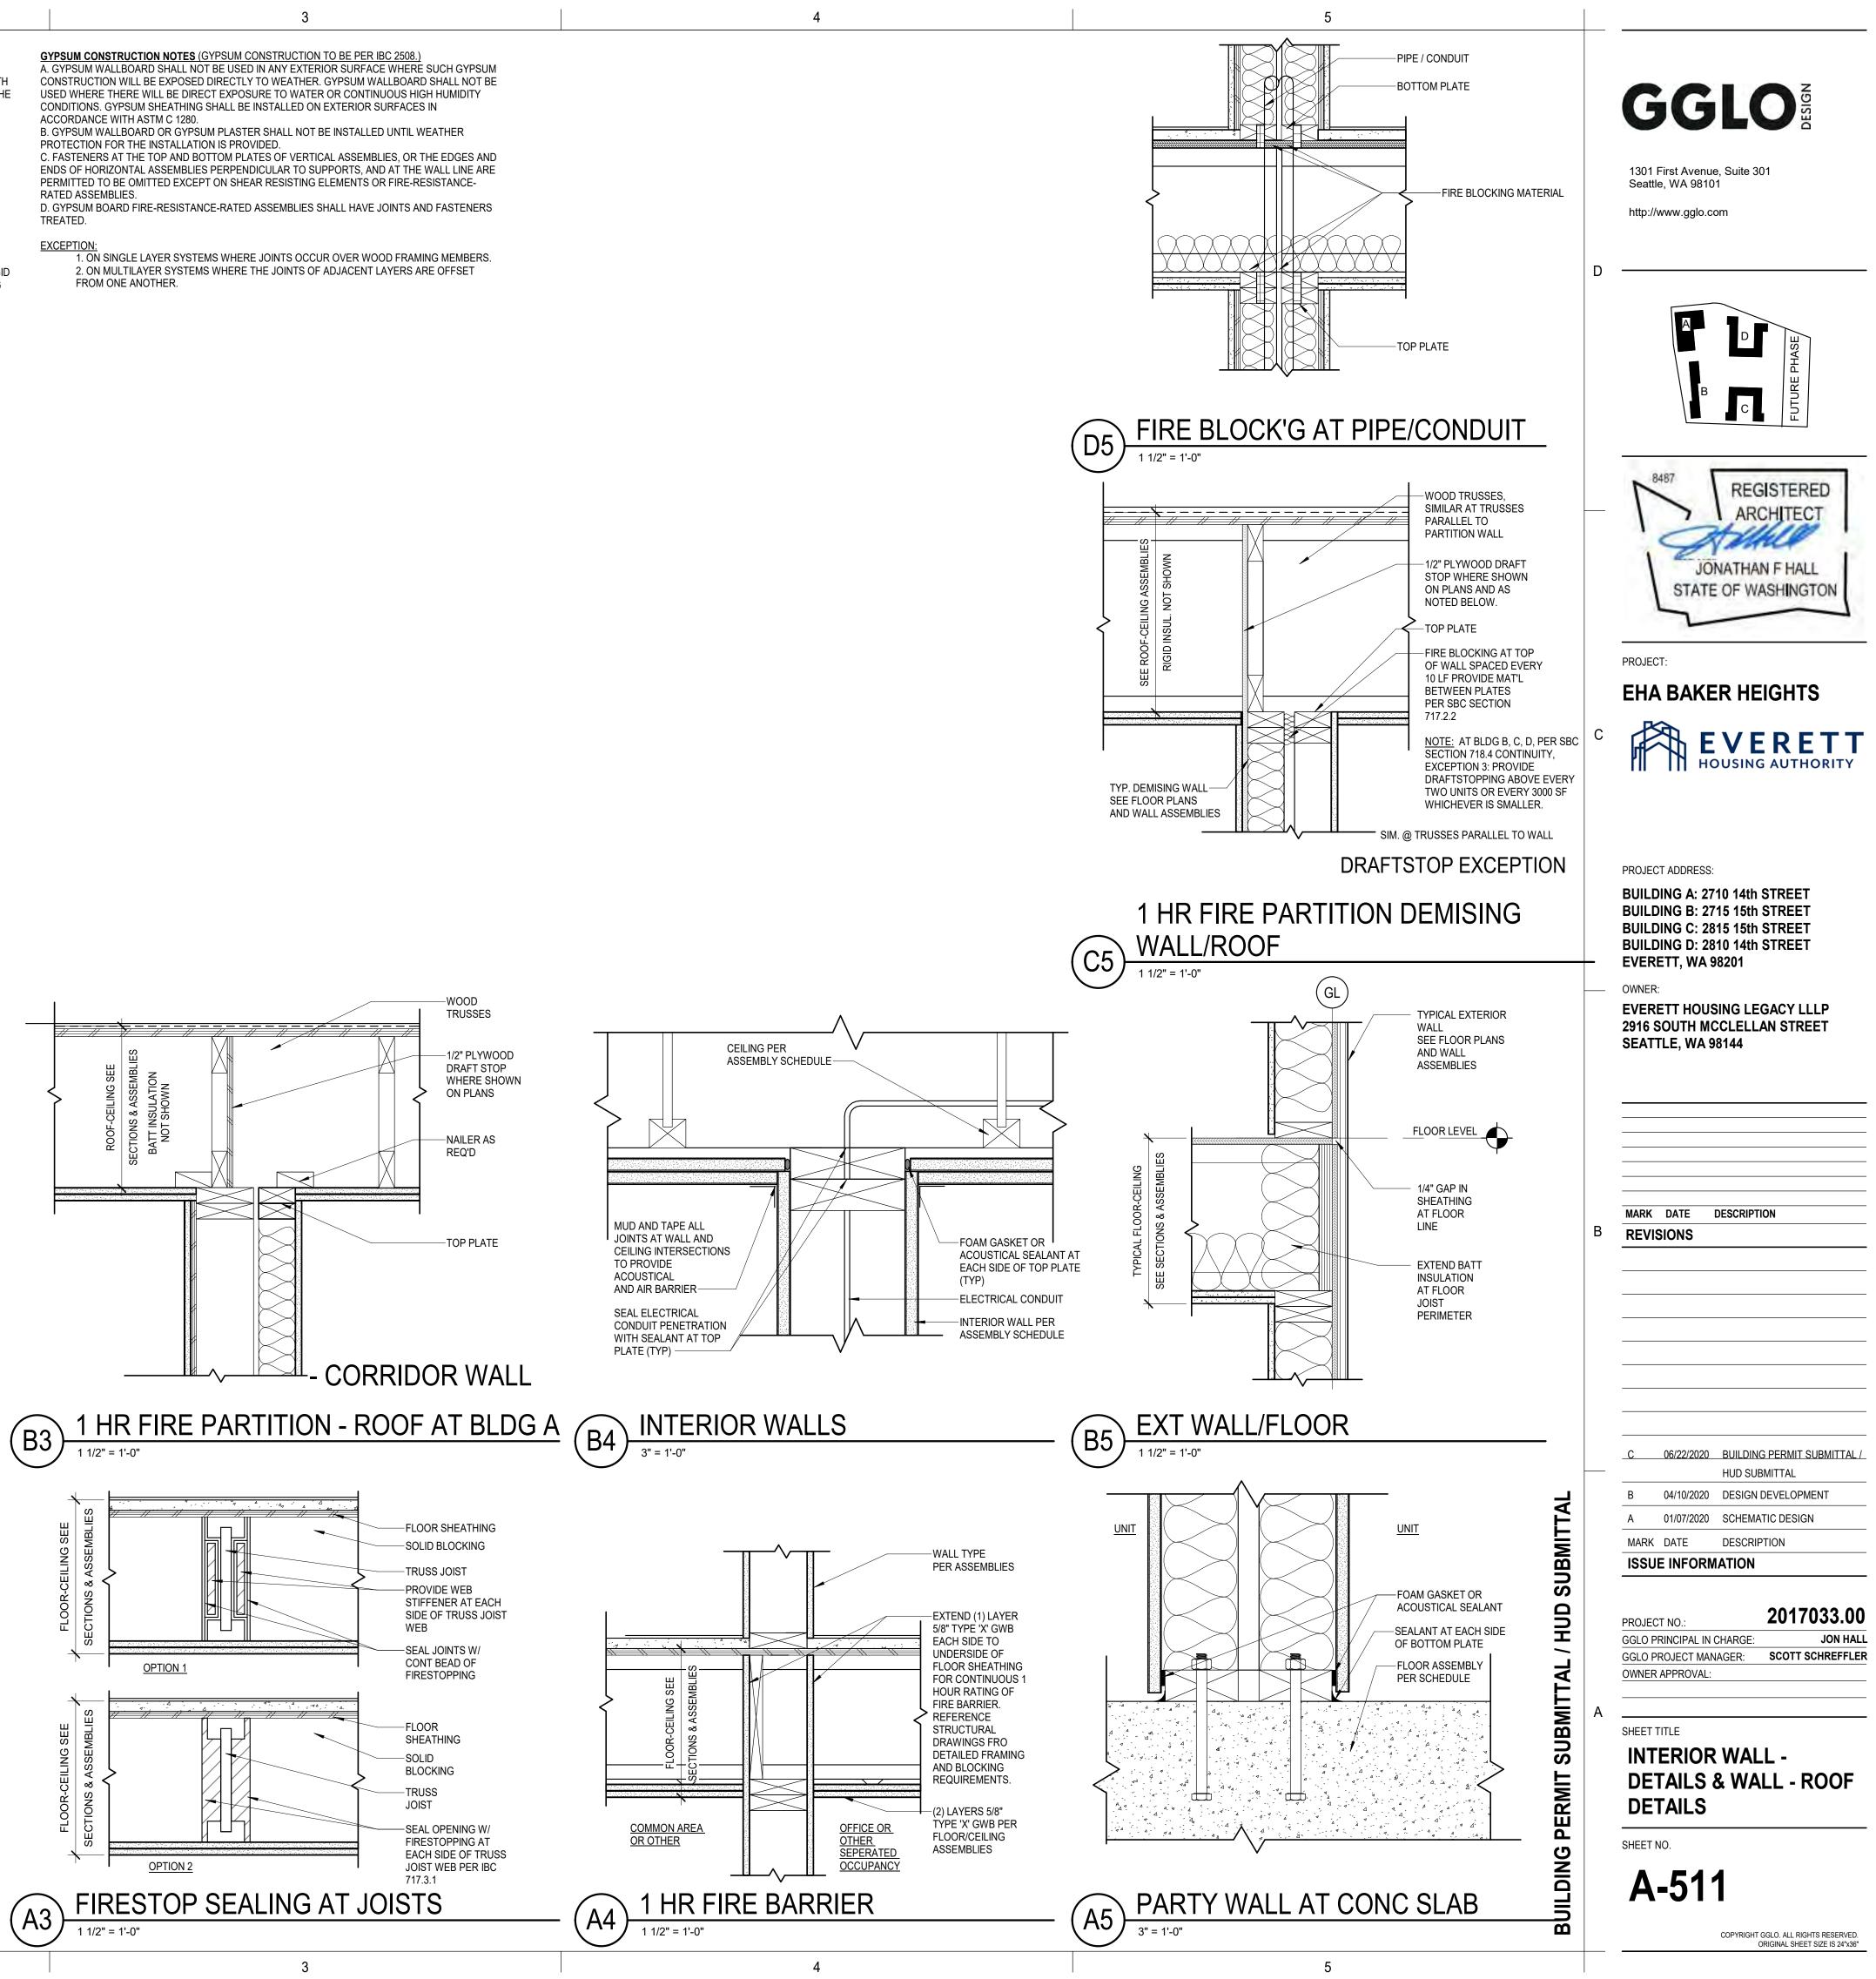
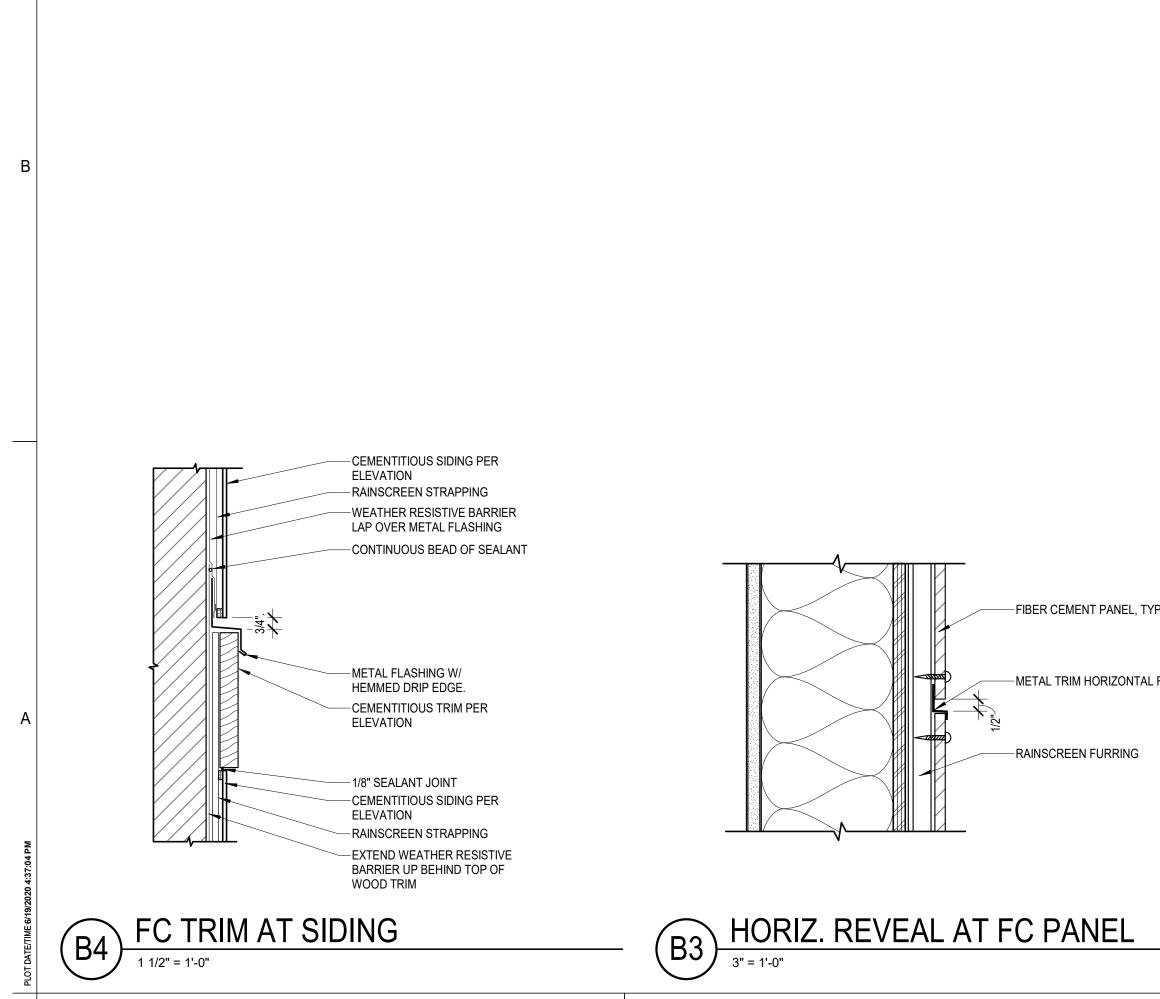
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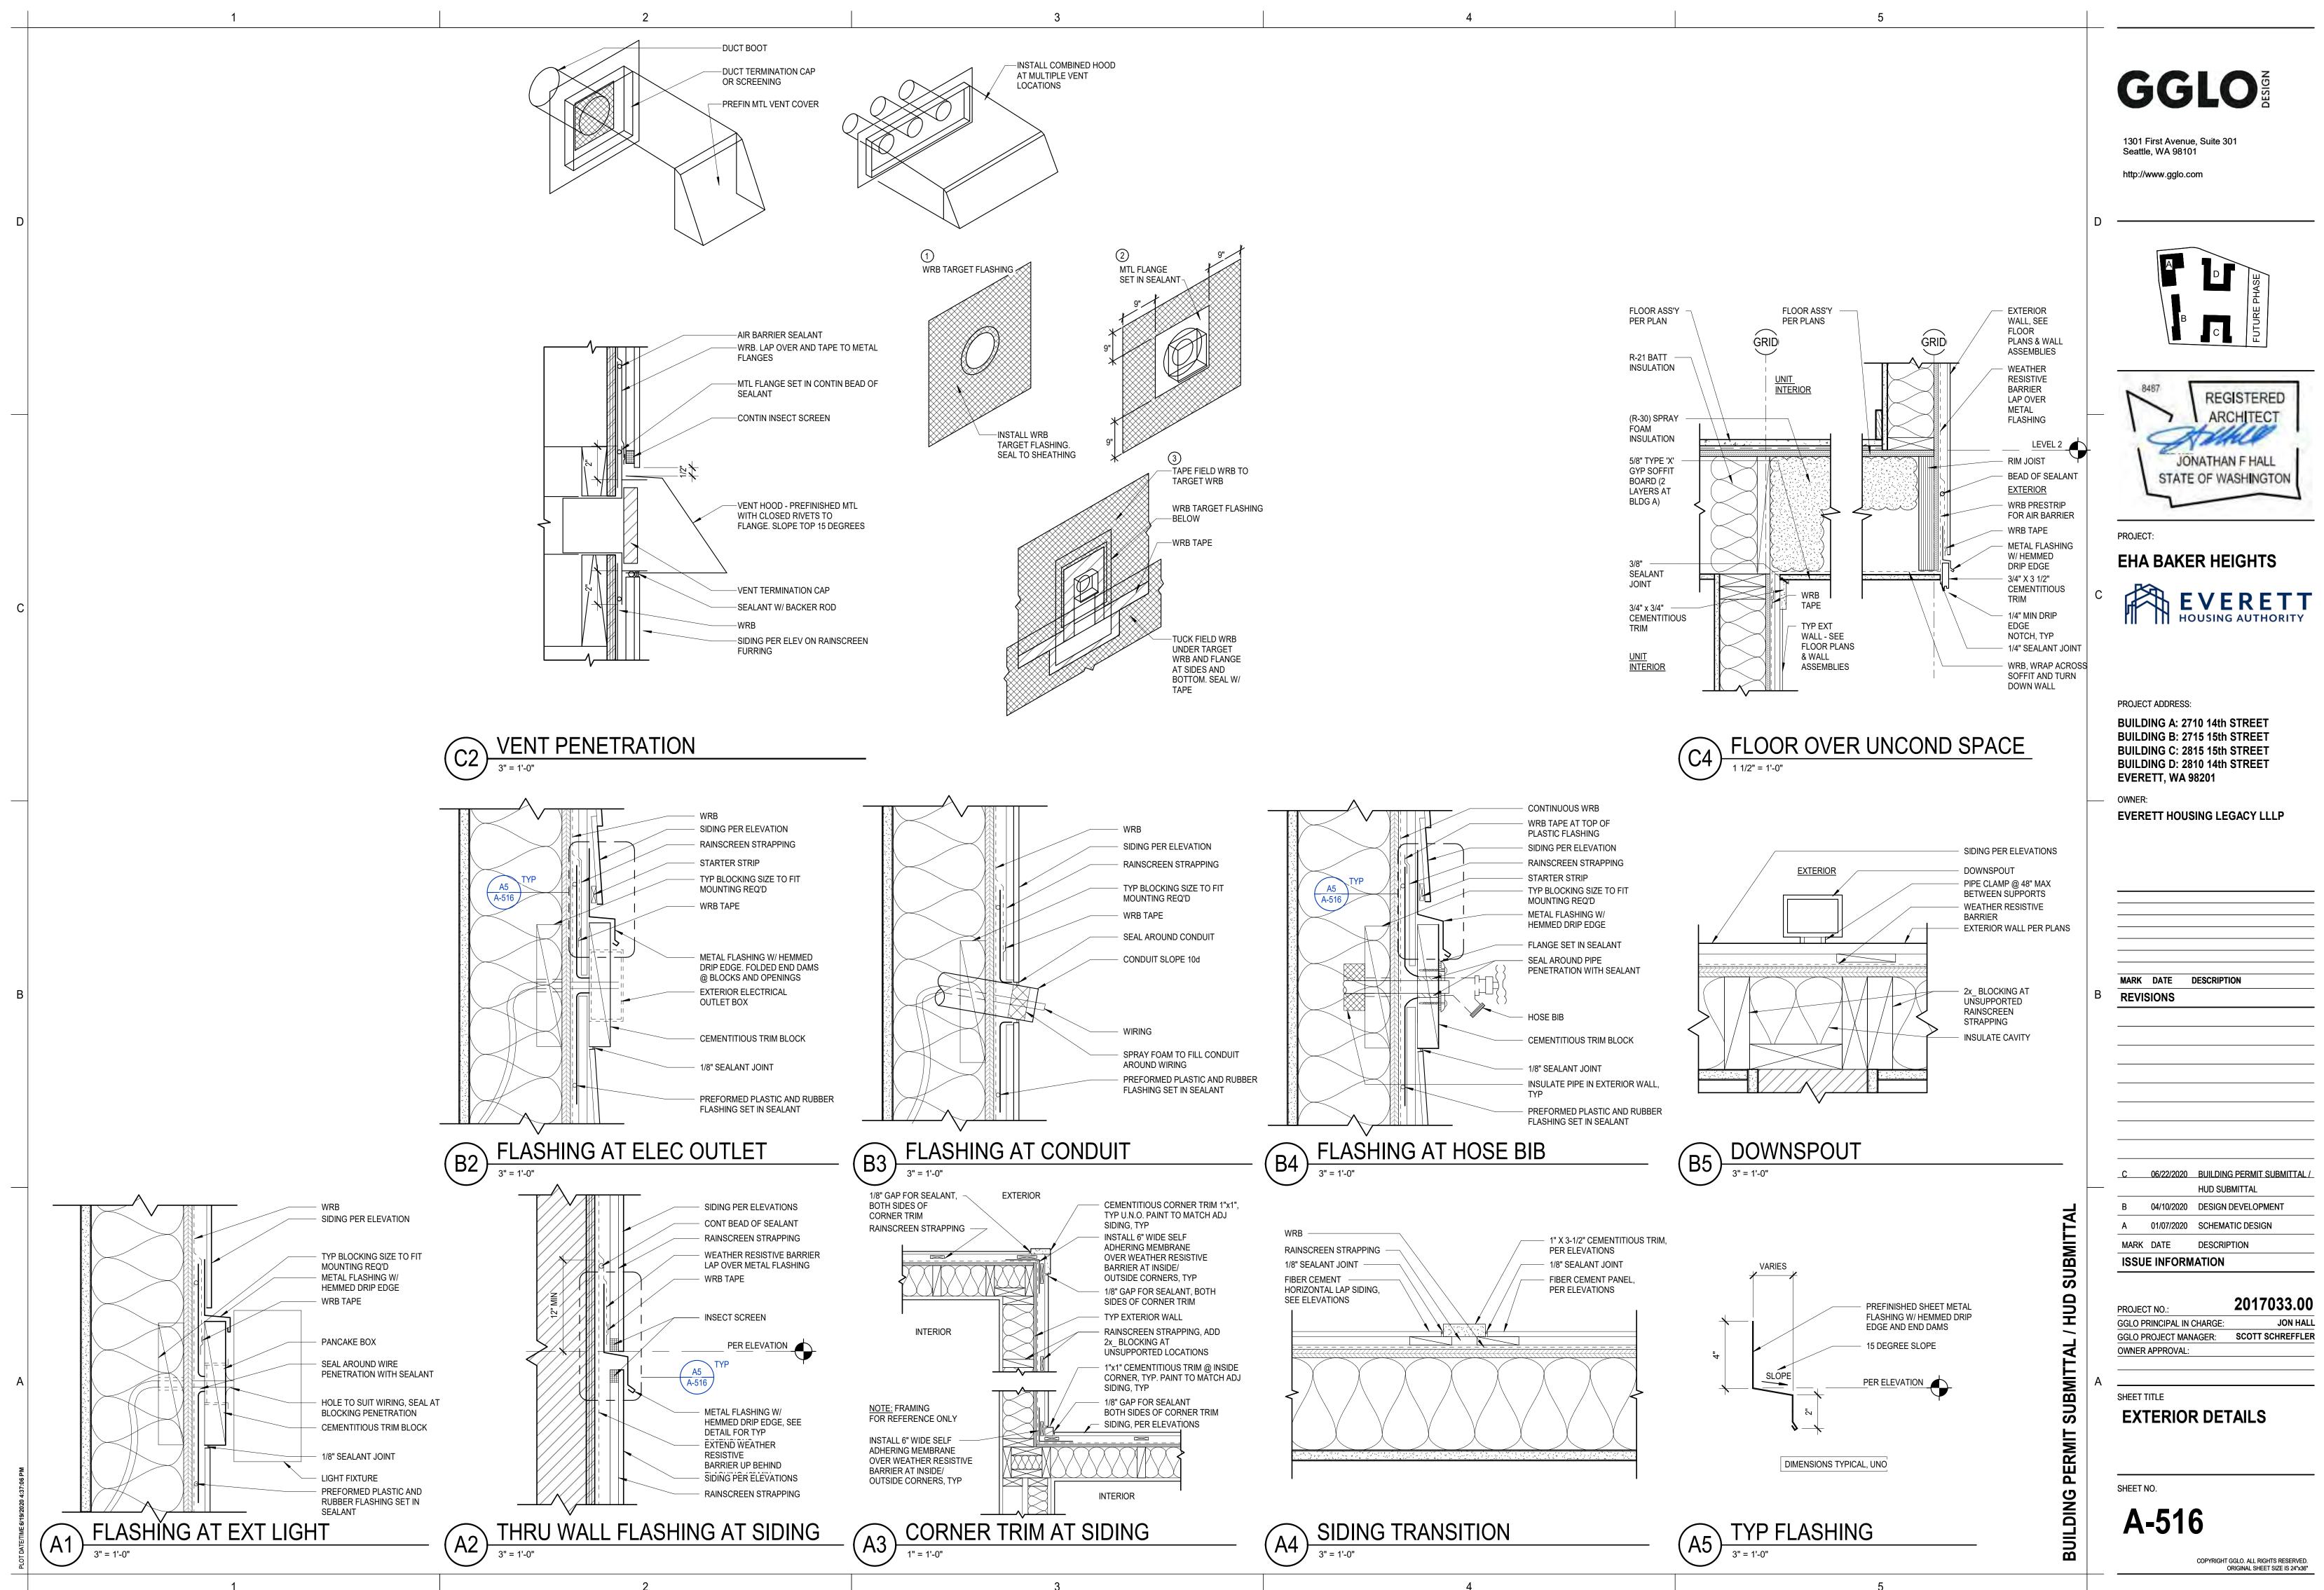
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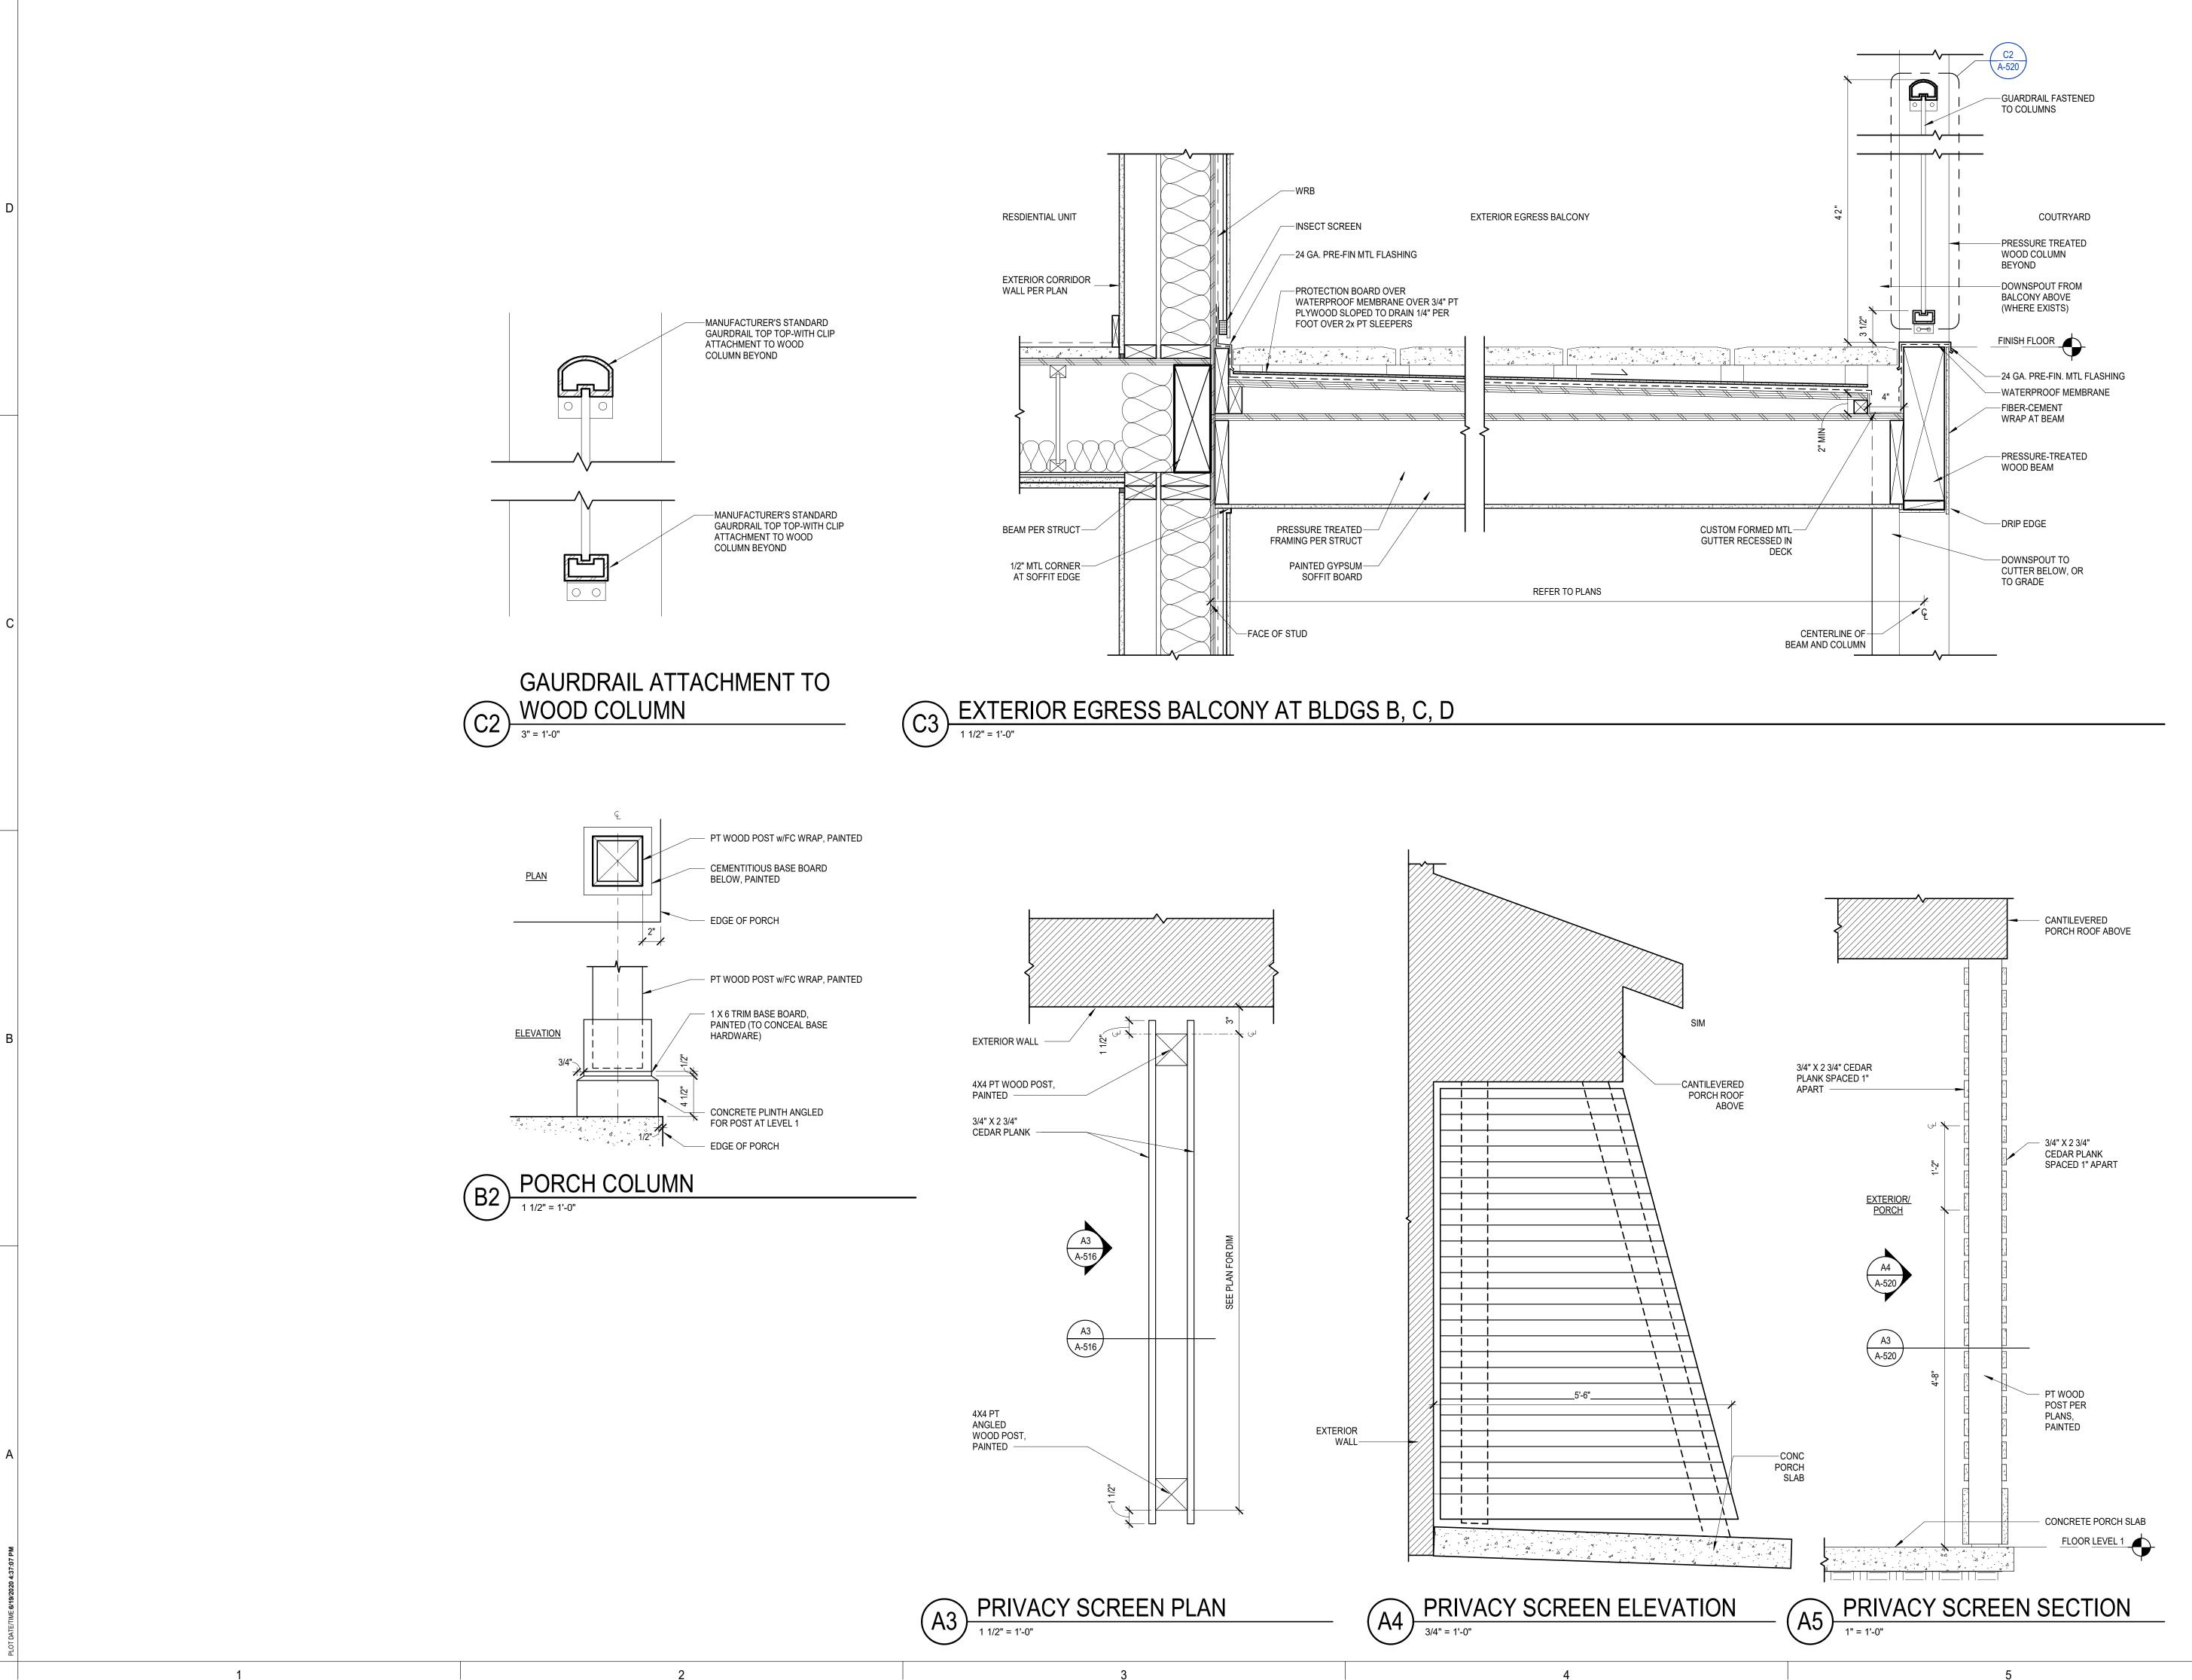
- CONTINUE SHEATHING DOWN TO CEILING

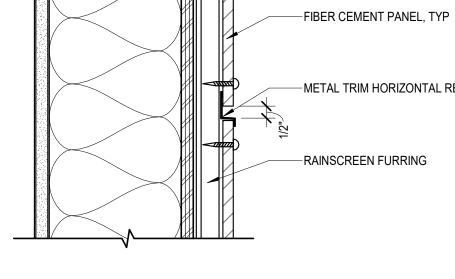
---WRAP WEATHER RESISTIVE BARRIER AROUND BOTTOM OF BEAM


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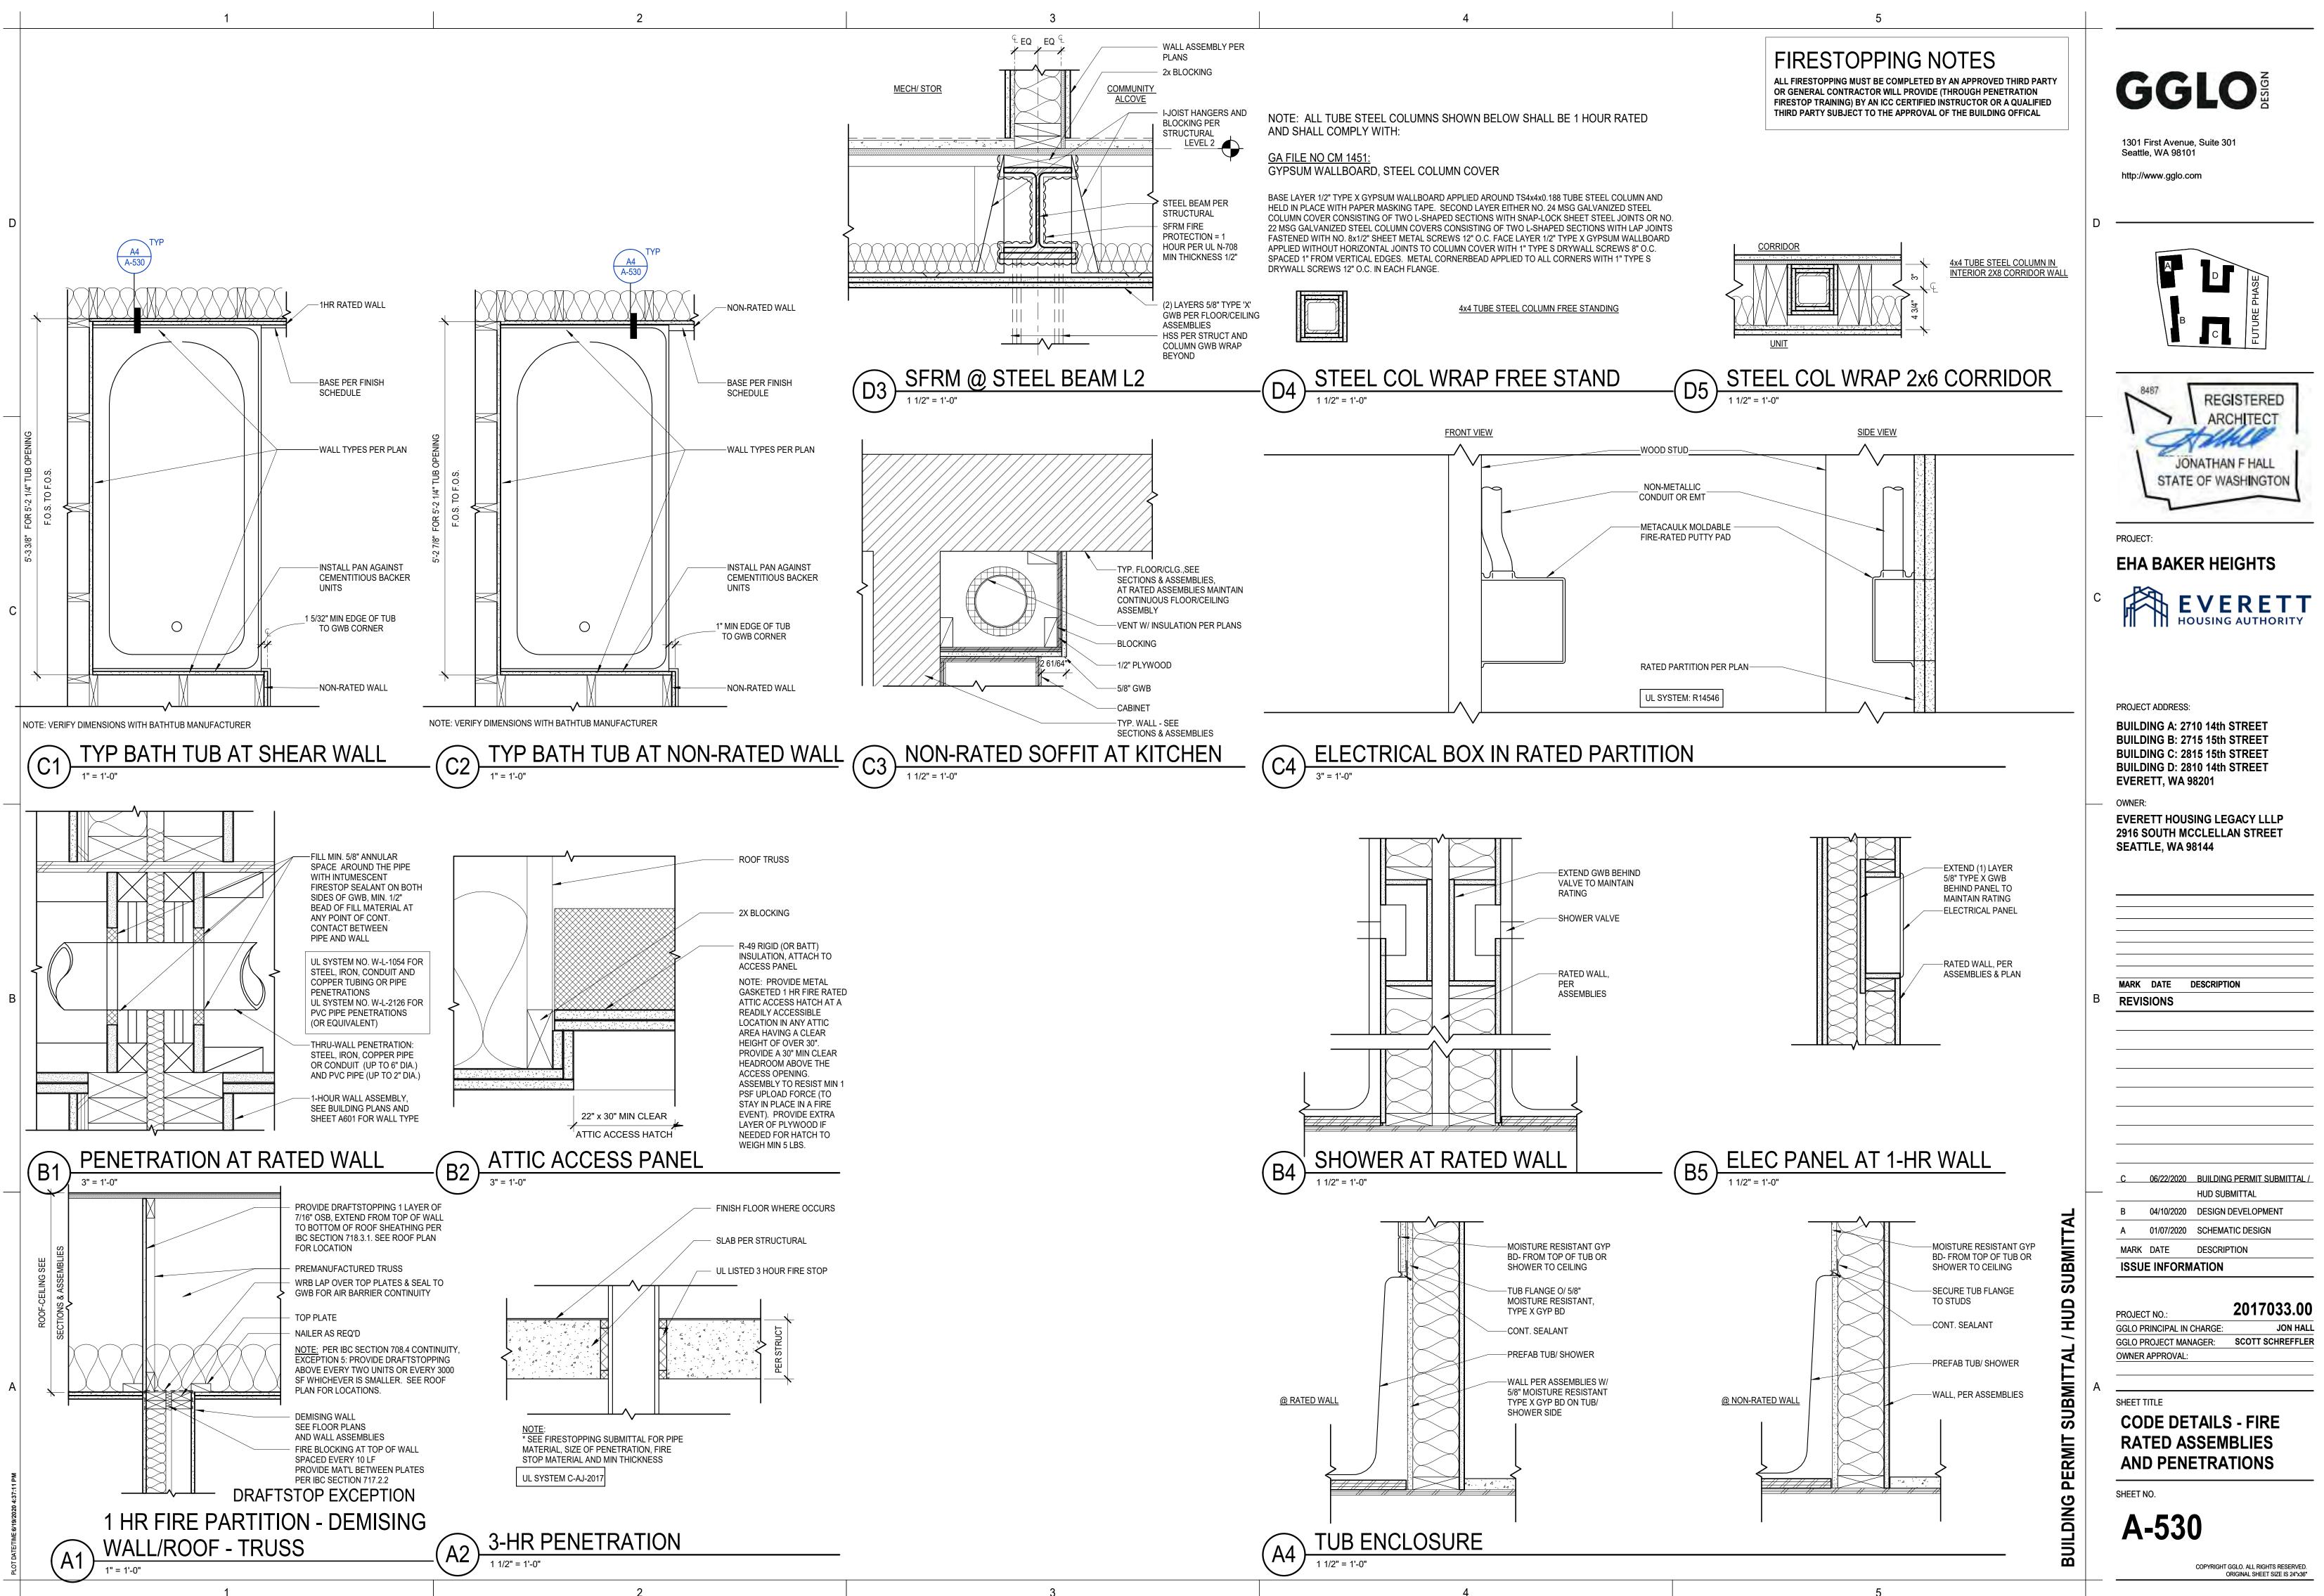
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		PROJECT ADDRESS: BUILDING A: 2710 14th STREET BUILDING B: 2715 15th STREET BUILDING C: 2815 15th STREET BUILDING D: 2810 14th STREET EVERETT, WA 98201 OWNER: EVERETT HOUSING LEGACY LLLP 2916 SOUTH MCCLELLAN STREET SEATTLE, WA 98144
	В	MARK DATE DESCRIPTION REVISIONS
METAL TRIM VERTICAL REVEL	PERMII SUBMII IAL / HUD SUBMII IAL	C 06/22/2020 BUILDING PERMIT SUBMITTAL / HUD SUBMITTAL HUD SUBMITTAL B 04/10/2020 DESIGN DEVELOPMENT A 01/07/2020 SCHEMATIC DESIGN MARK DATE DESCRIPTION ISSUE INFORMATION DESCRIPTION PROJECT NO: PROJECT NO: GGLO PRINCIPAL IN CHARGE: JON HALL GGLO PROJECT MANAGER: SCOTT SCHREFFLER OWNER APPROVAL: SHEET TITLE EXTERSION DETAILS SHEET TITLE
		SHEET NO. A-515 COPYRIGHT GGLO. ALL RIGHTS RESERVED. ORIGINAL SHEET SIZE IS 24*x38*









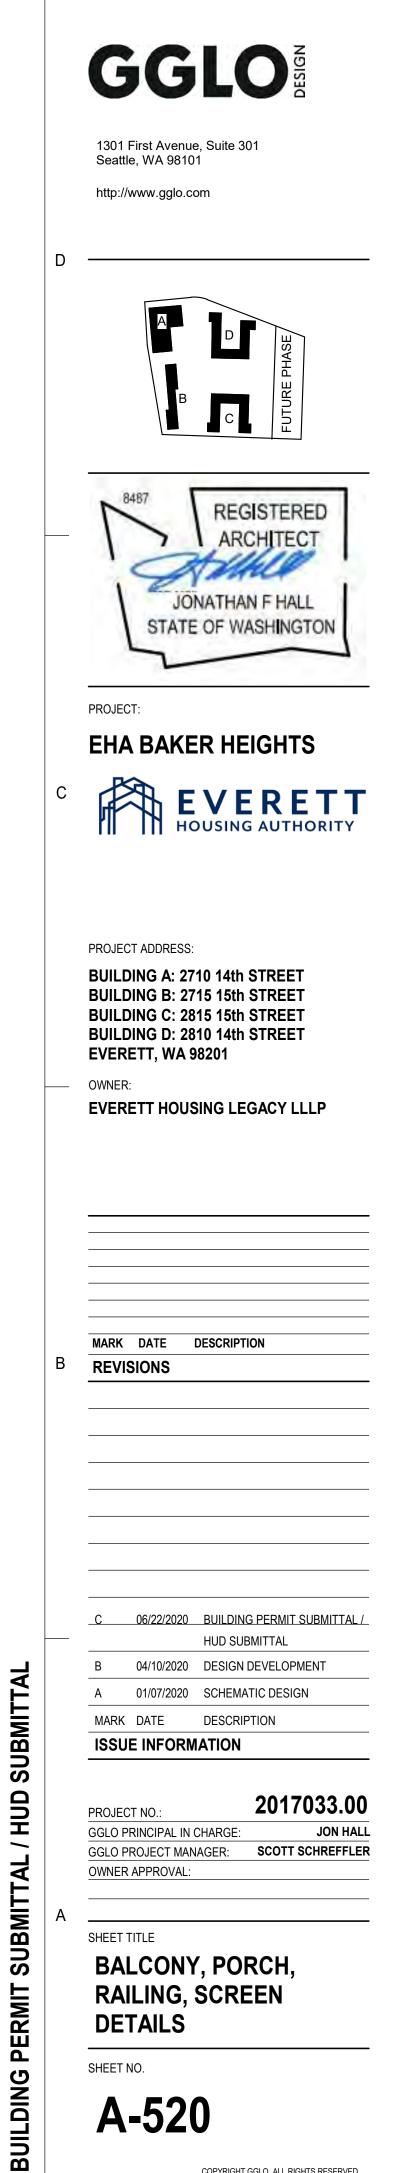

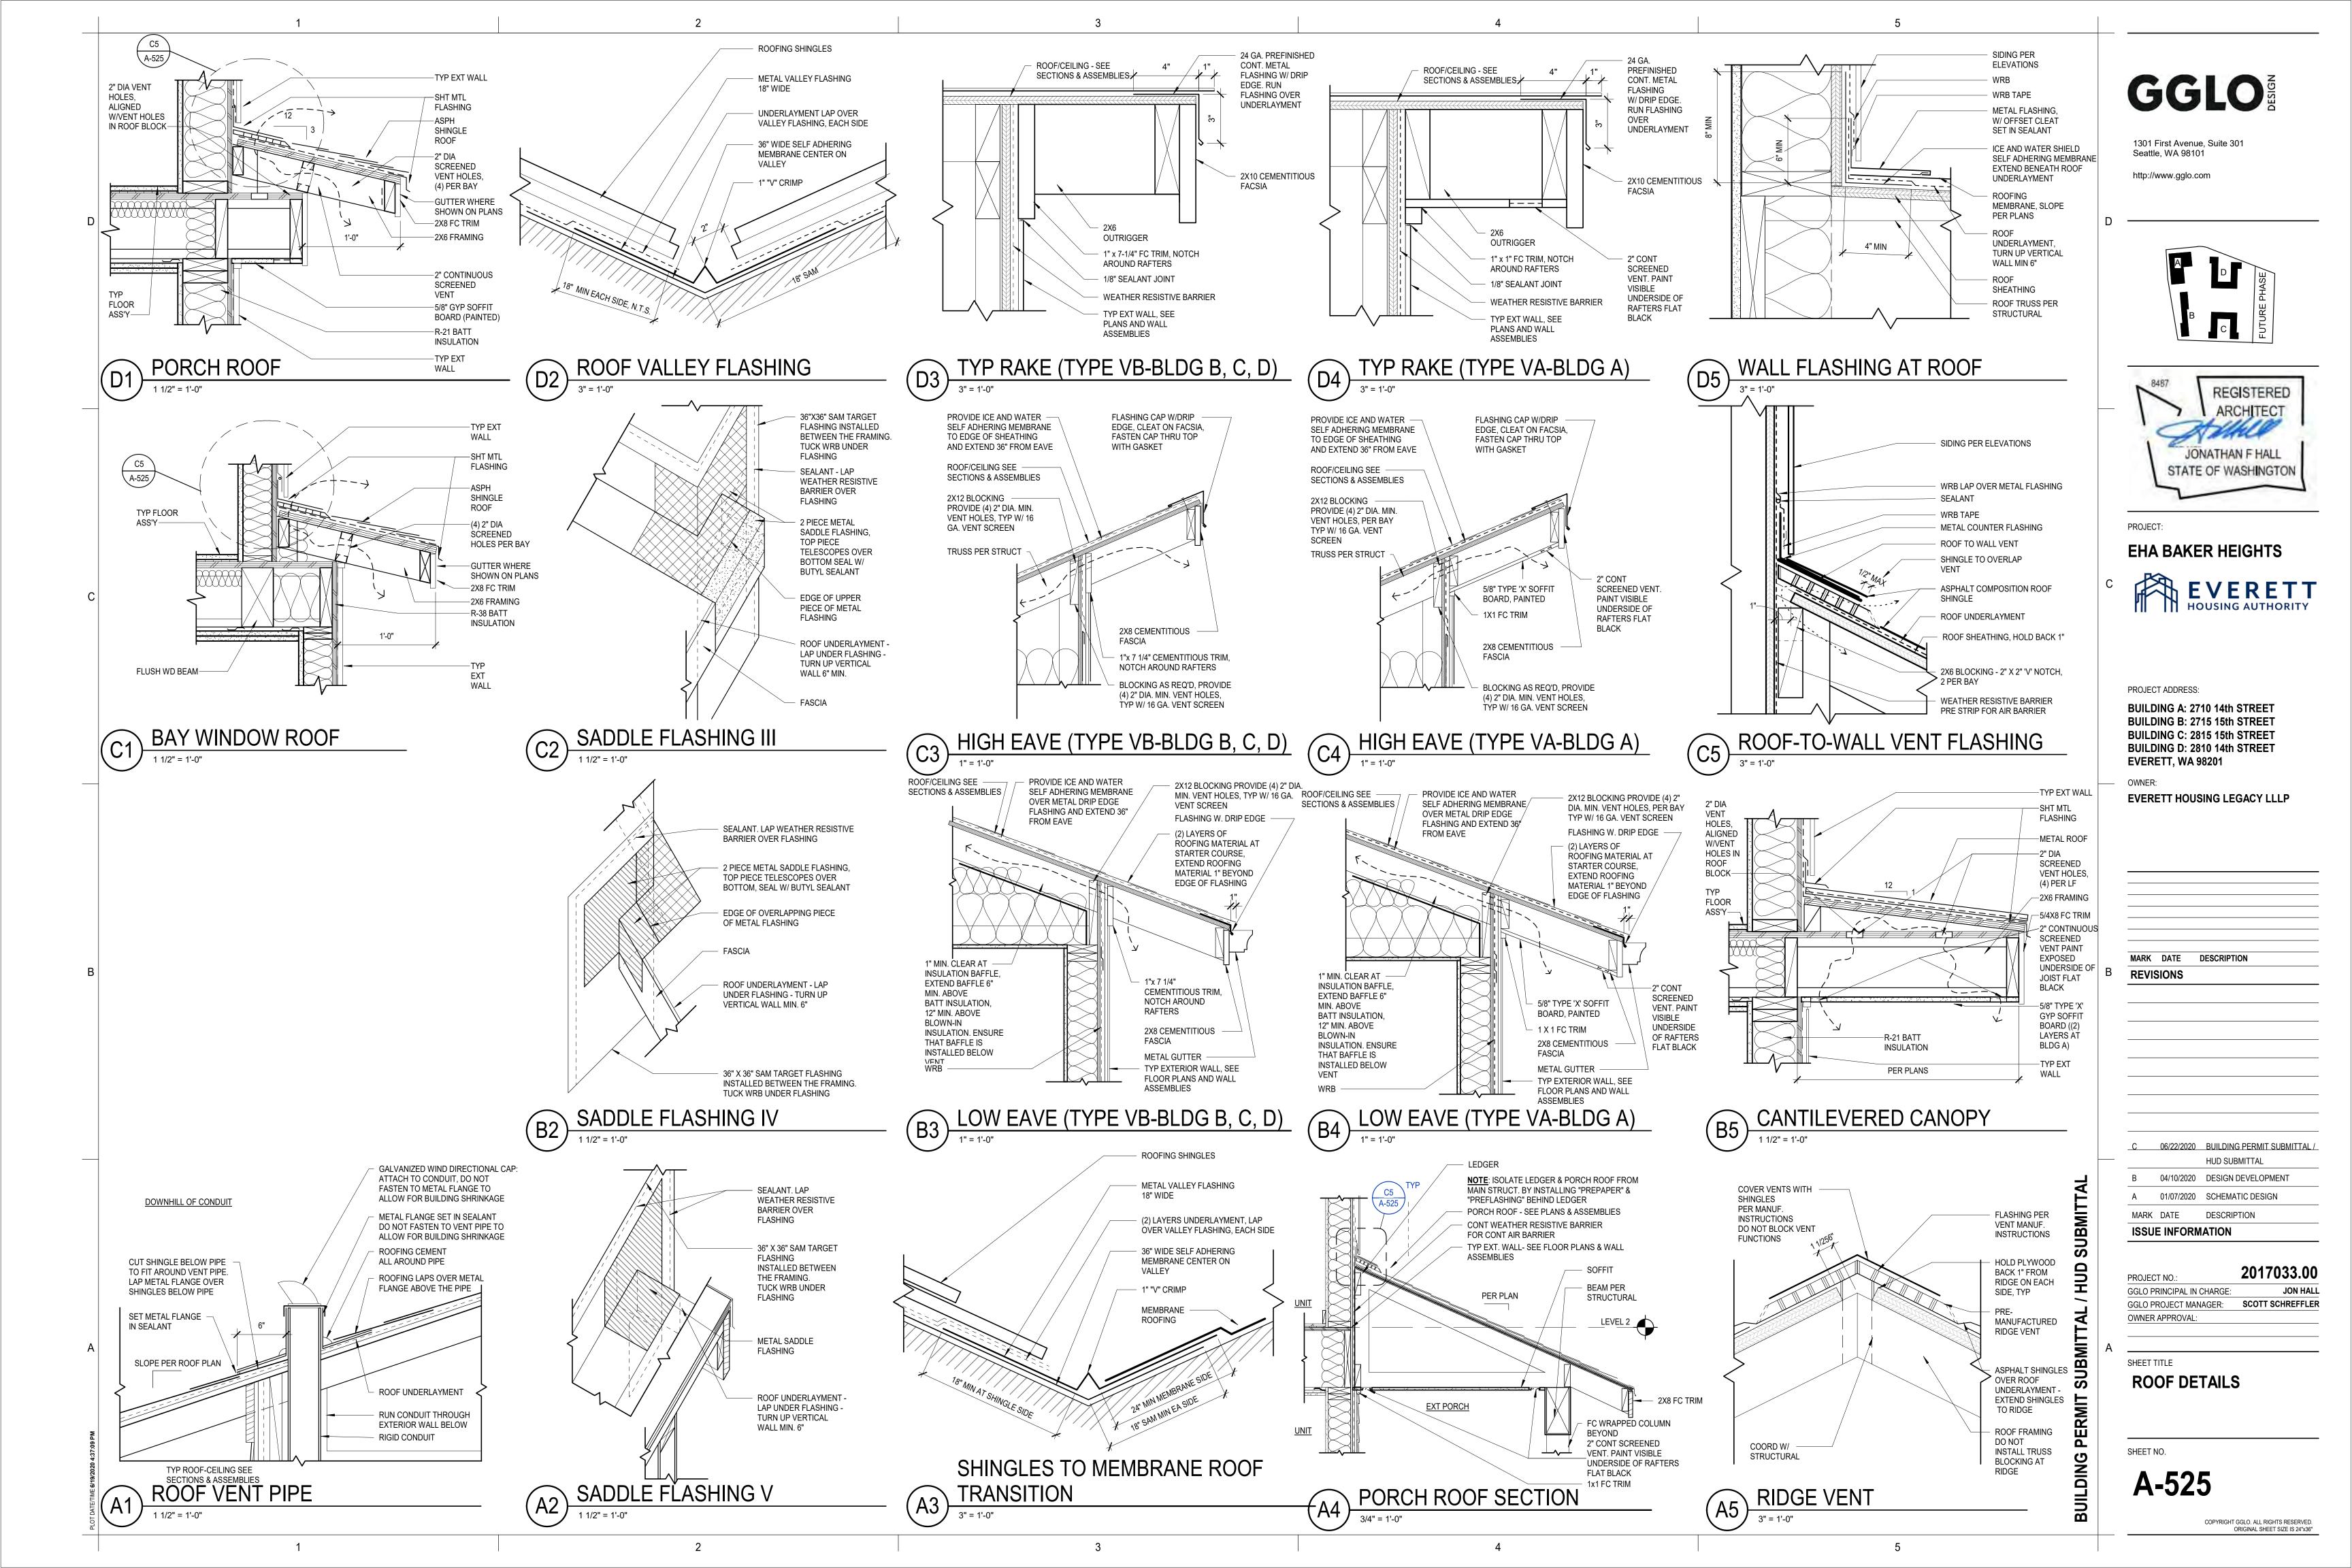

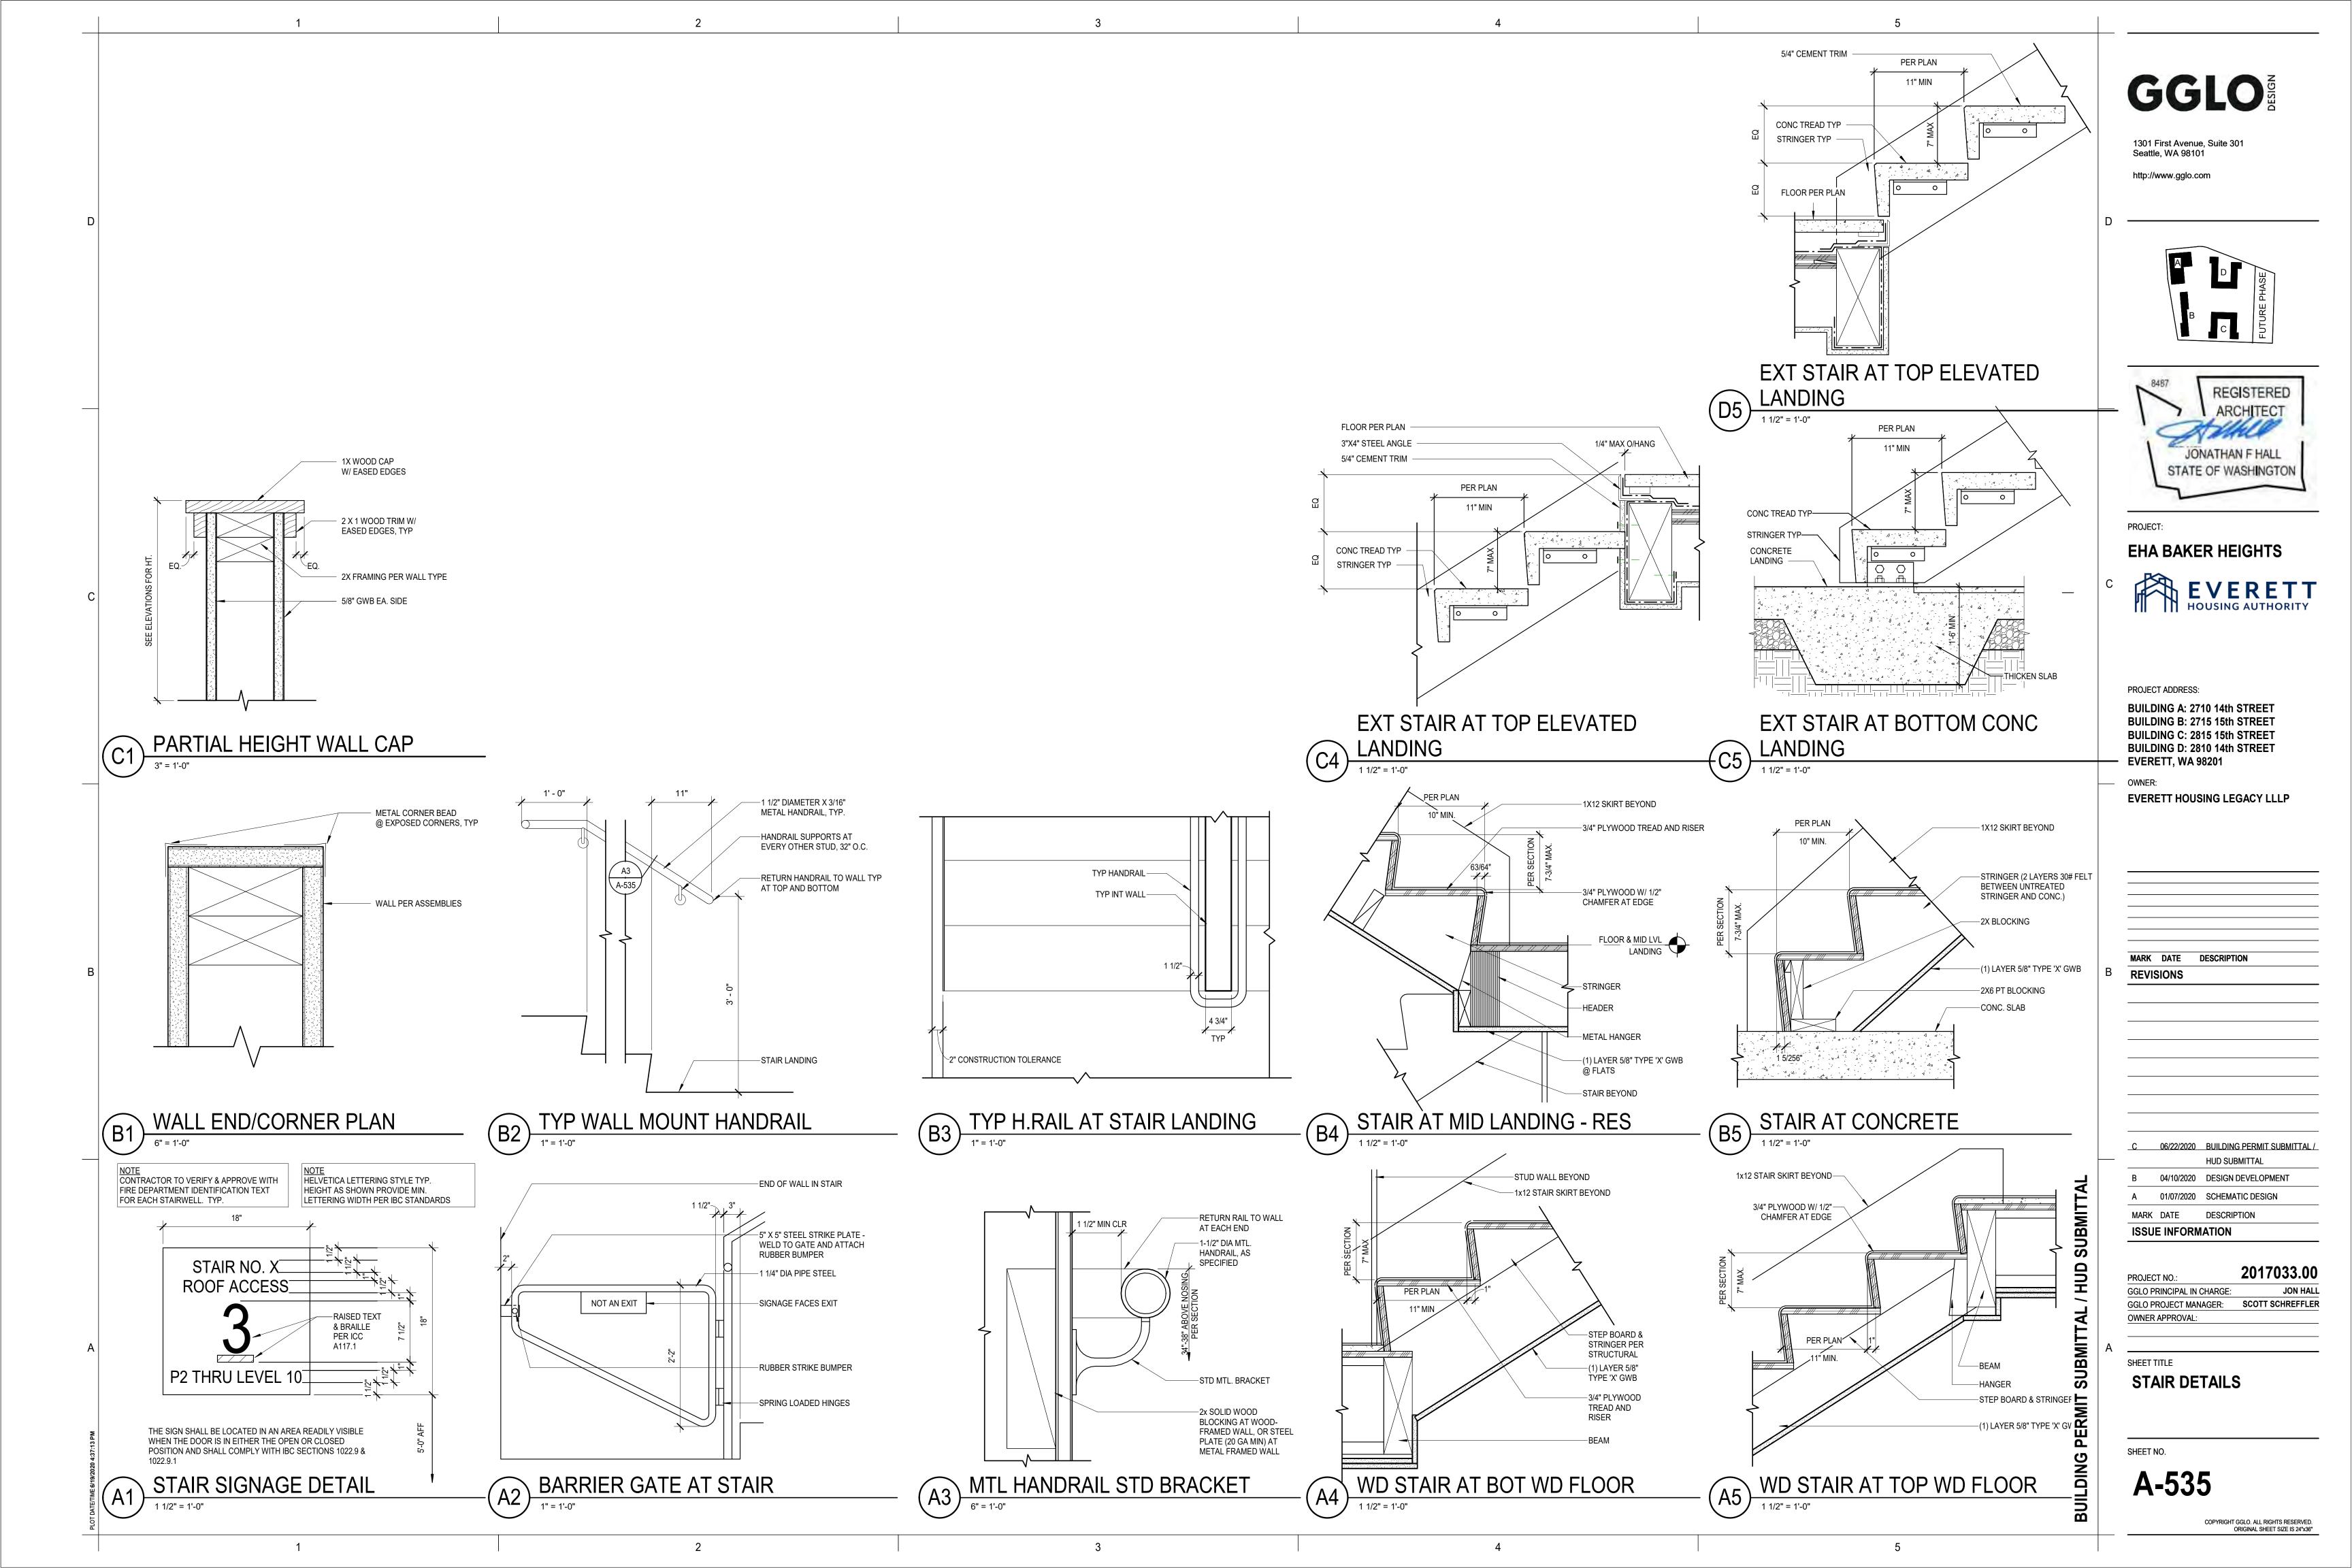

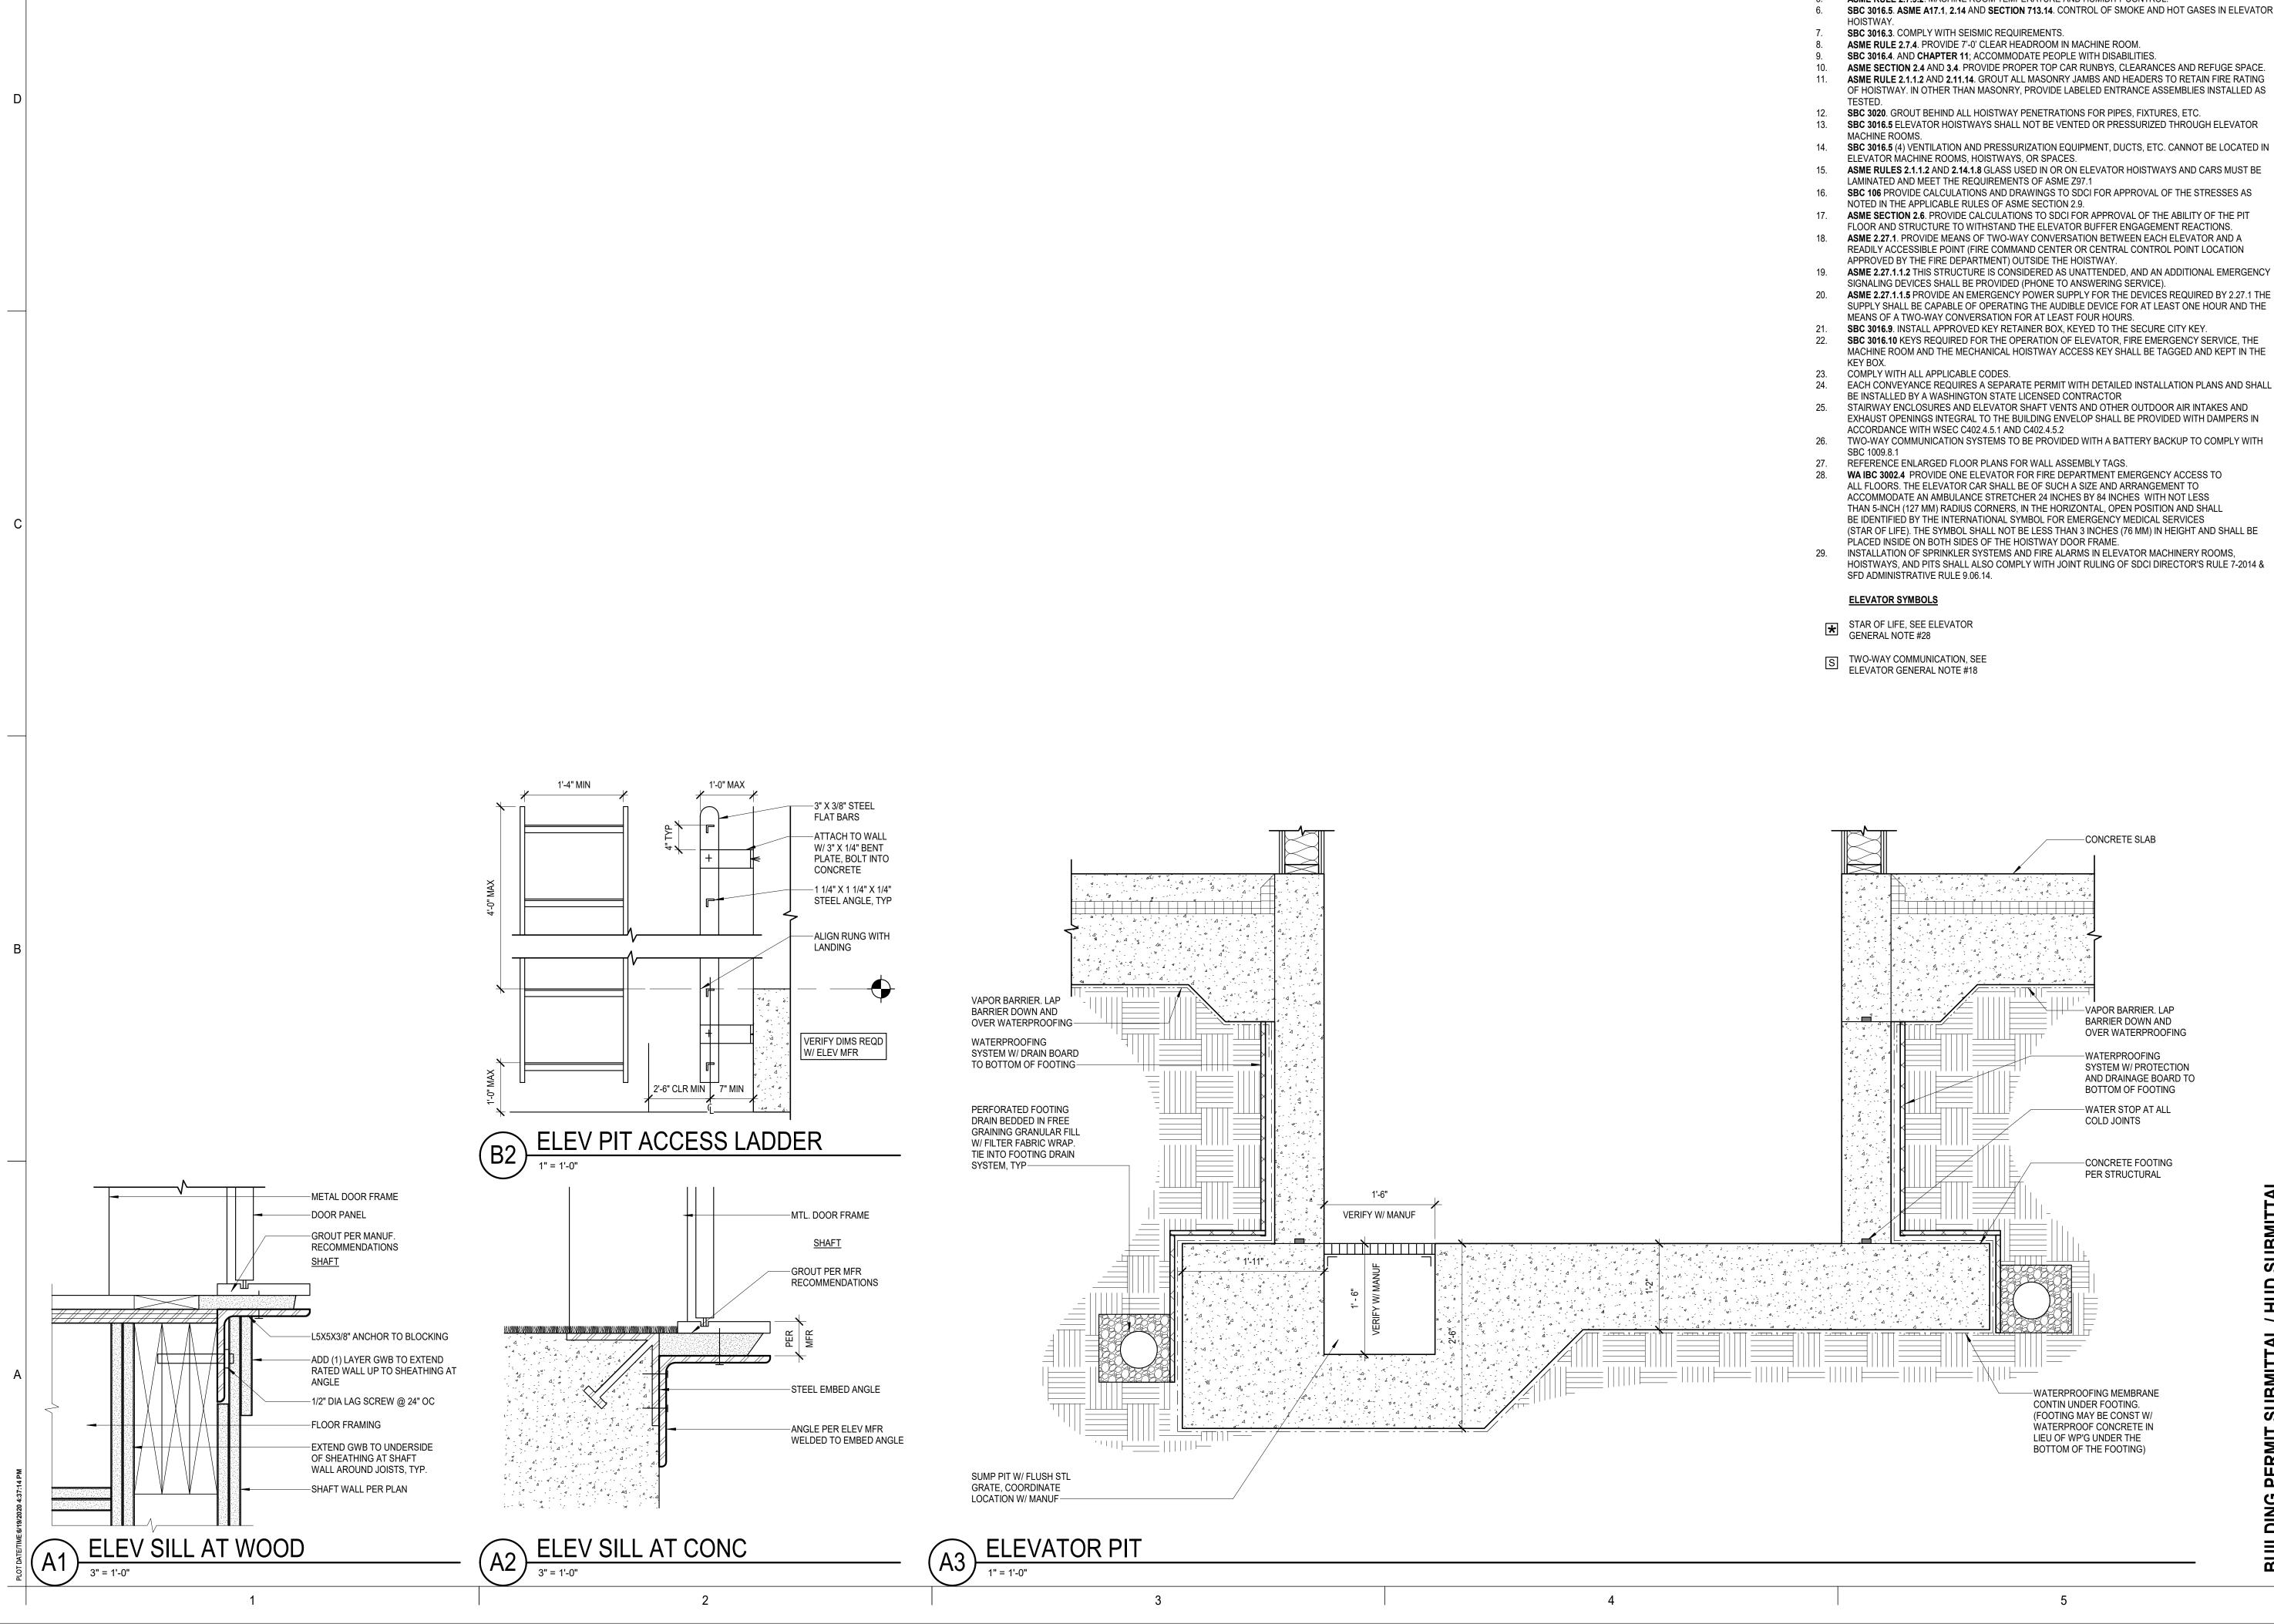

GENERAL ELEVATOR NOTES


- SBC SECTION 3022 AND ASME SECTIONS 2.7 AND 2.8. PIPES, DUCTS, CONDUITS, AND EQUIPMENT NOT 1 USED FOR THE OPERATION OF THE ELEVATORS ARE PROHIBITED IN MACHINE ROOM AND HOISTWAY.
- SBC 3020. MAINTAIN ALL REQUIRED WORKING CLEARANCES IN MACHINE ROOM. ASME RULE 2.2.2. WATERPROOF AS NECESSARY TO PREVENT ENTRY OF GROUND WATER. SUMP
- PUMPS MAY BE INSTALLED FOR FLOOD CONTROL BUT NOT APPROVED TO MAINTAIN A DRY PIT.
- SBC 3023, ASME RULE 2.2.4. PROVIDE PIT LADDER. ASME RULE 2.7.9.2. MACHINE ROOM TEMPERATURE AND HUMIDITY CONTROL.
- SBC 3016.5. ASME A17.1, 2.14 AND SECTION 713.14. CONTROL OF SMOKE AND HOT GASES IN ELEVATOR

- ASME SECTION 2.4 AND 3.4. PROVIDE PROPER TOP CAR RUNBYS, CLEARANCES AND REFUGE SPACE. ASME RULE 2.1.1.2 AND 2.11.14. GROUT ALL MASONRY JAMBS AND HEADERS TO RETAIN FIRE RATING OF HOISTWAY. IN OTHER THAN MASONRY, PROVIDE LABELED ENTRANCE ASSEMBLIES INSTALLED AS
- SBC 3016.5 ELEVATOR HOISTWAYS SHALL NOT BE VENTED OR PRESSURIZED THROUGH ELEVATOR
- SBC 3016.5 (4) VENTILATION AND PRESSURIZATION EQUIPMENT, DUCTS, ETC. CANNOT BE LOCATED IN
- ASME RULES 2.1.1.2 AND 2.14.1.8 GLASS USED IN OR ON ELEVATOR HOISTWAYS AND CARS MUST BE
- SBC 106 PROVIDE CALCULATIONS AND DRAWINGS TO SDCI FOR APPROVAL OF THE STRESSES AS
- FLOOR AND STRUCTURE TO WITHSTAND THE ELEVATOR BUFFER ENGAGEMENT REACTIONS. ASME 2.27.1. PROVIDE MEANS OF TWO-WAY CONVERSATION BETWEEN EACH ELEVATOR AND A READILY ACCESSIBLE POINT (FIRE COMMAND CENTER OR CENTRAL CONTROL POINT LOCATION
- ASME 2.27.1.1.2 THIS STRUCTURE IS CONSIDERED AS UNATTENDED, AND AN ADDITIONAL EMERGENCY ASME 2.27.1.1.5 PROVIDE AN EMERGENCY POWER SUPPLY FOR THE DEVICES REQUIRED BY 2.27.1 THE
- SUPPLY SHALL BE CAPABLE OF OPERATING THE AUDIBLE DEVICE FOR AT LEAST ONE HOUR AND THE
- SBC 3016.10 KEYS REQUIRED FOR THE OPERATION OF ELEVATOR, FIRE EMERGENCY SERVICE, THE MACHINE ROOM AND THE MECHANICAL HOISTWAY ACCESS KEY SHALL BE TAGGED AND KEPT IN THE
- STAIRWAY ENCLOSURES AND ELEVATOR SHAFT VENTS AND OTHER OUTDOOR AIR INTAKES AND EXHAUST OPENINGS INTEGRAL TO THE BUILDING ENVELOP SHALL BE PROVIDED WITH DAMPERS IN
- TWO-WAY COMMUNICATION SYSTEMS TO BE PROVIDED WITH A BATTERY BACKUP TO COMPLY WITH
- WA IBC 3002.4 PROVIDE ONE ELEVATOR FOR FIRE DEPARTMENT EMERGENCY ACCESS TO ALL FLOORS. THE ELEVATOR CAR SHALL BE OF SUCH A SIZE AND ARRANGEMENT TO ACCOMMODATE AN AMBULANCE STRETCHER 24 INCHES BY 84 INCHES WITH NOT LESS THAN 5-INCH (127 MM) RADIUS CORNERS, IN THE HORIZONTAL, OPEN POSITION AND SHALL BE IDENTIFIED BY THE INTERNATIONAL SYMBOL FOR EMERGENCY MEDICAL SERVICES (STAR OF LIFE). THE SYMBOL SHALL NOT BE LESS THAN 3 INCHES (76 MM) IN HEIGHT AND SHALL BE
- INSTALLATION OF SPRINKLER SYSTEMS AND FIRE ALARMS IN ELEVATOR MACHINERY ROOMS, HOISTWAYS, AND PITS SHALL ALSO COMPLY WITH JOINT RULING OF SDCI DIRECTOR'S RULE 7-2014 &

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PROJECT:

EHA BAKER HEIGHTS

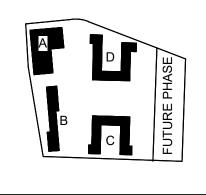

PROJECT ADDRESS:

BUILDING A: 2710 14th STREET BUILDING B: 2715 15th STREET BUILDING C: 2815 15th STREET BUILDING D: 2810 14th STREET **EVERETT, WA 98201**

OWNER:

EVERETT HOUSING LEGACY LLLP 2916 SOUTH MCCLELLAN STREET SEATTLE, WA 98144

MARK	DATE	DESCRIPTION
REVIS	SIONS	
С	06/22/2020	BUILDING PERMIT SUBMITT
		HUD SUBMITTAL
В	04/10/2020	DESIGN DEVELOPMENT
А	01/07/2020	SCHEMATIC DESIGN
MARK	DATE	DESCRIPTION
ISSU		IATION
		2047022
PROJEC		2017033.
	ROJECT MAN APPROVAL:	IAGER: SCOTT SCHREFT
	AFFROVAL.	

ELEVATOR DETAILS & NOTES

SHEET NO.

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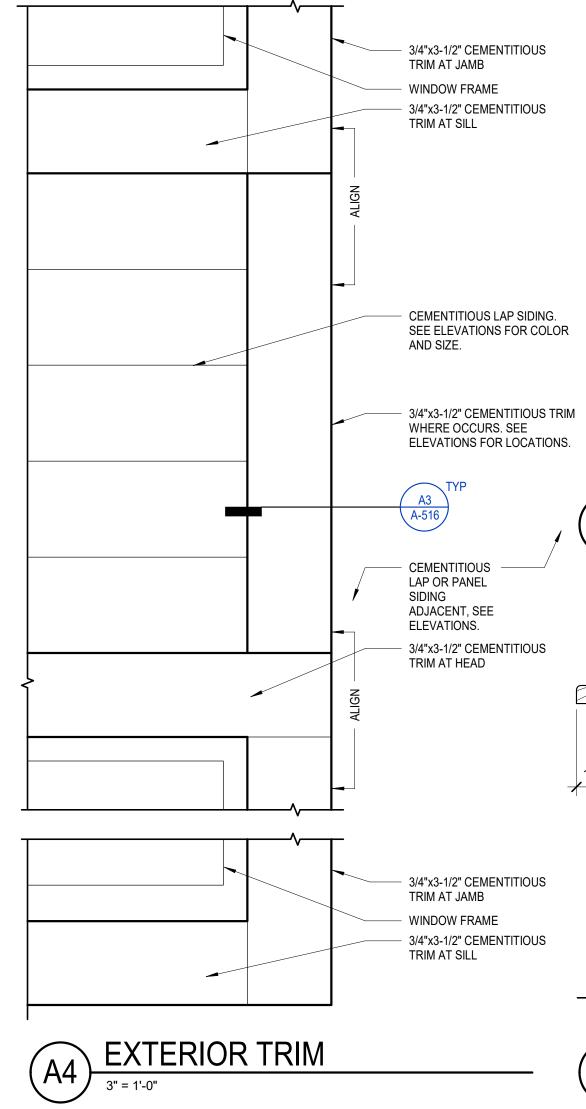
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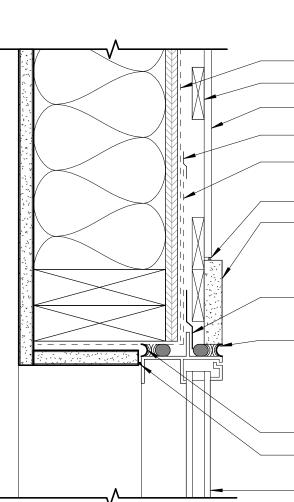
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WRB

- RAINSCREEN STRAPPING CEMENTITIOUS SIDING
- WRB TAPE STRIP OF WRB INTO ROUGH OPENING
- 1/8" SEALANT JOINT - 3/4" X 3 1/2" CEMENTITIOUS TRIM
- SAM OVER JAMB FLANGE
- 1/2" SEALANT JOINT W/ BACKER ROD


- INTERIOR SEALANT W/ BACKER ROD - 1/4" INTERIOR SEALANT BETWEEN GWB & WINDOW - WINDOW UNIT


WEATHER RESISTIVE BARRIER PRE-

NAILER

GWB & WINDOW

- WINDOW UNIT

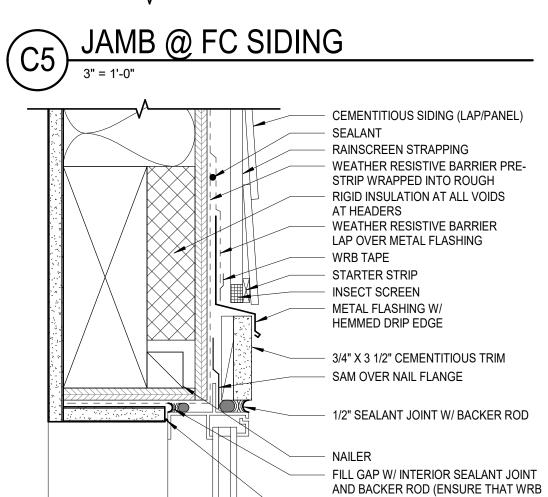

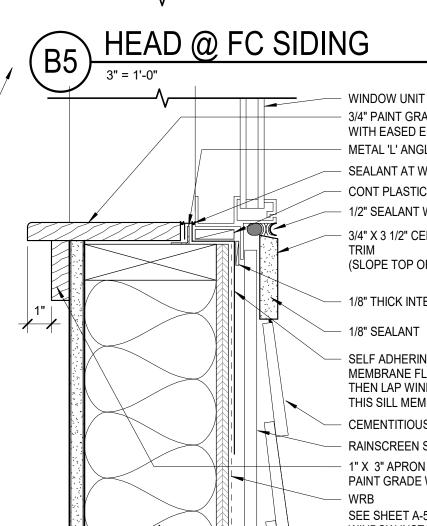

- WINDOW UNIT 3/4" PAINT GRADE WOOD SILL WITH EASED EDGE METAL 'L' ANGLE SEALANT AT WINDOW FRAME CONT PLASTIC SHIM - 1/2" SEALANT W/ BACKER ROD 3/4" X 3 1/2" CEMENTITIOUS TRIM (SLOPE TOP OF TRIM MIN 15%)

IS SEALED TO WINDOW FRAME)

1/4" INTERIOR SEALANT BETWEEN

- 1/8" THICK INTERMITTENT SHIMS

- SELF ADHERING MEMBRANE (RUN MEMBRANE FLASHING 6" UP JAMBS THEN LAP WINDOW JAMB WRB OVER THIS SILL MEMBRANE — CEMENTITIOUS SIDING (LAP/PANEL) - RAINSCREEN STRAPPING 1" X 3" APRON PAINT GRADE WOOD WRB

SEE SHEET A-505 FOR WINDOW INSTALLATION SEQUENCE (A5) SILL @ FC SIDING 3" = 1'-0"

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MARK DATE DESCRIPTION REVISIONS HUD SUBMITTAL В MARK DATE DESCRIPTION **ISSUE INFORMATION** 2017033.00 PROJECT NO .: GGLO PRINCIPAL IN CHARGE: GGLO PROJECT MANAGER: SCOTT SCHREFFLER OWNER APPROVAL: SHEET TITLE

WINDOW DETAILS

SHEET NO.


A-540

8487 REGISTERED ARCHITECT

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PROJECT:

EHA BAKER HEIGHTS

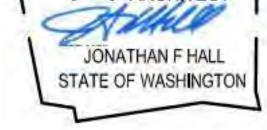

PROJECT ADDRESS:


BUILDING A: 2710 14th STREET BUILDING B: 2715 15th STREET BUILDING C: 2815 15th STREET BUILDING D: 2810 14th STREET **EVERETT, WA 98201**

OWNER: EVERETT HOUSING LEGACY LLLP

2916 SOUTH MCCLELLAN STREET
SEATTLE, WA 98144


C 06/22/2020 BUILDING PERMIT SUBMITTAL / 04/10/2020 DESIGN DEVELOPMENT A 01/07/2020 SCHEMATIC DESIGN

JON HALL

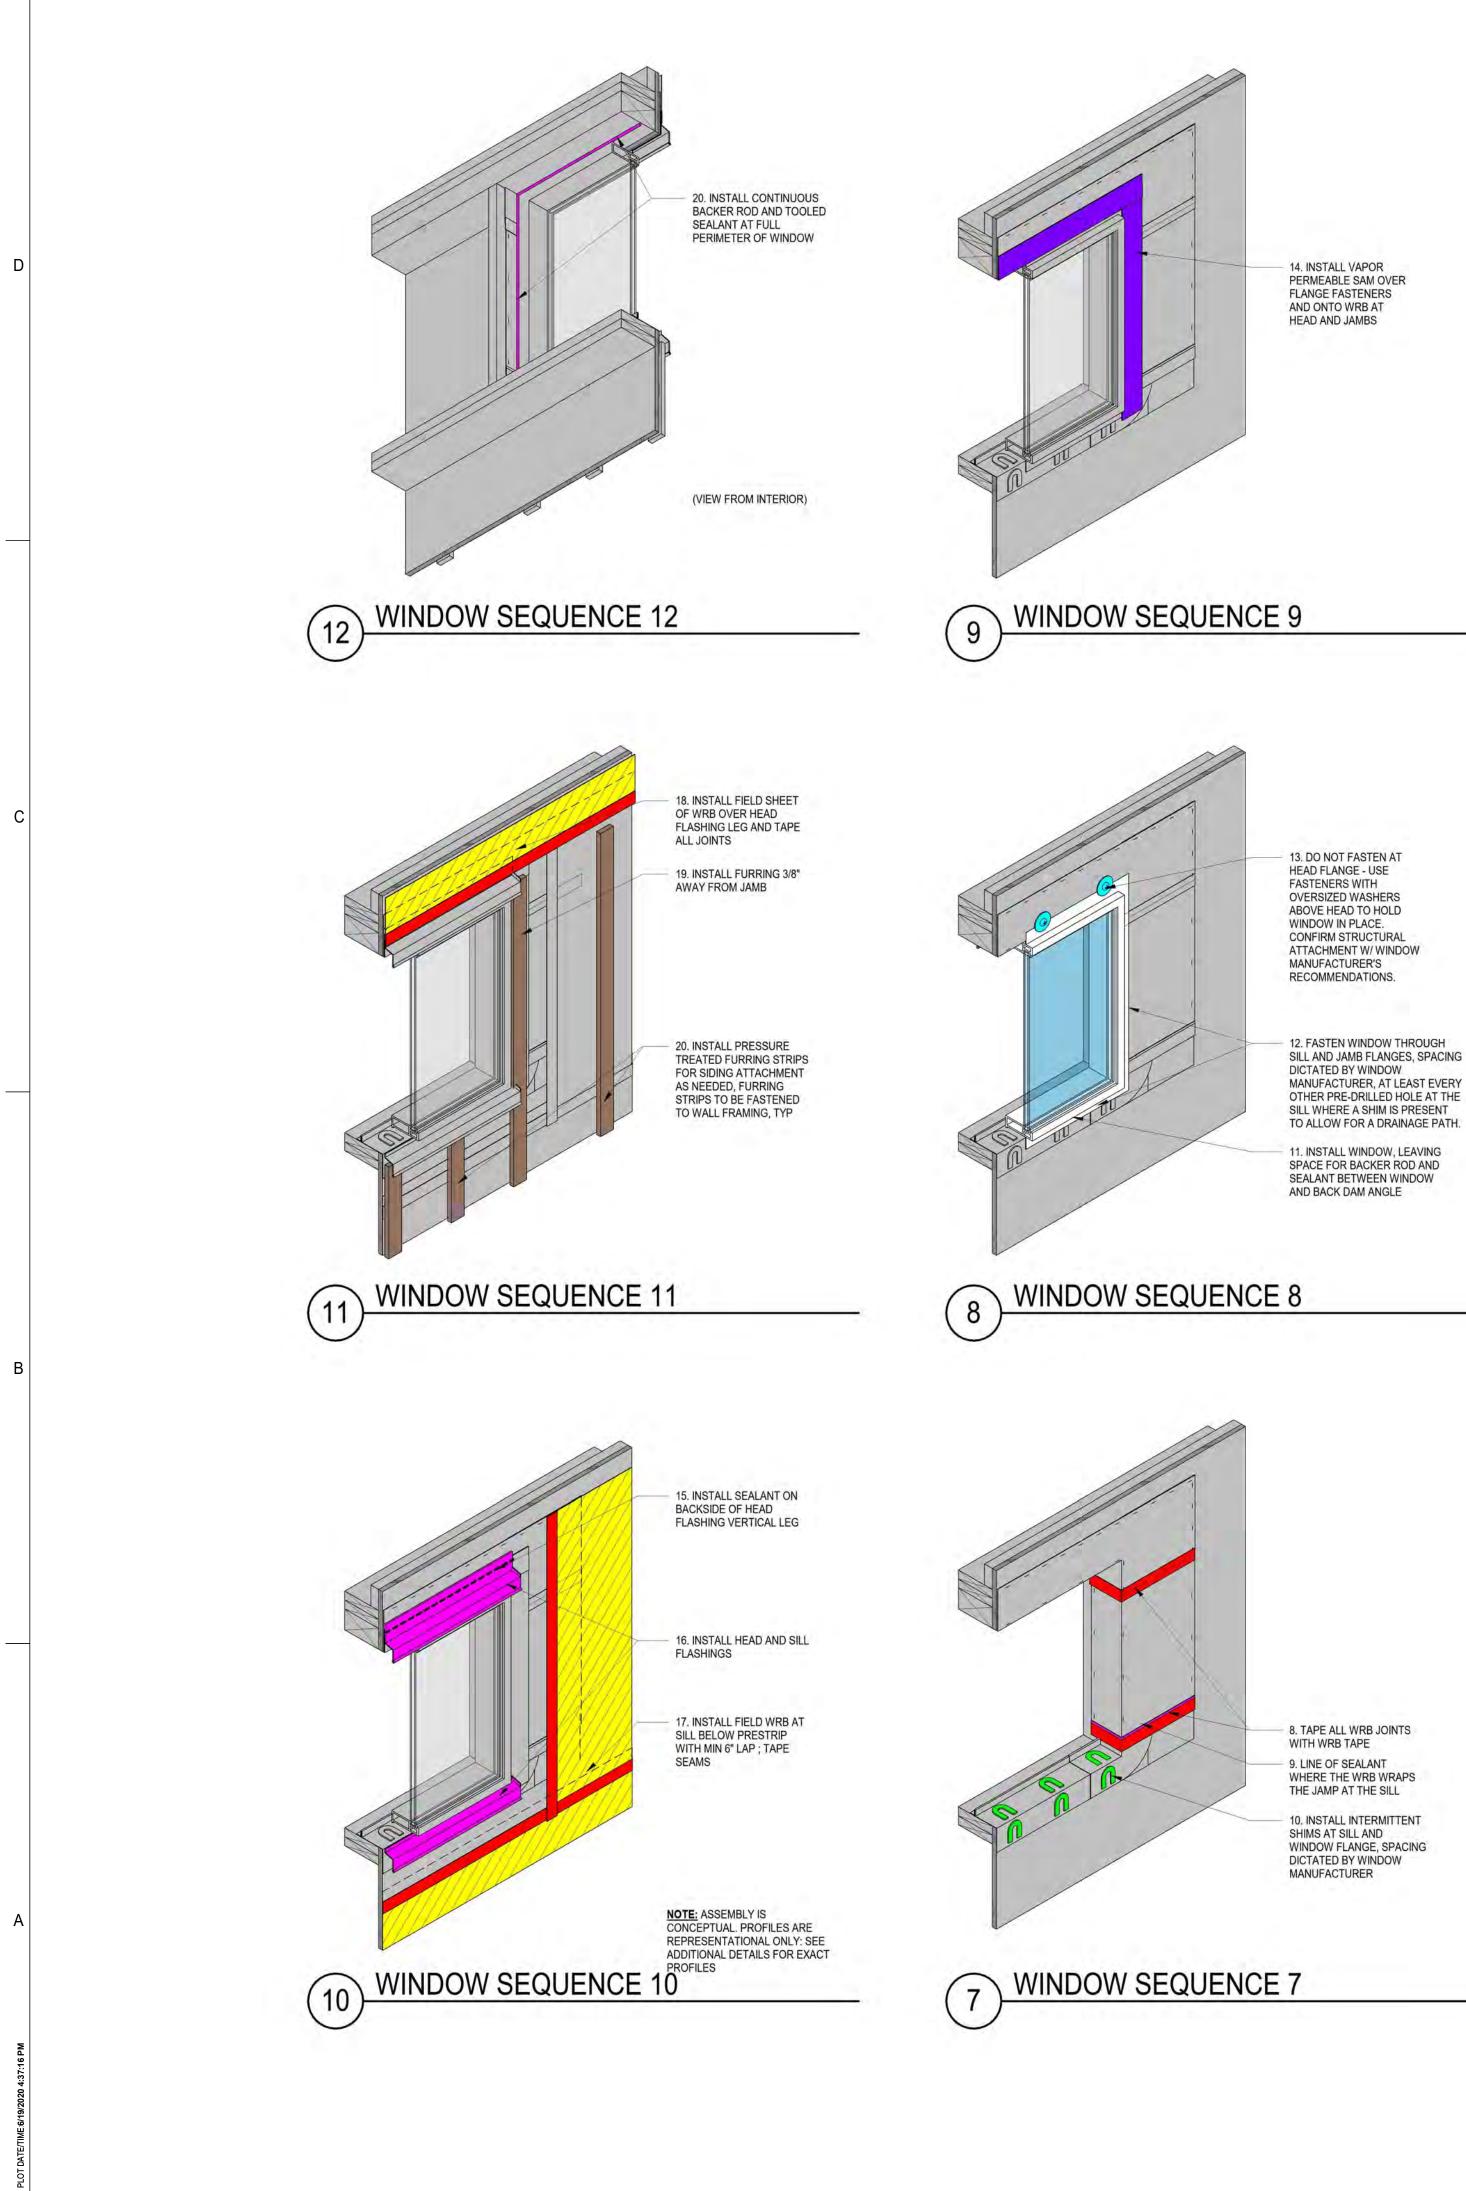


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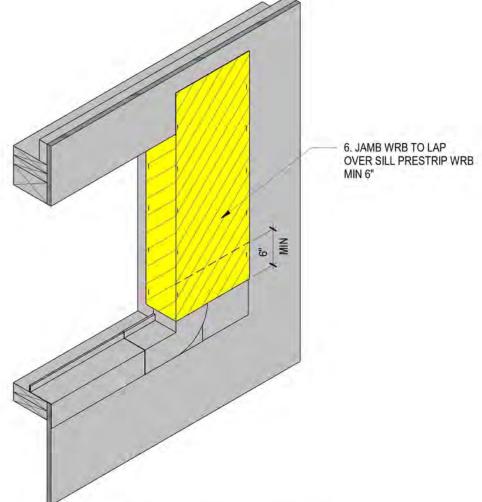
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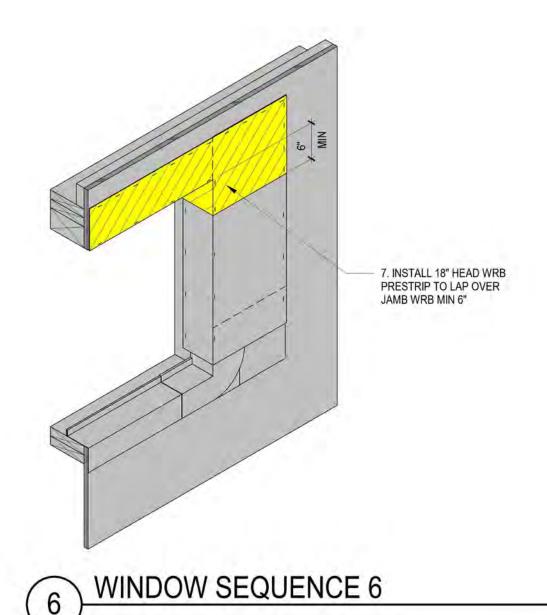


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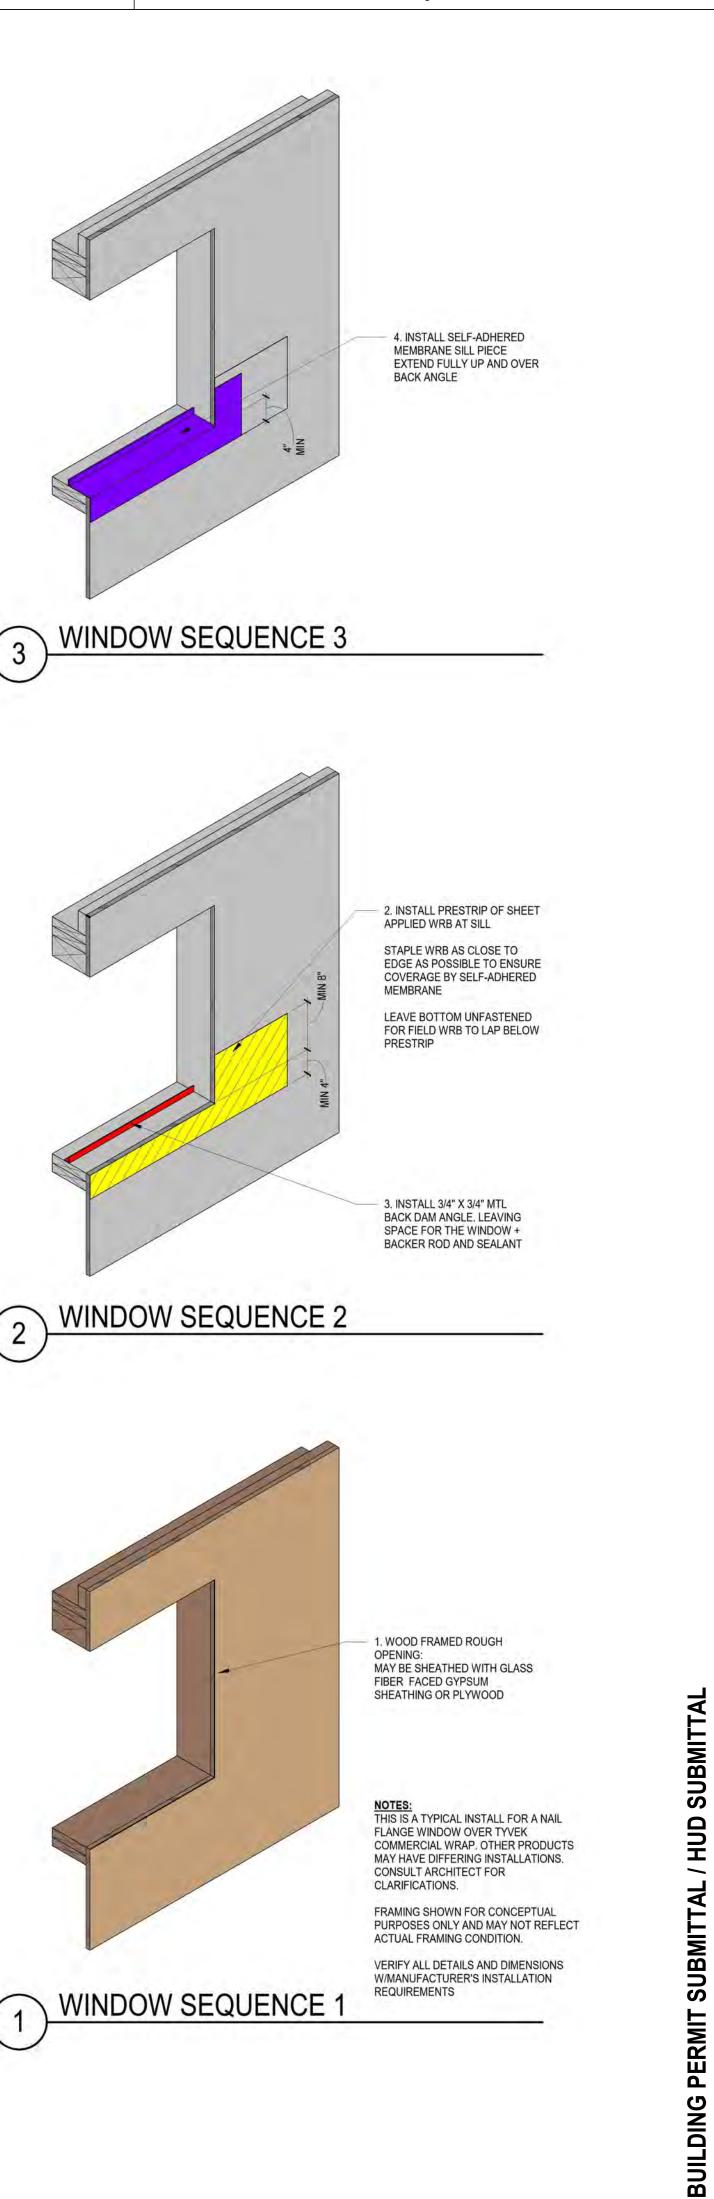


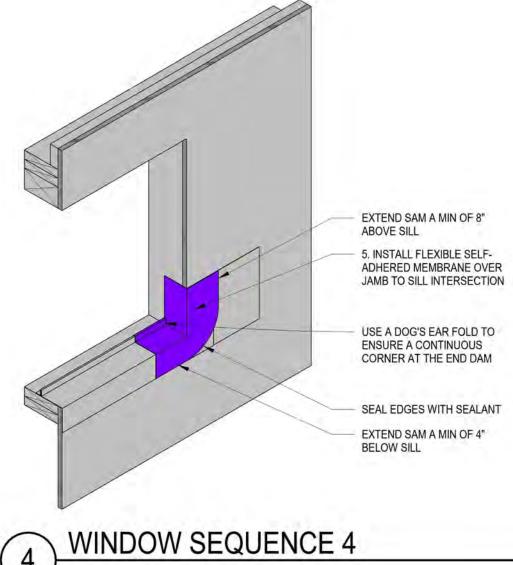12. FASTEN WINDOW THROUGH SILL AND JAMB FLANGES, SPACING



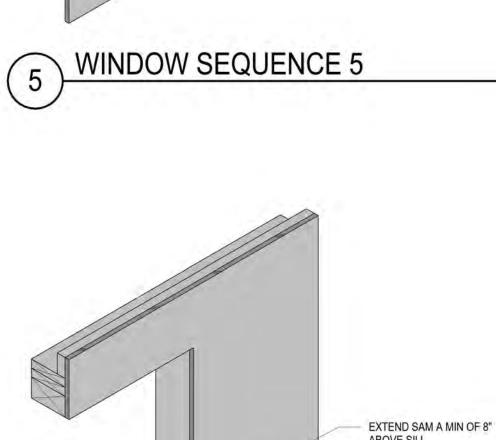

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	A B C B	
1	REGISTERED ARCHITECT JONATHAN F HALL STATE OF WASHINGTON	
PROJE	ct: A BAKER HEIGHTS	
F	EVERET HOUSING AUTHORIT	T Y
OWNEI	D .	
EVEF 2916	RETT HOUSING LEGACY LLLP SOUTH MCCLELLAN STREET TLE, WA 98144	
EVEF 2916	RETT HOUSING LEGACY LLLP SOUTH MCCLELLAN STREET	
EVEF 2916 SEAT	RETT HOUSING LEGACY LLLP SOUTH MCCLELLAN STREET TLE, WA 98144	
EVEF 2916 SEAT	RETT HOUSING LEGACY LLLP SOUTH MCCLELLAN STREET TLE, WA 98144	
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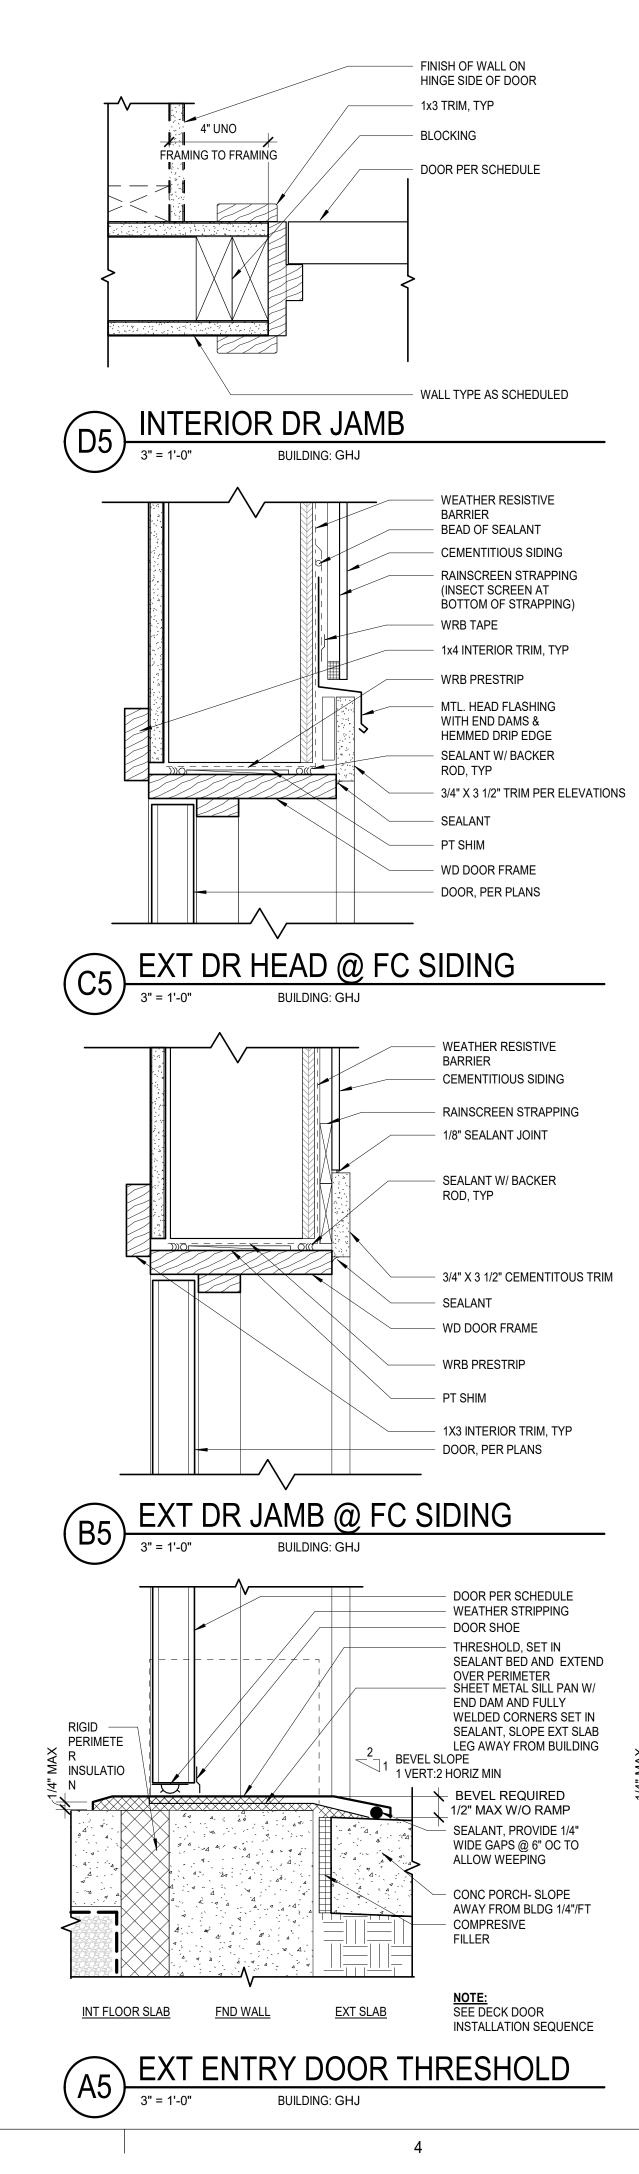
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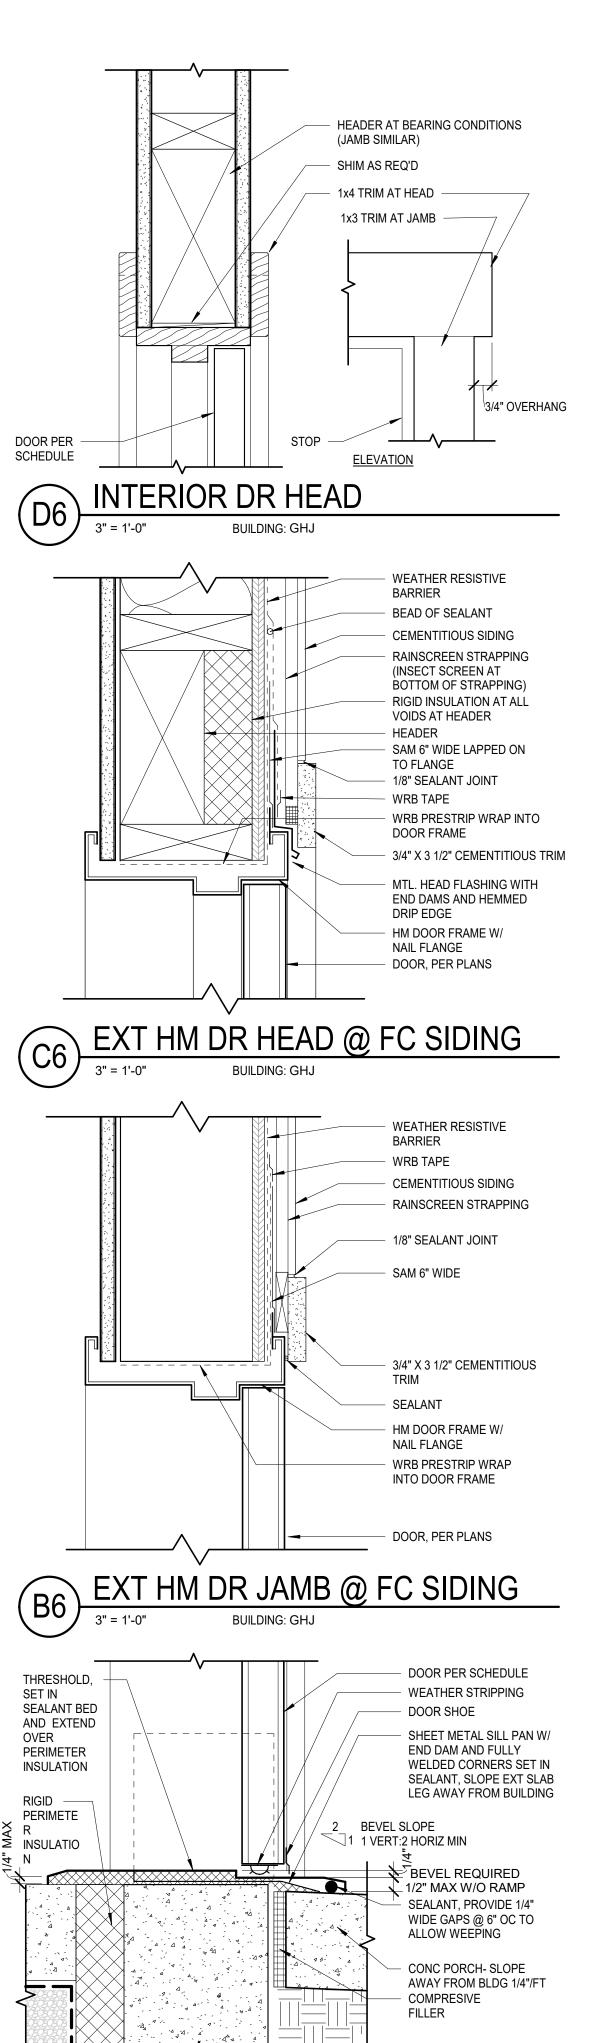
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<u>NOTE:</u> SEE DECK DOOR INSTALLATION SEQUENCE

FND WALL

EXT DOOR THRESHOLD

BUILDING: GHJ

EXT SLAB

5

INT FLOOR SLAB

3" = 1'-0"

(A6)

UILDING PERMIT SUBMITTAL / HUD SUBMITTAL

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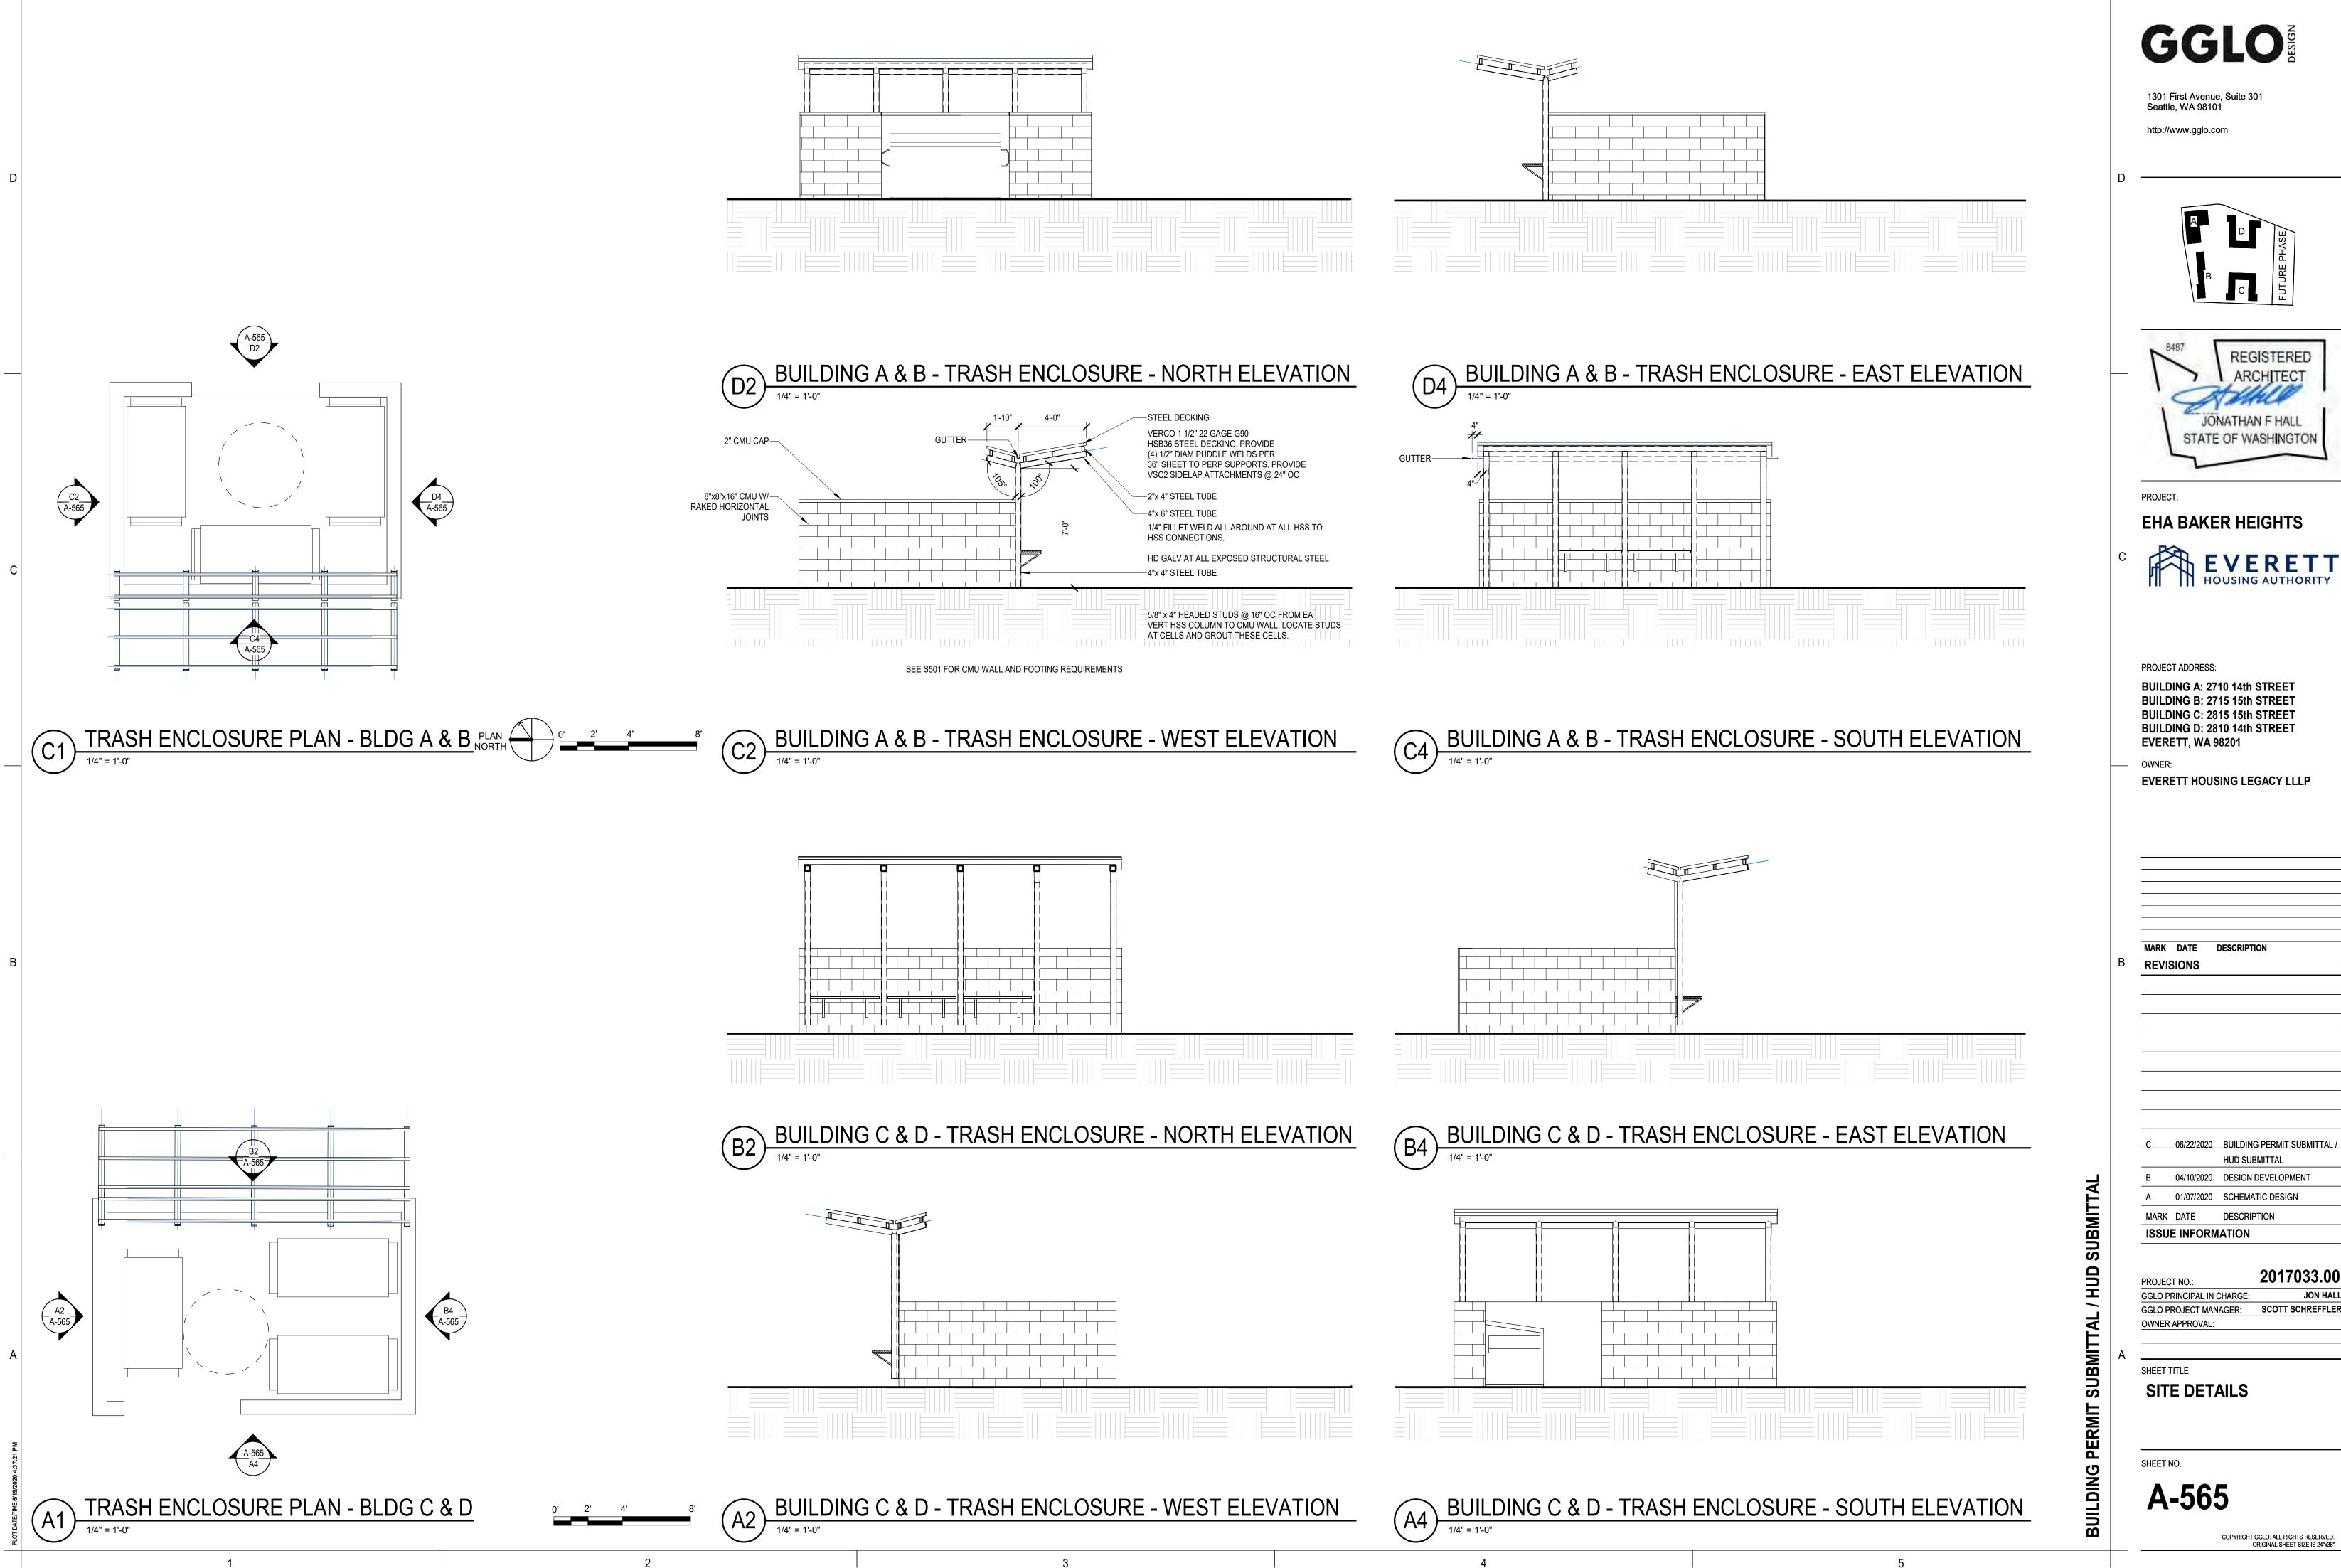
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BUIL BUIL	DING C: 28	15 15th STREET 15 15th STREET 10 14th STREET 98201
ownei EVEF		SING LEGACY LLLP
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Seattle, WA 98101

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WALL ASSEMBLIES - CONCRETE\CMU SEE EXTERIOR ELEVATIONS FOR LOCATION AND EXTENT OF EXTERIOR FINISHES

DESC	MARK	ASSEMBLY		FIRE RATING	SOUND RATING	ENERGY RATING
CAST-IN-PLACE CONCRETE	A01		FINISH AS SHOWN ON ELEVATIONS REINFORCED CAST-IN-PLACE CONCRETE FURRING - SEE FLOOR PLANS FOR LOCATION AND TYPE	NON-RATED	57 STC	N/A
				TEST SOURCE: N/A	TEST SOURCE: RAL TL 76-77 1977	TEST SOURCE: N/A

WALL ASSEMBLIES - INTERIOR WOOD FRAMED

SEE EXTERIOR ELI	EVATIONS FOR LOCA	ATION AND EXTENT OF EXTERIOR FINISHE	S			1
DESC	MARK		ASSEMBLY	FIRE RATING	SOUND RATING	ENERGY RATING
INTERIOR WOOD WALL	E01		(1) LAYER 5/8" TYPE "X" GYPSUM BOARD PLYWOOD SHEATHING WHERE REQ'D BY STRUCTURAL 2X4 WOOD STUD (1) LAYER 5/8" TYPE "X" GYPSUM BOARD <u>NOTE</u> : PROVIDE MIN 3-1/2" SOUND ATTENUATION	NON-RATED TEST SOURCE: N/A	N/A TEST SOURCE: N/A	N/A TEST SOURCE: N/A
INTERIOR WOOD WALL	E02		(1) LAYER 5/8" TYPE "X" GYPSUM BOARD PLYWOOD SHEATHING WHERE REQ'D BY STRUCTURAL 2X6 WOOD STUD	NON-RATED	N/A	N/A
			(1) LAYER 5/8" TYPE "X" GYPSUM BOARD <u>NOTE</u> : PROVIDE MIN 3-1/2" SOUND ATTENUATION BLANKETS IN BATHROOM AND BEDROOM PARTITIONS	TEST SOURCE: N/A	TEST SOURCE: N/A	TEST SOURCE: N/A
INTERIOR WOOD WALL	E03		(1) LAYER 5/8" TYPE "X" GYPSUM BOARD PLYWOOD SHEATHING WHERE REQ'D BY STRUCTURAL 2X8 WOOD STUD (1) LAYER 5/8" TYPE "X" GYPSUM BOARD	NON-RATED	N/A	N/A
			NOTE: PROVIDE MIN 3-1/2" SOUND ATTENUATION BLANKETS IN BATHROOM AND BEDROOM PARTITIONS	TEST SOURCE: N/A	TEST SOURCE: N/A	TEST SOURCE: N/A
INTERIOR WOOD WALL - 1HR	E11		(1) LAYER 5/8" TYPE "X" GYPSUM BOARD PLYWOOD SHEATHING WHERE REQ'D BY STRUCTURAL 2X4 WOOD STUD (1) LAYER 5/8" TYPE "X" GYPSUM BOARD	1-HR	N/A	N/A
			NOTE: PROVIDE MIN 3-1/2" SOUND ATTENUATION BLANKETS IN BATHROOM AND BEDROOM PARTITIONS	TEST SOURCE: GA FILE NO. WP 3660	TEST SOURCE: N/A	TEST SOURCE: N/A
INTERIOR WOOD WALL - 1HR	E12		(1) LAYER 5/8" TYPE "X" GYPSUM BOARD PLYWOOD SHEATHING WHERE REQ'D BY STRUCTURAL 2X6 WOOD STUD (1) LAYER 5/8" TYPE "X" GYPSUM BOARD	1-HR TEST SOURCE:	N/A TEST SOURCE:	N/A TEST SOURCE:
INTERIOR WOOD			NOTE: PROVIDE MIN 3-1/2" SOUND ATTENUATION BLANKETS IN BATHROOM AND BEDROOM PARTITIONS (1) LAYER 5/8" TYPE "X" GYPSUM BOARD	GA FILE NO. WP 3660	N/A	N/A
WALL - 1HR	E13	UTILITY ROOM UNIT	2X6 WOOD STUD R-21 GLASS-FIBER-BLANKET INSULATION (1) LAYER 5/8" TYPE "X" GYPSUM BOARD PVA PRIMER FOR VAPOR RETARDER	1-HR TEST SOURCE: GA FILE NO. WP 3660	N/A TEST SOURCE: N/A	N/A TEST SOURCE: N/A
INTERIOR WOOD WALL - 2HR	E21		(2) LAYERS 5/8" TYPE "X" GYPSUM BOARD 2X4 WOOD STUD 5 1/2" MINERAL FIBER INSULATION (2) LAYERS 5/8" TYPE "X" GYPSUM BOARD	2-HR TEST SOURCE: GA FILE NO. WP 4230	N/A TEST SOURCE: N/A	N/A TEST SOURCE: N/A
INTERIOR WOOD WALL - 2HR	E22		(2) LAYERS 5/8" TYPE "X" GYPSUM BOARD 2X6 WOOD STUD 5 1/2" MINERAL FIBER INSULATION (2) LAYERS 5/8" TYPE "X" GYPSUM BOARD	2-HR TEST SOURCE: GA FILE NO. WP 4230	N/A TEST SOURCE: N/A	N/A TEST SOURCE: N/A
INTERIOR DEMISING WALL 1HR	E40		 (1) LAYER 5/8" TYPE "X" GYPSUM BOARD PLYWOOD SHEATHING WHERE REQUIRED BY STRUCTURAL 2X4 WOOD STUD FRAMING 3-1/2" SOUND ATTENUATION BLANKETS 1" AIRSPACE 3-1/2" SOUND ATTENUATION BLANKETS 2X4 WOOD STUD FRAMING PLYWOOD SHEATHING WHERE REQUIRED BY STRUCTURAL (1) LAYER 5/8" TYPE "X" GYPSUM BOARD 	1-HR TEST SOURCE: U341	55 STC TEST SOURCE: NRCC-TL-93-261	N/A TEST SOURCE: N/A
INT WOOD 2X6/2X4 STUD - 1 HR - UNIT / CORRIDOR AT BLDG A (TYPE VA)	E90		 (1) LAYER 5/8" TYPE "X" GYP BD PLYWOOD SHEATHING WHERE REQ'D BY STRUCTURAL 2x6 WOOD STUDS 1/2" AIR SPACE 3-1/2" SOUND ATTENUATION BLANKETS 2x4 WOOD STUDS (1) LAYER 5/8" TYPE "X" GYP BD 	1-HR TEST SOURCE: GA FILE NO. WP-3370	STC 55 TEST SOURCE: NRCC TL-93-250	TEST SOURCE:
INT WOOD 2X8/2X4 STUD - 1 HR - UNIT / CORRIDOR	E91		 (1) LAYER 5/8" TYPE "X" GYP BD PLYWOOD SHEATHING WHERE REQ'D BY STRUCTURAL 2x8 WOOD STUDS 1/2" AIR SPACE 3-1/2" SOUND ATTENUATION BLANKETS 2x4 WOOD STUDS (1) LAYER 5/8" TYPE "X" GYP BD 	1-HR TEST SOURCE: GA FILE NO. WP-3370	STC 55 TEST SOURCE: NRCC TL-93-250	TEST SOURCE:

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1

WALL ASSEMBLIES - INTERIOR WOOD FRAMED

DESC	MARK	ASSEMBLY		SOUND RATING	ENERGY RATING
INTERIOR WOOD WALL	E93	(1) LAYER 5/8" TYPE "X" GYPSUM BOARD 2X4 WOOD STUD	NON-RATED TEST SOURCE: N/A	N/A TEST SOURCE: N/A	N/A TEST SOURCE: N/A
INTERIOR WOOD WALL	E94	(1) LAYER 5/8" TYPE "X" GYPSUM BOARD 2X6 WOOD STUD	NON-RATED TEST SOURCE: N/A	N/A TEST SOURCE: N/A	N/A TEST SOURCE: N/A

WALL A	ASSEMBI	LIES - EXTERIOR FINISH				
SEE EXTERIOR ELEVATIONS FOR LOCATION AND EXTENT OF EXTERIOR FINISHES						

DESC	MARK		ASSEMBLY		FIRE	SOUND RATING	ENERGY RATING
XTERIOR WOOD /ALL AT BLDG A 'YPE VA)	D02		WEATHER DARKEN EXTERIOR SHEATHING 2X6 WOOD STUDS R-21 GLASS-FIBER-BLANKET INSULATION (1) LAYER 5/8" TYPE "X" GYPSUM BOARD PVA PRIMER FOR VAPOR RETARDER			N/A TEST SOURCE: N/A	R-21 TEST SOURCE: N/A
(TERIOR WOOD ALL AT BLDGS C, D (TYPE VB)	D03	EXTERIOR INTERIOR	WEATHER BARI EXTERIOR SHE 2X6 WOOD STU R-21 GLASS-FIB (1) LAYER 5/8" T	ATHING	NON-RATED TEST SOURCE: N/A	N/A TEST SOURCE: N/A	R-21 TEST SOURCE: N/A
TERIOR WOOD	D04		WEATHER BARI EXTERIOR SHE 2X4 WOOD STU (1) LAYER 5/8" T	ATHING	NON-RATED TEST SOURCE: N/A	N/A TEST SOURCE: N/A	R-21 TEST SOURCE: N/A
TERIOR WOOD	D05		FINISH AS SHOWN ON ELEVATIONS WEATHER BARRIER EXTERIOR SHEATHING 2X6 WOOD STUDS EXTERIOR SHEATHING WEATHER RESISTIVE BARRIER FINISH AS SHOWN ON ELEVATIONS		NON-RATED TEST SOURCE: N/A	N/A TEST SOURCE: N/A	R-21 TEST SOURCE: N/A
TERIOR WOOD 6/2X4 STUD - 1 2 - UNIT / 9RRIDOR AT DGS B, C, D (PE VB)	D06	EXTERIOR CORRIDOR	FINISH AS SHOWN ON ELEVATIONS WEATHER BARRIER PLYWOOD SHEATHING (AS REQ'D BY STRUCTURAL) R-21 GLASS-FIBER-BLANKET INSULATION 2X6 WOOD STUDS 1/2" AIR SPACE 2x4 WOOD STUDS (1) LAYER 5/8" TYPE "X" GYPSUM BOARD PVA PRIMER FOR VAPOR RETARDER		NON-RATED TEST SOURCE: N/A	STC 55 TEST SOURCE: NRCC TL-93-250	TEST SOURCE:
TERIOR WOOD 6/2X8 STUD - 1 ? - UNIT / DRRIDOR AT DGS B, C, D (PE VB)	D07	EXTERIOR CORRIDOR	FINISH AS SHOWN ON ELEVATIONS WEATHER BARRIER PLYWOOD SHEATHING (AS REQ'D BY STRUCTURAL) R-21 GLASS-FIBER-BLANKET INSULATION 2X8 WOOD STUDS 1/2" AIR SPACE 2x6 WOOD STUDS (1) LAYER 5/8" TYPE "X" GYPSUM BOARD PVA PRIMER FOR VAPOR RETARDER		NON-RATED TEST SOURCE: N/A	STC 55 TEST SOURCE: NRCC TL-93-250	R-21 TEST SOURCE:
(TERIOR WOOD 8/2X4 STUD - 1 R - UNIT / DRRIDOR AT DGS B, C, D YPE VB)	D08	EXTERIOR CORRIDOR	WEATHER BARI PLYWOOD SHE R-21 GLASS-FIB 2X8 WOOD STU 1/2" AIR SPACE 2x4 WOOD STU (1) LAYER 5/8" T	ATHING (AS REQ'D BY STRUCTURAL) ER-BLANKET INSULATION DS	NON-RATED TEST SOURCE: N/A	STC 55 TEST SOURCE: NRCC TL-93-250	R-21 TEST SOURCE:
ı							
B EX C IN D EX E IN <u>FINISH WALL</u> G EX H IN	DNCRETE OR CMU WALLS (TERIOR METAL STUD WA TERIOR METAL STUD WA (TERIOR WOOD STUD WA TERIOR WOOD STUD WA	ALLS LLS ALLS ALLS ALLS ALLS ALLS ALS AL	REMENTS JIRED AT THE 3: FIXTURES L FIXTURES AND COUNTERS E MOUNTED TO LL-MOUNTED OR D EQUIPMENT	 INSULATE HOT AND COLD WATER MIN INSULATE HOT WATER PIPES PER LESS THAN 2" IN DIA SEE WSEC TABLE 5-12 FOR ALL OT 1 1/2" ACOUSTIC BATT INSULATION AT WALLS AND CEILINGS, INSTALL ADJACENT FINISHES TO PRODUCE ARCHTECT'S APPROVAL, ADJACEN INSTEAD OF FINISHED FLUSH. 	WSEC SECTION 503.11 - 1 HER APPLICATIONS WRAP AT ALL DRAIN PIPE FURRING OR ADDITIONAL	' MIN FOR NON-CIRCL S LAYERS OF GWB WH	ILATING WATER PIF ERE REQ'D TO ALIO GMENT. ON

G H	EXTERIOR FINISH WALLS
<u>CEILIN</u>	<u>GS, FLOORS & ROOFS</u>
F R J	FLOOR - CEILINGS ROOF - CEILINGS CEILINGS

3

CEMENT BACKER BOARD TO BE USED IN PLACE OF GYP BD AT ALL

4

WET LOCATIONS

5

8. FOR WOOD WALL ASSEMBLIES ON CONC FLOORS, BOTTOM PLATE MUST BE TREATED WOOD. 9. SEE SHEET A-560 THROUGH A-563 FOR DETAILED FIRE RATING INFORMATION.

HUD SUBMITTA $\overline{}$ ┫ SUBMIT **BUILDING PERMIT**

	В	D	FUTURE PHASE
٢		AR	SISTERED CHITECT N F HALL ASHINGTON
PROJ			
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WALL ASSEMBLIES - INTERIOR FINISH

SEE EXTERIOR ELEVATIONS FOR LOCATION AND EXTENT OF EXTERIOR FINISHES					
DESC	MARK		ASSEMBLY		
WOOD STUD FURRING	H20		WALL PER PLANS 1" AIR SPACE AS REQUIRED 2X4 WOOD STUD (1) LAYER 5/8" TYPE "X" GYPSUM E PVA PRIMER FOR VAPOR RETARE		
WOOD STUD FURRING	H21		WALL PER PLANS 1" AIR SPACE AS REQUIRED 2X6 WOOD STUD R-21 GLASS-FIBER-BLANKET INSU (1) LAYER 5/8" TYPE "X" GYPSUM B PVA PRIMER FOR VAPOR RETARE		
WOOD STUD FURRING	H22		WALL PER PLANS 1" AIR SPACE AS REQUIRED 2X4 WOOD STUD R-13 BATT INSULATION (1) LAYER 5/8" TYPE "X" GYPSUM E PVA PRIMER FOR VAPOR RETARD		

WALL ASSEMBLIES - INTERIOR METAL SEE EXTERIOR ELEVATIONS FOR LOCATION AND EXTENT OF EXTERIOR FINISHES

DESC	MARK		ASSEMBLY	FIRE RATING	SOUND RATING	ENERGY RATING
METAL CH STUD SHAFT - 2HR, INSULATED	C53	CONDITIONED	(2) LAYERS TYPE "X" GYPSUM BOARD 2 1/2" METAL CH STUD R-11 GLASS-FIBER-BLANKET INSULATION 1" GYPSUM LINER PANEL	2-HR TEST SOURCE: UL U415 SYSTEM B	39 STC TEST SOURCE: USG-040901	N/A TEST SOURCE: N/A

MARK KEY		GENERAL NOTES				
CORE WALLS A CONCRETE OR CMU WALLS	1.	SEE TEST REPORTS FOR ADDITIONAL REQUIREMENTS	4.	INSULATE HO		
 B EXTERIOR METAL STUD WALLS C INTERIOR METAL STUD WALLS D EXTERIOR WOOD STUD WALLS 	2.	BLOCKING IS REQUIRED AT THE FOLLOWING AREAS: A. PLUMBING FIXTURES	5.	INSULATE HOLESS THAN 2		
E INTERIOR WOOD STUD WALLS		B. ELECTRICAL FIXTURES C. CABINETS AND COUNTERS		SEE WSEC T		
FINISH WALLS		D. WOOD BASE E. HANDRAILS MOUNTED TO	6.	1 1/2" ACOUS		
G EXTERIOR FINISH WALLS H INTERIOR FINISH WALLS		WALL F. OTHER WALL-MOUNTED OR SUPPORTED EQUIPMENT AND FIXTURES	7.	AT WALLS AI ADJACENT F ARCHTECT'S INSTEAD OF		
CEILINGS, FLOORS & ROOFS						
F FLOOR - CEILINGS R ROOF - CEILINGS J CEILINGS	3.	CEMENT BACKER BOARD TO BE USED IN PLACE OF GYP BD AT ALL WET LOCATIONS	8. 9.	FOR WOOD		

4

2

	5	
FIRE RATING	SOUND RATING	ENERGY RATING

	NOT-RATED	N/A	N/A
M BOARD ARDER	TEST SOURCE: N/A	TEST SOURCE: N/A	TEST SOURCE: N/A
	NOT-RATED	N/A	N/A
ISULATION M BOARD ARDER	TEST SOURCE: N/A	TEST SOURCE: N/A	TEST SOURCE: N/A
	NOT-RATED	N/A	N/A
M BOARD ARDER	TEST SOURCE: N/A	TEST SOURCE: N/A	TEST SOURCE: N/A

HOT AND COLD WATER PIPES IN EXTERIOR WALLS AND UNCONDITIONED SPACES TO R-3

HOT WATER PIPES PER WSEC SECTION 503.11 - 1" MIN FOR NON-CIRCULATING WATER PIPES IN 2" IN DIA

C TABLE 5-12 FOR ALL OTHER APPLICATIONS

OUSTIC BATT INSULATION WRAP AT ALL DRAIN PIPES

S AND CEILINGS, INSTALL FURRING OR ADDITIONAL LAYERS OF GWB WHERE REQ'D TO ALIGN T FINISHES TO PRODUCE A CONTINUOUS SURFACE FOR EACH FULL SEGMENT. ON CT'S APPROVAL, ADJACENT SURFACES MAY BE OFFSET BY A MINIMUM OF 2" ACTUAL DIM OF FINISHED FLUSH.

D WALL ASSEMBLIES ON CONC FLOORS, BOTTOM PLATE MUST BE TREATED WOOD. T A-560 THROUGH A-563 FOR DETAILED FIRE RATING INFORMATION.

GGLO 1301 First Avenue, Suite 301 Seattle, WA 98101 http://www.gglo.com 8487 REGISTERED ARCHITECT JONATHAN F HALL STATE OF WASHINGTON PROJECT: EHA BAKER HEIGHTS **EVERETT** HOUSING AUTHORITY PROJECT ADDRESS: BUILDING A: 2710 14th STREET BUILDING B: 2715 15th STREET BUILDING C: 2815 15th STREET BUILDING D: 2810 14th STREET **EVERETT, WA 98201** OWNER: EVERETT HOUSING LEGACY LLLP MARK DATE DESCRIPTION REVISIONS В -----_C 06/22/2020 BUILDING PERMIT SUBMITTAL /_ HUD SUBMITTAL B 04/10/2020 DESIGN DEVELOPMENT A 01/07/2020 SCHEMATIC DESIGN MARK DATE DESCRIPTION **ISSUE INFORMATION** 2017033.00 PROJECT NO .: GGLO PRINCIPAL IN CHARGE: JON HALL GGLO PROJECT MANAGER: SCOTT SCHREFFLER OWNER APPROVAL: SHEET TITLE

BUILDING PERMIT SUBMITTAL / HUD SUBMIT

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WALL ASSEMBLIES

SHEET NO.

A-606

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