


EVERETT HOUSING AUTHORITY

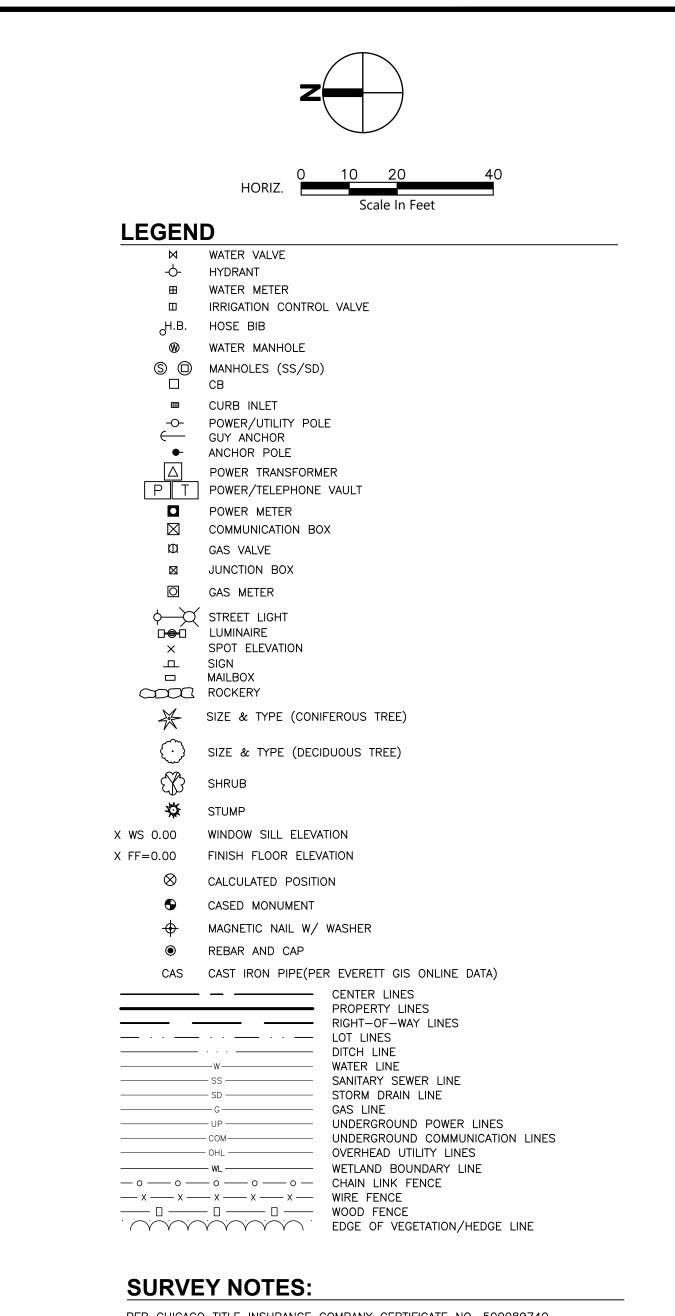


PER CHICAGO TITLE INSURANCE COMPANY CERTIFICATE NO. 500089740 DATE: AUGUST 19, 2019 AT 8:00 AM

- 9 CITY OF EVERETT, SANITARY SEWER AND WATER MAINS REC. NO. 8506210151
- (23) WASHINGTON NATURAL GAS COMPANY RECORDING NO. 1242949

EASEMENT NOTE:

PER CHICAGO TITLE INSURANCE COMPANY CERTIFICATE NO. 500089740 DATE: AUGUST 19, 2019 AT 8:00 AM

15 PUBLIC UTILITY DISTRICT NO. 1 OF SNOHOMISH COUNTY AND VERIZON NORTHWEST REC. NO. 200609140228 AN EASEMENT 10 FEET IN WIDTH, 5 FEET ON EACH SIDE OF THE CENTERLINE OF THE ELECTRICAL AS ACTUALLY INSTALLED.

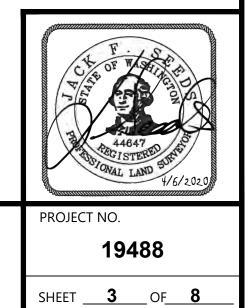

PORTION OF: NE1/4, SECTION 17, T. 29N., R. 5E., W.M. PORTION OF: SE1/4, SECTION 17, T. 29N., R. 5E., W.M.

TOPOGRAPHIC SURVEY FOR **EVERETT HOUSING AUTHORITY**

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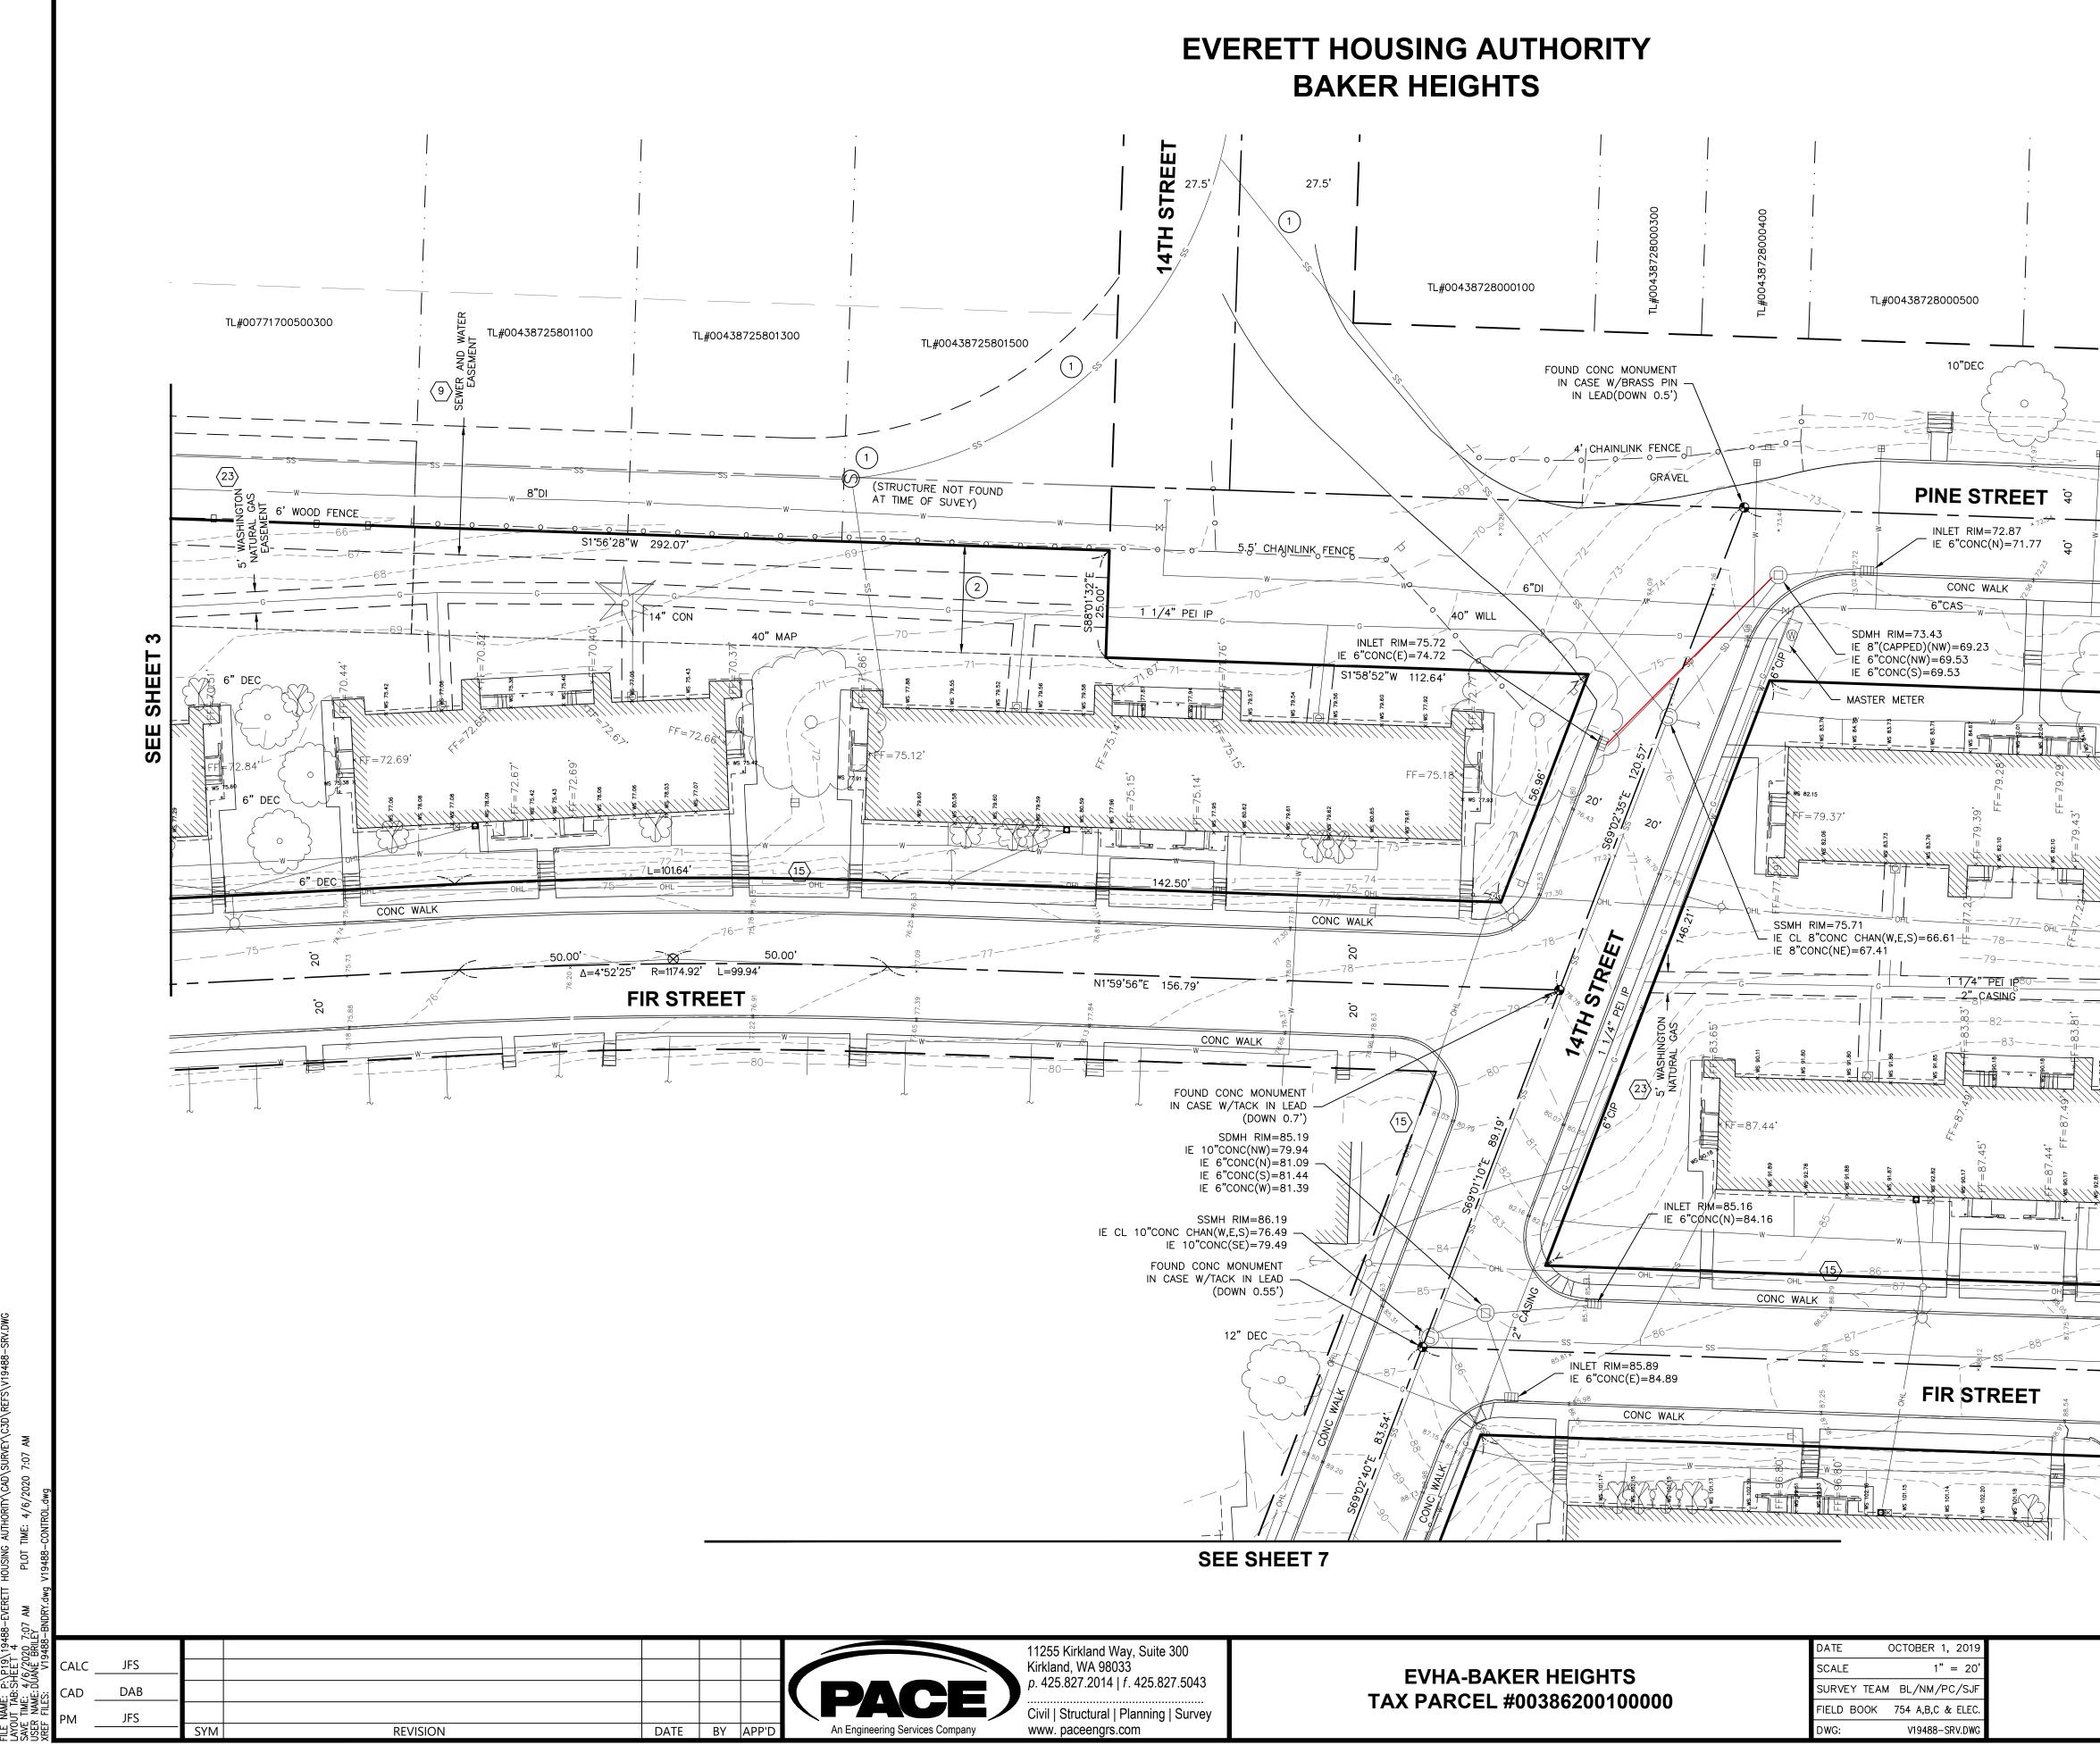
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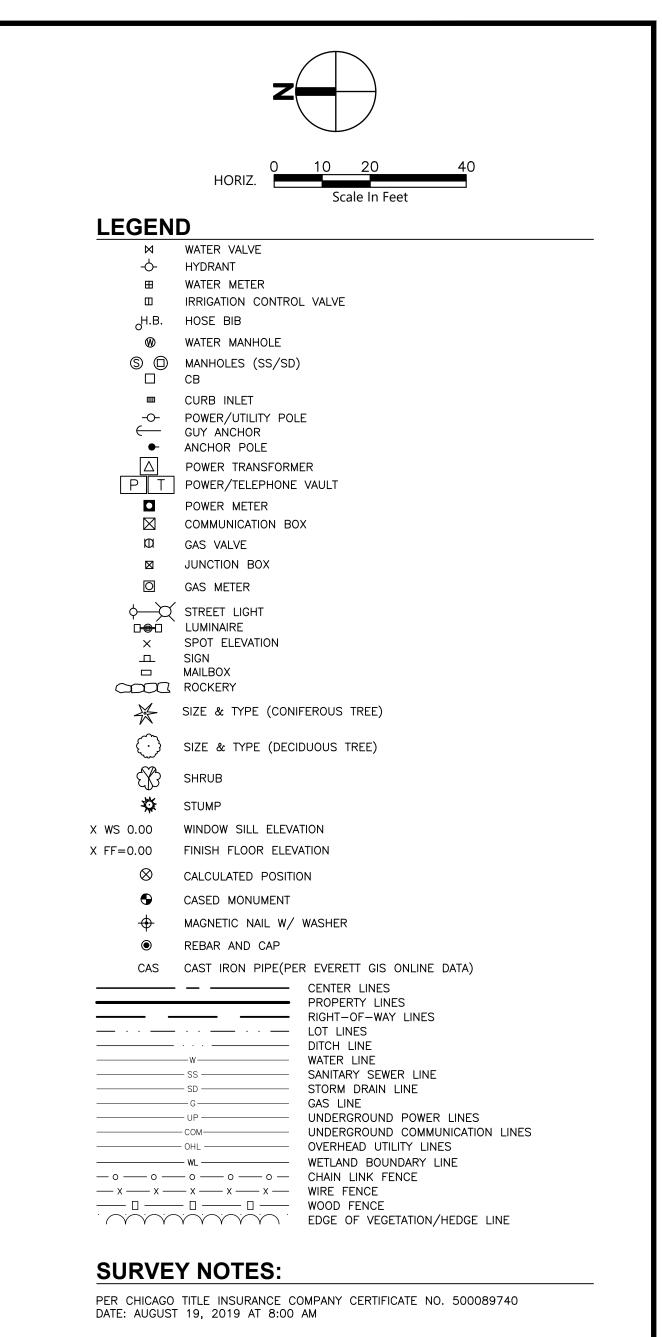
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11255 Kirkland Way, Suite 300 Kirkland, WA 98033		DATE SCALE	OCTOBER 1, 2019 1" = 20'	
<i>p</i> . 425.827.2014 <i>f</i> . 425.827.5043	TAX PARCEL #00386200100000		BL/NM/PC/SJF	
Civil Structural Planning Survey www.paceengrs.com		FIELD BOOK DWG:	754 A,B,C & ELEC. V19488-SRV.DWG	



- 9 CITY OF EVERETT, SANITARY SEWER AND WATER MAINS REC. NO. 8506210151
- (23) WASHINGTON NATURAL GAS COMPANY RECORDING NO. 1242949
- (1) APPROXIMATE LOCATION, PER CITY OF EVERETT ONLINE GIS DATA
- 2 VACATED PORTION OF PINE STREET

EASEMENT NOTE:

PER CHICAGO TITLE INSURANCE COMPANY CERTIFICATE NO. 500089740 DATE: AUGUST 19, 2019 AT 8:00 AM

- (15) PUBLIC UTILITY DISTRICT NO. 1 OF SNOHOMISH COUNTY AND VERIZON NORTHWEST REC. NO. 200609140228
 - AN EASEMENT 10 FEET IN WIDTH, 5 FEET ON EACH SIDE OF THE CENTERLINE OF THE ELECTRICAL AS ACTUALLY INSTALLED.

UTILITY SERVICE NOTE:

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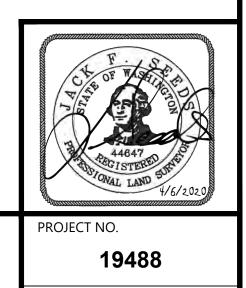
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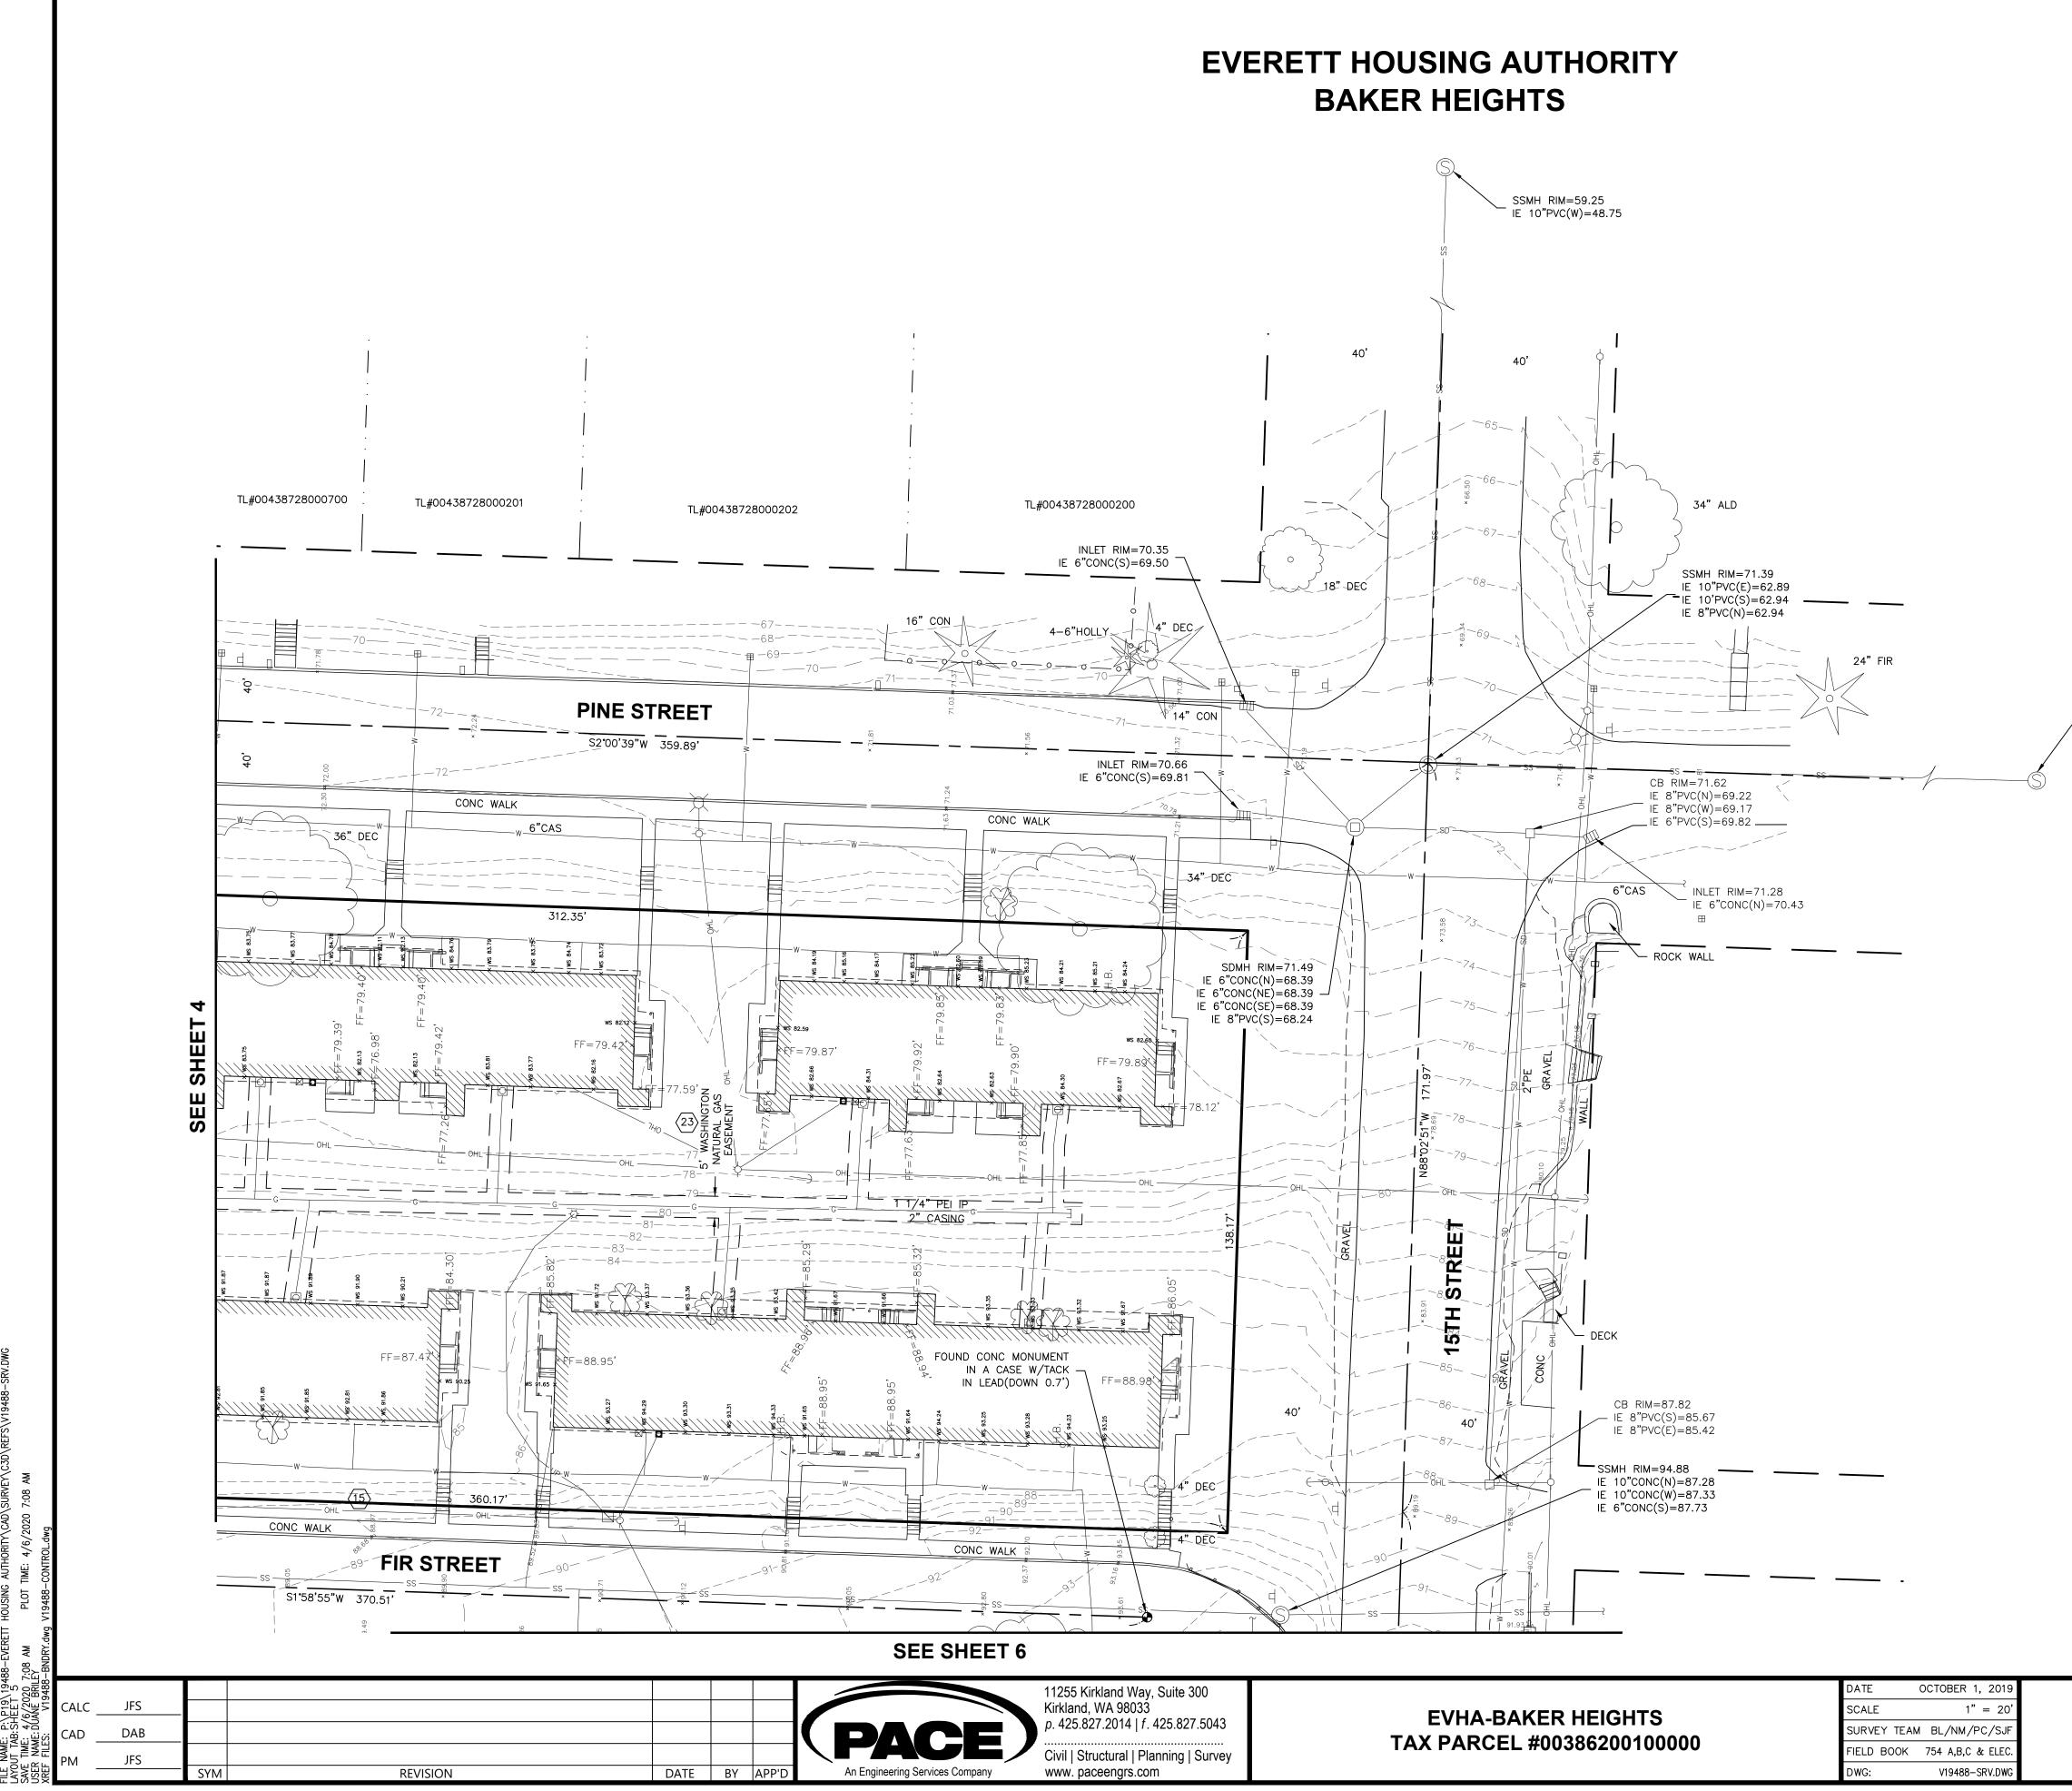
SANITARY SEWER SERVICES ARE BASED ON DATA PROVIDED BY OTHERS AND CITY OF EVERETT ON-LINE GIS DATA. WATER SERVICE METER IS SHOWN AS ONE MASTER METER.

PORTION OF: NE1/4, SECTION 17, T. 29N., R. 5E., W.M. PORTION OF: SE1/4, SECTION 17, T. 29N., R. 5E., W.M.


TOPOGRAPHIC SURVEY FOR **EVERETT HOUSING AUTHORITY**



sheet <u>**4**</u> of <u>**8**</u>



DATE	OCTOBER 1, 2019
SCALE	1" = 20'
SURVEY TEAM	BL/NM/PC/SJF
FIELD BOOK	754 A,B,C & ELEC.
DWG	V19488-SRV.DWG

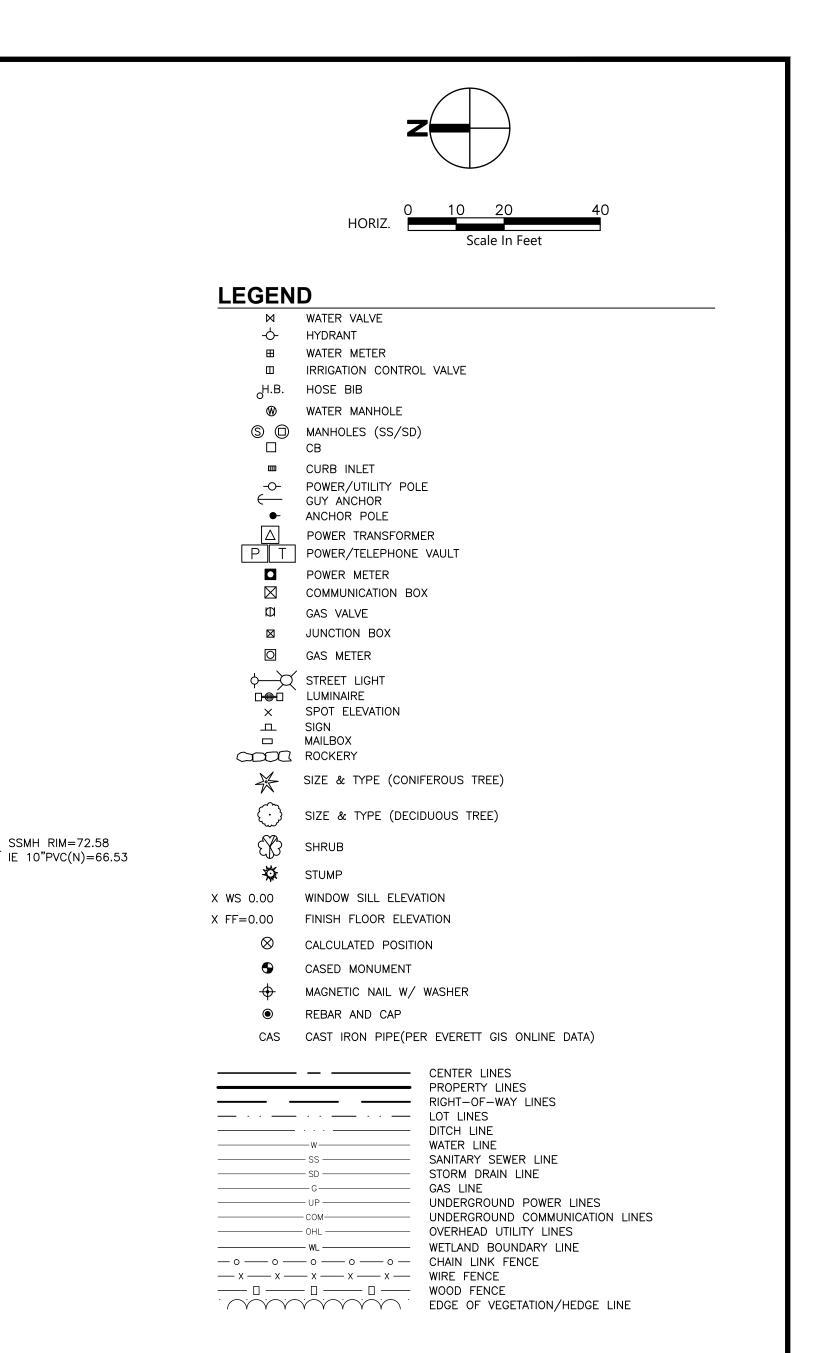

SURVEY NOTES:

PER CHICAGO TITLE INSURANCE COMPANY CERTIFICATE NO. 500089740 DATE: AUGUST 19, 2019 AT 8:00 AM

23 WASHINGTON NATURAL GAS COMPANY RECORDING NO. 1242949

EASEMENT NOTE:

PER CHICAGO TITLE INSURANCE COMPANY CERTIFICATE NO. 500089740 DATE: AUGUST 19, 2019 AT 8:00 AM


PUBLIC UTILITY DISTRICT NO. 1 OF SNOHOMISH COUNTY
AND VERIZON NORTHWEST REC. NO. 200609140228


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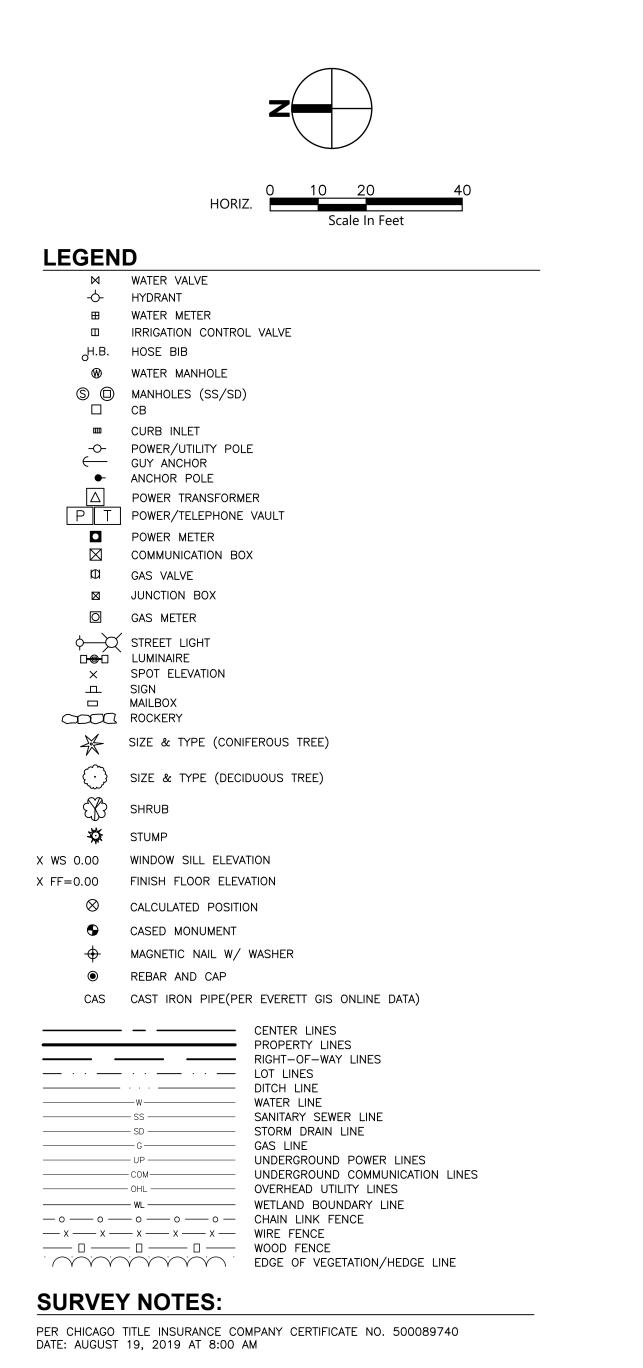






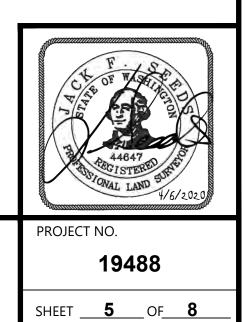

DATE	OCTOBER 1, 2019
SCALE	1" = 20'
SURVEY TEAM	1 BL/NM/PC/SJF
FIELD BOOK	754 A,B,C & ELEC.
DWG:	V19488-SRV.DWG

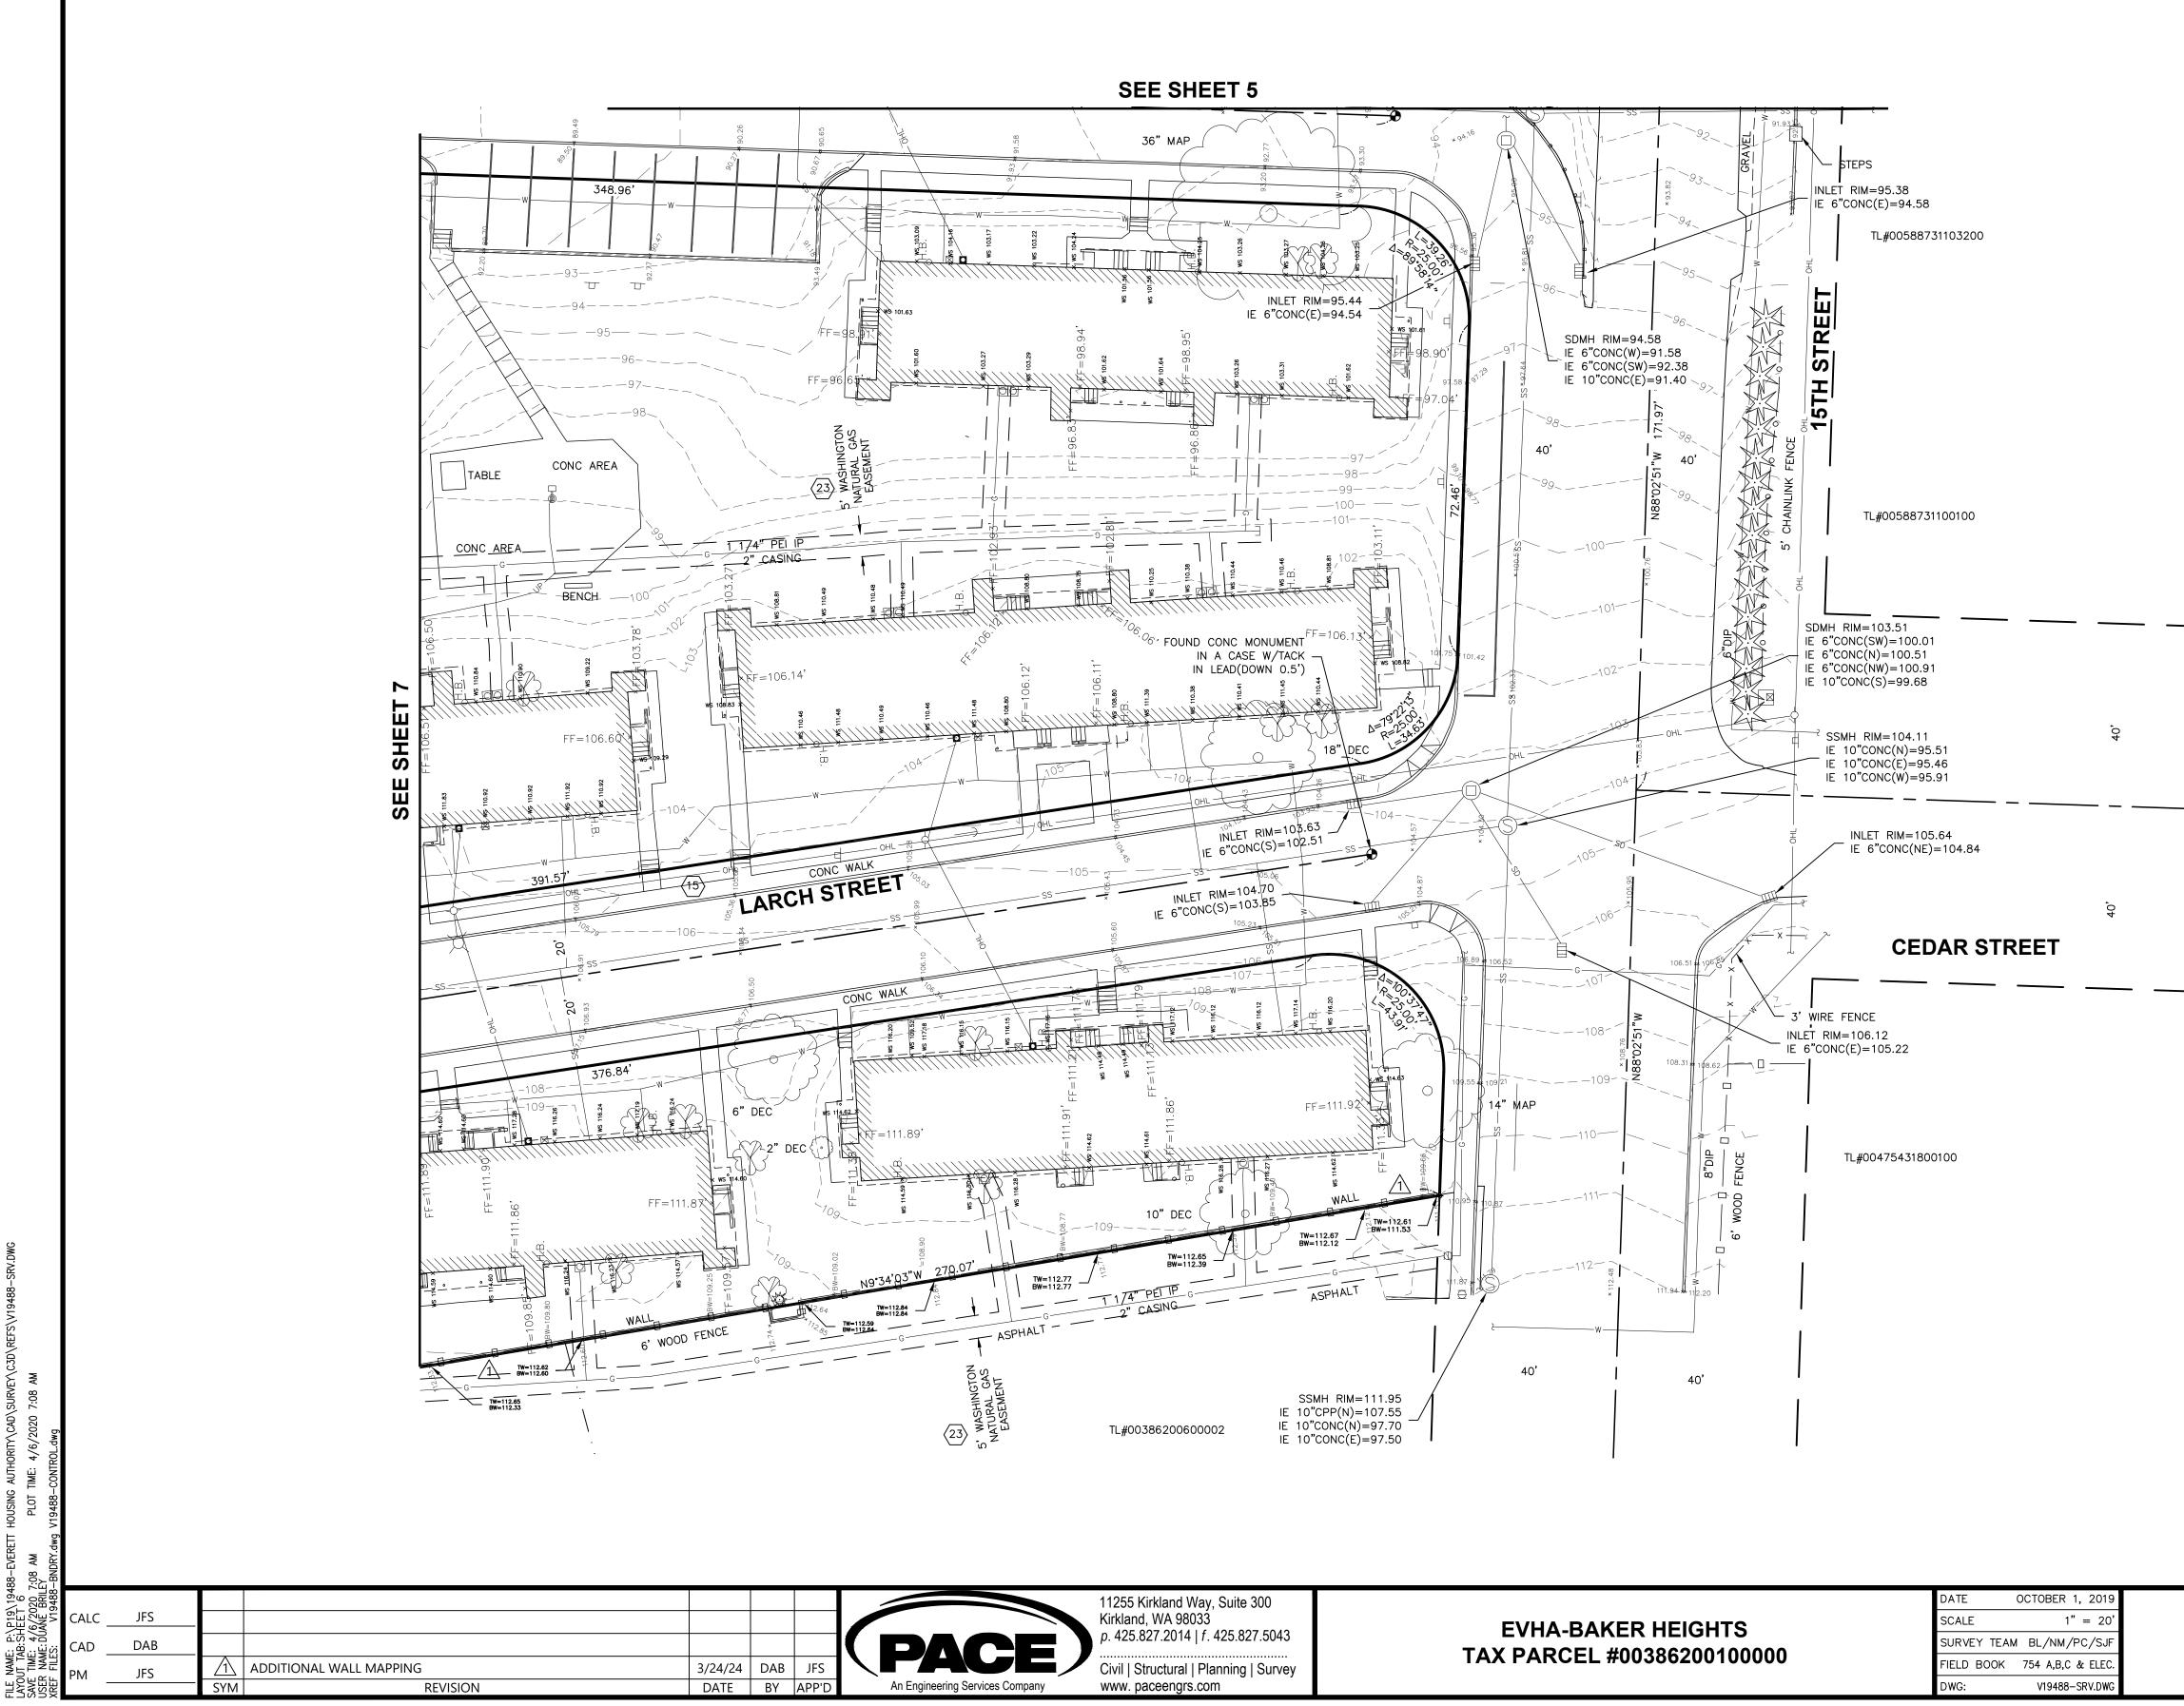

23 WASHINGTON NATURAL GAS COMPANY RECORDING NO. 1242949

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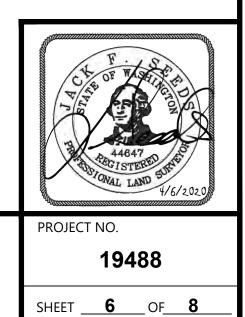
PER CHICAGO TITLE INSURANCE COMPANY CERTIFICATE NO. 500089740 DATE: AUGUST 19, 2019 AT 8:00 AM


15 PUBLIC UTILITY DISTRICT NO. 1 OF SNOHOMISH COUNTY AND VERIZON NORTHWEST REC. NO. 200609140228 AN EASEMENT 10 FEET IN WIDTH, 5 FEET ON EACH SIDE OF THE CENTERLINE OF THE ELECTRICAL AS ACTUALLY INSTALLED.

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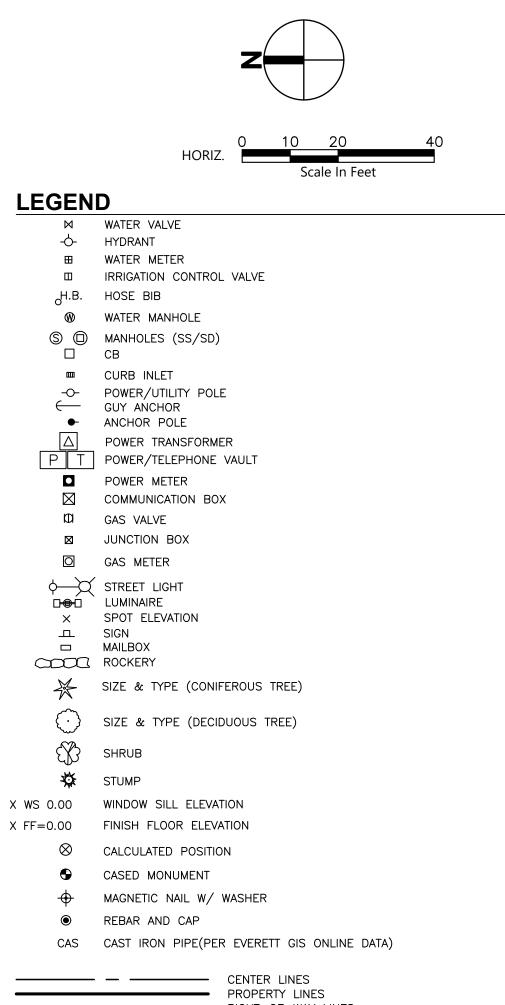
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RIGHT-OF-WAY LINES LOT LINES DITCH LINE WATER LINE SANITARY SEWER LINE STORM DRAIN LINE GAS LINE UNDERGROUND POWER LINES UNDERGROUND COMMUNICATION LINES OVERHEAD UTILITY LINES WETLAND BOUNDARY LINE CHAIN LINK FENCE WIRE FENCE WOOD FENCE EDGE OF VEGETATION/HEDGE LINE

SURVEY NOTES:

PER CHICAGO TITLE INSURANCE COMPANY CERTIFICATE NO. 500089740 DATE: AUGUST 19, 2019 AT 8:00 AM

23 WASHINGTON NATURAL GAS COMPANY RECORDING NO. 1242949

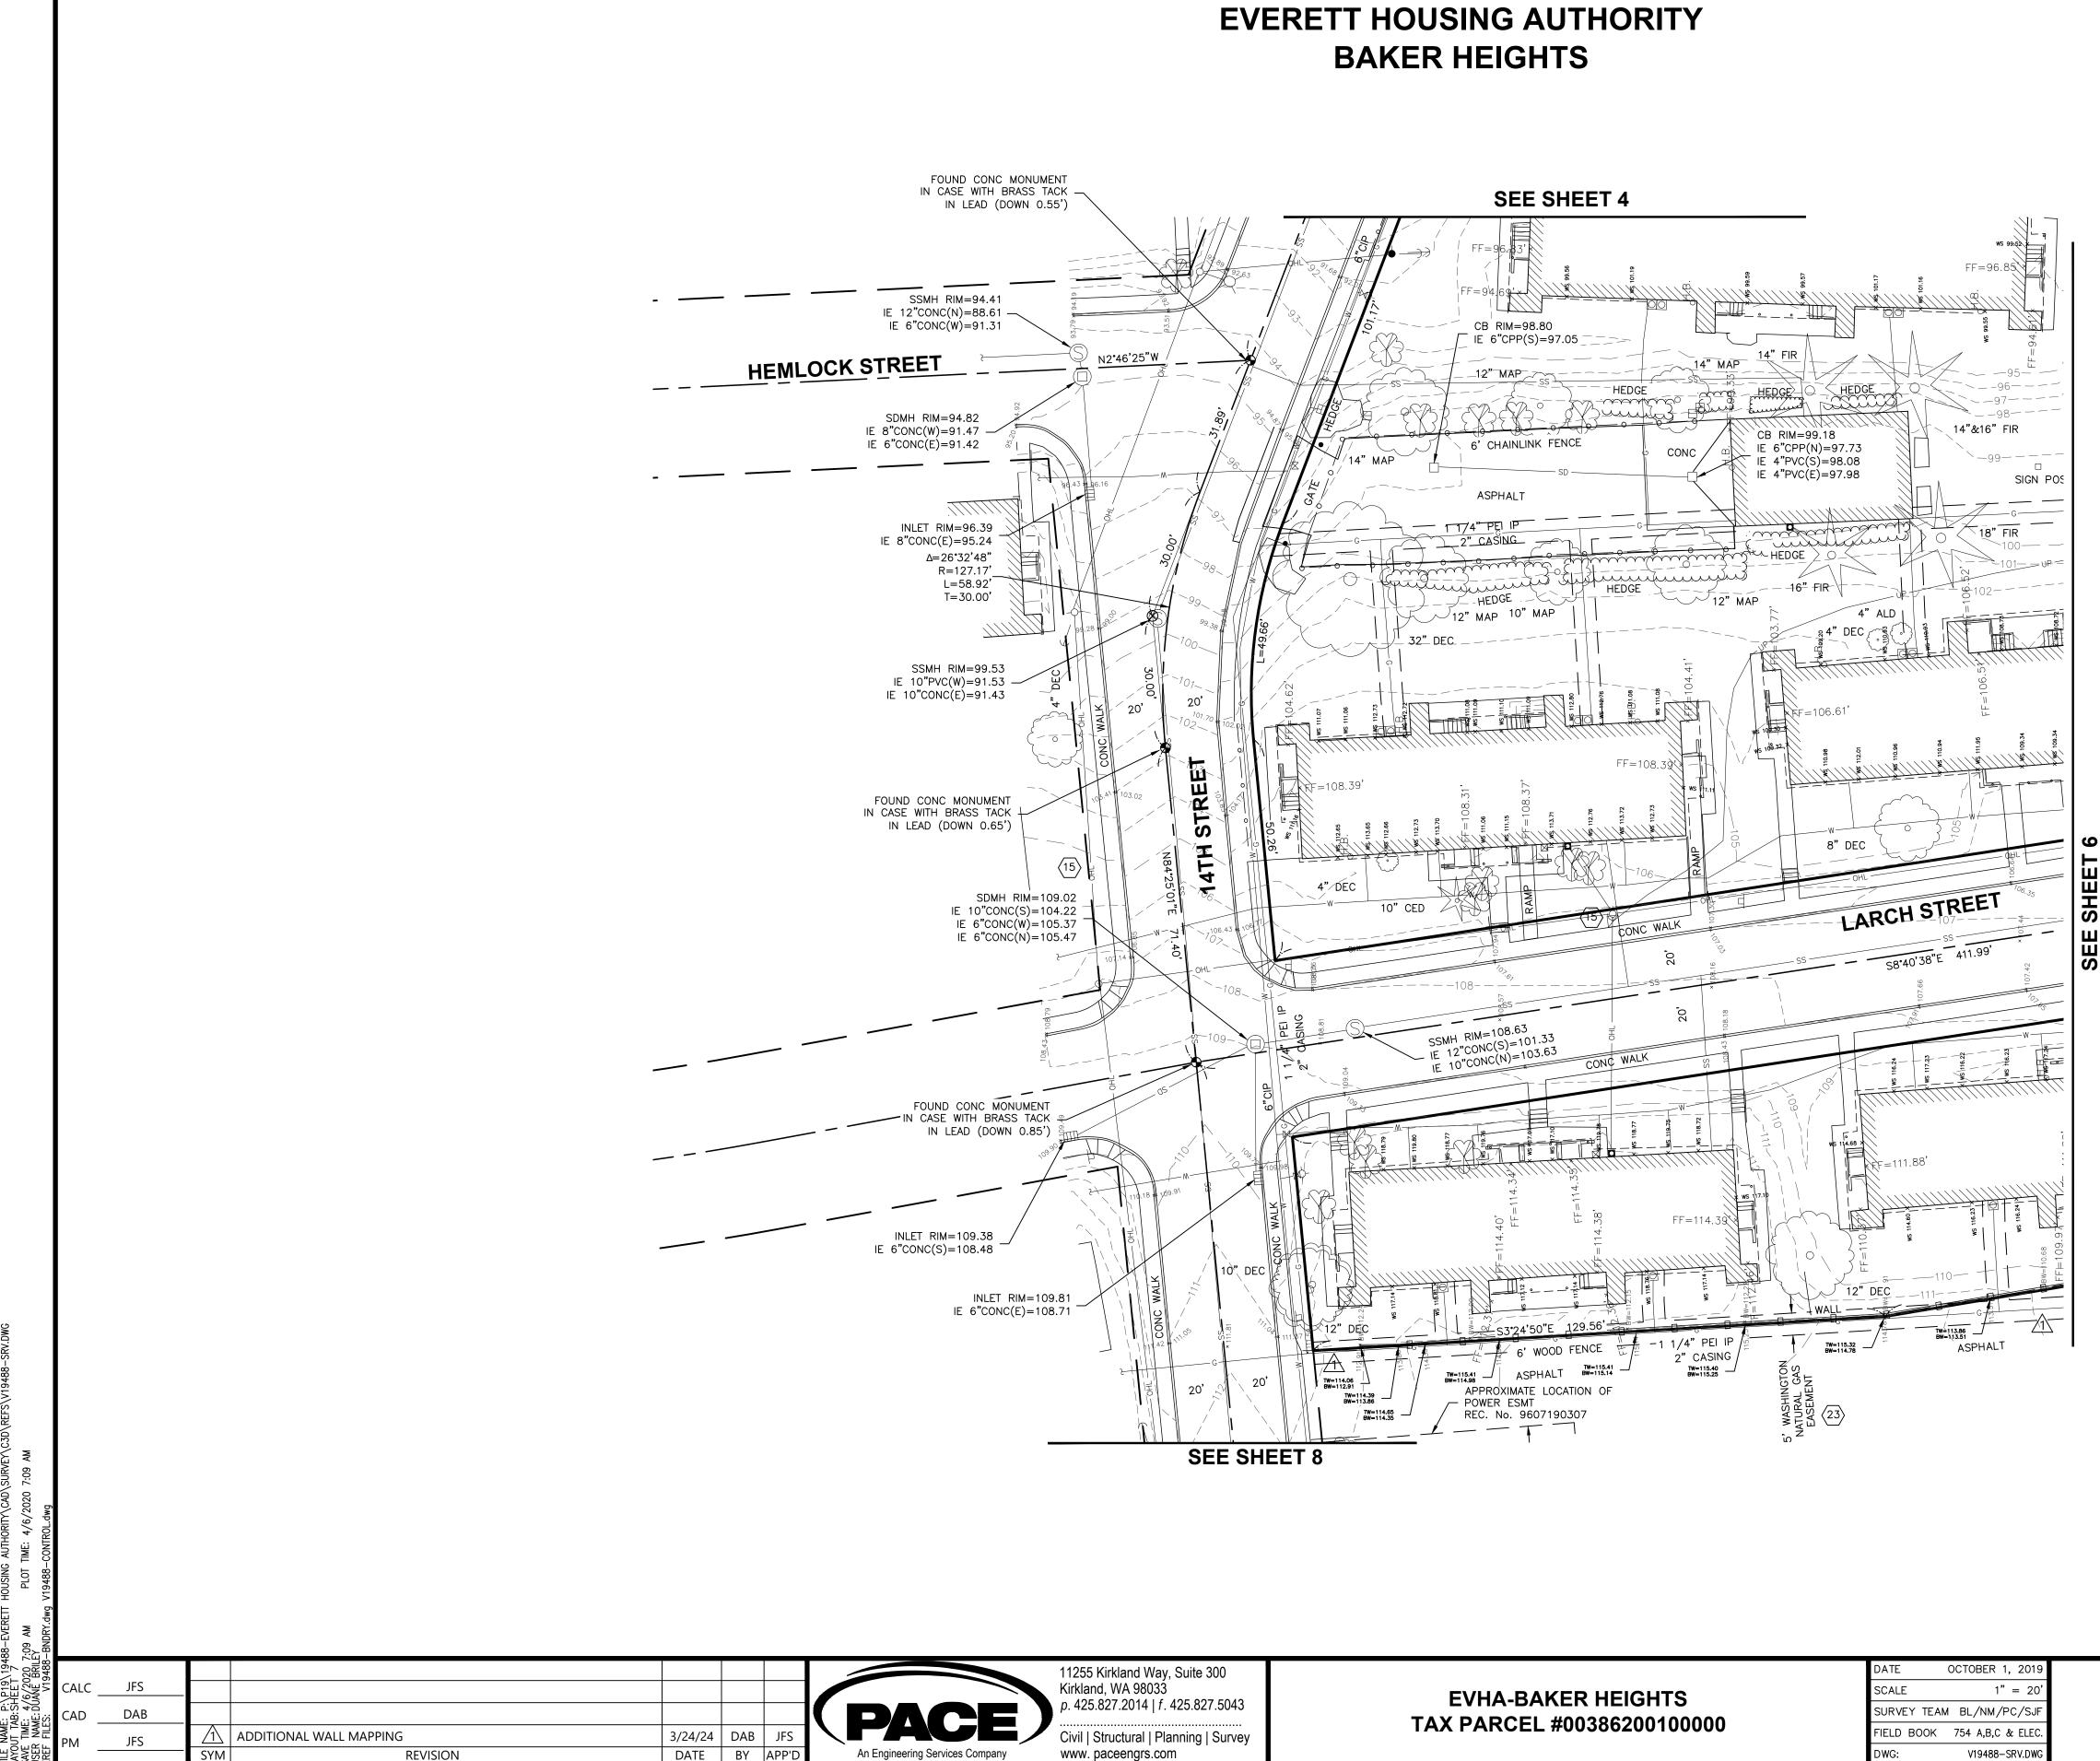EASEMENT NOTE:


PER CHICAGO TITLE INSURANCE COMPANY CERTIFICATE NO. 500089740 DATE: AUGUST 19, 2019 AT 8:00 AM


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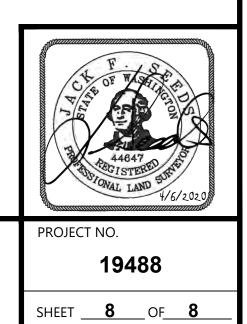
PER CHICAGO TITLE INSURANCE COMPANY CERTIFICATE NO. 500089740 DATE: AUGUST 19, 2019 AT 8:00 AM


- 15 PUBLIC UTILITY DISTRICT NO. 1 OF SNOHOMISH COUNTY AND VERIZON NORTHWEST INC. RECORDING NO. 200609140228
- (23) WASHINGTON NATURAL GAS COMPANY RECORDING NO. 1242949
- PUBLIC UTILITY DISTRICT NO. 1 OF SNOHOMISH COUNTY AND GTE NORTHWEST, INC. RECORDING NO. 9607190307
- (1) APPROXIMATE LOCATION, PER PSE MAPS


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PORTION OF: NE1/4, SECTION 17, T. 29N., R. 5E., W.M. PORTION OF: SE1/4, SECTION 17, T. 29N., R. 5E., W.M.



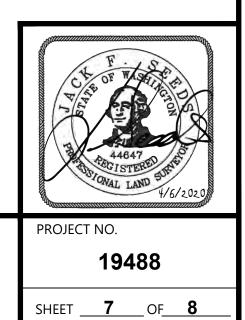

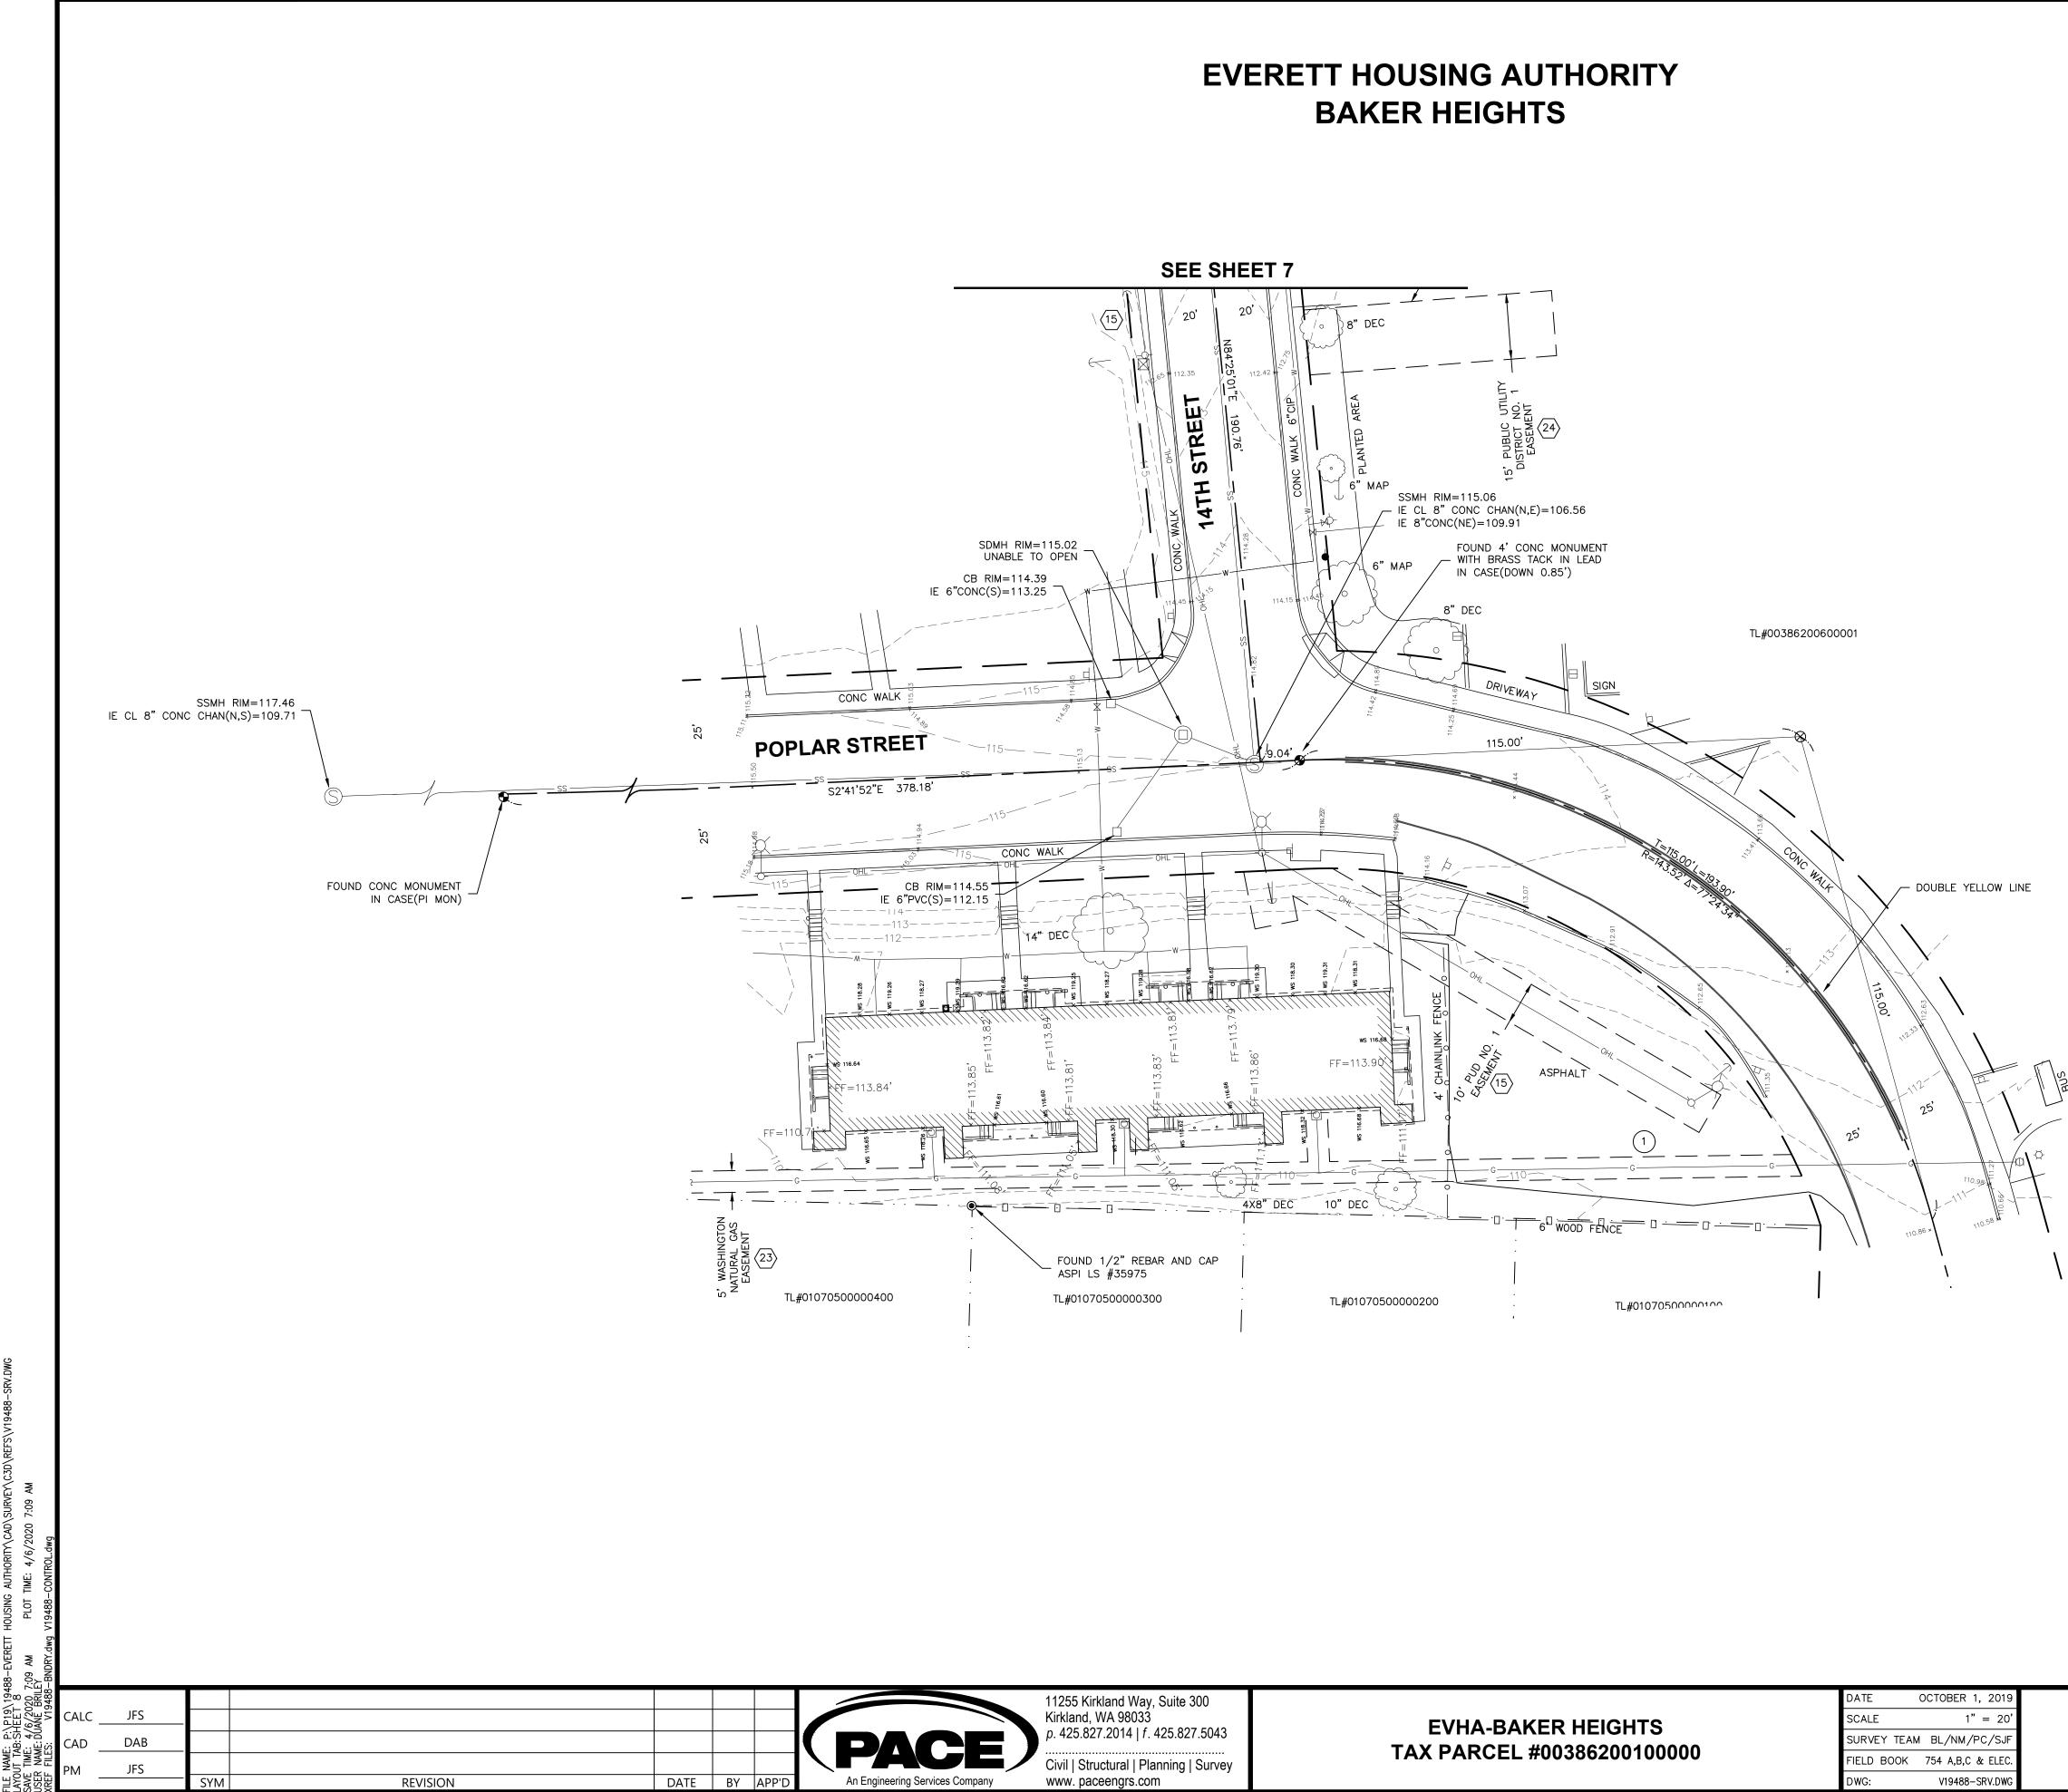
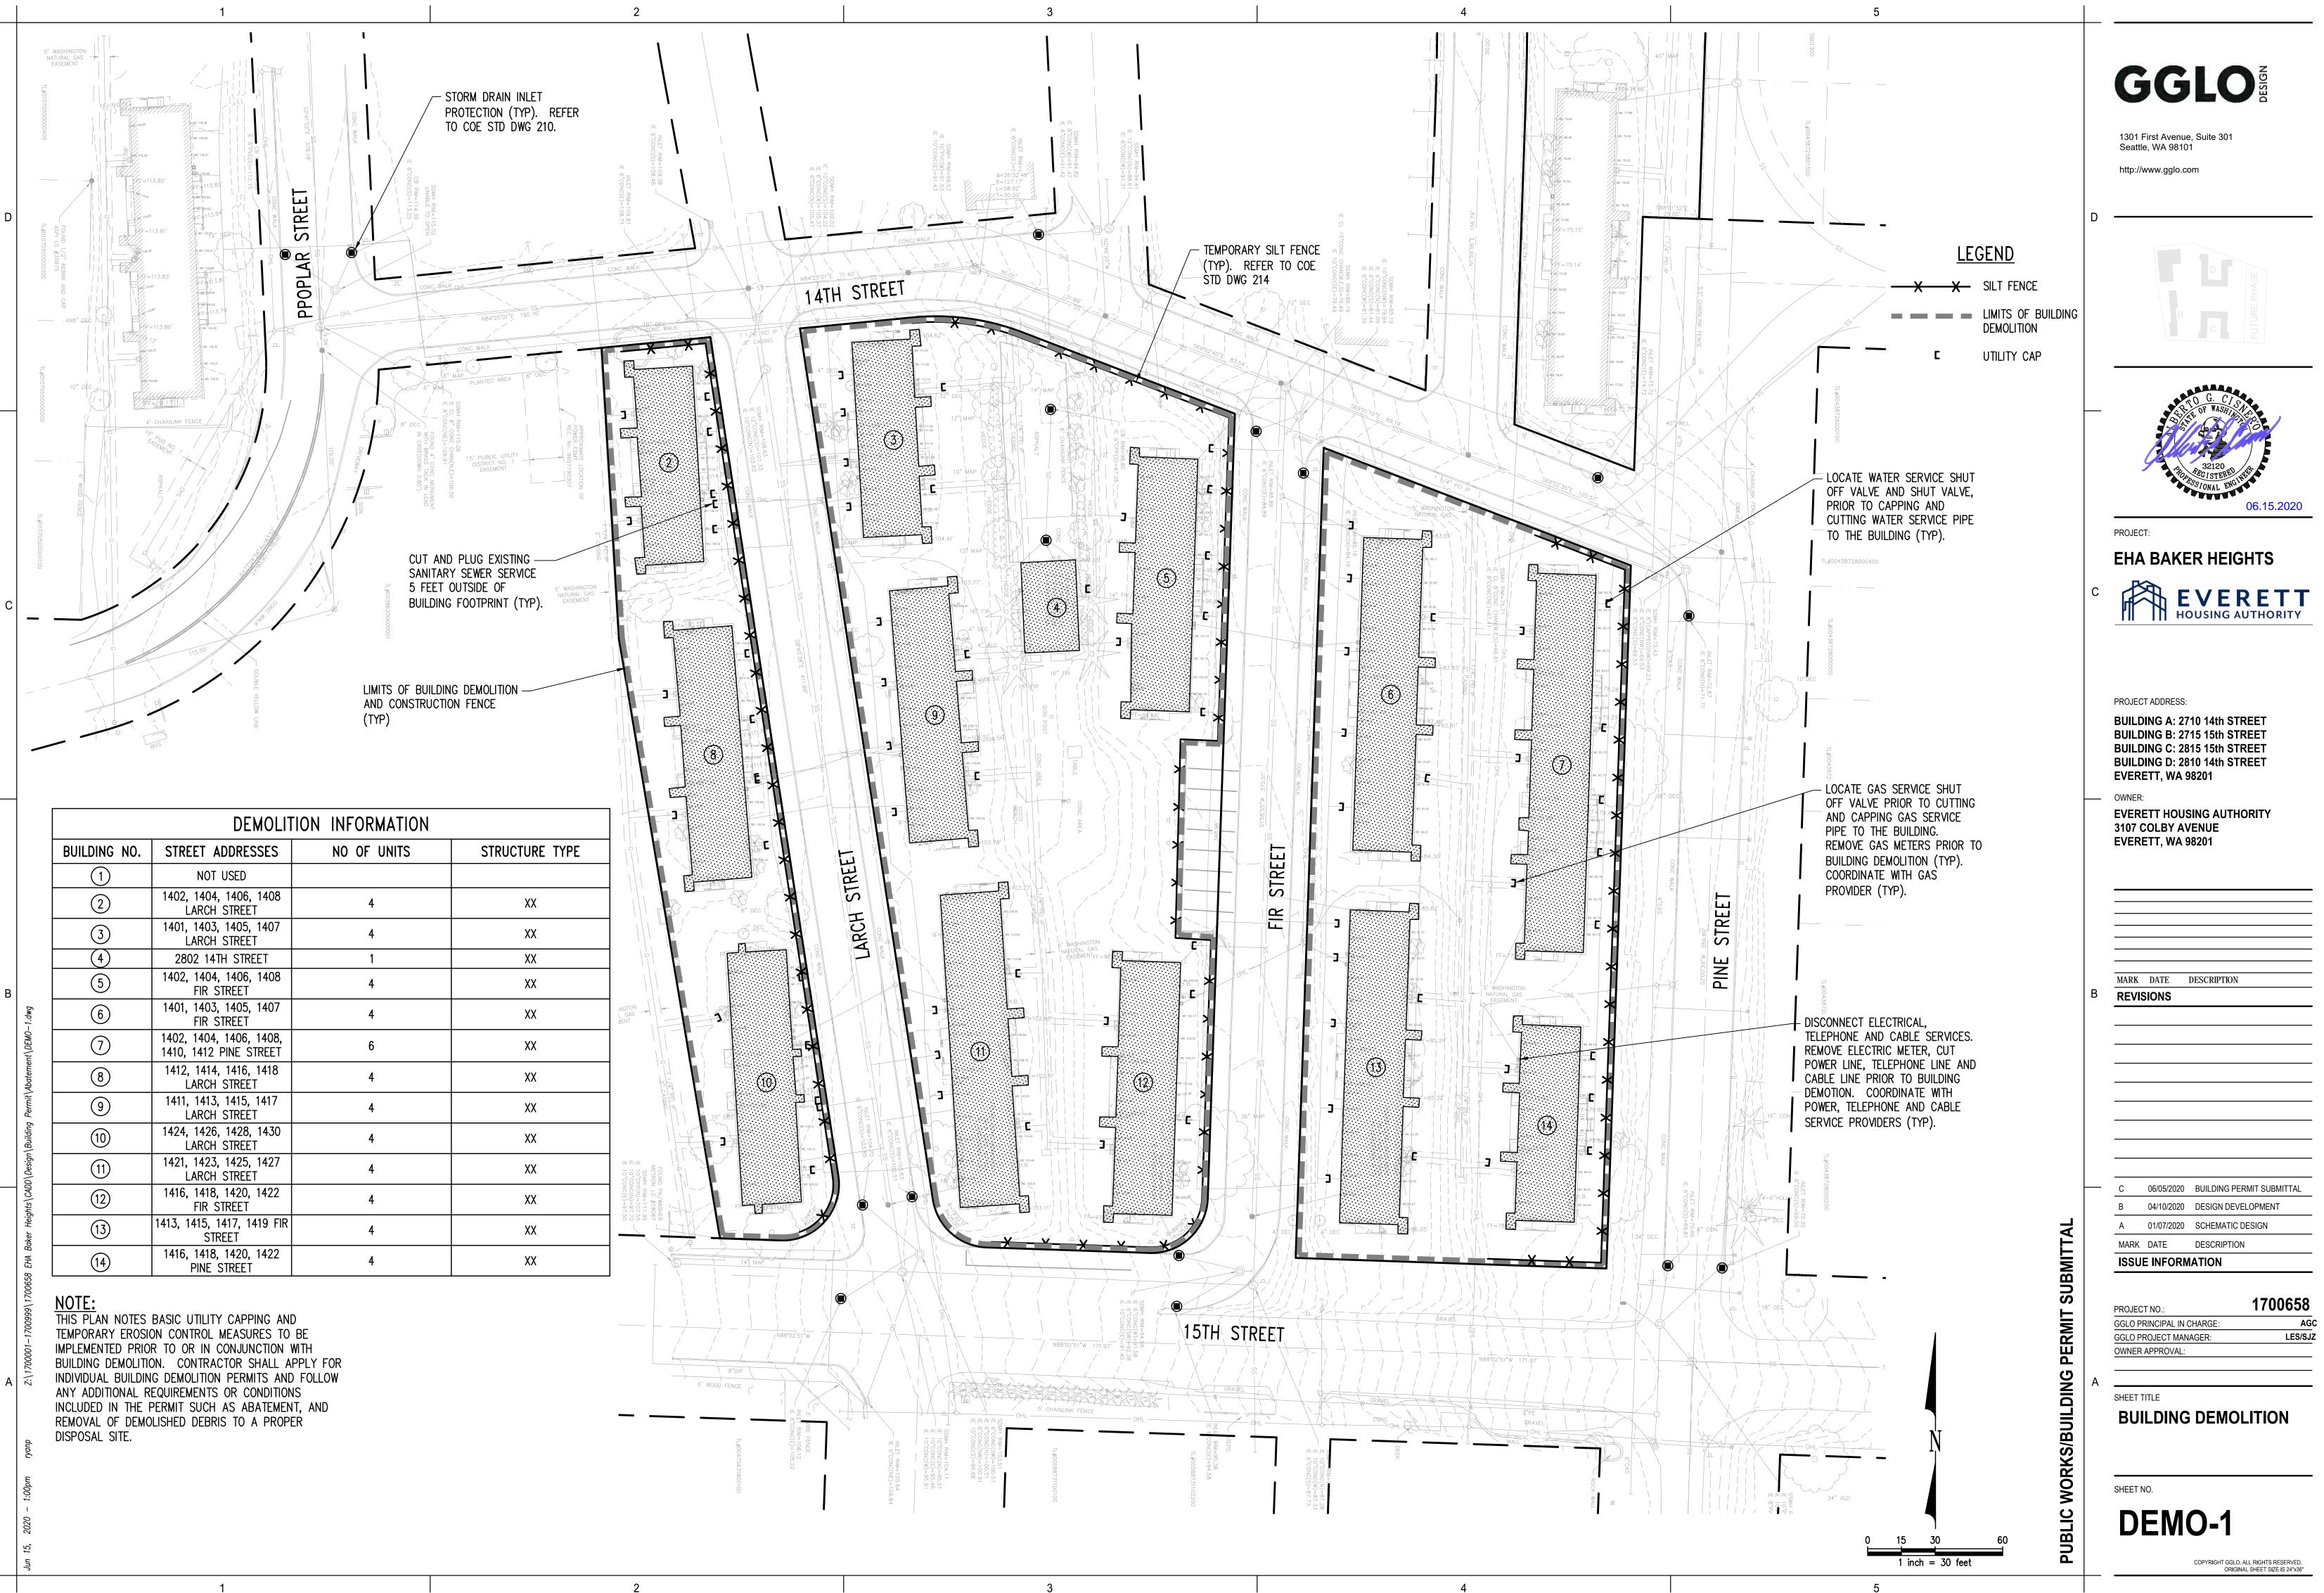
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С	06.15.2020 PROJECT: EHA BAKER HEIGHTS EVERETT HOUSING AUTHORITY
	PROJECT ADDRESS: BUILDING A: 2710 14th STREET BUILDING B: 2715 15th STREET BUILDING C: 2815 15th STREET BUILDING D: 2810 14th STREET EVERETT, WA 98201 OWNER: EVERETT HOUSING AUTHORITY 3107 COLBY AVENUE EVERETT, WA 98201
В	MARK DATE DESCRIPTION REVISIONS
	C06/05/2020BUILDING PERMIT SUBMITTALB04/10/2020DESIGN DEVELOPMENTA01/07/2020SCHEMATIC DESIGNMARKDATEDESCRIPTION
A	B04/10/2020DESIGN DEVELOPMENTA01/07/2020SCHEMATIC DESIGN
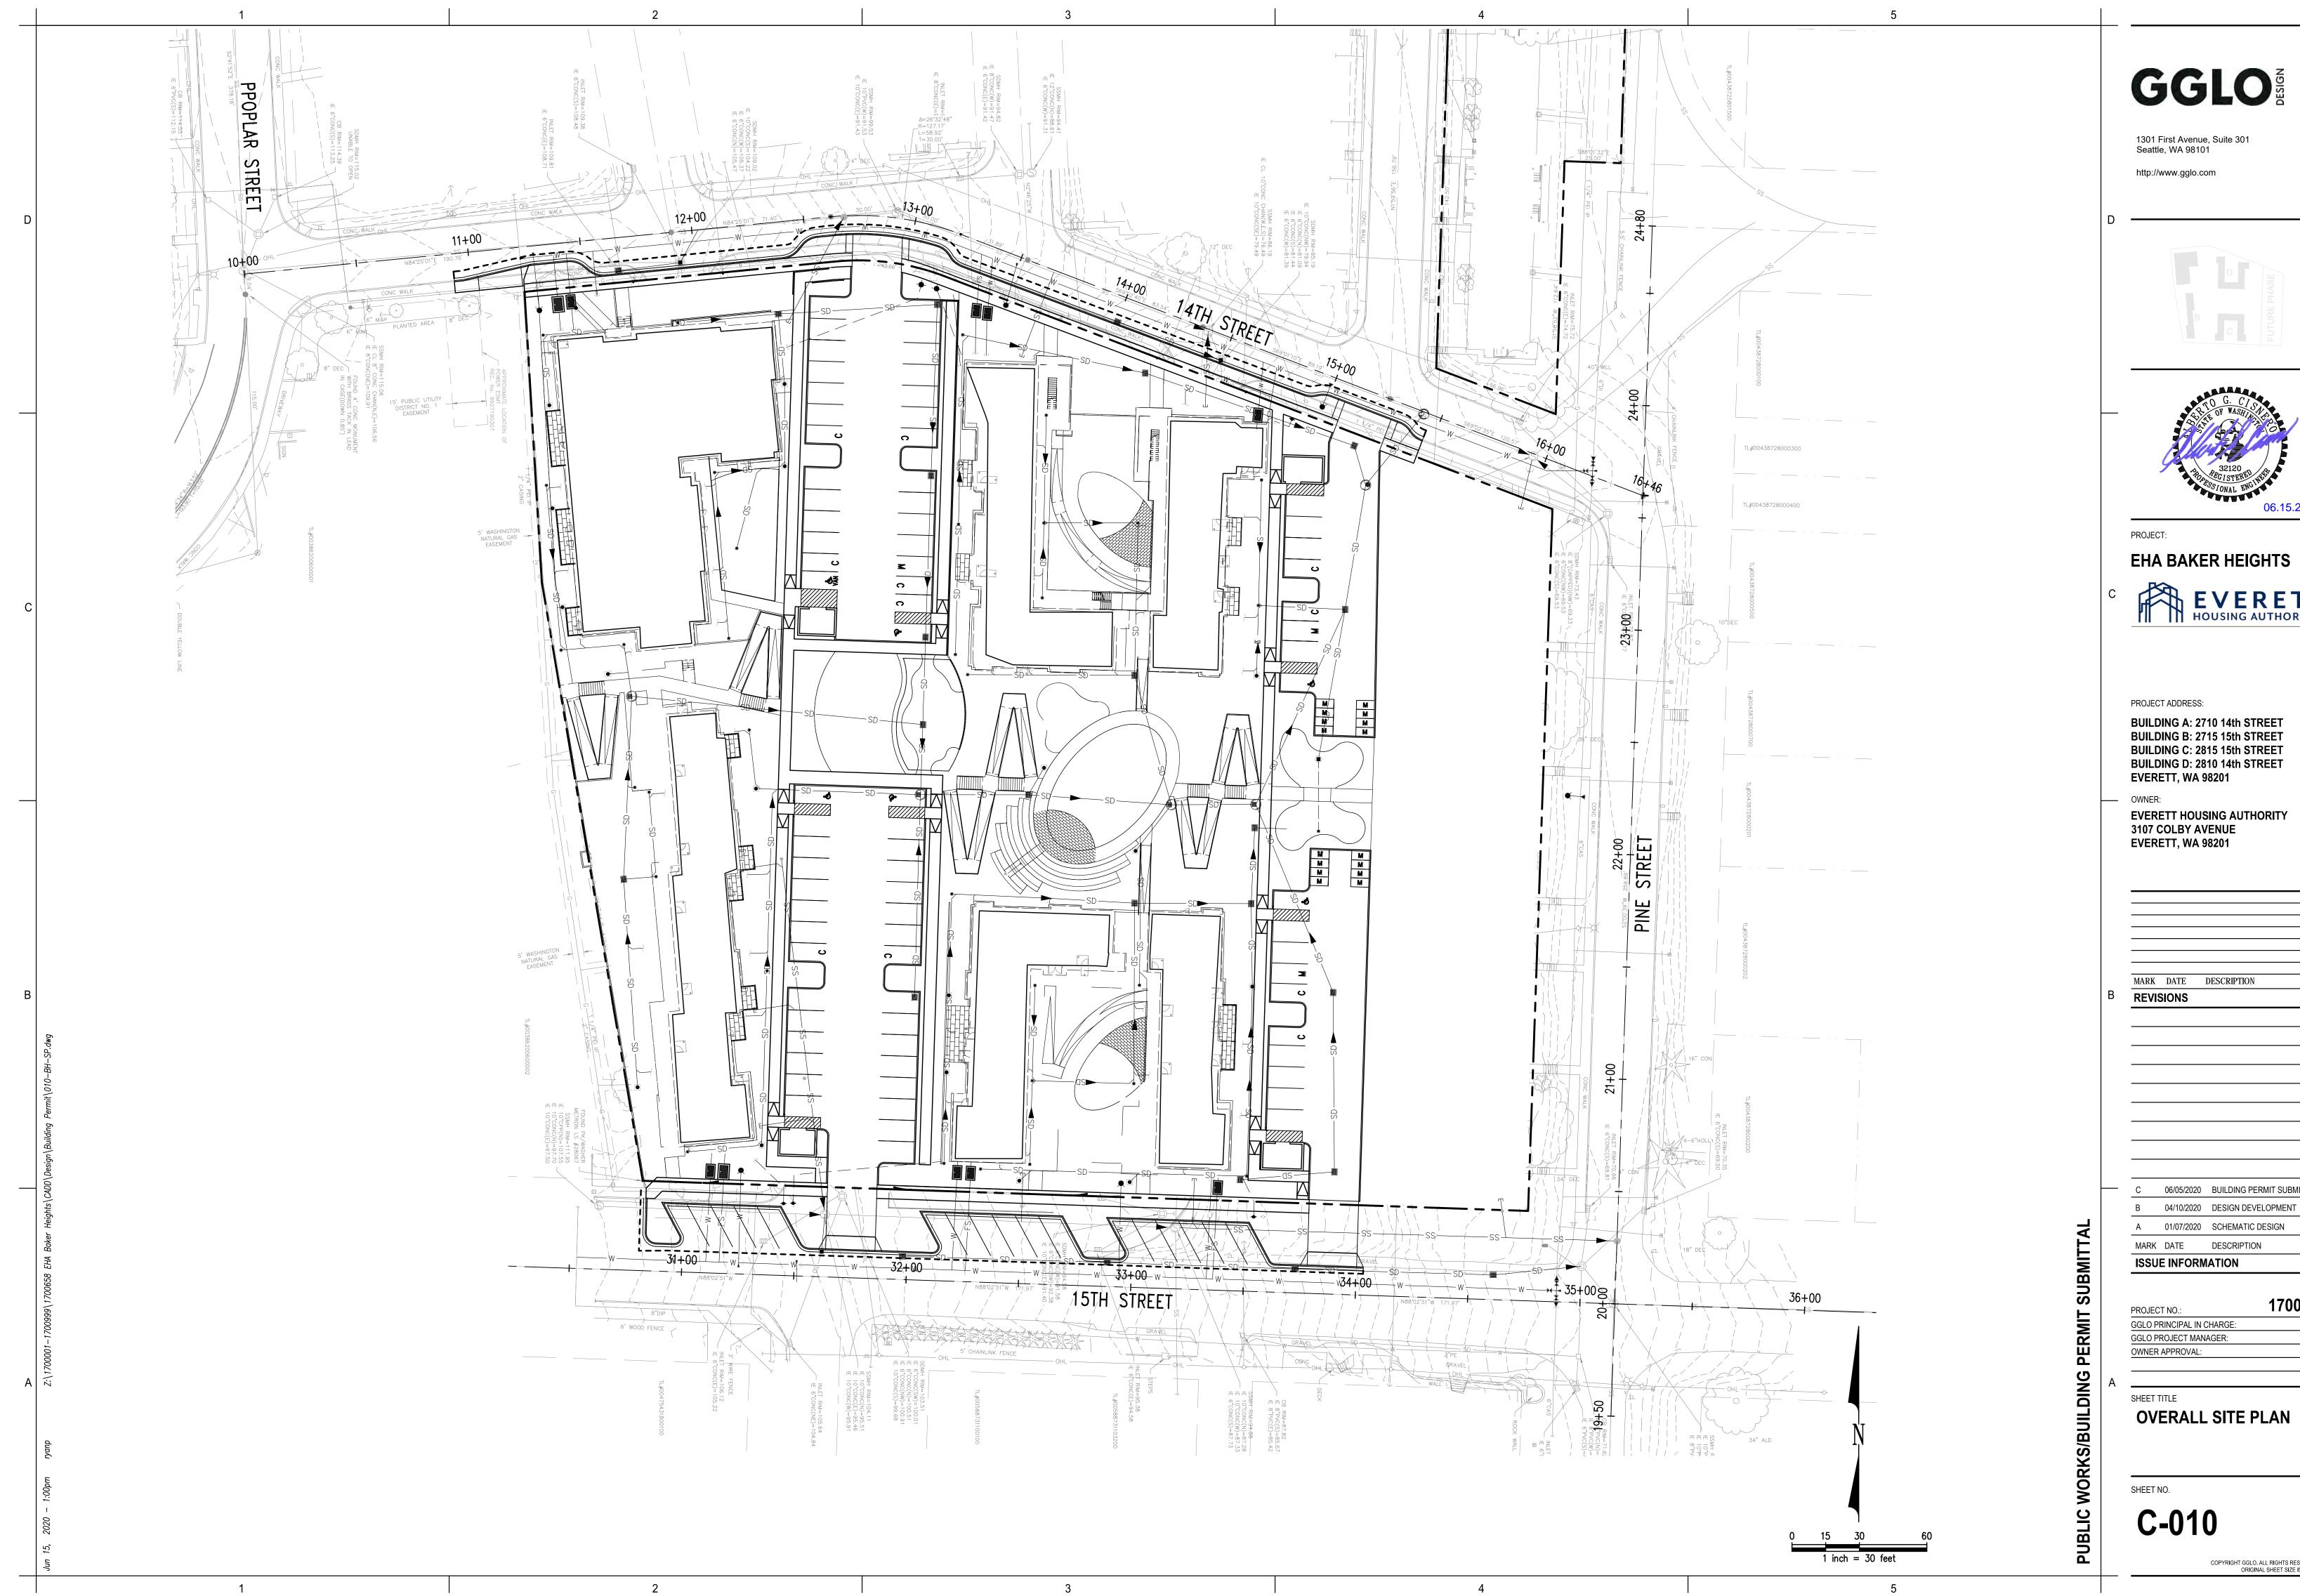
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	<u>GE</u>	NERAL PROJECT NOTES:		
	1.	ALL WORK SHALL CONFORM TO THE 2018 EDITION OF CITY OF EVERETT DESIGN AND CONSTRUCTION STANDARDS AND SPECIFICATIONS. THESE STANDARD PLANS ARE REFERENCED TO IN THESE DESIGN DRAWINGS. A COPY OF THESE DOCUMENTS SHALL BE ON SITE DURING CONSTRUCTION. ANY DISCREPANCIES FOUND BETWEEN CITY STANDARDS AND THE CONTRACT DOCUMENTS SHALL BE BROUGHT TO THE ENGINEERS ATTENTION PRIOR TO PERFORMING THE WORK.		INSPECTION AND ACCEPTANCE LIMITS OF WORK) SHALL BE OF EVERETT. IT SHALL BE TH APPROPRIATE INSPECTIONS A MAY REQUIRE REMOVAL AND THAT DO NOT MEET CITY STA INSPECTIONS.
	2. 3.	A COPY OF THE APPROVED PLAN MUST BE ON SITE WHENEVER CONSTRUCTION IS IN PROGRESS. LOCAL AND EMERGENCY ACCESS SHALL BE MAINTAINED AT ALL TIMES.	21.	THE CONTRACTOR SHALL PRO SEDIMENTATION COLLECTION F ENTER THE SNOHOMISH RIVER
D	J. 4.	ALL PERMITS REQUIRED FOR WORK WITHIN THE PUBLIC RIGHT OF WAY (AND WITHIN LIMITS OF WORK) MUST BE OBTAINED PRIOR TO THE START OF CONSTRUCTION.		CONDITIONS DICTATE, ADDITIO OF CONSTRUCTION. IT SHALL TO ADDRESS ANY NEW COND
	5.	PRIOR TO THE START OF CONSTRUCTION WITHIN THE RIGHT OF WAY (AND WITHIN LIMITS OF WORK), THE CONTRACTOR SHALL SCHEDULE AND ATTEND A PRECONSTRUCTION MEETING WITH THE CITY OF EVERETT PUBLIC WORKS DEPARTMENT.	22.	AND TO PROVIDE ADDITIONAL PROPERTIES. THE CONTRACTOR SHALL KEE
	6.	THE CONTRACTOR SHALL PROTECT ALL AREAS OUTSIDE THE WORK ZONE AND OUTSIDE THE RIGHT-OF-WAY FROM DISTURBANCE. ALL DISTURBED AREAS SHALL BE FULLY RESTORED TO PROPOSED OR PRE-EXISTING CONDITIONS.		SWEEPING. CONTRACTOR'S TRAFFIC CONT TRAFFIC CONTROL MANUAL F
	7.	ALL DAMAGE TO INFRASTRUCTURE CAUSED BY THE CONSTRUCTION SHALL BE REPAIRED IN KIND OR AS REQUIRED BY THE CITY OF EVERETT INSPECTOR.	24.	WILL BE REQUIRED FOR ALL A
	8.	THE APPROVED PLANS SHOW THE APPROXIMATE AREA OF PAVEMENT RESTORATION BASED ON THE DEPTH OF EXCAVATIONS AND/OR THE AREA OF CURB AND/OR PAVEMENT TO BE REMOVED AND REPLACED. THE ACTUAL LIMITS OF THE PAVEMENT RESTORATION SHALL BE DETERMINED IN THE FIELD WITH THE CITY OF EVERETT INSPECTOR PRIOR TO THE PAVEMENT RESTORATION.	25.	PURVEYORS TO REMOVE OR F CONTRACTOR'S EXPENSE. CARE SHALL BE EXERCISED V
	9.	HORIZONTAL DATUM: NAD 83/91. VERTICAL DATUM: NAVD 88.	<u>GEI</u>	NERAL CONSTRUCTIO
	10.	SURVEYING AND STAKING OF ALL IMPROVEMENTS IN THE PUBLIC RIGHT OF WAY (AND WITHIN LIMITS OF WORK) SHALL BE COMPLETED PRIOR TO CONSTRUCTION AND COORDINATED WITH CITY INSPECTOR AND PORT REPRESENTATIVE TO VERIFY POSITIVE DRAINAGE IS OBTAINED.	1.	EXISTING WATER SERVICES SH APPROXIMATE ONLY. CONTRA
С	11.	THE CONTRACTOR SHALL BE RESPONSIBLE FOR REFERENCING AND REPLACING ALL MONUMENTS THAT MAY BE DISTURBED, DESTROYED OR REMOVED BY THE PROJECT AND SHALL FILE AN APPLICATION FOR PERMIT TO REMOVE OR DESTROY A SURVEY MONUMENT WITH THE WASHINGTON STATE DEPARTMENT OF NATURAL RESOURCES, PURSUANT TO RCW 58.24.040(8).	2.	APPROXIMATE LOCATIONS OF RECORDS AND ARE SHOWN F VERIFICATION OF LOCATIONS SHOWN. IF CONFLICTS WITH E SHALL NOTIFY THE ENGINEER.
	12.	THE CONTRACTOR SHALL COORDINATE WITH PORT REPRESENTATIVE FOR ANY SUBMITTAL OF DOCUMENTS IN CONFORMANCE WITH THE STANDARD SPECIFICATIONS PRIOR TO CONSTRUCTION. A MATERIAL SOURCE FORM FOR ALL MATERIALS TO BE PLACED IN THE RIGHT OF WAY (AND WITHIN LIMITS OF WORK) AND MIX DESIGNS FOR ALL ASPHALT, CONCRETE AND AGGREGATES TO BE PLACED MAY REQUIRE SUBMITTAL FOR REVIEW AND APPROVAL PRIOR TO BEGINNING	3.	HOUSING AUTHORITY AND THON THE PROJECT. CONTRACTOR SHALL NOTE IN NOTIFY ENGINEER IF ELEVATION
	13.	CONSTRUCTION.	4.	DO NOT ALLOW SEDIMENT LA PROVIDE CB PROTECTION IMM EROSION AND SEDIMENT CON
	13.	THE CONTRACTOR SHALL NOTIFY THE EVERETT FIRE DEPARTMENT DISPATCHER AT LEAST TWENTY-FOUR (24) HOURS IN ADVANCE OF ALL WATER SERVICE INTERRUPTIONS, HYDRANT SHUTOFFS, AND STREET CLOSURES OR OTHER ACCESS BLOCKAGE. THE CONTRACTOR SHALL ALSO NOTIFY THE DISPATCHER OF ALL NEW, RELOCATED, OR ELIMINATED HYDRANTS RESULTING FROM THIS WORK.	5.	DO NOT ALLOW FLOW OF STO PIPING AND PUMPS IF NEEDE DISCHARGE BACK TO THE PU
	14.	THE CONTRACTOR SHALL LOCATE AND PROTECT ALL CASTINGS AND UTILITIES DURING CONSTRUCTION.	6.	ALL SAWCUT PAVEMENT TO E
	15.	THE CONTRACTOR SHALL CONTACT THE UNDERGROUND UTILITIES LOCATOR SERVICE (1-800-424-5555) AT LEAST 48 HOURS PRIOR TO CONSTRUCTION. THE CONTRACTOR SHALL BE RESPONSIBLE FOR PROVIDING A PRIVATE LOCATOR SERVICE TO LOCATE ALL UTILITIES NOT MARKED BY DIAL-A-DIG WITHOUT ADDITIONAL EXPENSE TO THE EVERETT HOUSING AUTHORITY.	7. 8.	INSTALLATION OF RELOCATED DETAILS NO. 715 AND NO. 71 CONTRACTOR SHALL FIELD VE CONNECTING TO EXISTING PIP
В	16.	IT IS THE SOLE RESPONSIBILITY OF THE CONTRACTOR TO VERIFY THE ACCURACY OF ALL UTILITY LOCATIONS SHOWN AND TO FURTHER DISCOVER AND AVOID ANY OTHER UTILITIES NOT SHOWN WHICH MAY BE AFFECTED BY THE IMPLEMENTATION OF THESE IMPROVEMENTS.		
	NOTES.dwg	THE CONTRACTOR SHALL ADJUST ALL EXISTING MANHOLE RIMS, DRAINAGE STRUCTURE LIDS, VALVE BOXES, AND UTILITY ACCESS STRUCTURES TO FINISH GRADE WITHIN AREAS AFFECTED BY THE PROPOSED IMPROVEMENTS.		
	іт\011 <i>-вн-</i> 18.	THE CONTRACTOR SHALL PROVIDE AND PAY FOR ALL TESTING AS REQUIRED BY THE STREET INSPECTOR OR THE EVERETT HOUSING AUTHORITY.		
	ign\Building Perm .6	BACKFILL MATERIAL USED IN PUBLIC RIGHT OF WAY (AND WITHIN LIMITS OF WORK) SHALL MEET CITY OF EVERETT DESIGN AND CONSTRUCTION STANDARDS AND SPECIFICATIONS AND THE STANDARDS SET FORTH IN THE PROJECT MANUAL.		
A	15, 2020 – 1:00pm ryanp Z:\1700001–170099\1700658 EHA Baker Heights\CADD\Design\Building Permit\011–BH–NOTES.dwg 			
	Jun	1		2

CE OF ALL WORK IN THE PUBLIC RIGHT OF WAY (AND WITHIN E DONE BY REPRESENTATIVES OF THE CITY OF EVERETT AND PORT THE CONTRACTOR'S RESPONSIBILITY TO COORDINATE AND SCHEDULE ALLOWING FOR PROPER ADVANCE NOTICE. THE STREET INSPECTOR O RECONSTRUCTION OF ANY ITEMS PLACED IN THE RIGHT OF WAY FANDARDS OR THAT WERE CONSTRUCTED WITHOUT APPROPRIATE

- 3

ROVIDE AND MAINTAIN TEMPORARY EROSION CONTROL AND FACILITIES TO ENSURE THAT SEDIMENT-LADEN WATER DOES NOT ER. AS CONSTRUCTION PROGRESSES AND UNEXPECTED (SEASONAL) ONAL CONTROL FACILITIES MAY BE REQUIRED. DURING THE COURSE BE THE OBLIGATION AND RESPONSIBILITY OF THE CONTRACTOR DITIONS THAT MAY BE CREATED BY THE CONTRACTOR'S ACTIVITIES L FACILITIES THAT MAY BE NEEDED TO PROTECT ADJACENT

EP ALL PAVED SURFACES IN THE RIGHT OF WAY CLEAN BY

ITROL SHALL BE IN ACCORDANCE WITH THE CITY OF EVERETT FOR IN-STREET WORK. AN APPROVED TRAFFIC CONTROL PLAN ARTERIAL STREETS PRIOR TO BEGINNING CONSTRUCTION.

ANY CITY OF EVERETT DEPARTMENTS AND OTHER UTILITY RELOCATE EXISTING UTILITIES SHALL BE DONE AT THE

WHEN EXCAVATING NEAR EXISTING CHARGED WATER MAINS.

ON NOTES:

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SHOWN ARE BASED ON CITY/PORT RECORDS AND ARE ACTOR SHALL VERIFY PRIOR TO CONSTRUCTION.

EXISTING UTILITIES HAVE BEEN OBTAINED FROM AVAILABLE FOR CONVENIENCE. THE CONTRACTOR SHALL BE RESPONSIBLE FOR AND TO AVOID DAMAGE TO ANY ADDITIONAL UTILITIES NOT EXISTING UTILITIES ARISE DURING CONSTRUCTION, THE CONTRACTOR R. ANY CHANGES REQUIRED SHALL BE APPROVED BY THE EVERETT THE CITY PRIOR TO COMMENCEMENT OF RELATED CONSTRUCTION

NVERT ELEVATIONS ON EXISTING AND PROPOSED MANHOLES. IONS DIFFER FROM PLANS PRIOR TO ORDERING MANHOLES.

ADEN WATERS TO ENTER SNOHOMISH RIVER. AT A MINIMUM MEDIATELY DOWNSTREAM OF PROJECT. PROVIDE ADDITIONAL ITROL AS DIRECTED BY PORT REPRESENTATIVE.

ORMWATER INTO THE EXCAVATION. USE TEMPORARY BYPASS ED TO INTERCEPT FLOWS UPSTREAM OF THE WORK AREA AND JBLIC DRAINAGE SYSTEM.

BE RESTORED AT THE LIMITS INDICATED ON THE DRAWINGS.

SIGN POSTS SHALL BE PER CITY OF EVERETT STANDARD

/ERIFY EXISTING PIPE MATERIAL AND OUTER DIAMETER WHERE PE PRIOR TO ORDERING COUPLINGS.

DEMOLITION AND CLEARING NOTES

1. REFER TO DEMOLITION PLAN FOR DEMOLITION AND CLEARING NOTES..

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TESC NOTES

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1. REFER TO TESC PLAN FOR TESC NOTES.

	1301 First Avenue, Suite 301 Seattle, WA 98101
D	http://www.gglo.com
	B C B FUTURE PHASE
	C6.15.2020
	PROJECT: EHA BAKER HEIGHTS
С	EVERETT HOUSING AUTHORITY
	PROJECT ADDRESS: BUILDING A: 2710 14th STREET BUILDING B: 2715 15th STREET BUILDING C: 2815 15th STREET BUILDING D: 2810 14th STREET EVERETT, WA 98201 OWNER: EVERETT HOUSING AUTHORITY 3107 COLBY AVENUE EVERETT, WA 98201
В	MARK DATE DESCRIPTION REVISIONS
	C06/05/2020BUILDING PERMIT SUBMITTALB04/10/2020DESIGN DEVELOPMENTA01/07/2020SCHEMATIC DESIGNMARKDATEDESCRIPTIONISSUE INFORMATION
	PROJECT NO.: 1700658 GGLO PRINCIPAL IN CHARGE: AG
	GGLO PROJECT MANAGER: LES/SJ OWNER APPROVAL:
A	SHEET TITLE NOTES
	SHEET NO.

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PUBLIC WORKS/BUILDING PERMIT SUBMITT/

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	GF	NERAL SEWER AND STORM DRAIN NOTES:		
	<u>- 0 - 1</u> .	ALL WORK AND MATERIALS SHALL CONFORM TO THE CITY OF EVERETT (CITY) STANDARDS AND WSDOT/APWA STANDARD SPECIFICATIONS.	22.	PROTECT ALL INSTAL ADEQUATE PROTECTI AND PAVING.
	2.	, CONSTRUCTION OF ALL SEWER MAINS, SIDE SEWERS (LATERALS) AND APPURTENANCES SHALL BE IN COMPLIANCE WITH ALL ORDINANCES AND CURRENT STANDARDS OF CITY OF EVERETT.	23.	PROTECT ALL EXISTI
	3.	ALL REQUESTS FOR INSPECTIONS AND FOR WITNESSING TESTS SHALL BE SCHEDULED WITH THE	24.	DO NOT ALLOW FLOW EXCAVATION PIT.
D		ENGINEER 72 HOURS IN ADVANCE. FAILURE TO GIVE ADEQUATE ADVANCE NOTICE MAY RESULT IN DELAYS TO THE CONTRACTOR FOR REQUIRED INSPECTIONS.	25.	AT THE END OF EAC PRESENT, ALL OPEN
U	4. 5.	SAWCUT OR TRENCH WHEEL CUT PAVEMENT PRIOR TO DIGGING. ALL MANHOLES OVER 3 FEET IN HEIGHT SHALL BE PROVIDED WITH A LADDER OR STEPS PER		WITH STEEL PLATES (CHAIN LINK) SHALL
		CITY OF EVERETT STANDARD PLAN NO. 608.	26.	POTABLE WATER LIN SEWER. SEWER SHAL
	6.	SUBMIT SHOP DRAWINGS FOR ALL NEW MANHOLES TO THE ENGINEER FOR APPROVAL. NO MANHOLE SHALL BE MANUFACTURED PRIOR TO APPROVAL OF SHOP DRAWINGS.		other utilities. Cli Pipe/conduit.
	7.	ALL PIPES SHALL BE CLEARLY MARKED WITH TYPE, CLASS AND THICKNESS, AS APPLICABLE. LETTERING SHALL BE LEGIBLE AND PERMANENT UNDER NORMAL CONDITIONS OF HANDLING AND STORAGE.	27.	SEWER SHALL MAINT WATER MAIN, 3 FEE
	8.	UNLESS AUTHORIZED BY THE ENGINEER, NO PART OF THE SANITARY SEWER SYSTEM SHALL BE COVERED, CONCEALED OR PUT INTO USE UNTIL IT HAS BEEN TESTED, INSPECTED, AND APPROVED BY THE CITY.		
	9.	STAKE ALL SEWER MAIN EXTENSIONS WITHIN THE PUBLIC RIGHT—OF—WAY OR IN EASEMENT FOR LINE AND GRADE PRIOR TO STARTING CONSTRUCTION.		
	10.	CLEAN AND FLUSH ALL SEWER LINES WITH CLEAN WATER PRIOR TO TESTING.		
	11.	RECONNECT ALL EXISTING AND ACTIVE SIDE SEWERS TO NEW MAINS WHETHER SHOWN OR NOT IN DRAWINGS. SIDE SEWER LOCATIONS SHOWN ON THE DRAWINGS ARE APPROXIMATE AND SHALL BE SUBJECT TO RELOCATION IN THE FIELD. INSTALL TEE OR WYE BRANCH TO SEWER MAIN LINE AT LOCATION DESIGNATED OR APPROVED BY THE ENGINEER. ALL SIDE SEWERS MAY NOT BE AS SHOWN ON THE PLANS.		
С	12.	SOME EXISTING DRY SIDE SEWERS AND CAPPED TEES MAY BE ENCOUNTERED ON THIS PROJECT. VERIFY WITH ENGINEER IF REPLACEMENT SIDE SEWER IS REQUIRED.		
	13.	MINIMUM SIZE FOR SIDE SEWERS WITHIN EASEMENT OR RIGHT-OF-WAY SHALL BE 6 INCHES IN DIAMETER, UNLESS OTHERWISE NOTED.		
	14.	UNLESS OTHERWISE NOTED, MINIMUM SLOPE FOR SIDE SEWERS AND STORM DRAIN CONNECTIONS SHALL BE 2%.		
	15.	ALL SIDE SEWERS SHALL EXTEND TO THE PROPERTY LINE OR AS SHOWN ON THE PLANS AND SHALL HAVE MINIMUM COVER OF 6 FEET.		
	16.	AFTER BACKFILL ALL SIDE SEWERS AND STORM DRAIN CONNECTIONS SHALL BE TESTED IN ACCORDANCE WITH WSDOT STANDARD SPECIFICATIONS $7-17.3(2)F$. SIDE SEWERS AND STORM DRAIN CONNECTIONS THAT ARE RECONSTRUCTED OR REPAIRED TO A LENGTH OF 10 FEET OR MORE SHALL BE TESTED FOR WATERTIGHTNESS SIMULTANEOUSLY WITH THE MAIN LINE IN ACCORDANCE WITH WSDOT STANDARD SPECIFICATIONS $7-17.3(2)F$. TESTING OF NEWLY RECONSTRUCTED SECTIONS OF SIDE SEWERS CONSISTING OF A SINGLE LENGTH OF PIPE WILL NOT BE REQUIRED. TESTING SHALL BE PERFORMED IN THE PRESENCE OF THE CITY INSPECTOR AND THE PORT REPRESENTATIVE.		
	17.	TEMPORARY BYPASS PLANS FOR ALL SANITARY SEWER AND STORM DRAIN SYSTEM SHALL BE SUBMITTED TO THE PORT FOR APPROVAL.		
	18.	TEMPORARY BYPASS SHALL BE INSTALLED AND FULLY OPERATIONAL PRIOR TO REMOVAL OF ANY SANITARY SEWER MAINS OR MANHOLES.		
В	19.	STRUCTURAL FILL OR CSBC OR GB WILL BE REQUIRED FOR BACKFILL AROUND ALL NEW MANHOLES.		
	3H-NOTES.dwg	CONTRACTOR SHALL VERIFY INVERT ELEVATIONS ON EXISTING AND PROPOSED MANHOLES. NOTIFY THE ENGINEER IF ELEVATIONS DIFFER PRIOR TO ORDERING MANHOLES AND PRIOR TO BEGINNING ANY PIPE INSTALLATION.		
	EHA Baker Heights\CADD\Design\Building Permit\012-BH-NOTES.dwg .07	MAINTAIN ALL SERVICES UNTIL NEW MAIN IS ACTIVATED. CONTRACTOR SHALL COORDINATE WITH THE PORT, THE CITY AND PROPERTY OWNER FOR SERVICE SHUT DOWN. COORDINATE ABANDONING EXISTING SIDE SEWERS WITH CONNECTION OF SIDE SEWERS TO NEW SEWER MAIN SO THAT CONTINUOUS SEWER SERVICE IS MAINTAINED. FIELD VERIFY SIDE SEWER VERTICAL AND HORIZONTAL ALIGNMENTS PRIOR TO INSTALLATION. NOTIFY THE ENGINEER OF DISCREPANCIES.		
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LLED PIPES AND STRUCTURES WITH BACKFILL, STEEL PLATES OR OTHER TION FROM CONSTRUCTION AND TRAFFIC LOADS PRIOR TO FINAL GRADING

ING UTILITIES TO REMAIN.

2

W OF STORMWATER OR RAW SEWAGE TO ENTER THE TRENCH OR

CH WORKDAY AND IN WORK LOCATIONS WHERE THE CONTRACTOR IS NOT EXCAVATIONS, TRENCHES OR MANHOLE STRUCTURES SHALL BE COVERED OR PORTABLE FENCE PANELS. IN ADDITION, CONSTRUCTION SAFETY FENCE BE ERECTED TO SURROUND THE WORK AREA.

NES SHALL MAINTAIN A MINIMUM VERTICAL CLEARANCE OF 18 INCHES FROM LL MAINTAIN A MINIMUM VERTICAL CLEARANCE OF 6 INCHES FROM ALL EARANCE IS DEFINED AS OUTSIDE EDGE OF PIPE TO OUTSIDE EDGE OF

TAIN A MINIMUM LATERAL CLEARANCE AS FOLLOWS: 10 FEET FROM POTABLE T FROM ALL CONDUITS, AND 4 FEET FROM ALL NATURAL GAS LINES.

GENERAL WATER NOTES:

- NO PART OF THE DRAINAGE SYSTEM SHALL BE COVERED, CONCEALED, OR PUT INTO WATER SERVICE UTILITY INFORMATION IS APPROXIMATE (NOT SURVEYED) AND IS BASED ON BEST AVAILABLE DATA. USE UNTIL IT HAS BEEN INSPECTED, TESTED, AND ACCEPTED BY THE CITY OF EVERETT
- 2. ALL WORK AND MATERIAL SHALL CONFORM TO THE CITY OF EVERETT DESIGN AND 2. POTHOLE ALL EXISTING UTILITIES TO VERIFY SIZE, ELEVATION, AND LOCATION. POTHOLING SHALL BE AT A MINIMUM 100 FEET AHEAD OF PIPE INSTALLATION. IF A CONFLICT IS ENCOUNTERED, CONSTRUCTION STANDARDS AND SPECIFICATIONS AND THE WSDOT/APWA STANDARD DEFLECT PIPE TO PROVIDE CLEARANCE BETWEEN NEW AND EXISTING UTILITIES AS APPROVED BY SPECIFICATIONS FOR ROAD, BRIDGE, AND MUNICIPAL CONSTRUCTION (CURRENT EDITION). THE ENGINEER.
- 3. APPROXIMATE LOCATIONS OF EXISTING UTILITIES HAVE BEEN OBTAINED FROM AVAILABLE NO CONNECTION TO THE EXISTING MAINS WILL BE ALLOWED EXCEPT BY MEANS OF AN APPROVED RECORDS AND ARE SHOWN FROM CONVENIENCE. THE CONTRACTOR SHALL BE BACKFLOW PREVENTION DEVICE PRIOR TO SATISFACTORY FLUSHING, TESTING, DISINFECTION, AND RESPONSIBLE FOR VERIFICATION OF LOCATIONS AND TO AVOID DAMAGE TO ANY RECEIPT OF SATISFACTORY BACTERIOLOGICAL TEST RESULTS. ADDITIONAL UTILITIES SHOWN. IF CONFLICTS WITH EXISTING UTILITIES ARISE DURING CONSTRUCTION, THE CONTRACTOR SHALL NOTIFY THE PUBLIC WORKS INSPECTOR AND CONNECTIONS TO AND TAPS ON EXISTING MAINS WILL BE MADE BY THE PUBLIC WORKS ANY CHANGES REQUIRED SHALL BE APPROVED BY THE CITY ENGINEER PRIOR TO 4. DEPARTMENT AT THE DEVELOPER'S EXPENSE. THE PUBLIC WORKS DEPARTMENT SHALL BE GIVEN COMMENCEMENT OF RELATED CONSTRUCTION ON THE PROJECT.
- AT LEAST 5 BUSINESS DAYS NOTICE FOR EACH CONNECTION. THE PUBLIC WORKS DEPARTMENT SHALL THEREAFTER DETERMINE THE DATE AND TIME AT WHICH THE CONNECTION SHALL BE MADE. 4. ALL STORM SYSTEMS WITHIN THE PUBLIC RIGHT-OF-WAY OR IN EASEMENTS MUST BE
- ALL WORK AND MATERIALS MUST CONFORM TO CITY OF EVERETT STANDARDS.
- 5. 5. ALL CATCH BASIN GRATES MUST BE STENCILED OR STAMPED "DUMP NO WASTE, DRAINS TO STREAM, LAKE, RIVER, PUGET SOUND, OR WETLAND." CHOOSE APPROPRIATE 6. A PRE-CONSTRUCTION MEETING SHALL BE HELD WITH THE CITY AND THE PORT PRIOR TO THE START OF CONSTRUCTION. THE CITY OF EVERETT PUBLIC WORKS CONSTRUCTION DIVISION MUST BE FEATURE FOR THE PROJECT NOTIFIED AT LEAST 24 HOURS PRIOR TO COMMENCEMENT OF CONSTRUCTION.
- THE DEVELOPER OR THE DEVELOPER'S AUTHORIZED AGENT SHALL NOTIFY THE PUBLIC WORKS DEPARTMENT OF A PERSON WHO CAN BE CONTACTED REGARDING PROBLEMS DURING CONSTRUCTION ON A 24 HOUR BASIS.
- 8. MAINTAIN A MINIMUM OF 10 FEET HORIZONTAL AND 18 INCH VERTICAL SEPARATION BETWEEN POTABLE AND NON-POTABLE CONVEYANCE SYSTEMS.
- 9. ALL CITY OF EVERETT VALVES SHALL BE OPERATED BY PUBLIC WORKS DEPARTMENT PERSONNEL ONLY. ALL VALVES. NEW AND EXISTING. SHALL BE ACCESSIBLE AT ALL TIMES.
- 10. CONTRACTOR TO PROVIDE ALL NECESSARY PAVEMENT REMOVAL, EXCAVATION, SHORING, DEWATERING, PIPE & FITTINGS, PIPE ALIGNMENT AND PIPE SUPPORT REQUIRED FOR PIPE HOOK-UP TO THE EXISTING WATER MAIN. VERIFY EACH CONNECTION BY POTHOLE AND FIELD VERIFY THAT ALL CONNECTIONS ARE CORRECT. ALL CORRECT FITTINGS AND CONNECTIONS MUST BE ON SITE AND VERIFIED PRIOR TO SCHEDULING CITY CREWS. CONNECTIONS TO BE MADE PER SECTION 7-09 OF THE SPECIAL PROVISIONS AND STANDARD SPECIFICATIONS.
- 11. ABANDON EXISTING WATER MAINS IN PLACE, EXCEPT WHERE EXISTING MAINS CONFLICT WITH NEW WORK. ABANDONMENT OF WATER MAINS SHALL BE PER COE SPECIFICATIONS.
- 12. NOTIFY FIRE DEPARTMENT 48 HOURS IN ADVANCE OF TAKING OUT OF SERVICE ANY FIRE HYDRANT, SPRINKLER SUPPLY, OR OTHER FIRE PROTECTION WATER EQUIPMENT.
- 13. ALL VALVES BOXES AND EXTENSIONS SHALL BE ADJUSTED TO FINISH GRADE JUST PRIOR TO FINAL PAVING, SEE COE STANDARD DRAWING 504.
- 14. FOR DRAWING CLARITY SOME CONCRETE THRUST BLOCKING MAY NOT BE SHOWN. THRUST BLOCKS AND JOINT RESTRAIN SHALL BE REQUIRED WHERE JOINTS ARE NOT RESTRAINED BY FUSING OR FLANGES. ALL JOINTS FOR FIRE HYDRANTS ASSEMBLES (INCLUDING TEE) SHALL BE RESTRAINED.
- 15. FLUSHING AND DISINFECTION OF WATER MAINS SHALL BE IN ACCORDANCE WITH SPECIAL PROVISIONS 7-09.3(24).
- 16. ALL WORK ON WATER SERVICES AND METERS SHALL BE DONE IN ACCORDANCE WITH SECTION 7-15 OF THE SPECIAL PROVISIONS AND THE CITY OF EVERETT STANDARD DRAWINGS.
- 17. INSTALL NEW WATER MAINS SO THAT 3 FEET MINIMUM OF FINAL COVER IS PROVIDED, EXCEPT IN THOSE LOCATIONS WHERE EXISTING UTILITIES TO REMAIN ARE ENCOUNTERED, WHERE NEW MAIN CONFLICTS WITH SANITARY AND STORM PIPING, OR AT NEW TELEPHONE SYSTEM STRUCTURES. MAKE GRADE ADJUSTMENTS AS REQUIRED TO AVOID CONFLICTS WITH OTHER UTILITIES AS APPROVED BY THE ENGINEER.
- 18. SAFETY SYSTEMS FOR TRENCHES AND ALL OTHER EXCAVATIONS SHALL CONFORM TO LAWS AND REGULATIONS PER WA. STATE RCW, WAC AND OSHA.
- 19. WATER SERVICE TO ALL LOTS SHALL BE MAINTAINED THROUGHOUT THE PROJECT AT ALL TIMES.


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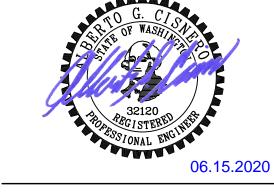
STORM DRAINAGE NOTES (COE):

STAKED BY SURVEY FOR LINE AND GRADE PRIOR TO STARTING CONSTRUCTION.



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PROJECT:

EHA BAKER HEIGHTS

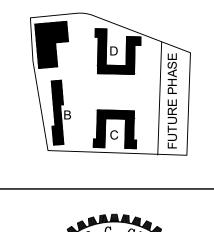

PROJECT ADDRESS:

BUILDING A: 2710 14th STREET BUILDING B: 2715 15th STREET BUILDING C: 2815 15th STREET **BUILDING D: 2810 14th STREET EVERETT, WA 98201**

OWNER: **EVERETT HOUSING AUTHORITY** 3107 COLBY AVENUE **EVERETT, WA 98201**

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MARK	DATE	DESCRIPTION	
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B	04/10/2020	DESIGN DEVELOPMENT	
A	01/07/2020	SCHEMATIC DESIGN	
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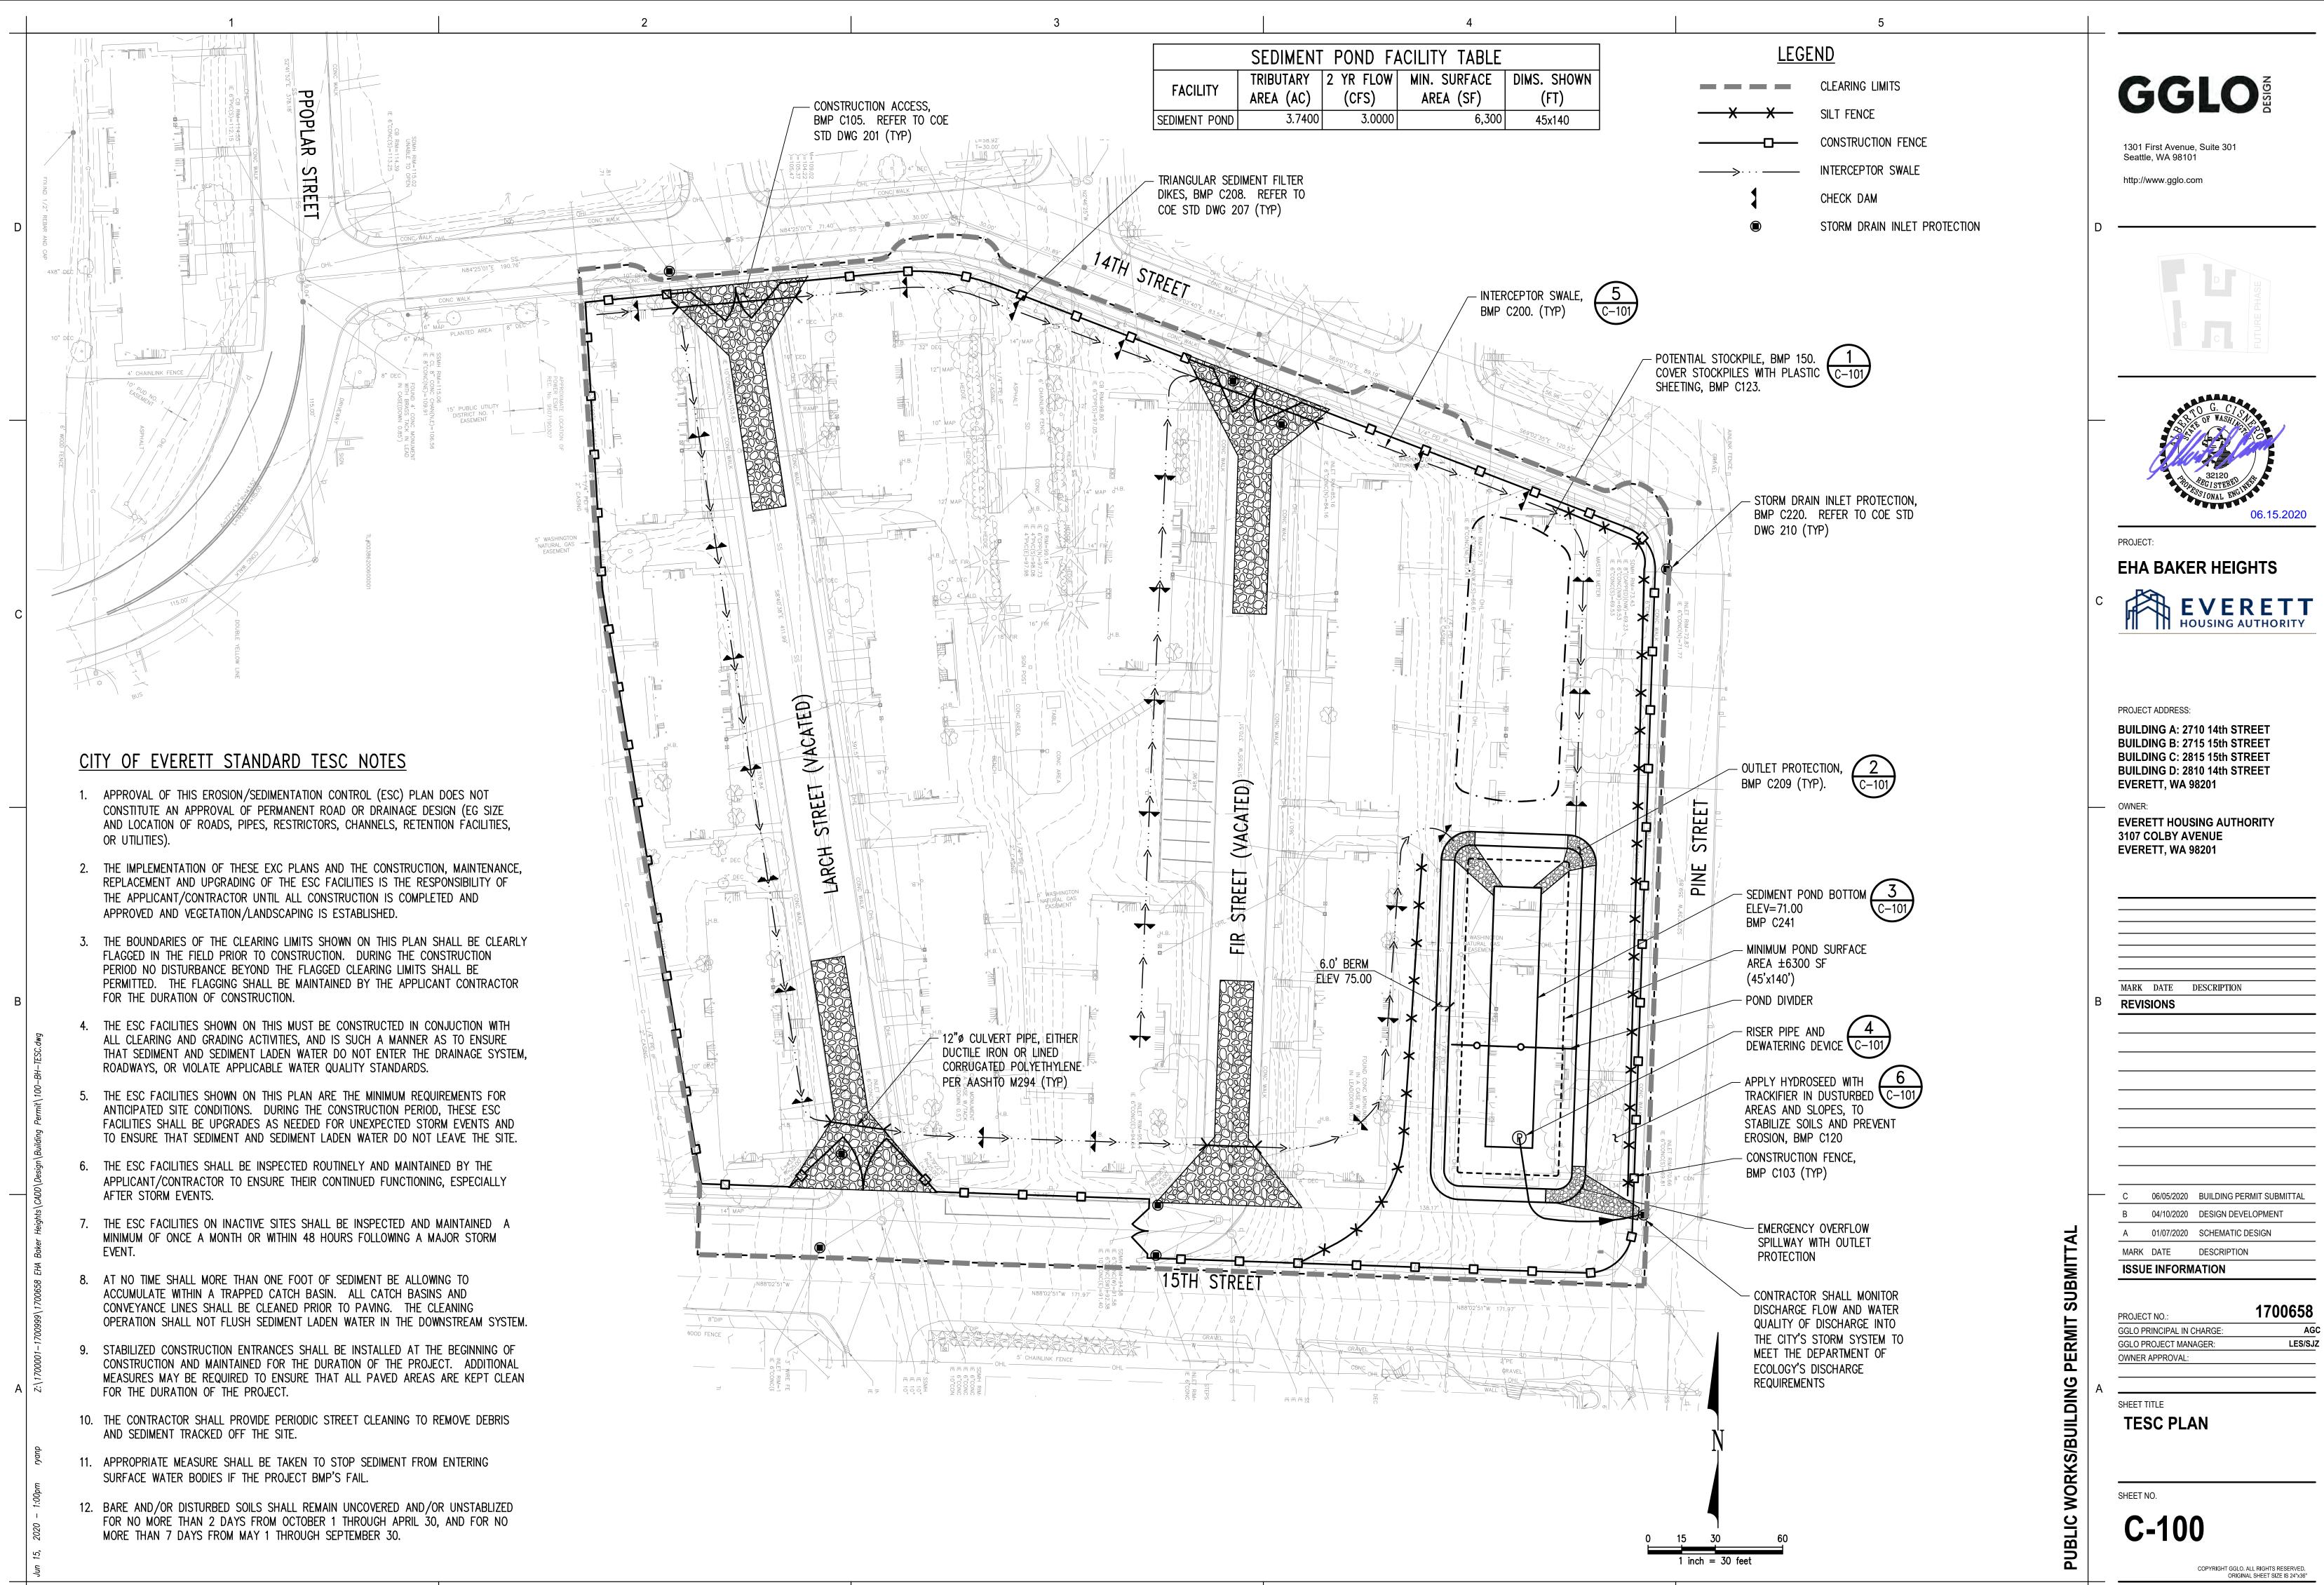
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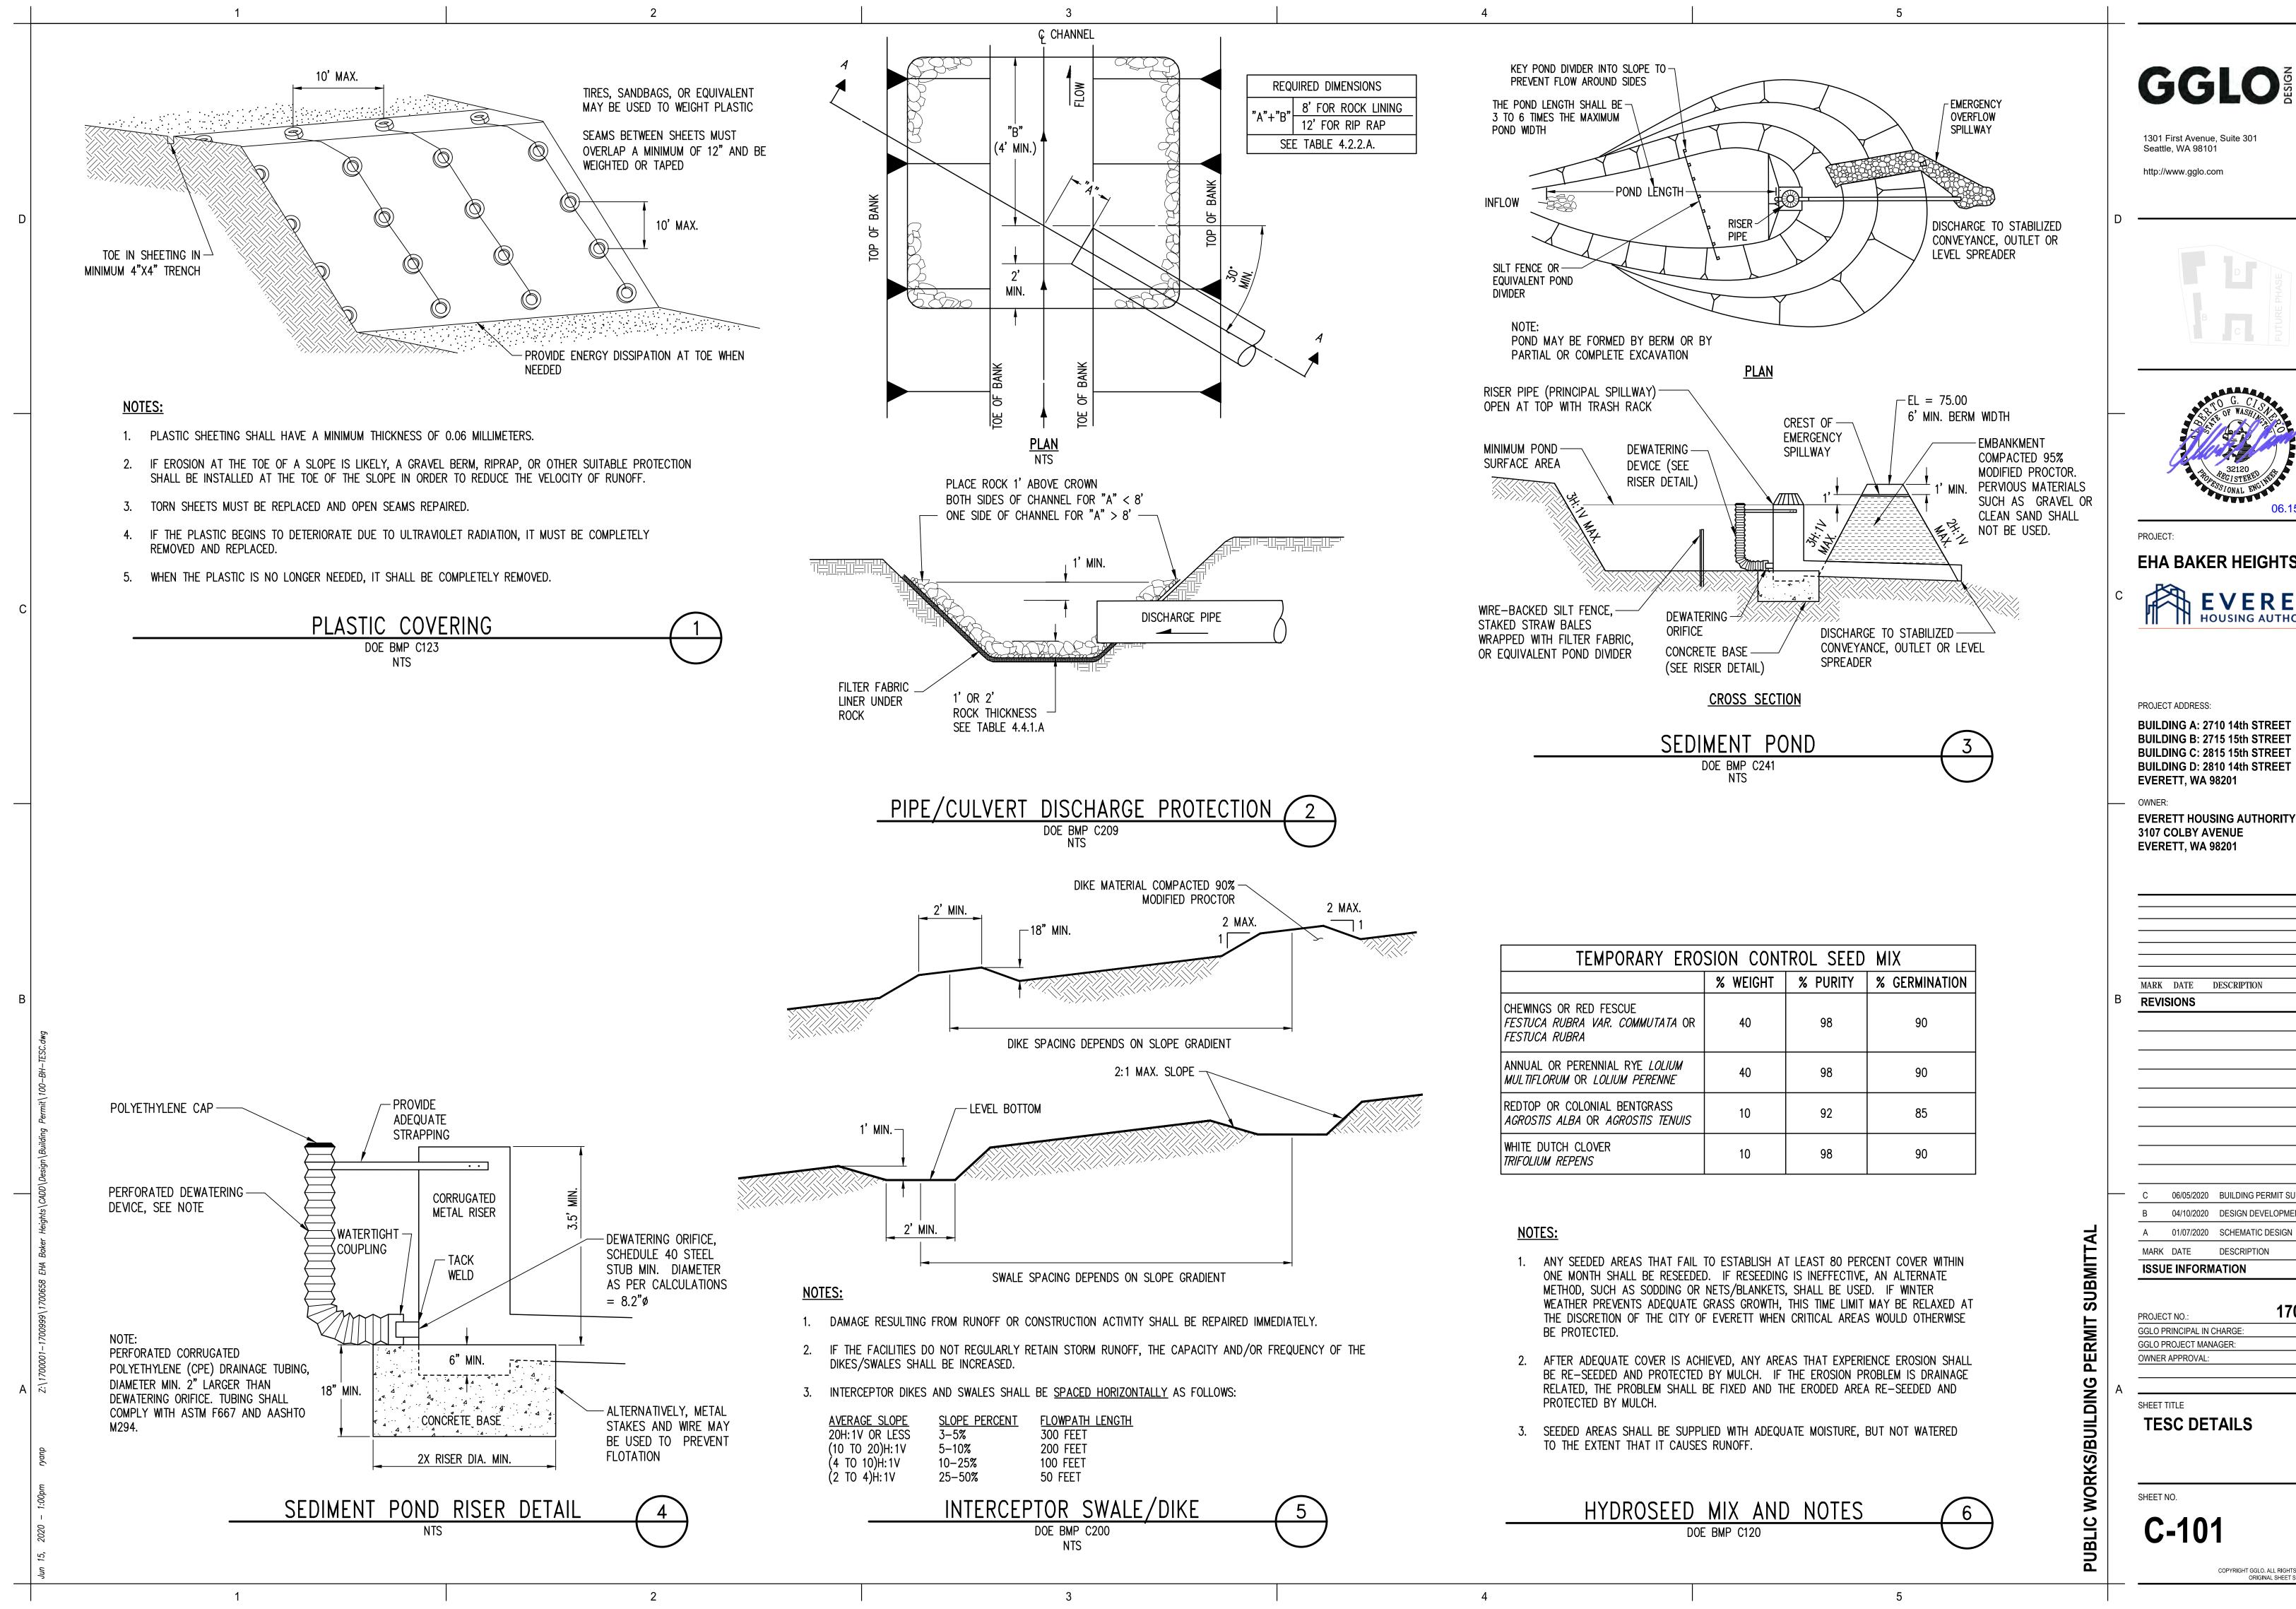
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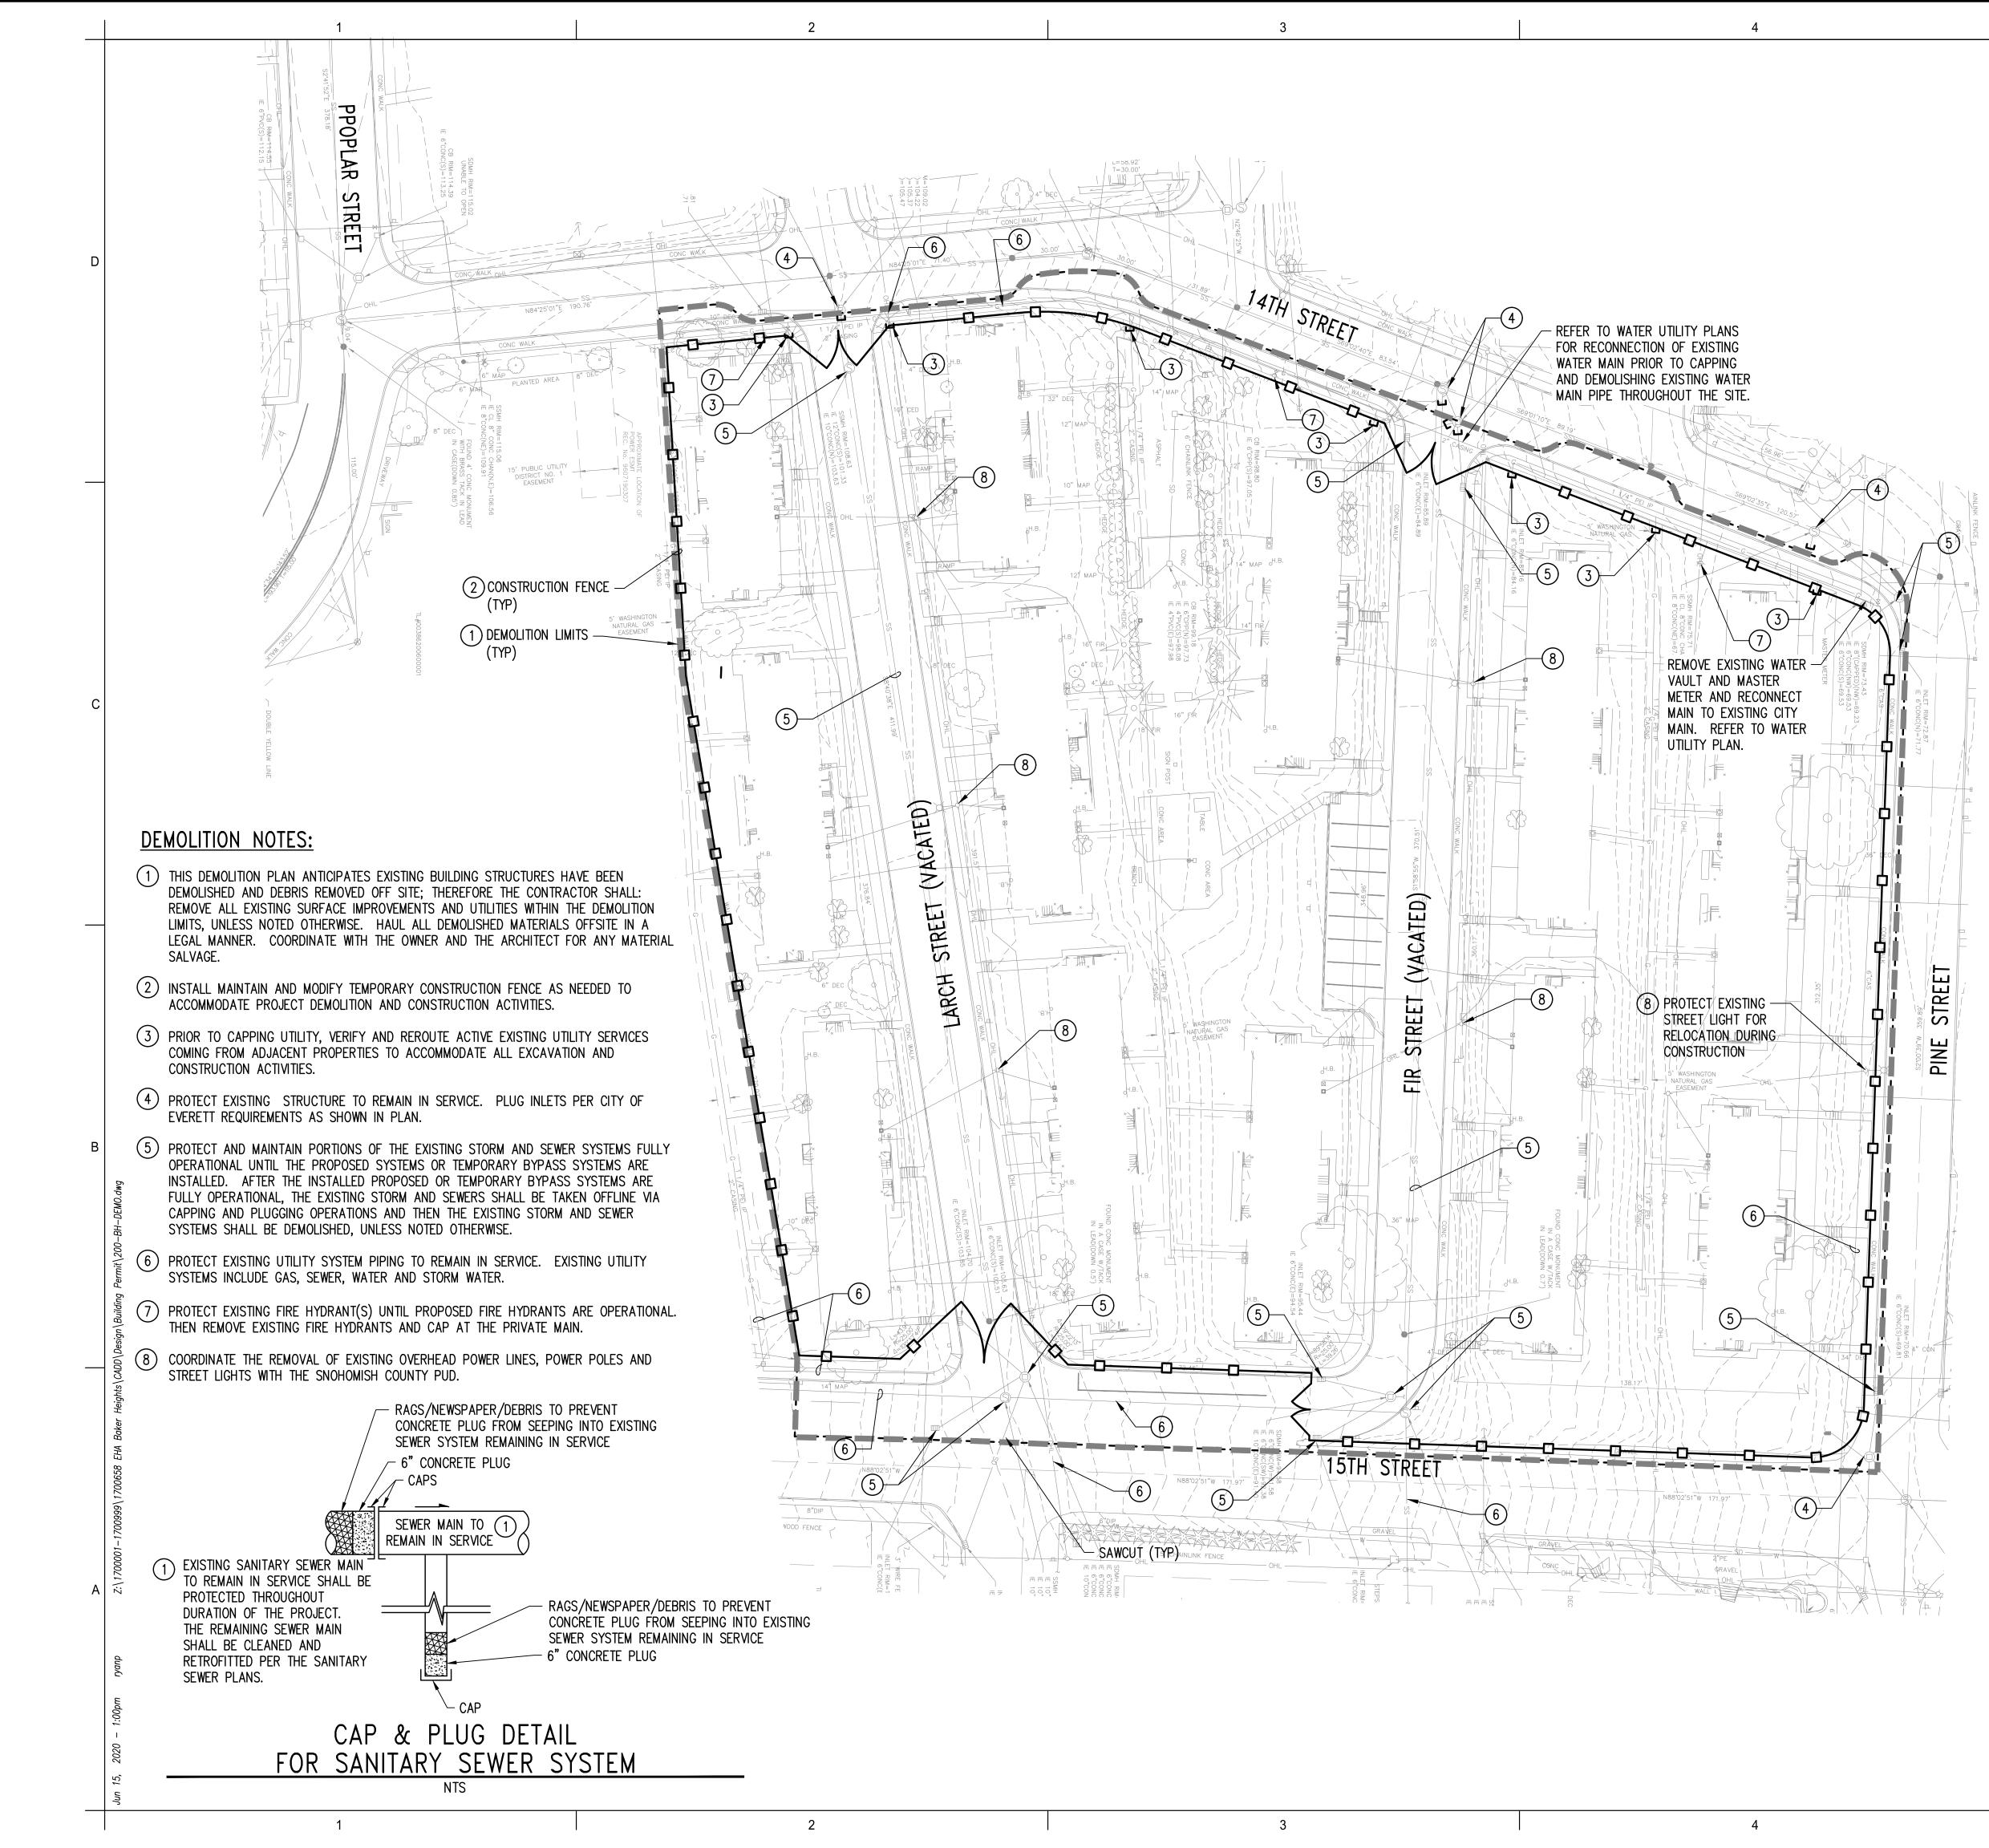
ORIGINAL SHEET SIZE IS 24"x36"






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	BUILDING D: 2810 14th STREET EVERETT, WA 98201
	OWNER:
	EVERETT HOUSING AUTHORITY 3107 COLBY AVENUE
	EVERETT, WA 98201
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GENERAL DEMOLITION NOTES:


- 1. RESIDENTIAL STRUCTURES AND FOUNDATIONS WITHIN THE DEMOLITION LIMITS HAVE BEEN REMOVED AND SERVICE UTILITIES CAPPED UNDER BUILDING DEMOLITION PLANS. CONTRACTOR SHALL REVIEW ABATEMENT AND DEMOLITION CONTRACT DOCUMENTS AND SCHEDULES TO ENSURE THE ABOVE WAS COMPLETED AS INDICATED OTHERWISE ANY REMNANTS WILL BECOME PART OF THIS DEMOLITION PLAN. CONTRACTOR SHALL COORDINATE THEIR DEMOLITION SCHEDULE ACCORDINGLY. BELOW GRADE UTILITIES REMAINING ON THE PROJECT SITE AND SHALL BE DEMOLISHED, PER THESE NOTES.
- 2. CONTRACTOR TO COORDINATE TREE PROTECTION WITH OWNER'S REPRESENTATIVE. CONTRACTOR IS RESPONSIBLE FOR THE TREE PROTECTION AND THE HEALTH OF THE TREES FOR THE DURATION OF THE PROJECT.
- 3. ALL EXISTING SURFACE FEATURES REMAINING WITHIN THE DEMOLITION LIMITS SHALL BE REMOVED IN THEIR ENTIRETY, UNLESS OTHERWISE NOTED.
- 4. ALL ASPHALT AND CONCRETE RUBBLE GENERATED BY DEMOLITION ACTIVITIES SHALL BE REMOVED AND RECYCLED IN A LEGAL MANNER.
- 5. ALL UTILITY STRUCTURES SHALL BE REMOVED FROM WITHIN THE DEMOLITION LIMITS IF RIM TO INVERT IS 5 FEET OR LESS. FOR UTILITY STRUCTURES DEEPER THAN 5 FEET FROM RIM TO INVERT, DEMOLISH AND REMOVE THE TOP 5 FEET OF THE STRUCTURE AND FILL WITH CDF, UNLESS OTHERWISE NOTED. ASSOCIATED PIPES SHALL BE CAPPED TO PREVENT THE MOVEMENT OF GROUNDWATER. EXCAVATION SHALL BE BACKFILLED WITH COMPACTED STRUCTURAL FILL.
- 6. ALL WATER VALVES, POWER AND COMMUNICATION VAULTS/HANDHOLES ENCOUNTERED WITHIN DEMOLITION LIMITS SHALL BE REMOVED AND DISPOSED OFF-SITE IN A LEGAL MANNER.
- 7. EXISTING UTILITY PIPES 8"Ø AND GREATER INTERCEPTED BY TRENCHING OPERATIONS SHALL BE GROUTED BOTH SIDES OF TRENCH TO PREVENT THE MOVEMENT OF GROUNDWATER.
- 8. ALL PRODUCTS OF DEMOLITION ACTIVITIES SHALL BE REMOVED AND LEGALLY DISPOSED OF OFF-SITE. ASPHALT AND CONCRETE SHALL BE RECYCLED OFF-SITE.
- 9. ALL UTILITIES AND ASSOCIATED STRUCTURES SHOWN TO REMAIN SHALL BE PROTECTED BY CONTRACTOR. ALL UTILITIES AND STRUCTURES SHOWN TO BE DEMOLISHED/ABANDONED SHALL BE PER RESPECTIVE UTILITY JURISDICTION REQUIREMENTS.
- 10. A PERIMETER CHAIN LINK CONSTRUCTION FENCE WAS INSTALLED DURING THE BUILDING DEMOLITION CONTRACT. DEMOLITION CONTRACTOR SHALL INHERIT THIS FENCE AND MAINTAIN IT THROUGH THE CONSTRUCTION PERIOD AND ADD ANY ADDITIONAL FENCE AND GATES AS NEEDED. CONTRACTOR TO LEAVE INSTALLED FENCING IN GOOD WORKING CONDITION. TESC MEASURES SHALL BE REMOVED AFTER GROUND HAS BEEN STABILIZED, UNLESS NEEDED BY FURTHER CONSTRUCTION OR REQUIRED BY COE INSPECTOR.
- 11. ALL UTILITY PIPES 8 INCHES OR GREATER IN DIAMETER AND LOCATED BELOW BUILDING AREAS MAY BE LEFT IN PLACE PROVIDED THEY ARE FULLY GROUTED. ALL UTILITIES LESS THAN 8 INCHES IN DIAMETER AND LOCATED BENEATH BUILDING AREAS MAY BE LEFT IN PLACE PROVIDED THEY ARE CAPPED AND OR PLUGGED WITH GROUT. UTILITY PIPES ENCOUNTERED OUTSIDE OF BUILDING AREAS DURING REDEVELOPMENT ACTIVITIES SHOULD BE PLUGGED, CAPPED, OR REMOVED TO PREVENT MOVEMENT OF GROUNDWATER.
- 12. ANY UTILITIES DISCOVERED DURING CONSTRUCTION OPERATIONS SHALL BE REMOVED TO A POINT, 3 FEET BELOW FINISH GRADE. THE UTILITY SHALL BE CAPPED OR PLUGGED WITH GROUT TO PREVENT THE MOVEMENT OF GROUNDWATER. ABANDONED UTILITY LINES UNDER PROPOSED BUILDINGS SHOULD BE IDENTIFIED DURING CONSTRUCTION AND EXISTING TRENCH BACKFILL SHOULD BE REMOVED AND REPLACED PER RECOMMENDATIONS OF THE GEOTECHNICAL REPORT.
- 13. CONTRACTOR IS RESPONSIBLE FOR CONTINUED OPERATION OF EXISTING AND TEMPORARY STORM SYSTEMS. CONTRACTOR SHALL REVIEW AND FIELD VERIFY THAT THE REMAINING PORTIONS OF THE EXISTING STORM DRAINAGE SYSTEM WITHIN THE RIGHT OF WAY, TEMPORARY STORM MEASURES AND PROPOSED GRADING ARE NOT IN CONFLICT. WHERE CONFLICTS OCCUR, CONTRACTOR SHALL PROVIDE TEMPORARY PUMPING OR ALTERNATIVE SYSTEMS.
- 14. CONTRACTOR SHALL PREPARE A COLOR CODED RECORD PLAN NOTING PLUGGED/ABANDONED/REMOVED UTILITIES FOR USE BY THE SITE DEVELOPMENT AND BUILDING CONTRACTOR'S TO COORDINATE, PLAN, AND SCHEDULE THEIR CONSTRUCTION EFFORTS ACCORDINGLY.






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PROJECT:

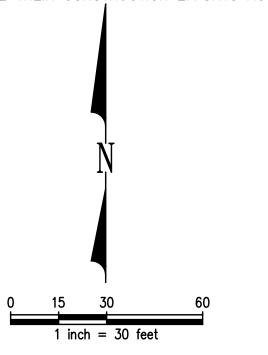EHA BAKER HEIGHTS

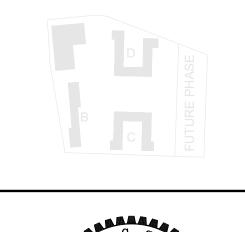

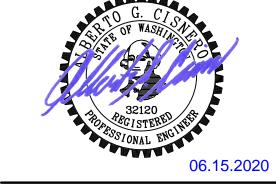PROJECT ADDRESS:

BUILDING A: 2710 14th STREET BUILDING B: 2715 15th STREET BUILDING C: 2815 15th STREET BUILDING D: 2810 14th STREET EVERETT, WA 98201

OWNER: EVERETT HOUSING AUTHORITY 3107 COLBY AVENUE EVERETT, WA 98201

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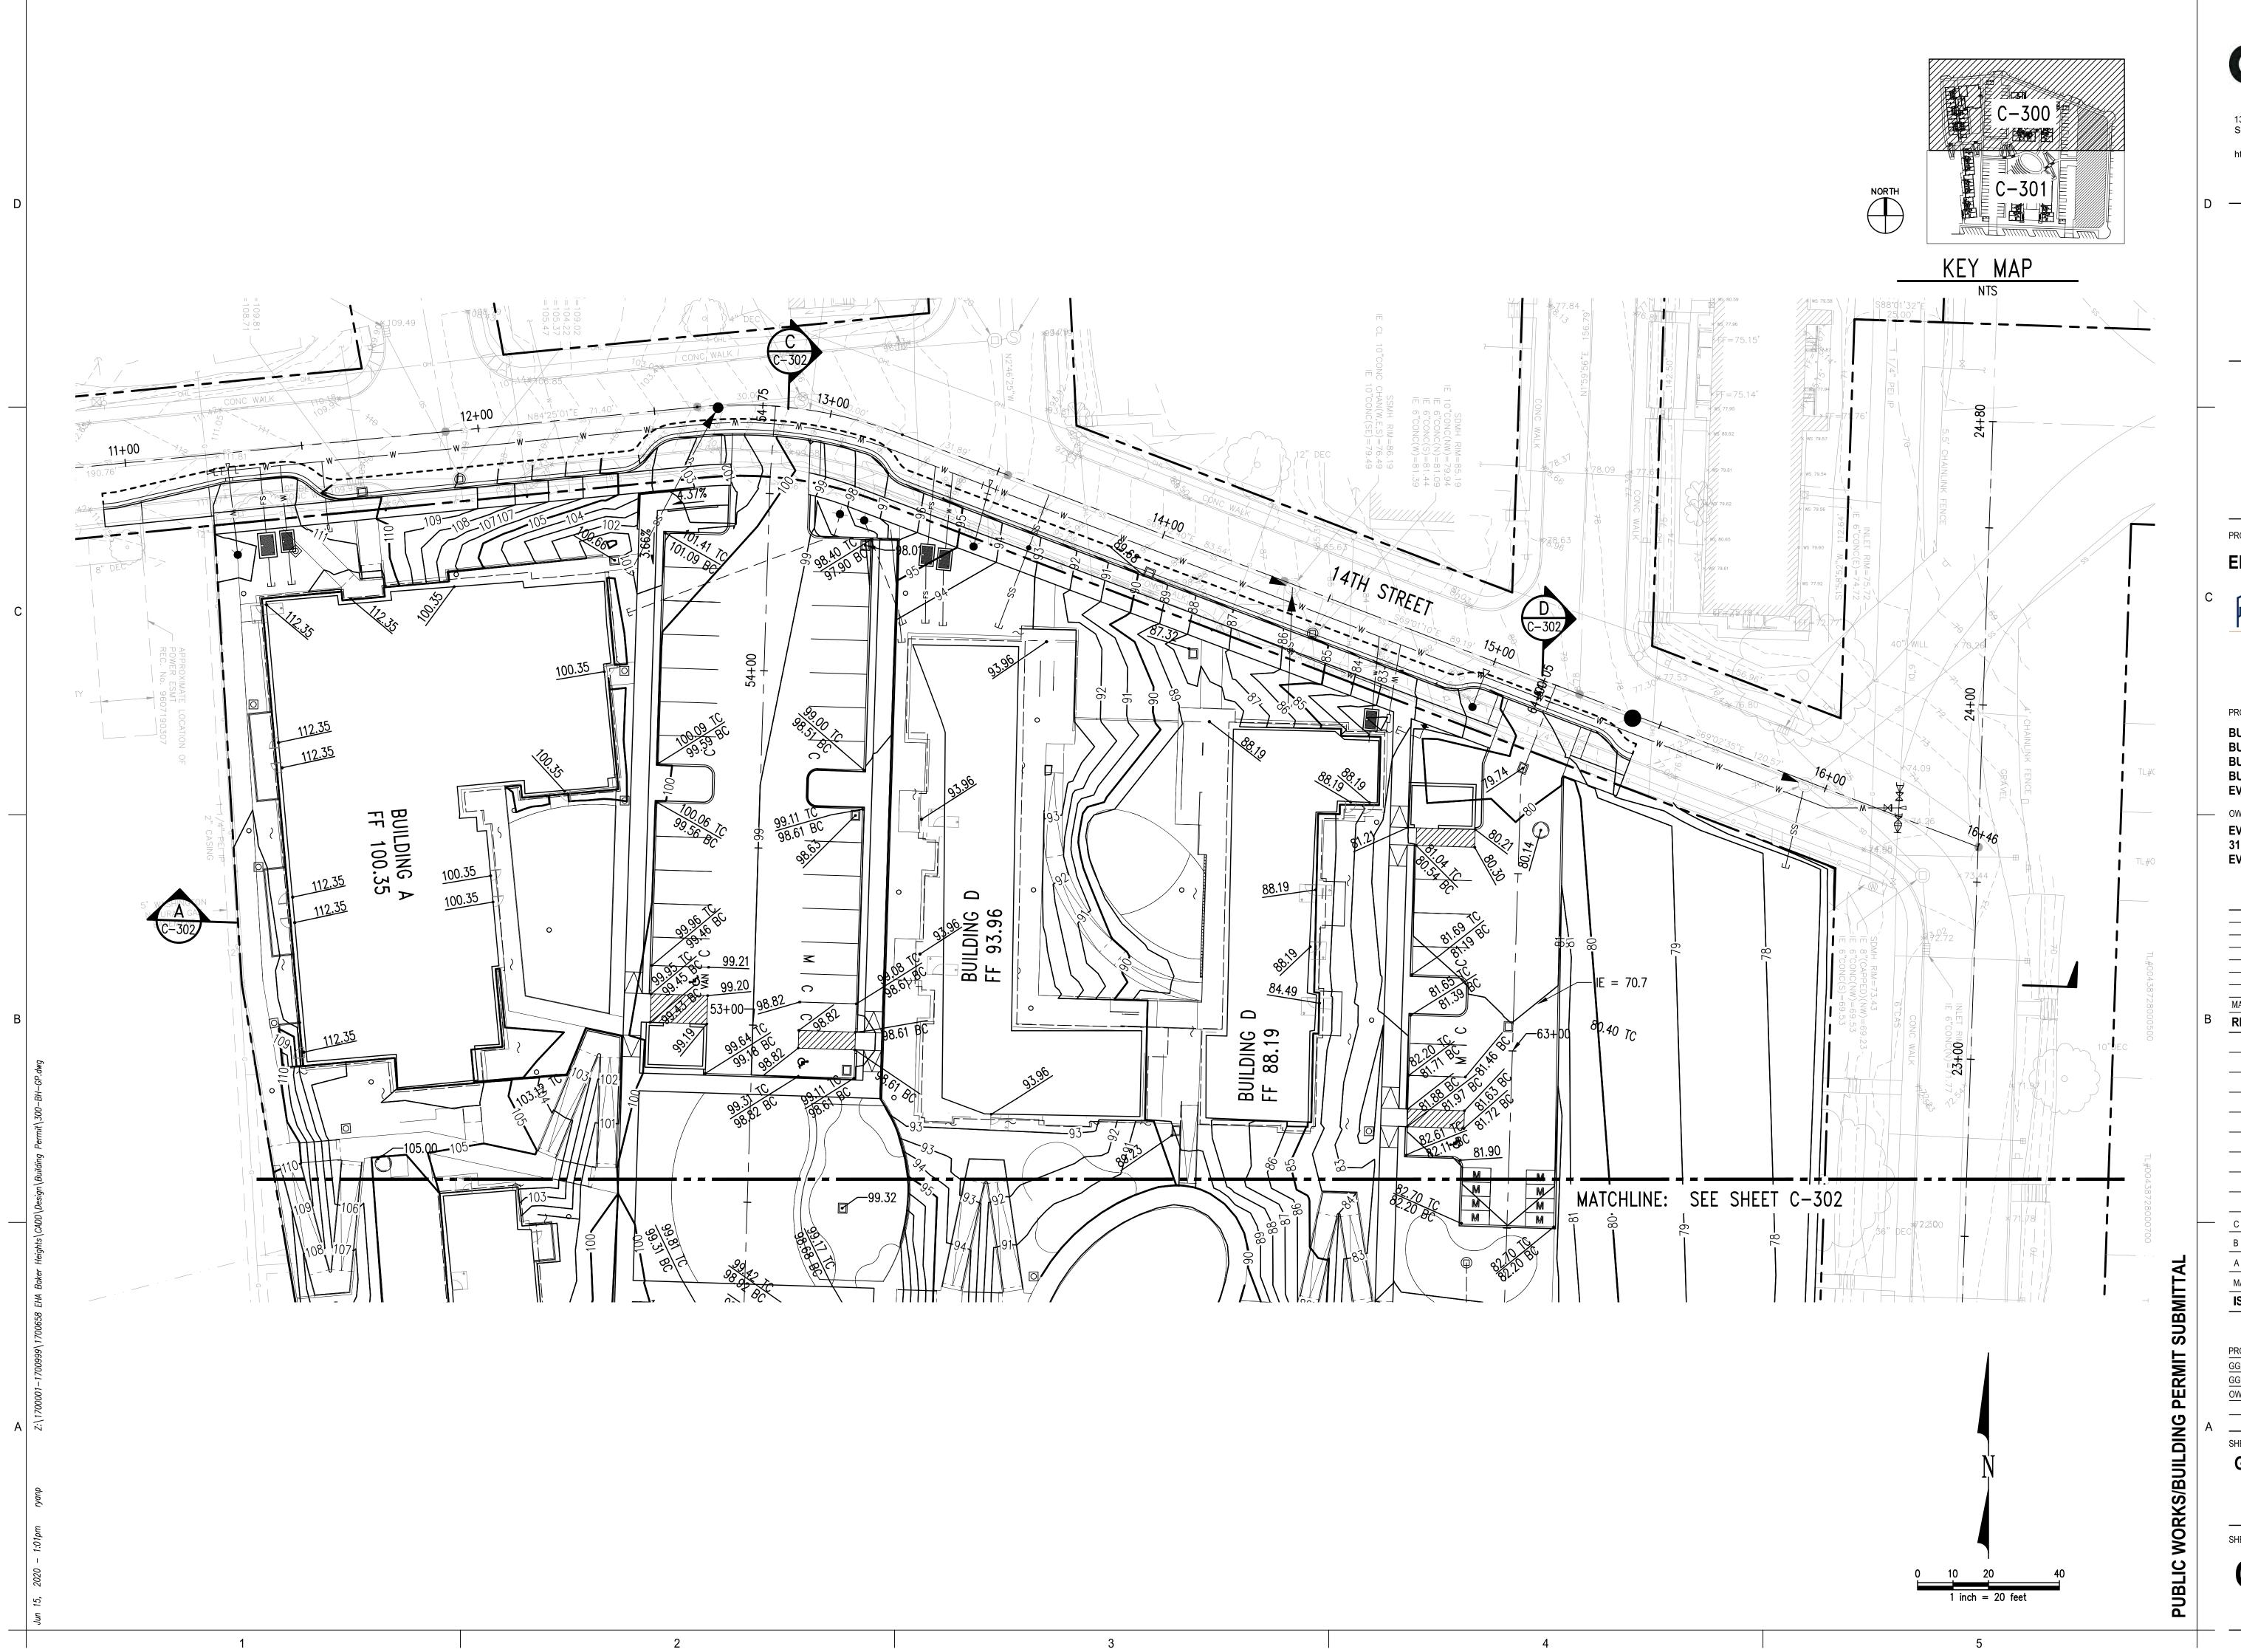
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GGLO PROJECT MANAGER:	LES/SJZ
OWNER APPROVAL:	

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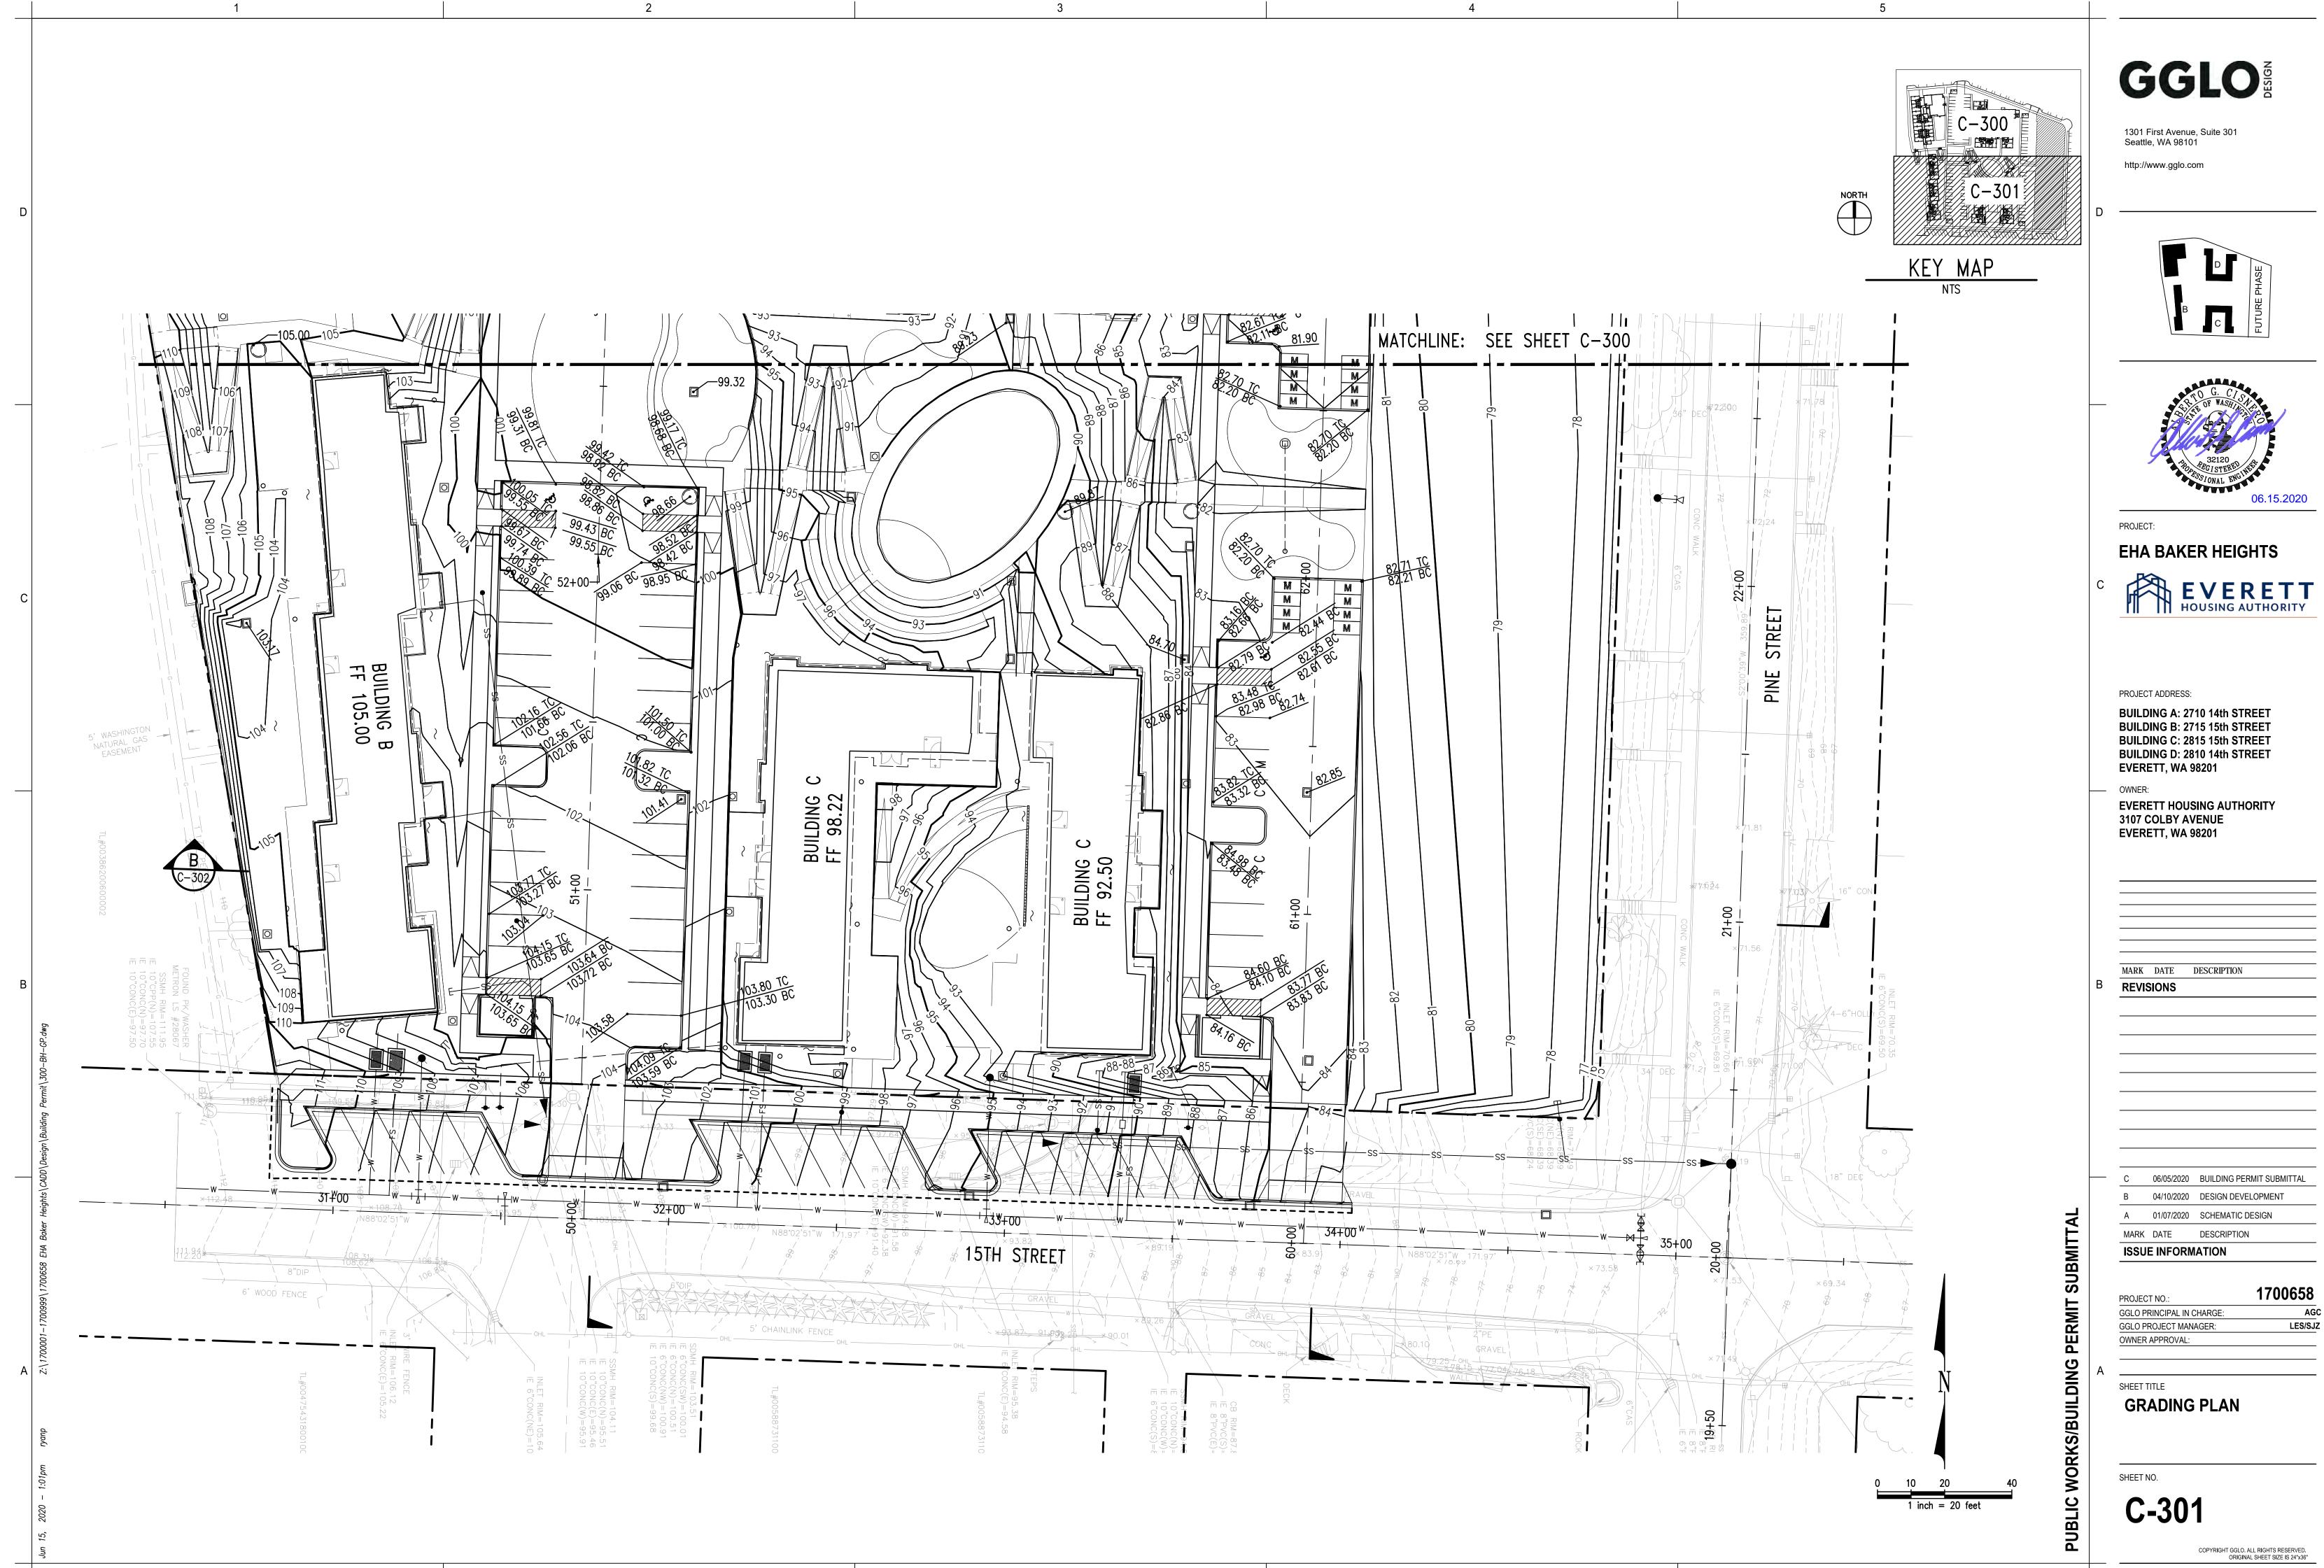
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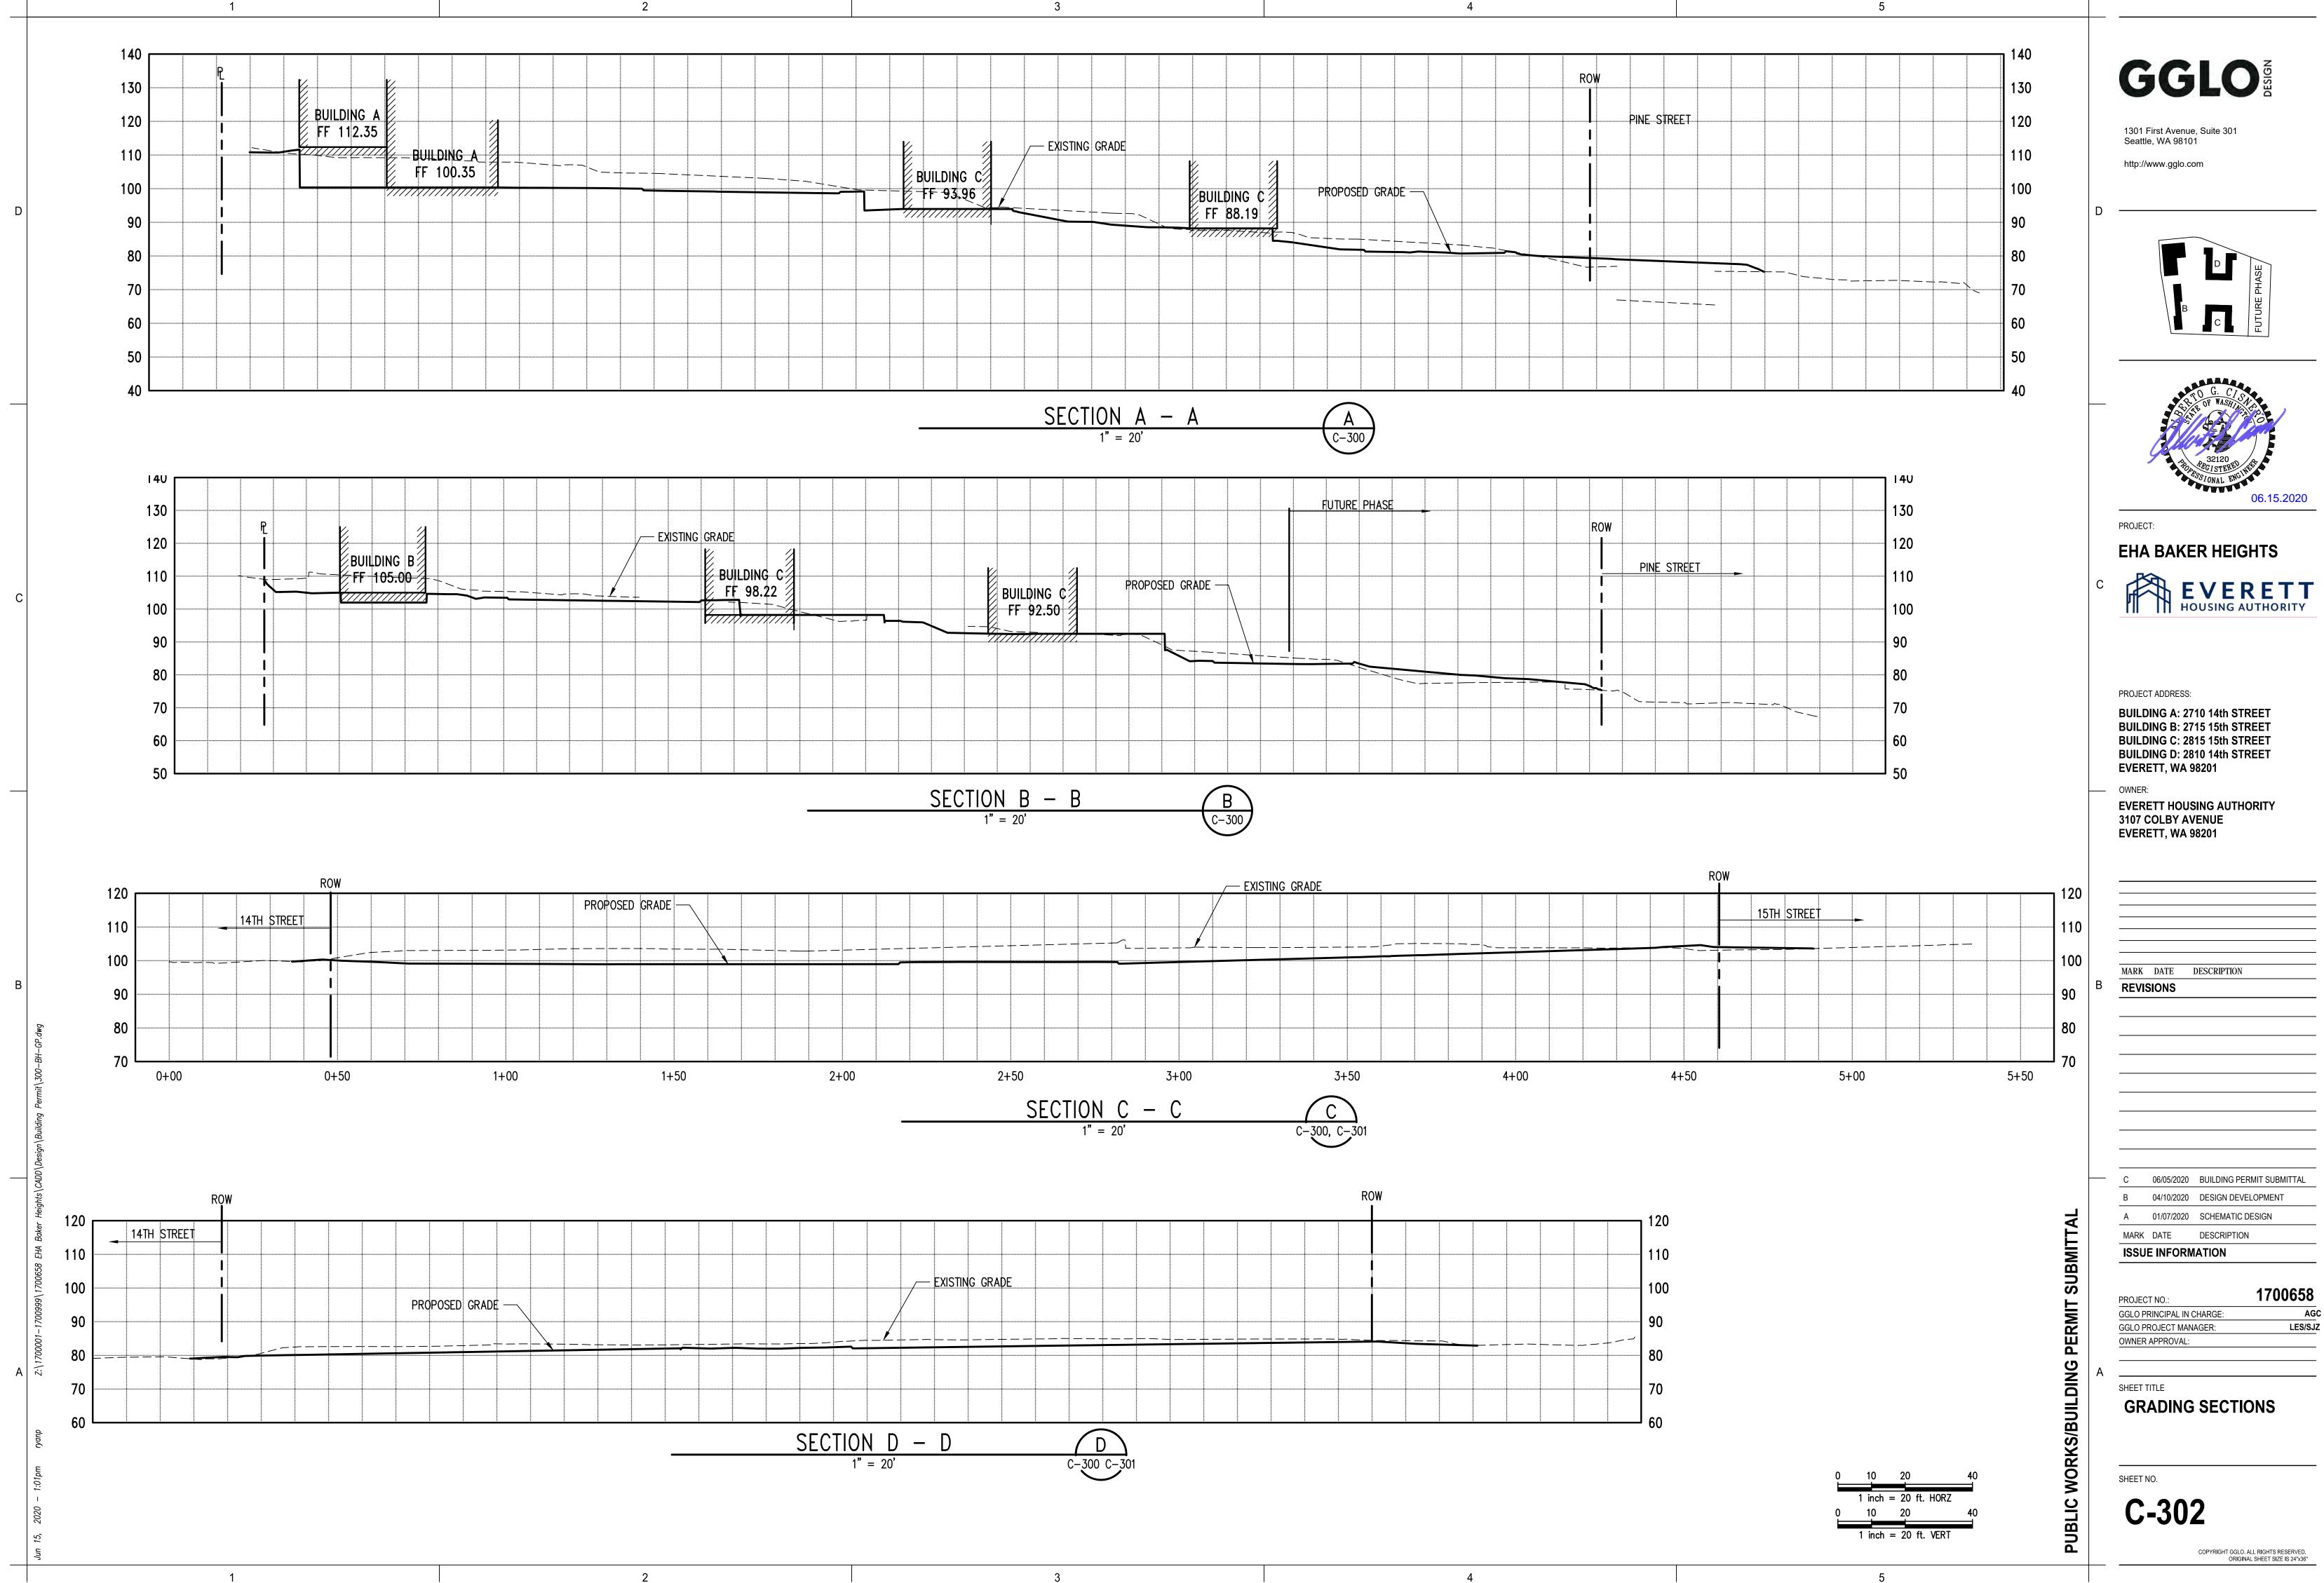
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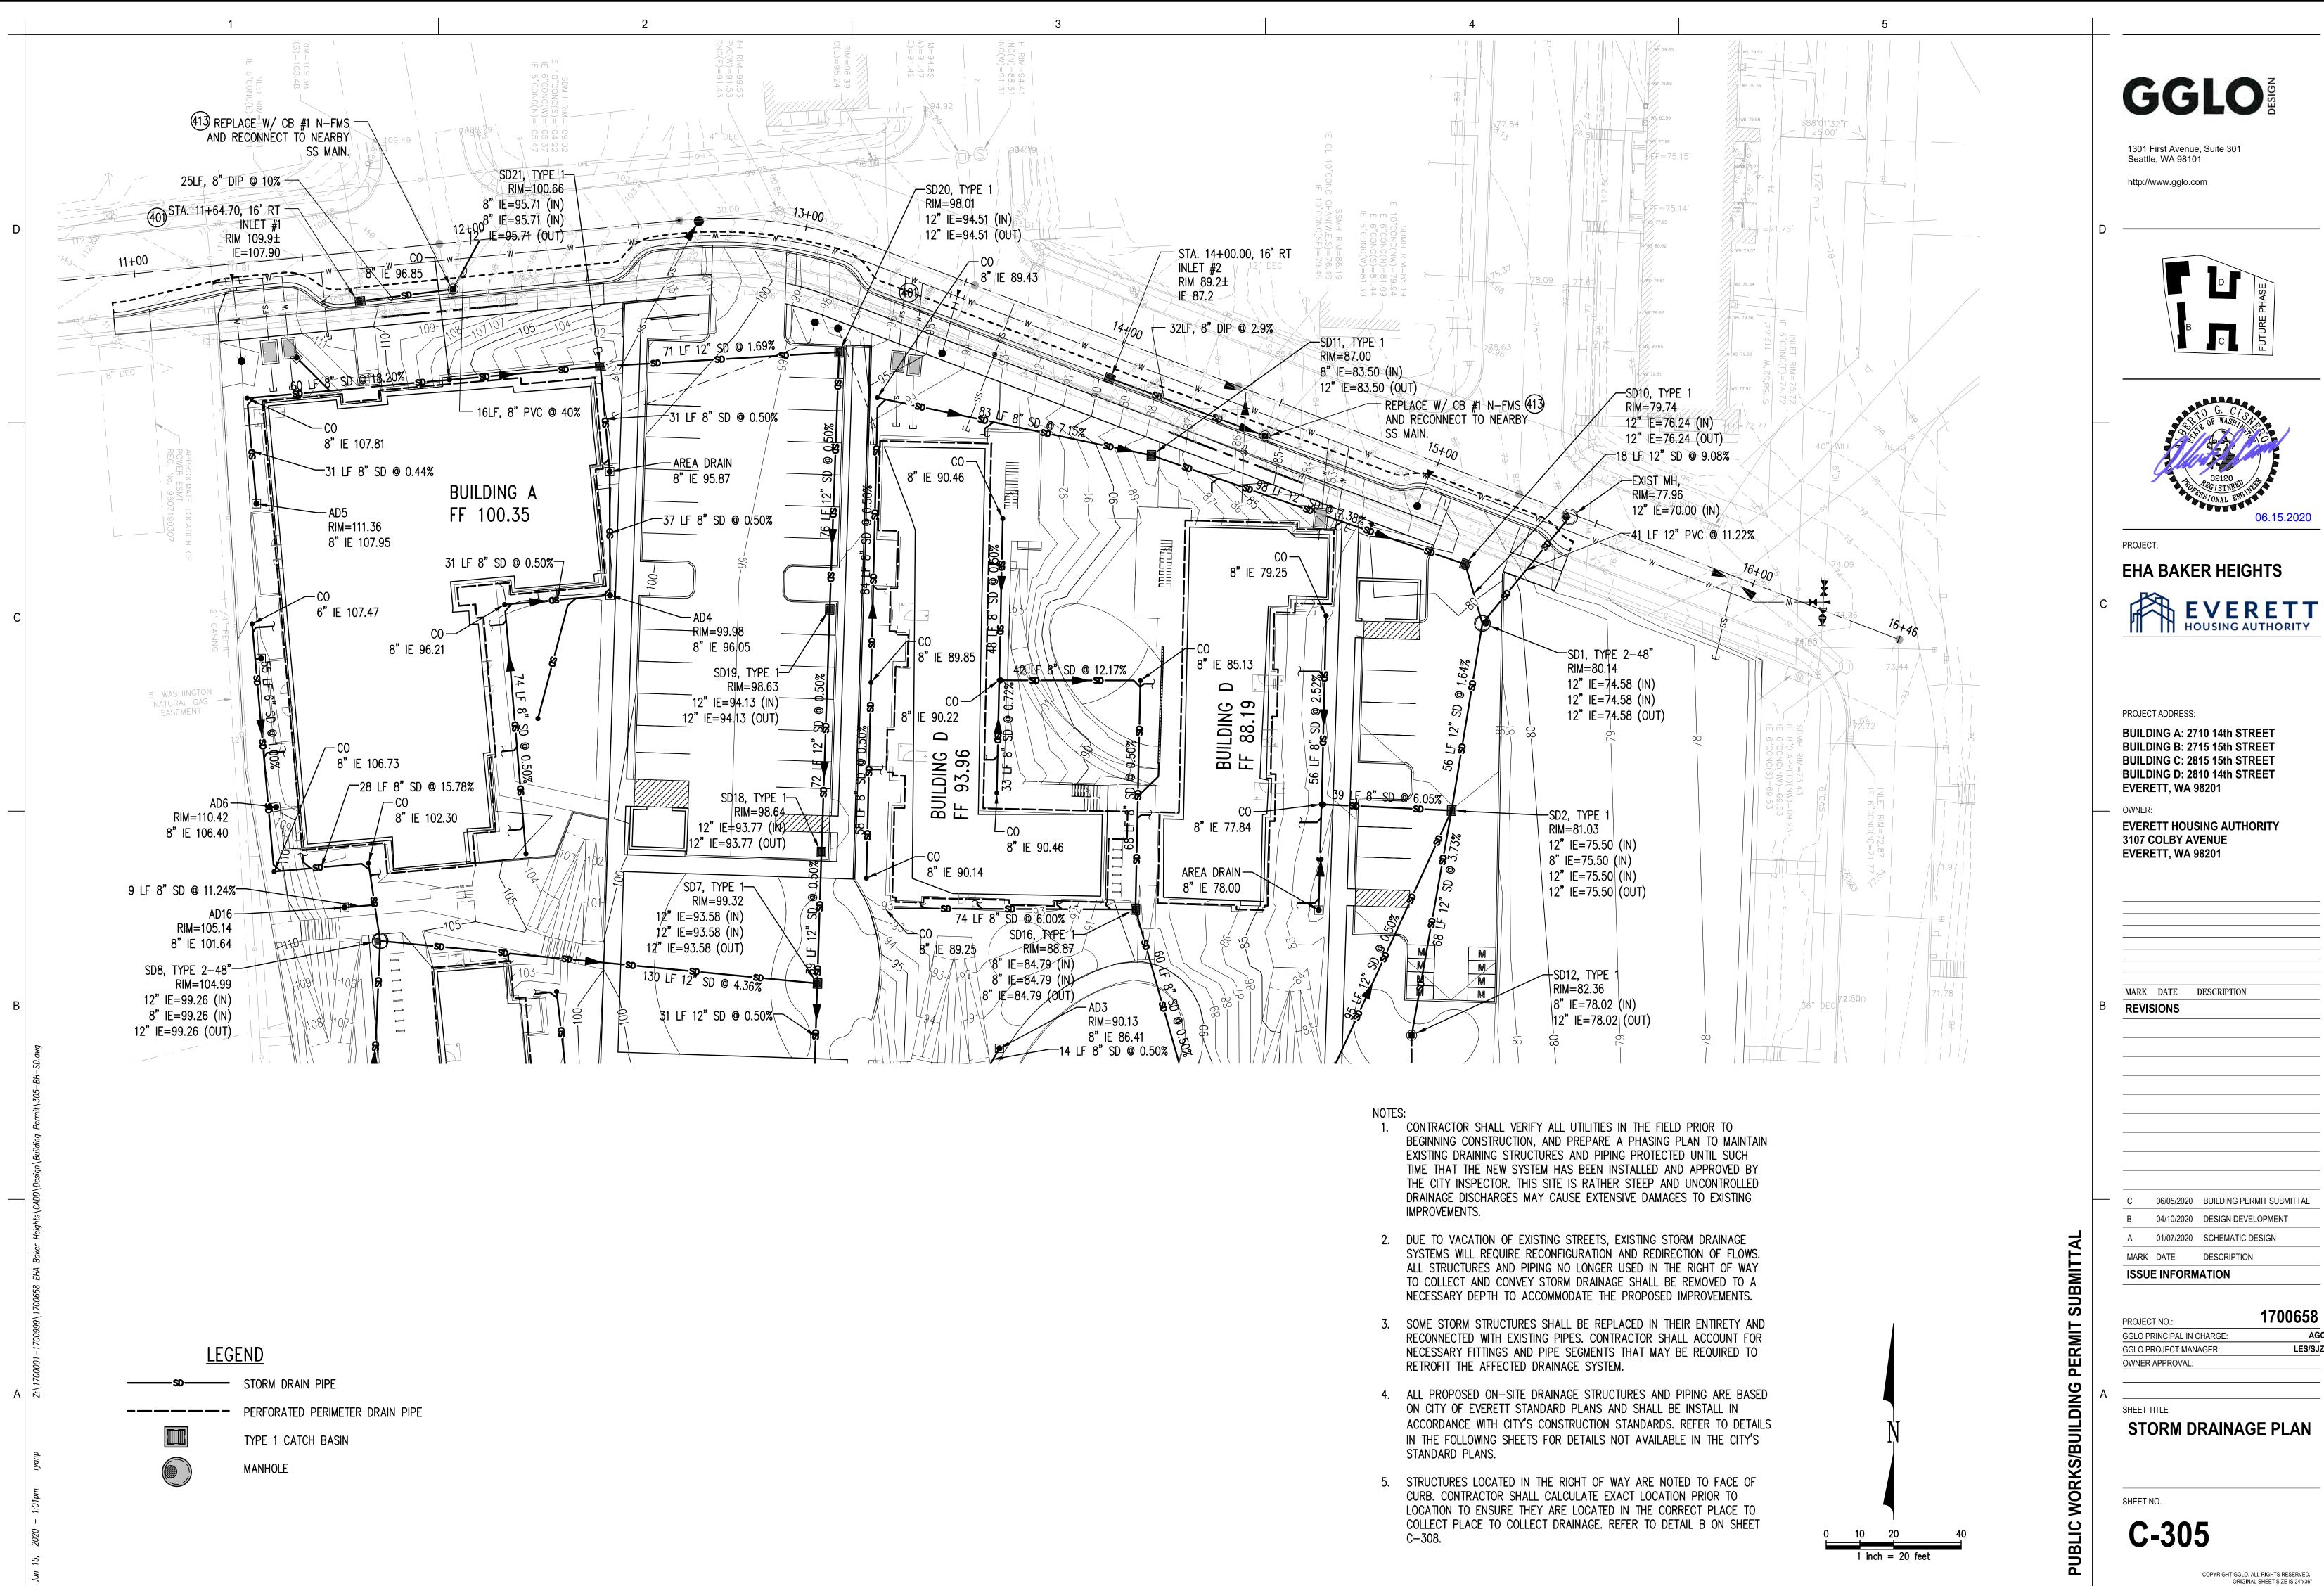


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AGC


LES/SJZ

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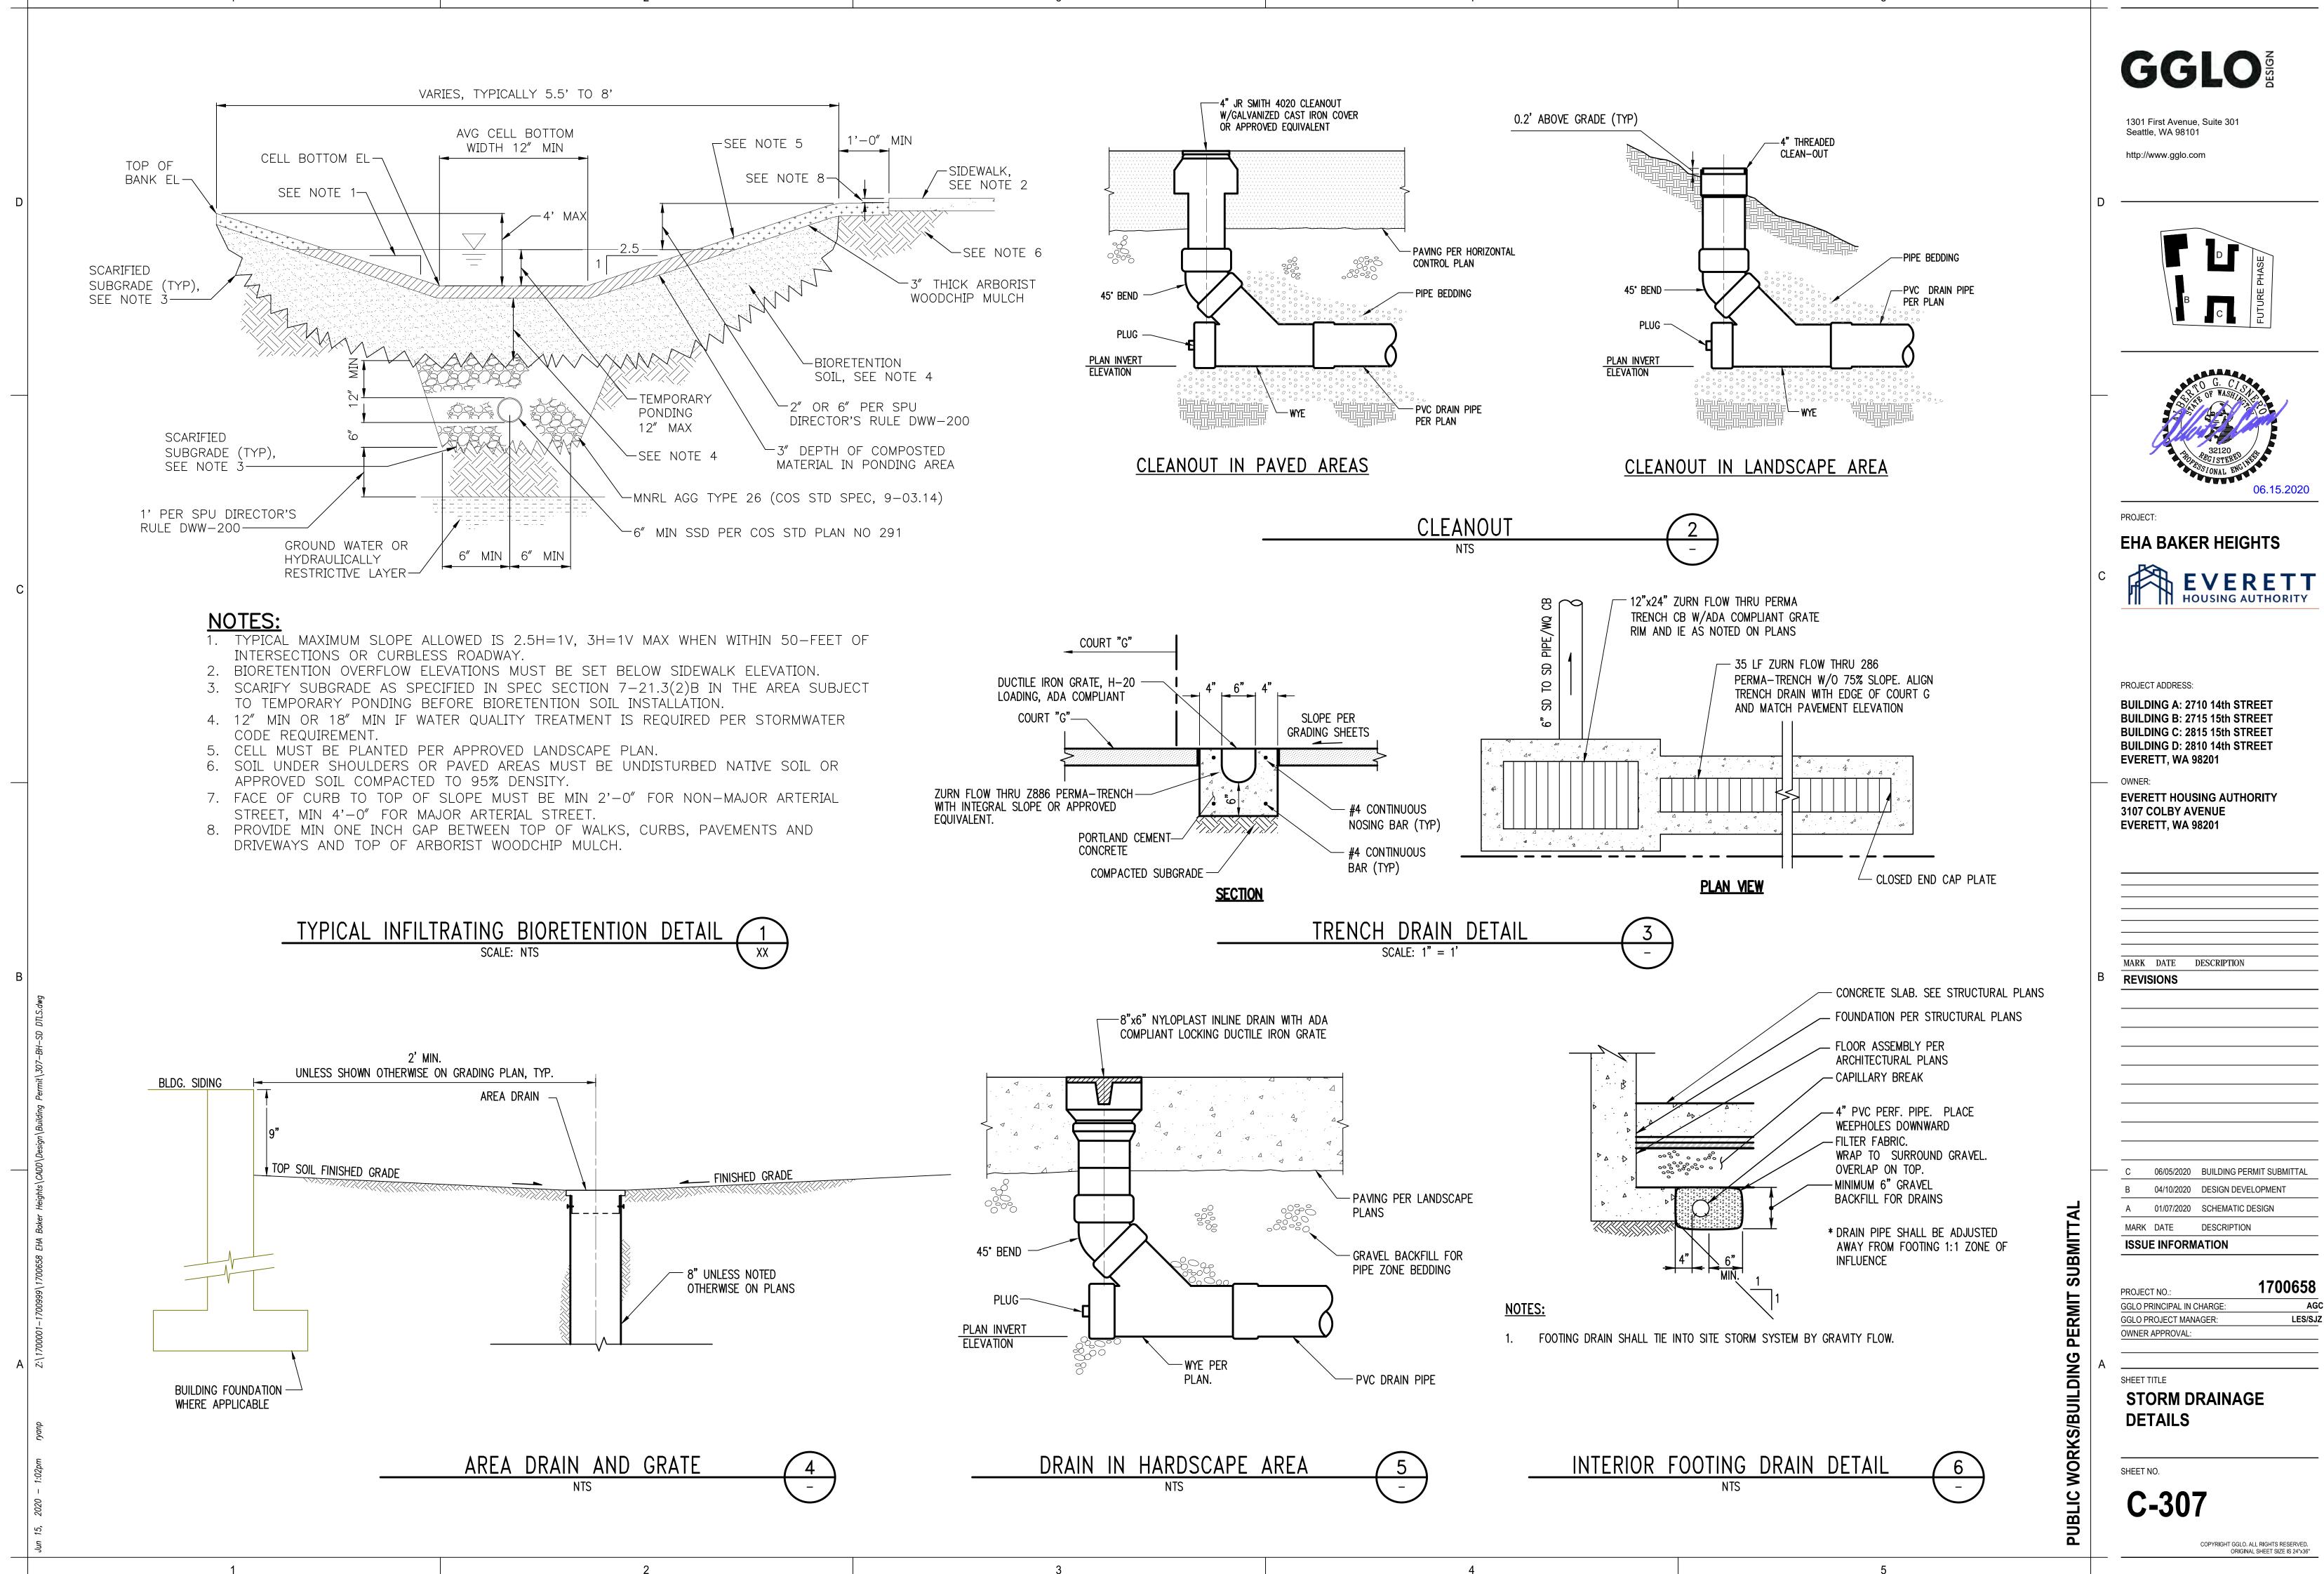
06.15.2020 PROJECT: EHA BAKER HEIGHTS HOUSING AUTHORITY PROJECT ADDRESS: **BUILDING A: 2710 14th STREET** BUILDING B: 2715 15th STREET **BUILDING C: 2815 15th STREET BUILDING D: 2810 14th STREET EVERETT, WA 98201** OWNER: **EVERETT HOUSING AUTHORITY 3107 COLBY AVENUE** EVERETT, WA 98201 MARK DATE DESCRIPTION REVISIONS 06/05/2020 BUILDING PERMIT SUBMITTAL 04/10/2020 DESIGN DEVELOPMENT A 01/07/2020 SCHEMATIC DESIGN MARK DATE DESCRIPTION **ISSUE INFORMATION** 1700658 PROJECT NO .: GGLO PRINCIPAL IN CHARGE: AGC LES/SJZ GGLO PROJECT MANAGER: OWNER APPROVAL: SHEET TITLE STORM DRAINAGE PLAN SHEET NO. **C-306**


1301 First Avenue, Suite 301


Seattle, WA 98101

http://www.gglo.com
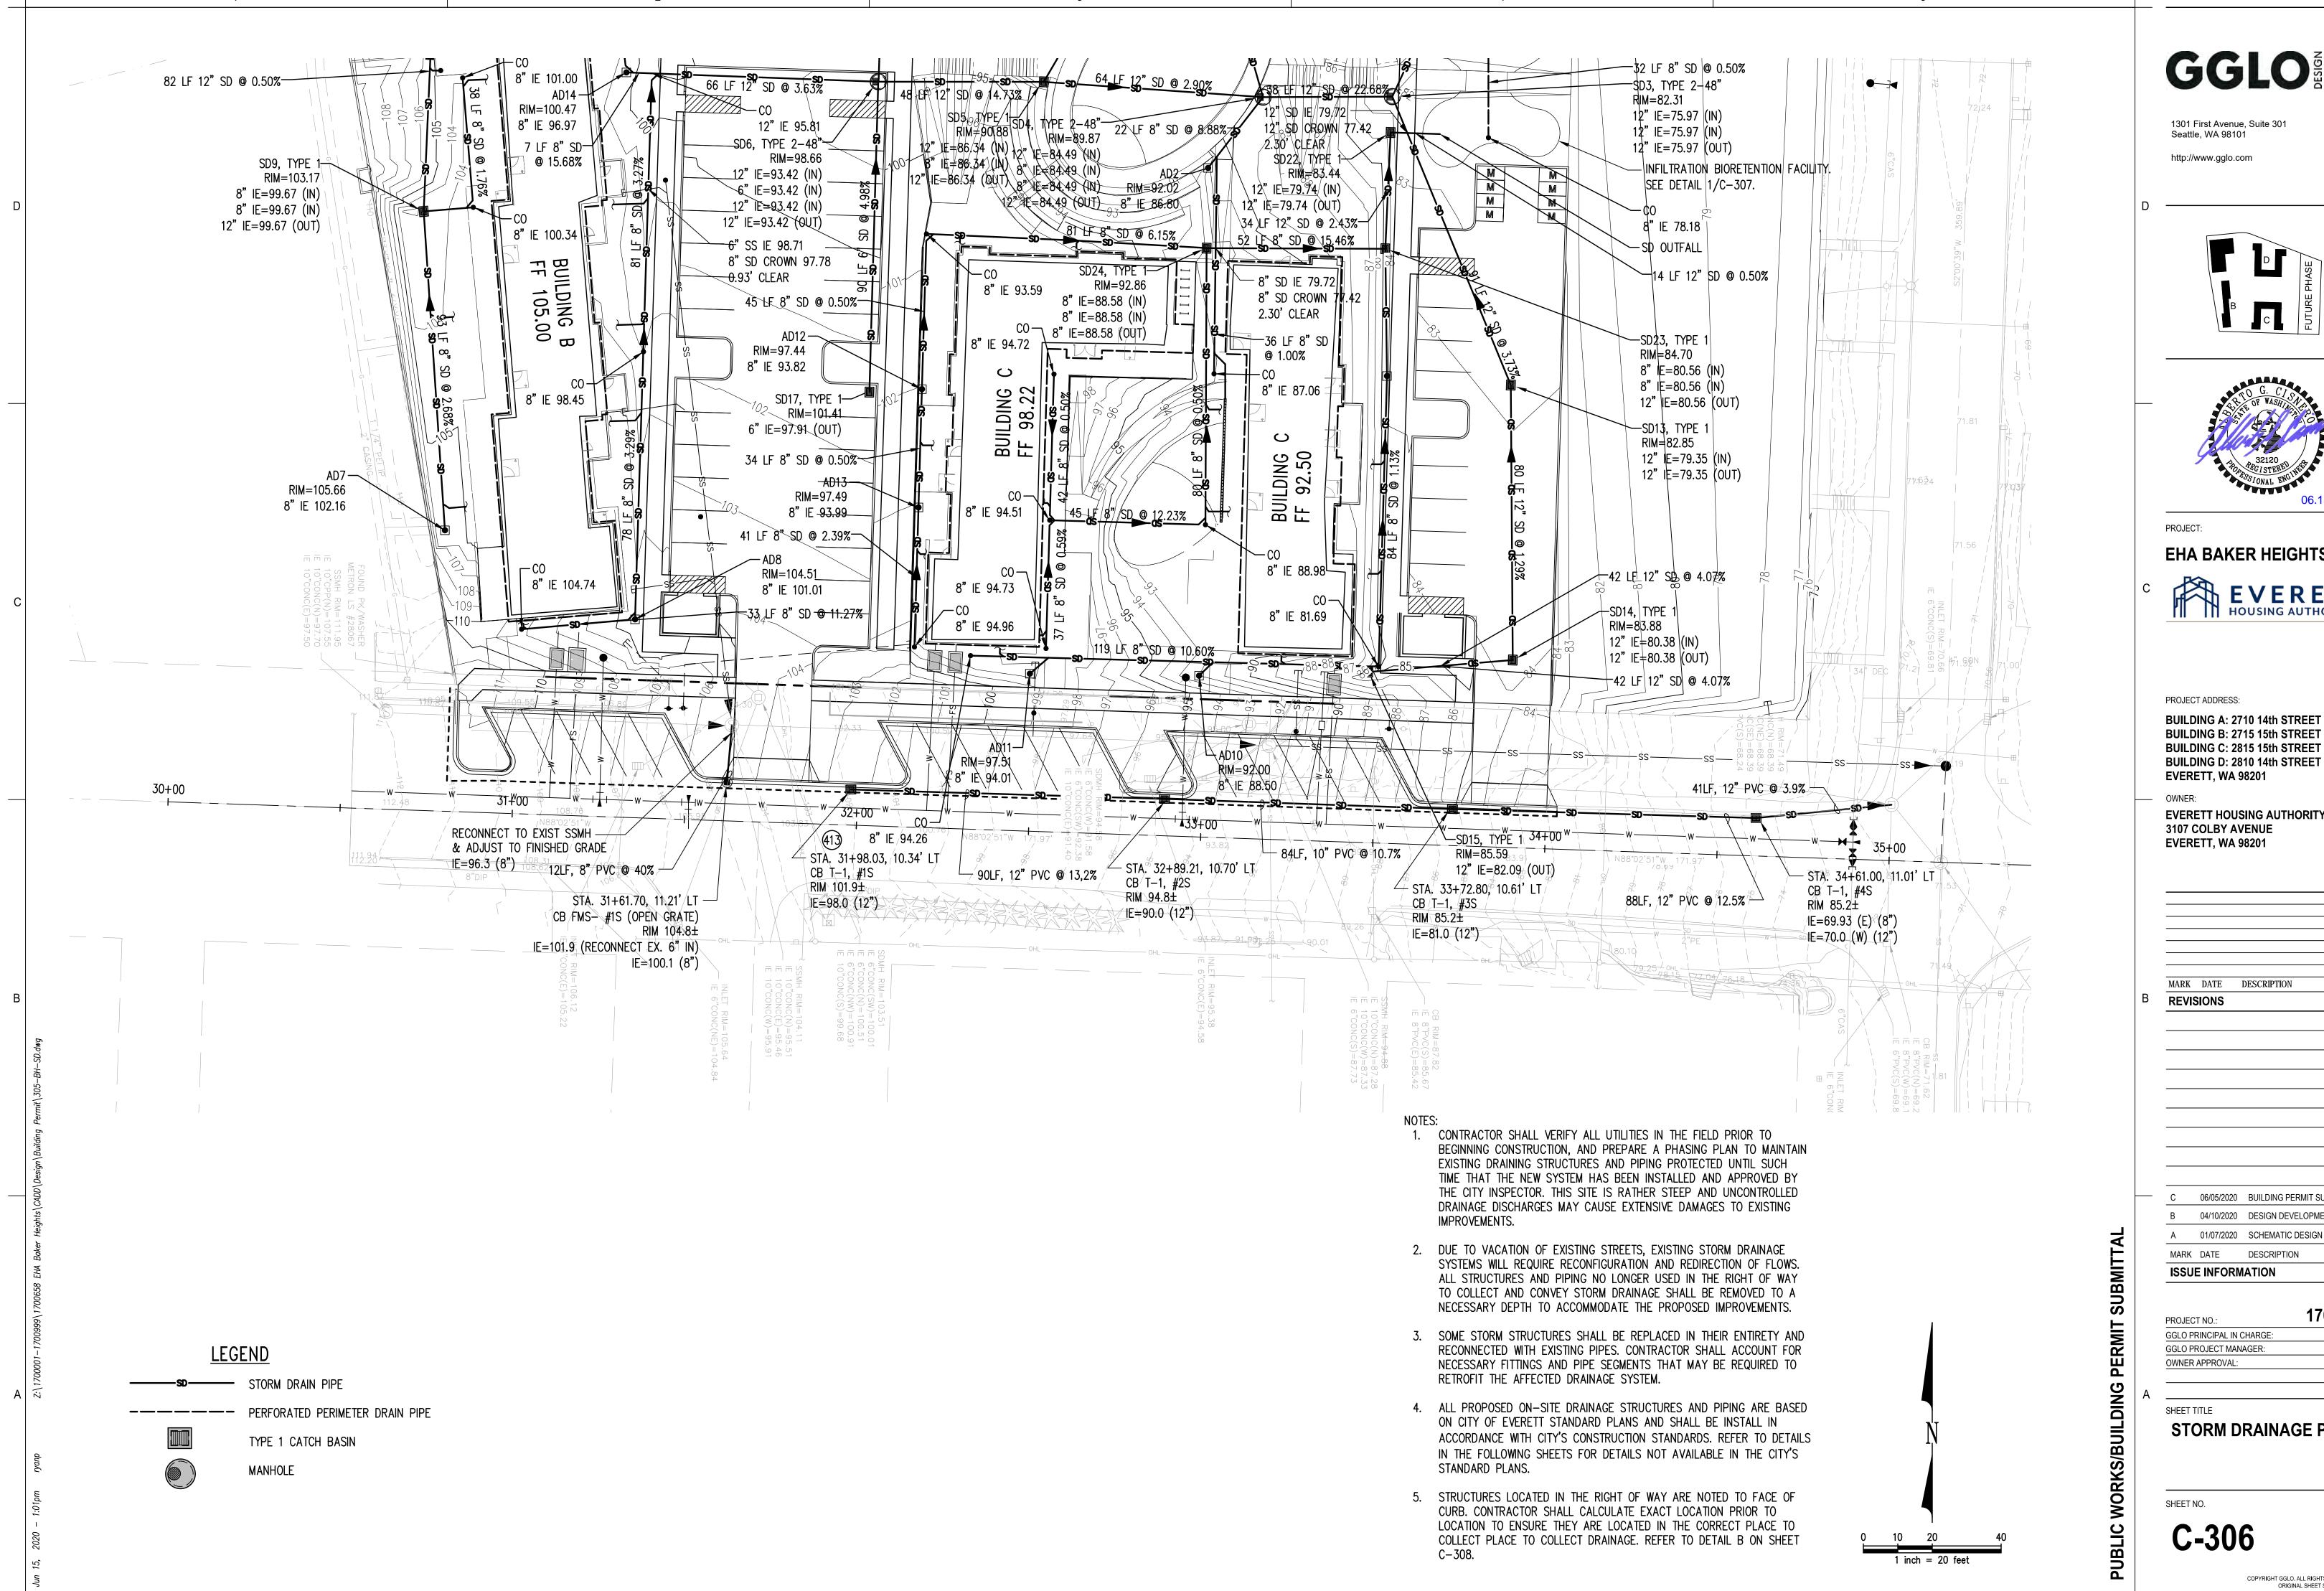
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	1301 First Avenue, Suite 301 Seattle, WA 98101 http://www.gglo.com
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	PROJECT ADDRESS: BUILDING A: 2710 14th STREET BUILDING B: 2715 15th STREET BUILDING C: 2815 15th STREET BUILDING D: 2810 14th STREET EVERETT, WA 98201 OWNER: EVERETT HOUSING AUTHORITY 3107 COLBY AVENUE EVERETT, WA 98201
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	PROJECT NO.: 1700658 GGLO PRINCIPAL IN CHARGE: AGC GGLO PROJECT MANAGER: LES/SJZ OWNER APPROVAL:
A	SHEET TITLE STORM DRAINAGE DETAILS

GGLO

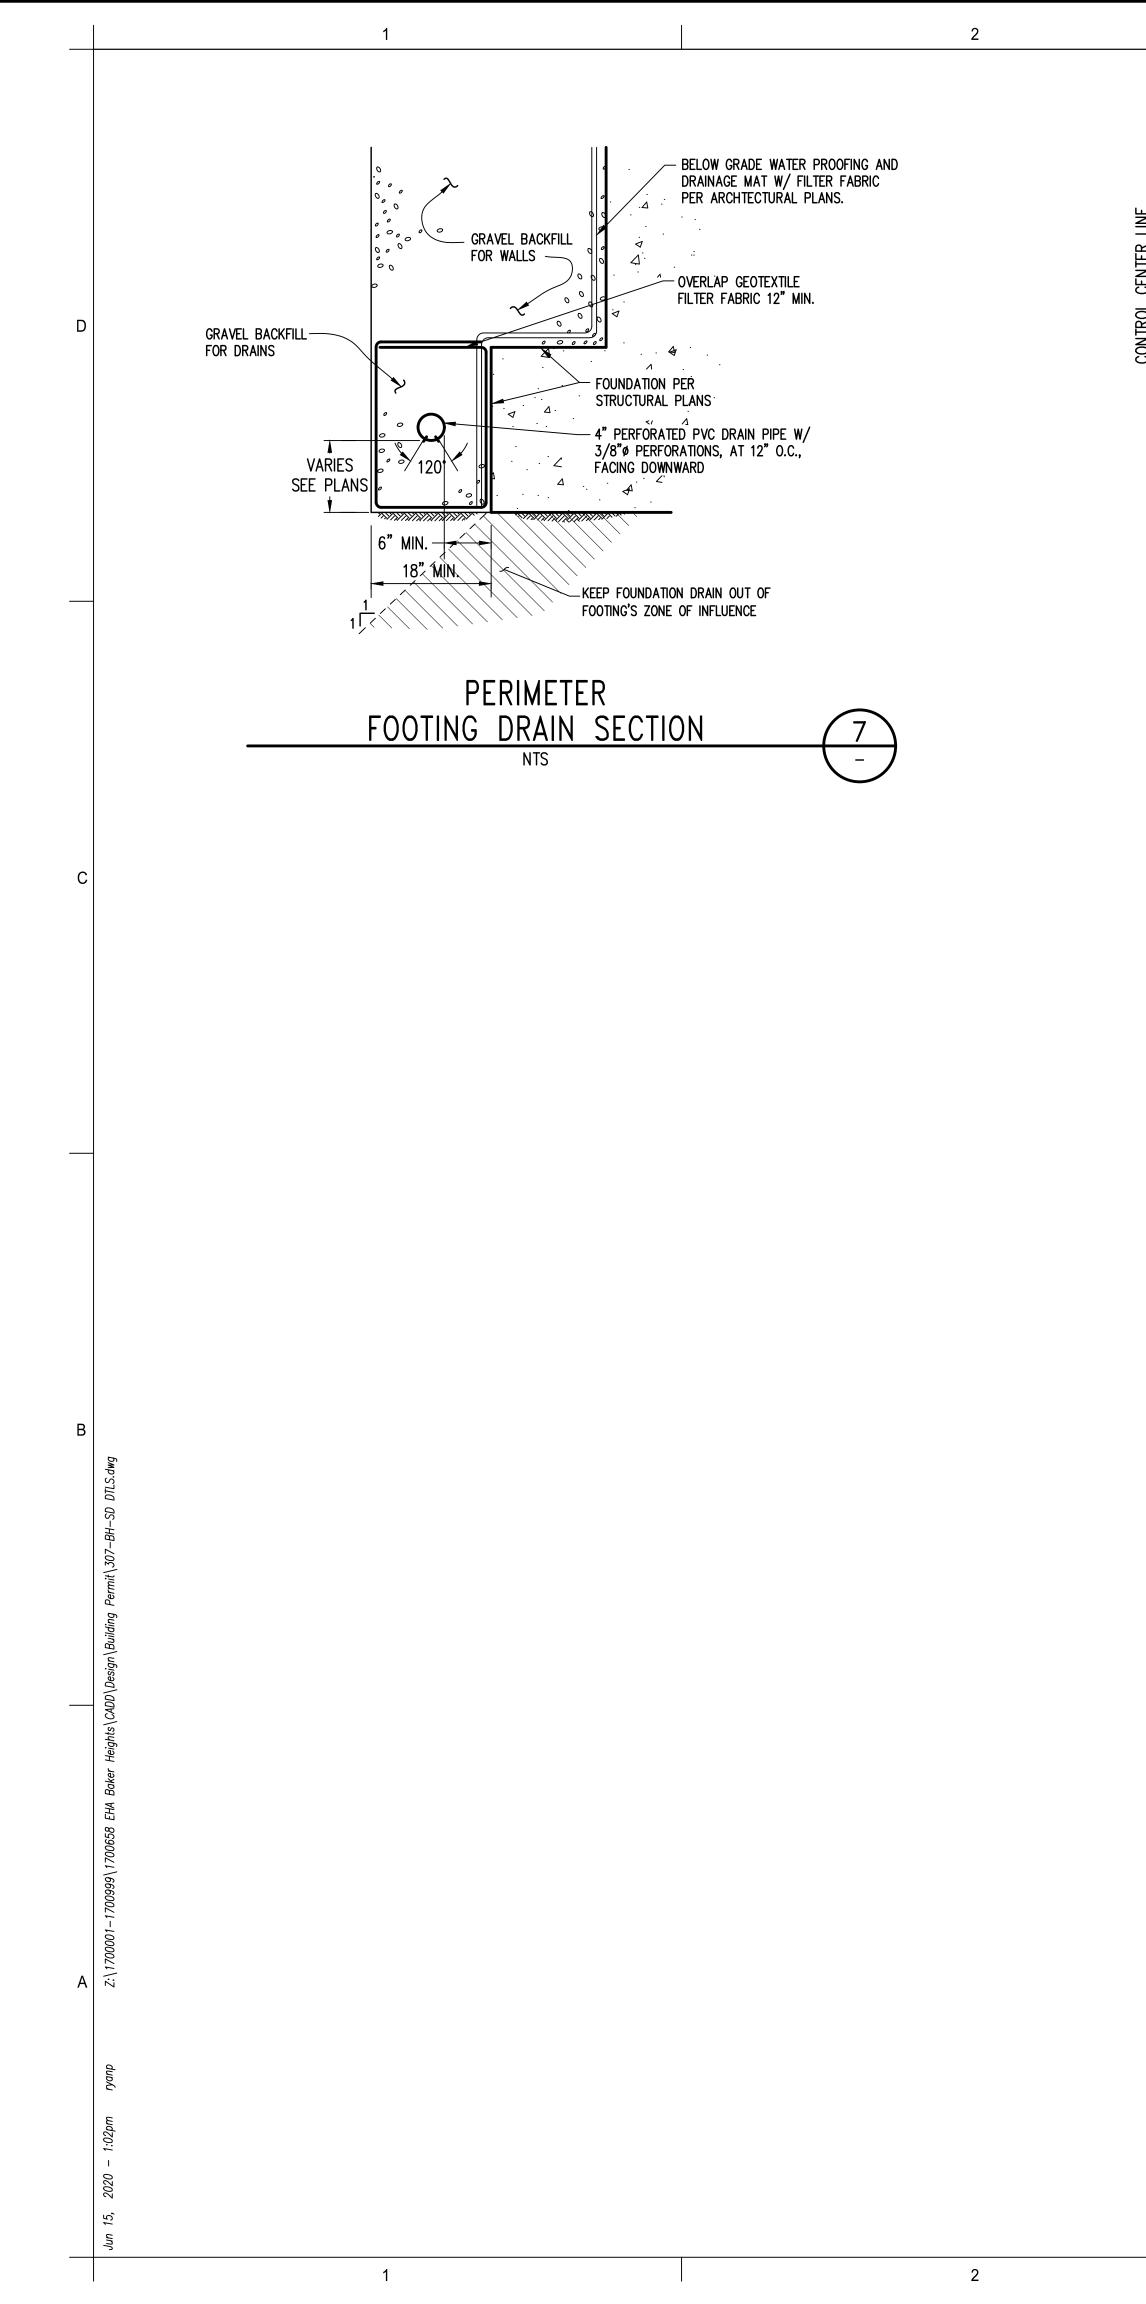PUBLIC WORKS/BUILDING PERMIT SUBMITT/

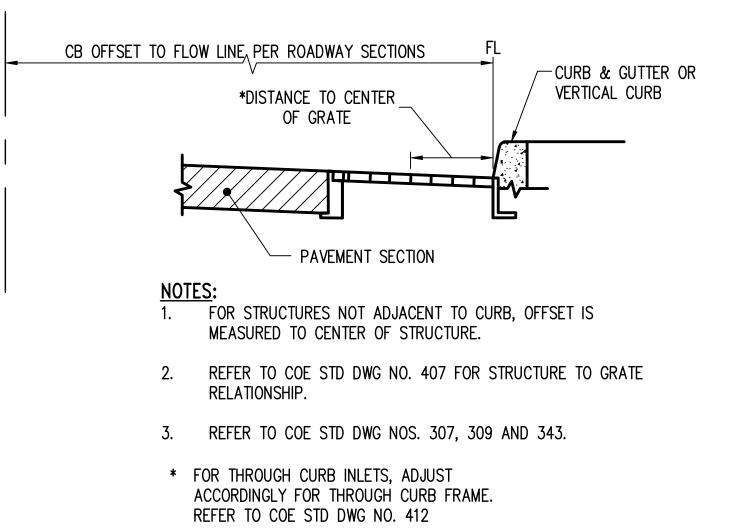
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SHEET NO.

C-308

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4



DEMOLITION AND CLEARING NOTES

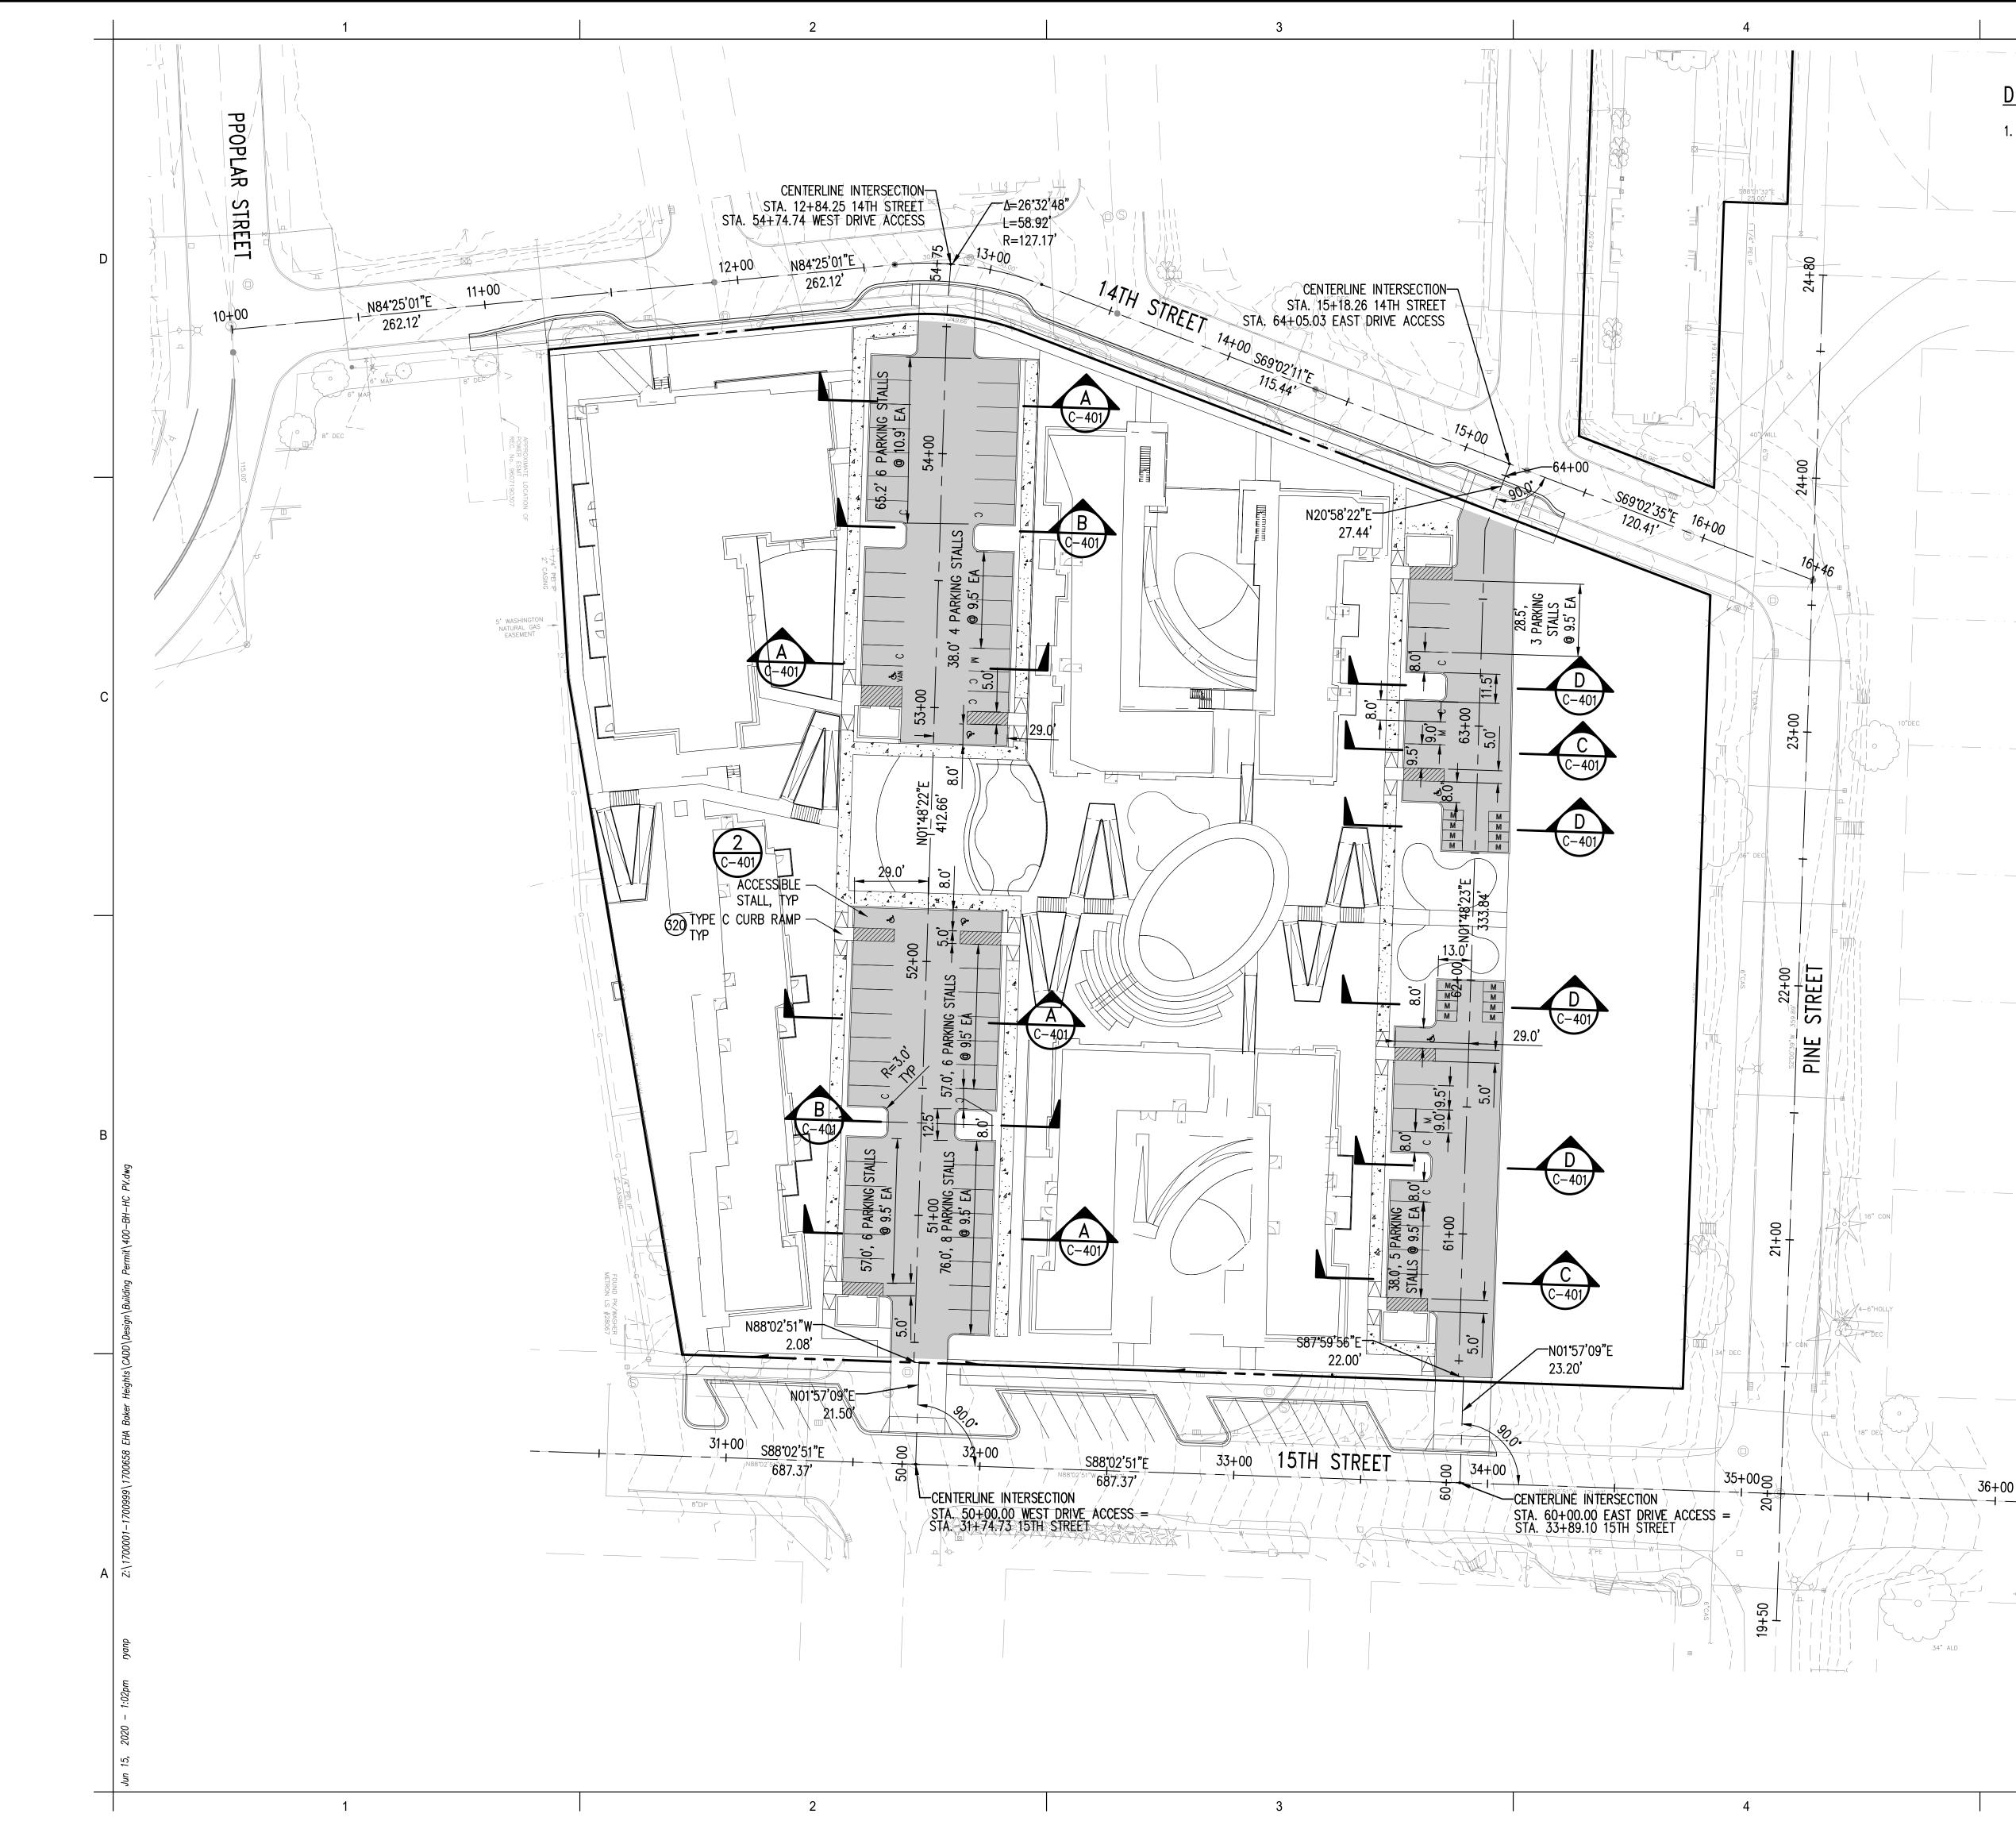15


1 inch = 30 feet

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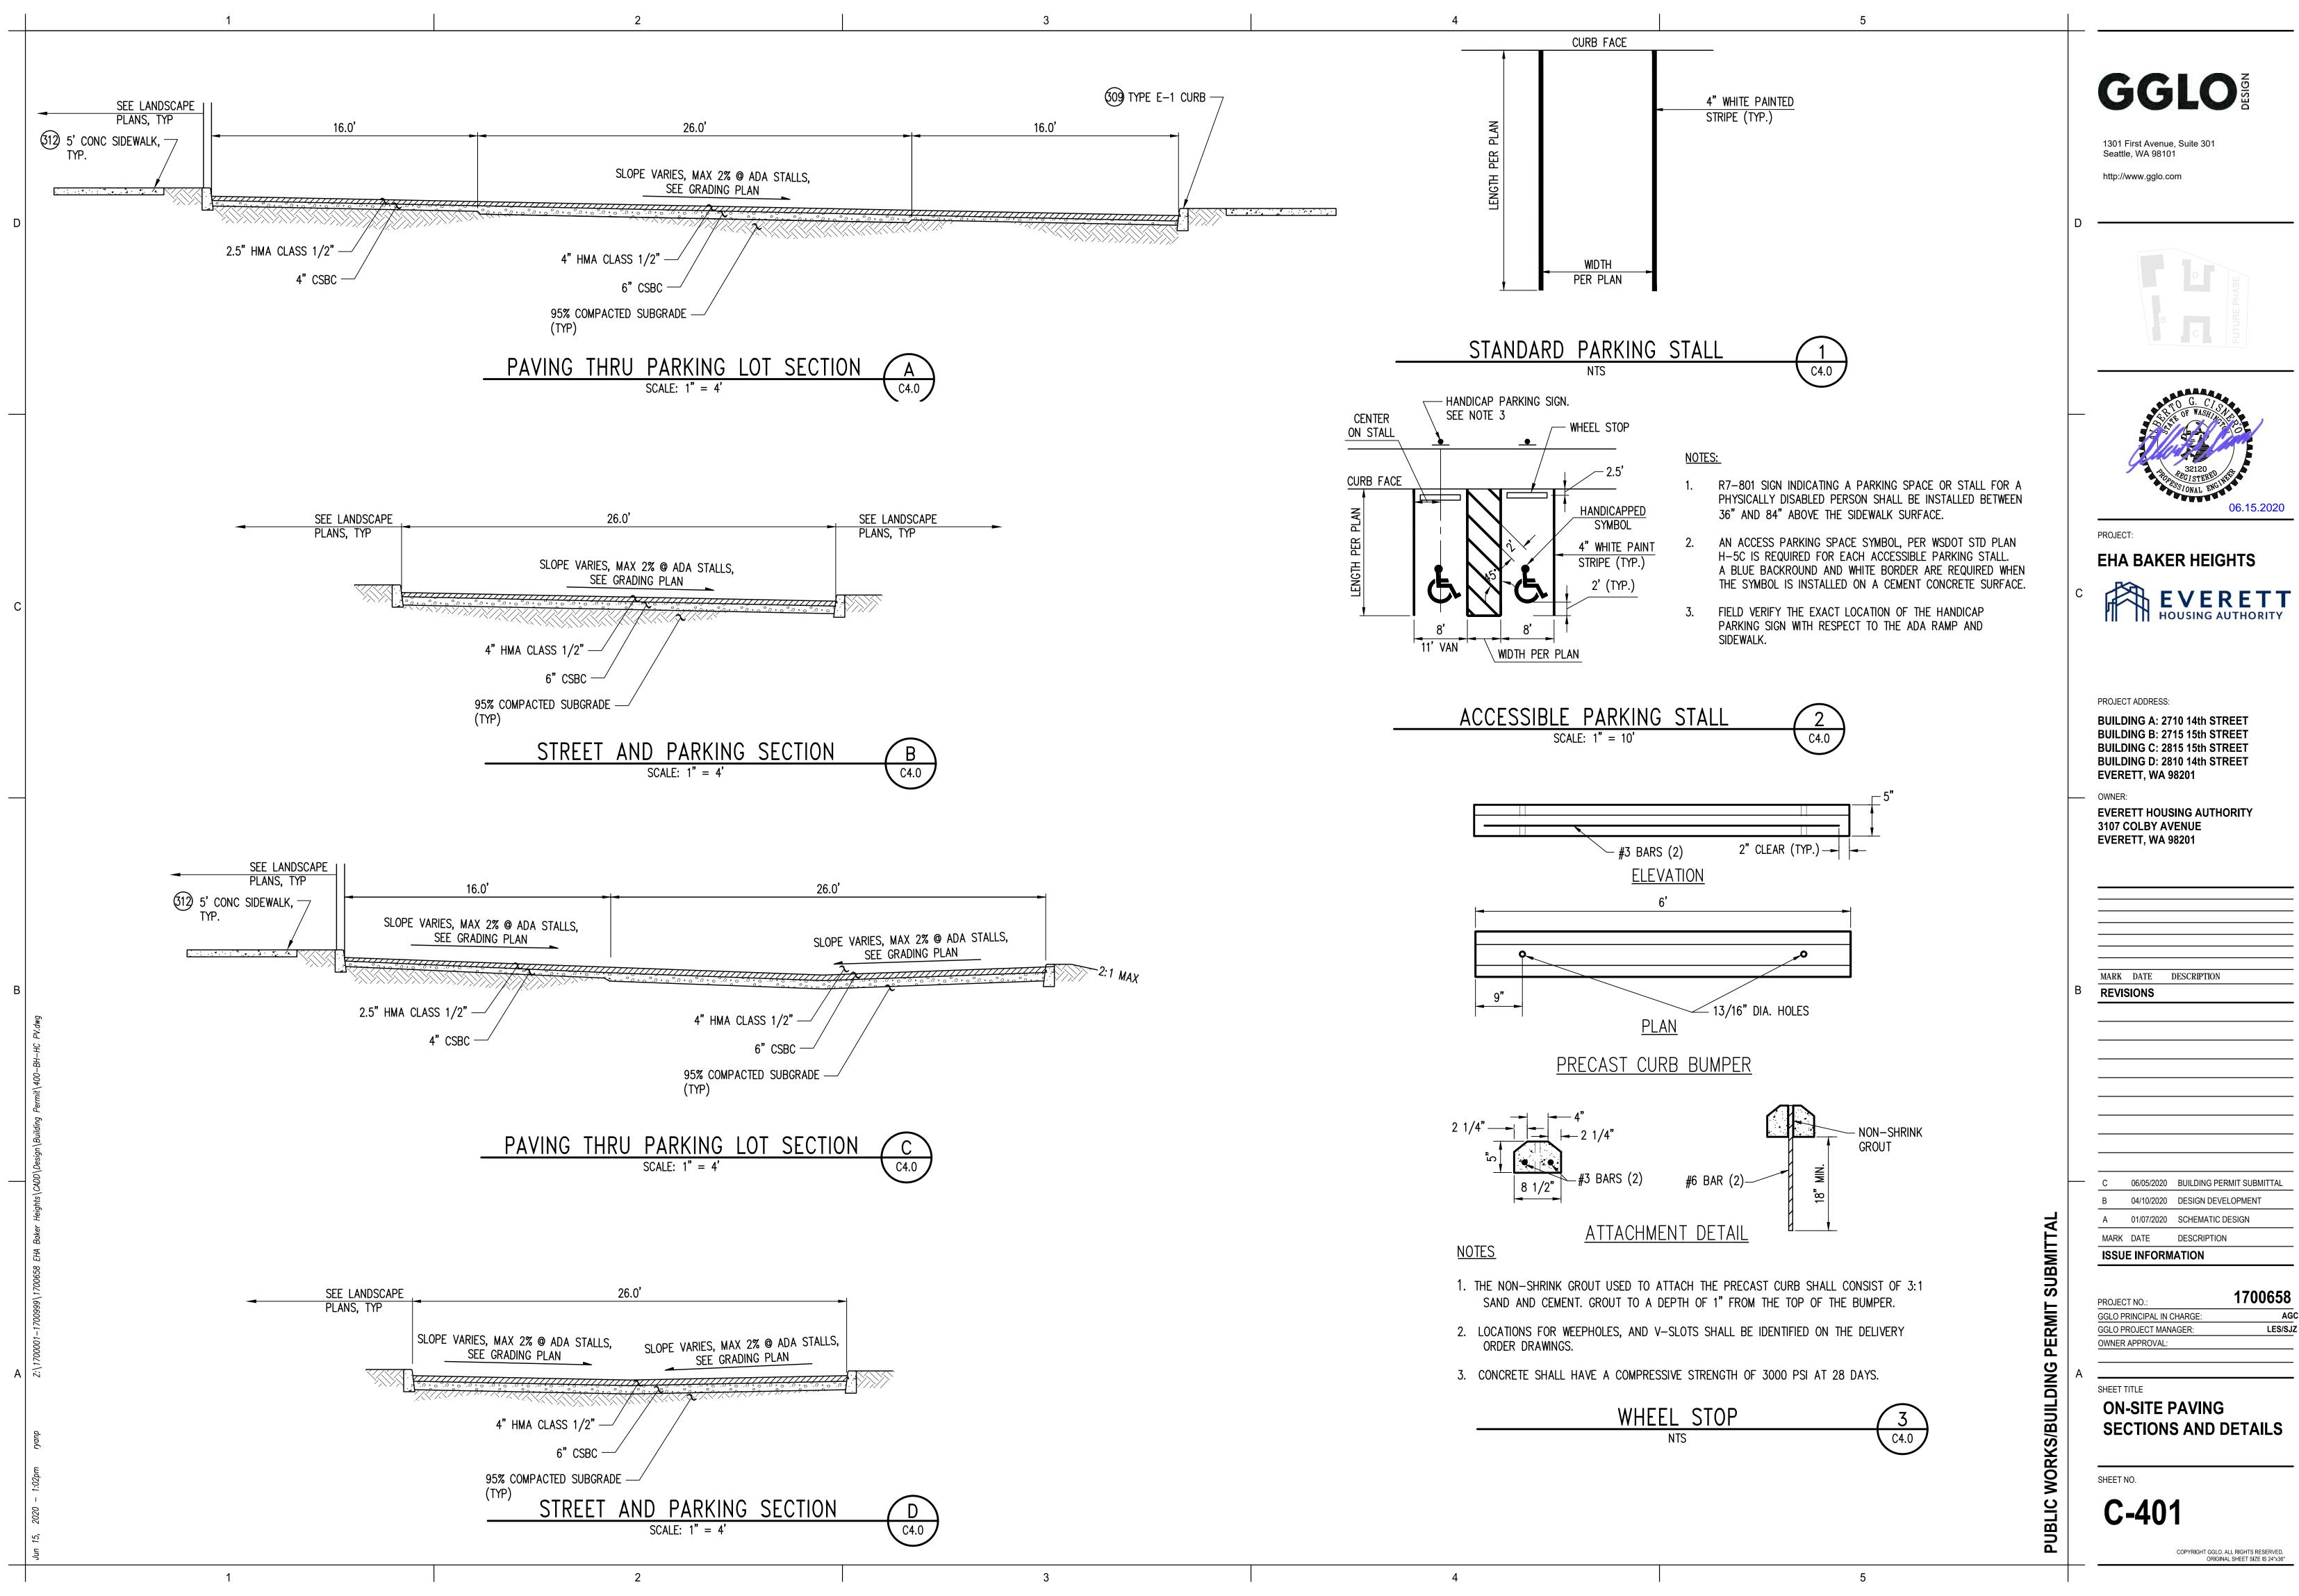
1. PARKING LOTS AND ADJACENT PARKING LOT ELEMENTS ARE LOCATED BASED ON STATION LINE FROM 15TH STREET. REFER TO ARCHITECT AND LANDSCAPE PLANS FOR LOCATION OF ALL BUILDINGS AND SURFACE IMPROVEMENTS OUTSIDE THE PARKING LOT.




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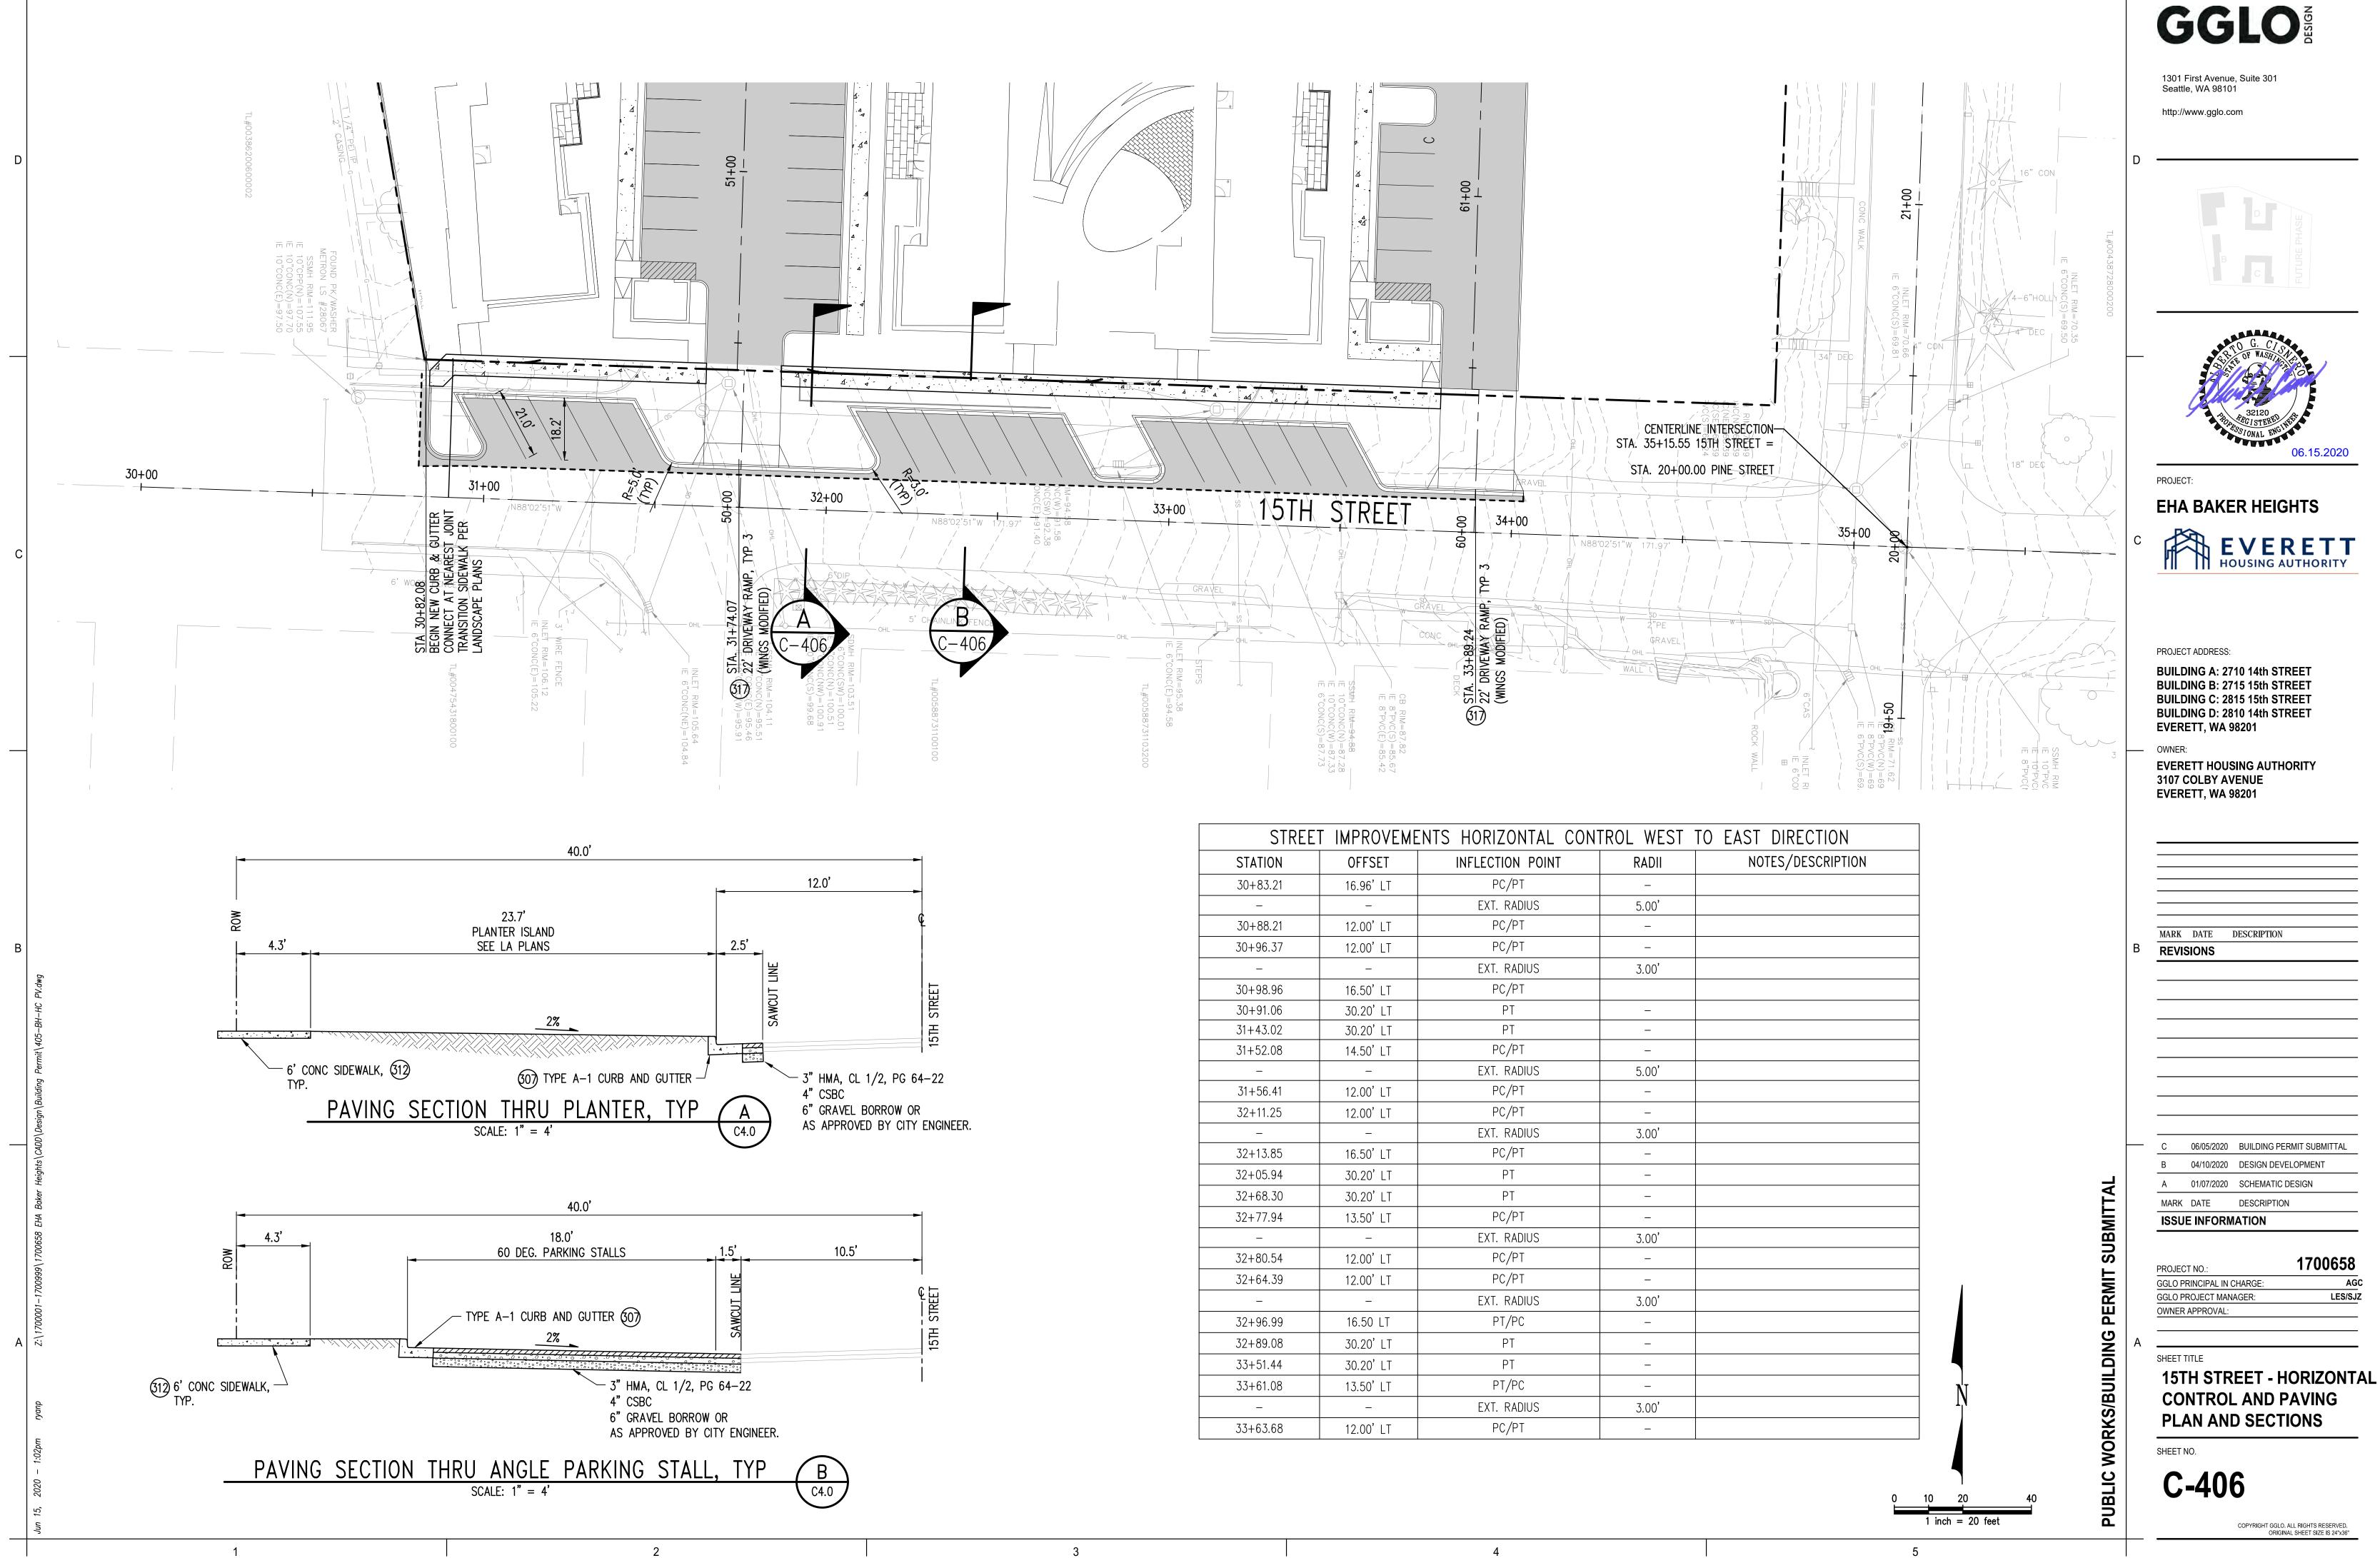


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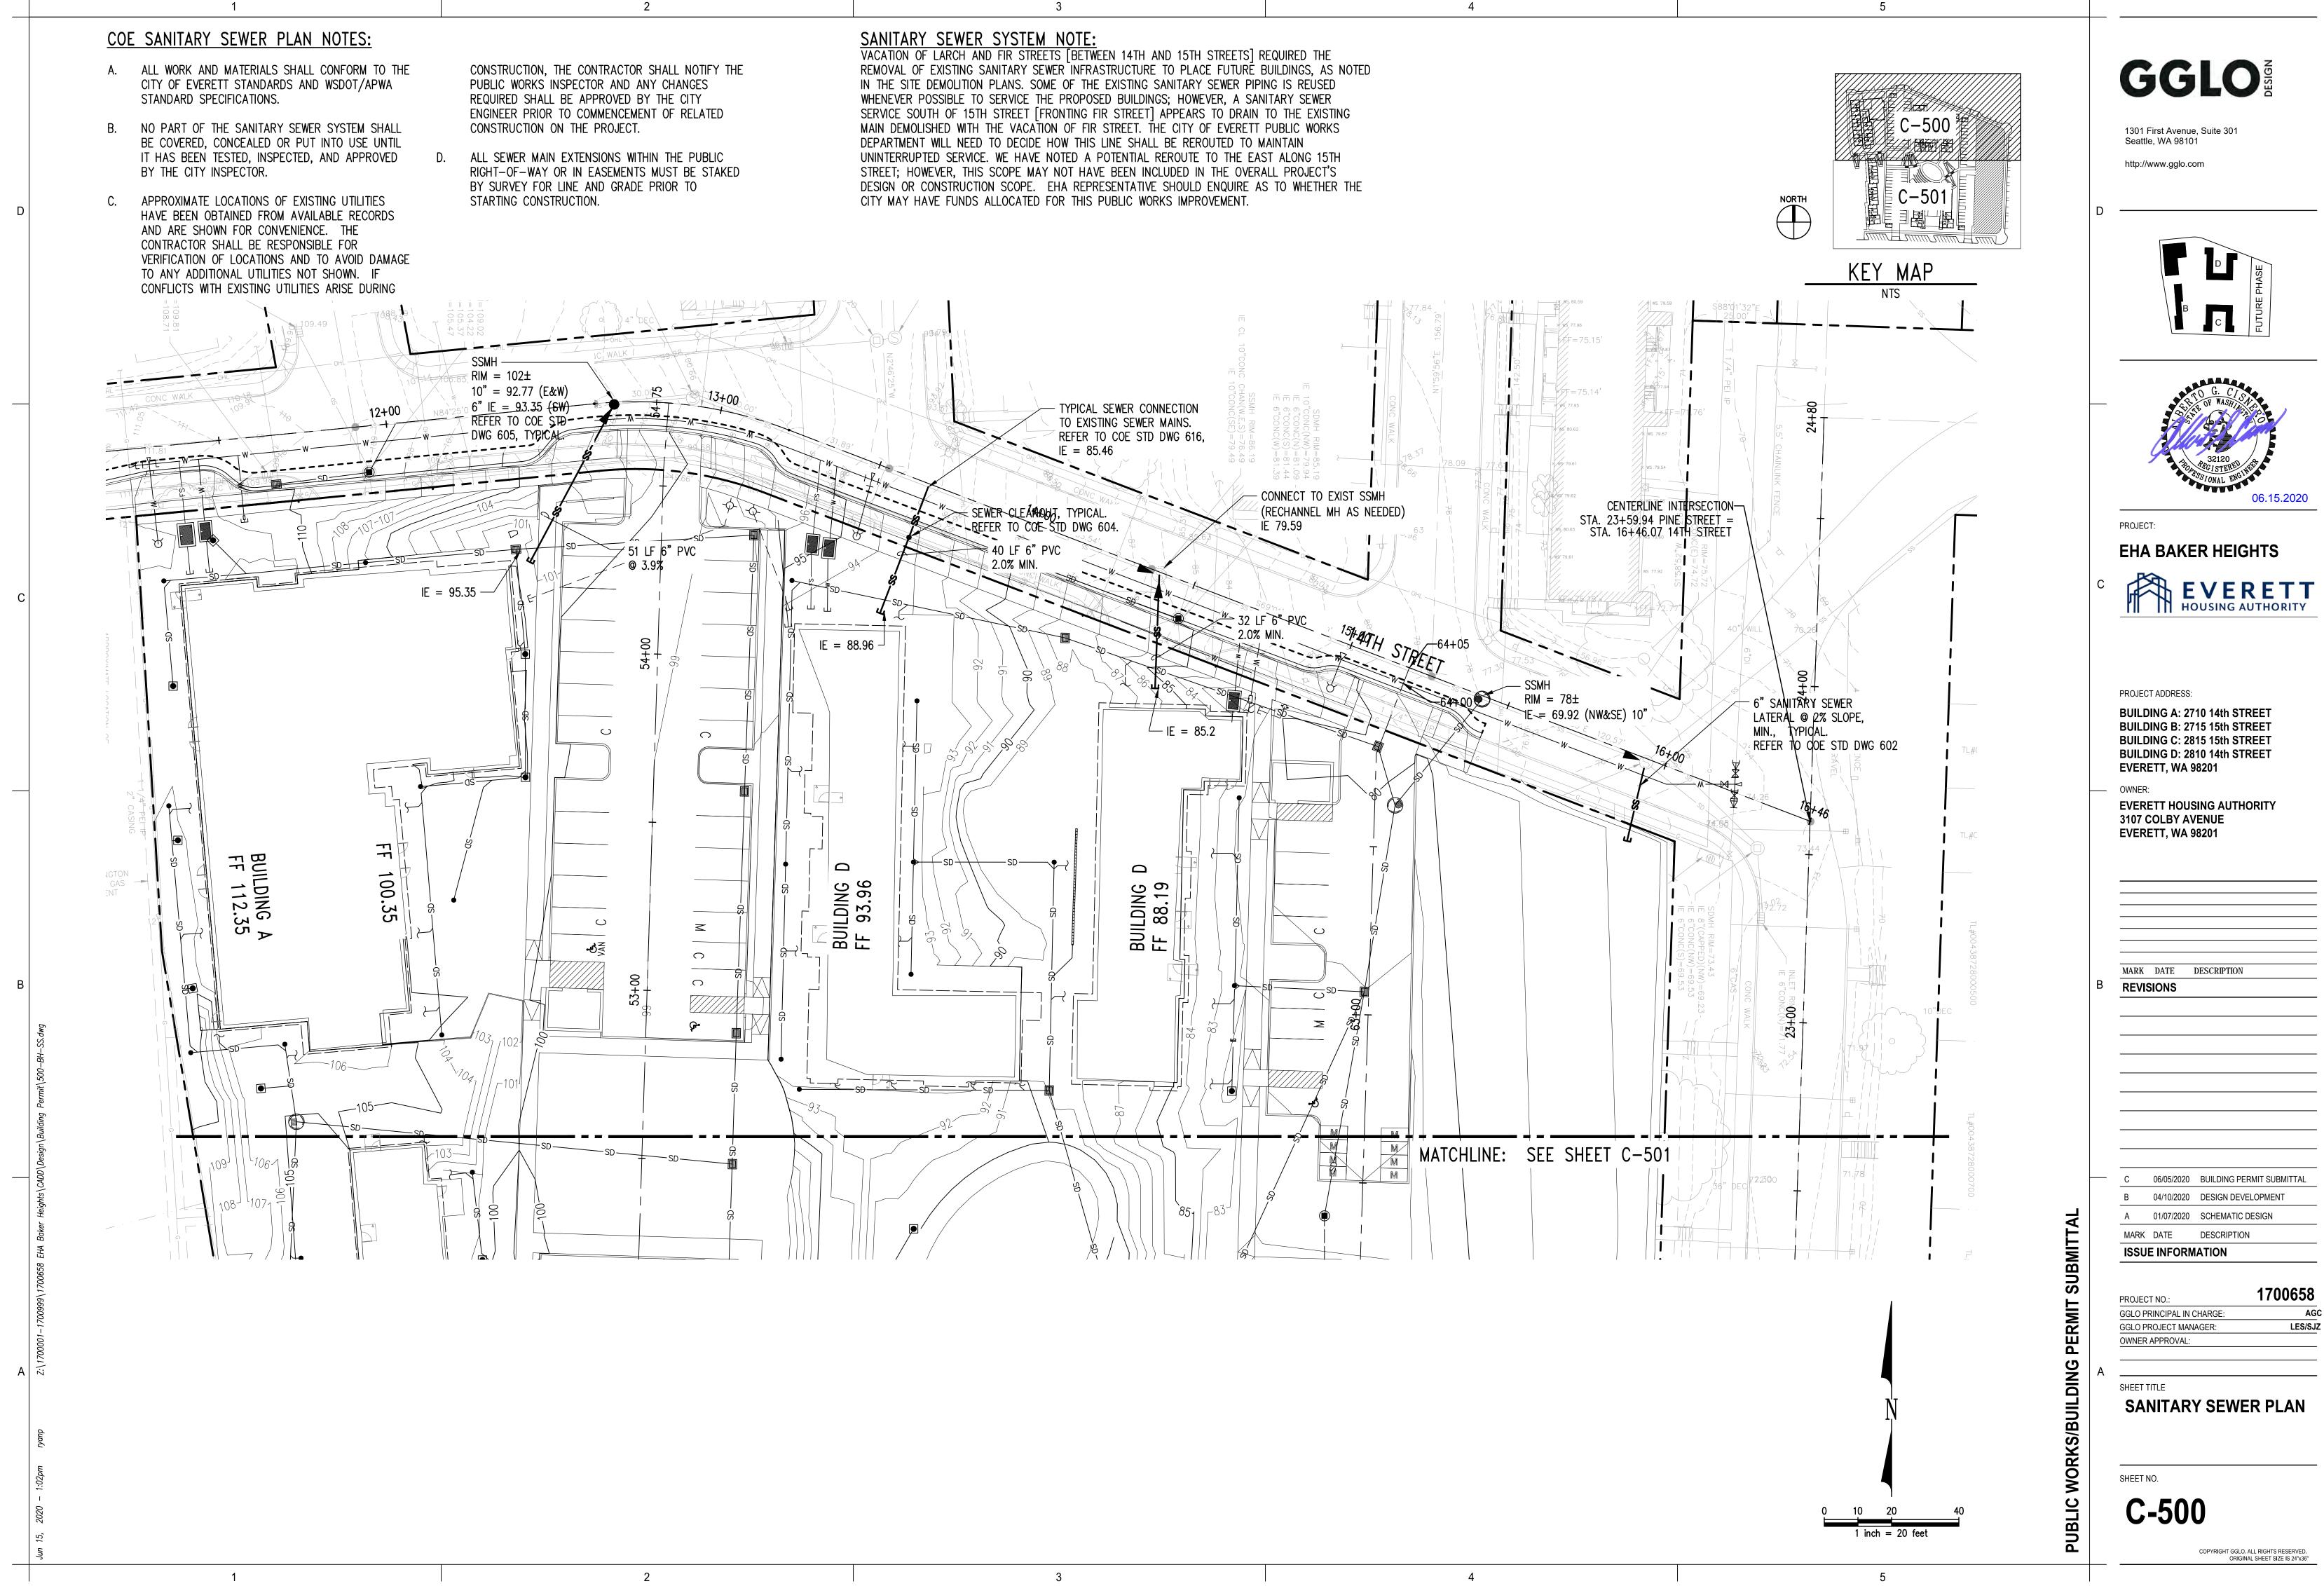


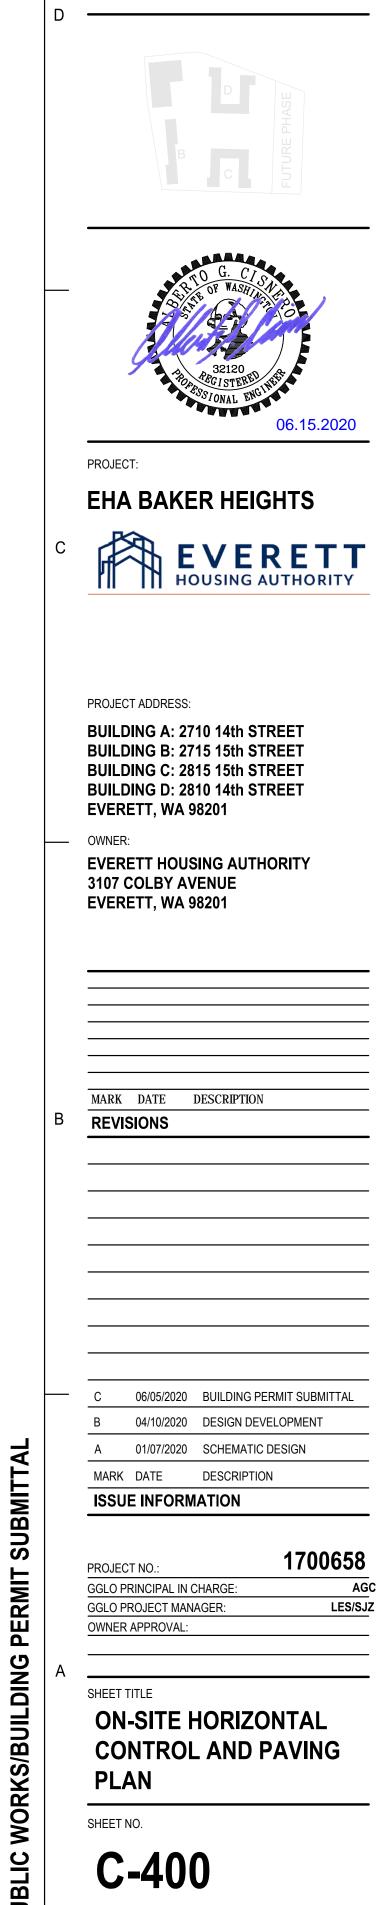
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STATION	OFFSET	INFLECTION POINT	RAI
11+44.54	8.00' RT	PT/PC	_
_	_	INT. RADIUS	10
11+52.92	13.07' RT	PRC	_
_	_	EXT. RADIUS	10
11+59.99	16.00'RT	PC/PT	_
12+39.04	16.00' RT	PC/PT	
12+48.61	11.28' RT	PRC	_
_	_	INT. RADIUS	10
12+55.33	8.00' RT	PC/PT	_
_	-	EXT. RADIUS	10
13+12.59	8.00' RT	PC/PT	_
_	_	EXT. RADIUS	10
13+20.08	10.53'RT	PRC	_
_	_	INT. RADIUS	10
13+27.66	12.82'RT	PT/PC	_
14+89.52	11.24' RT	PT/PC	_
_	_	INT. RADIUS	10
14+94.72	9.88' RT	PRC	_
_	_	EXT. RADIUS	10
15+00.56	7.99' RT	PT/PC	_
15+33.95	8.01'RT	PT/PC	_
_	_	EXT. RADIUS	10
15+38.91	9.69' RT	PRC	_
_	_	INT. RADIUS	10
15+45.65	11.39' RT	PT/PC	-
L	1		1

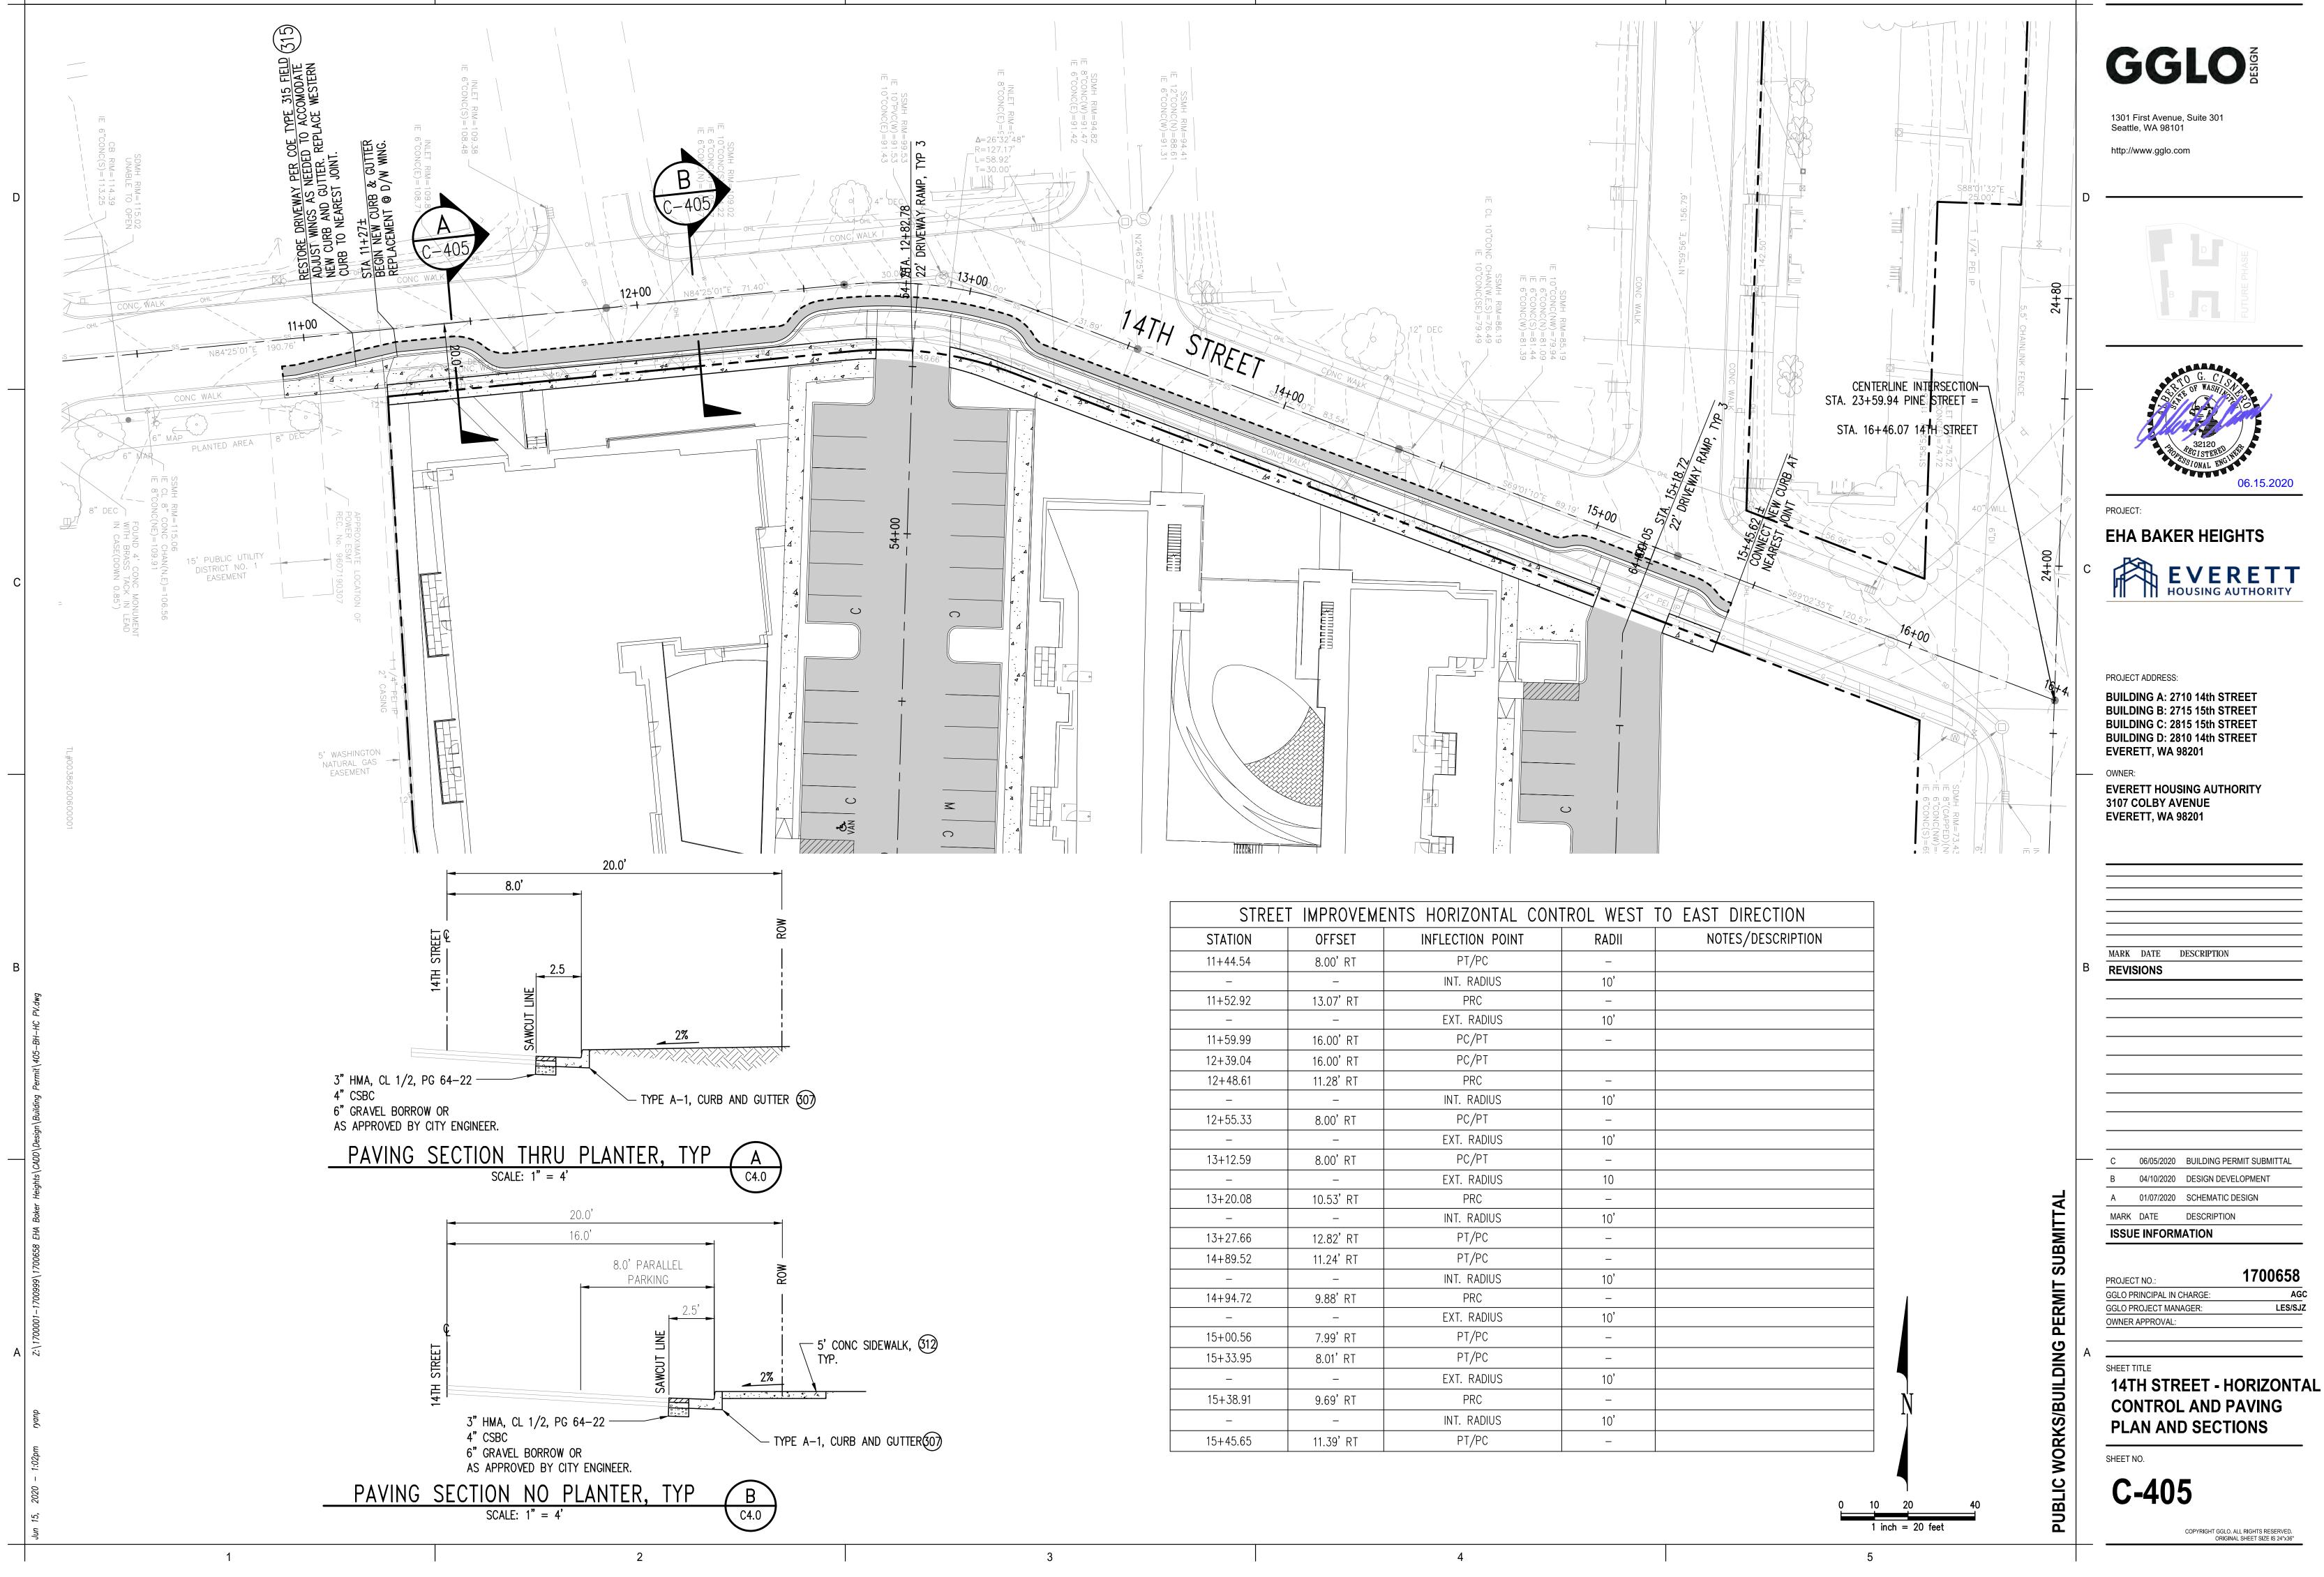


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	ľ	<u>-</u>
		REET
		15TH STREET
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33+61.08 13.50' LT PT/PC	32+89.08	30.20'LT	PT	
	33+51.44	30.20'LT	PT	
	33+61.08	13.50'LT	PT/PC	
	_	_	EXT. RADIUS	
33+63.68 12.00' LT PC/PT	33+63.68	12.00'LT	PC/PT	





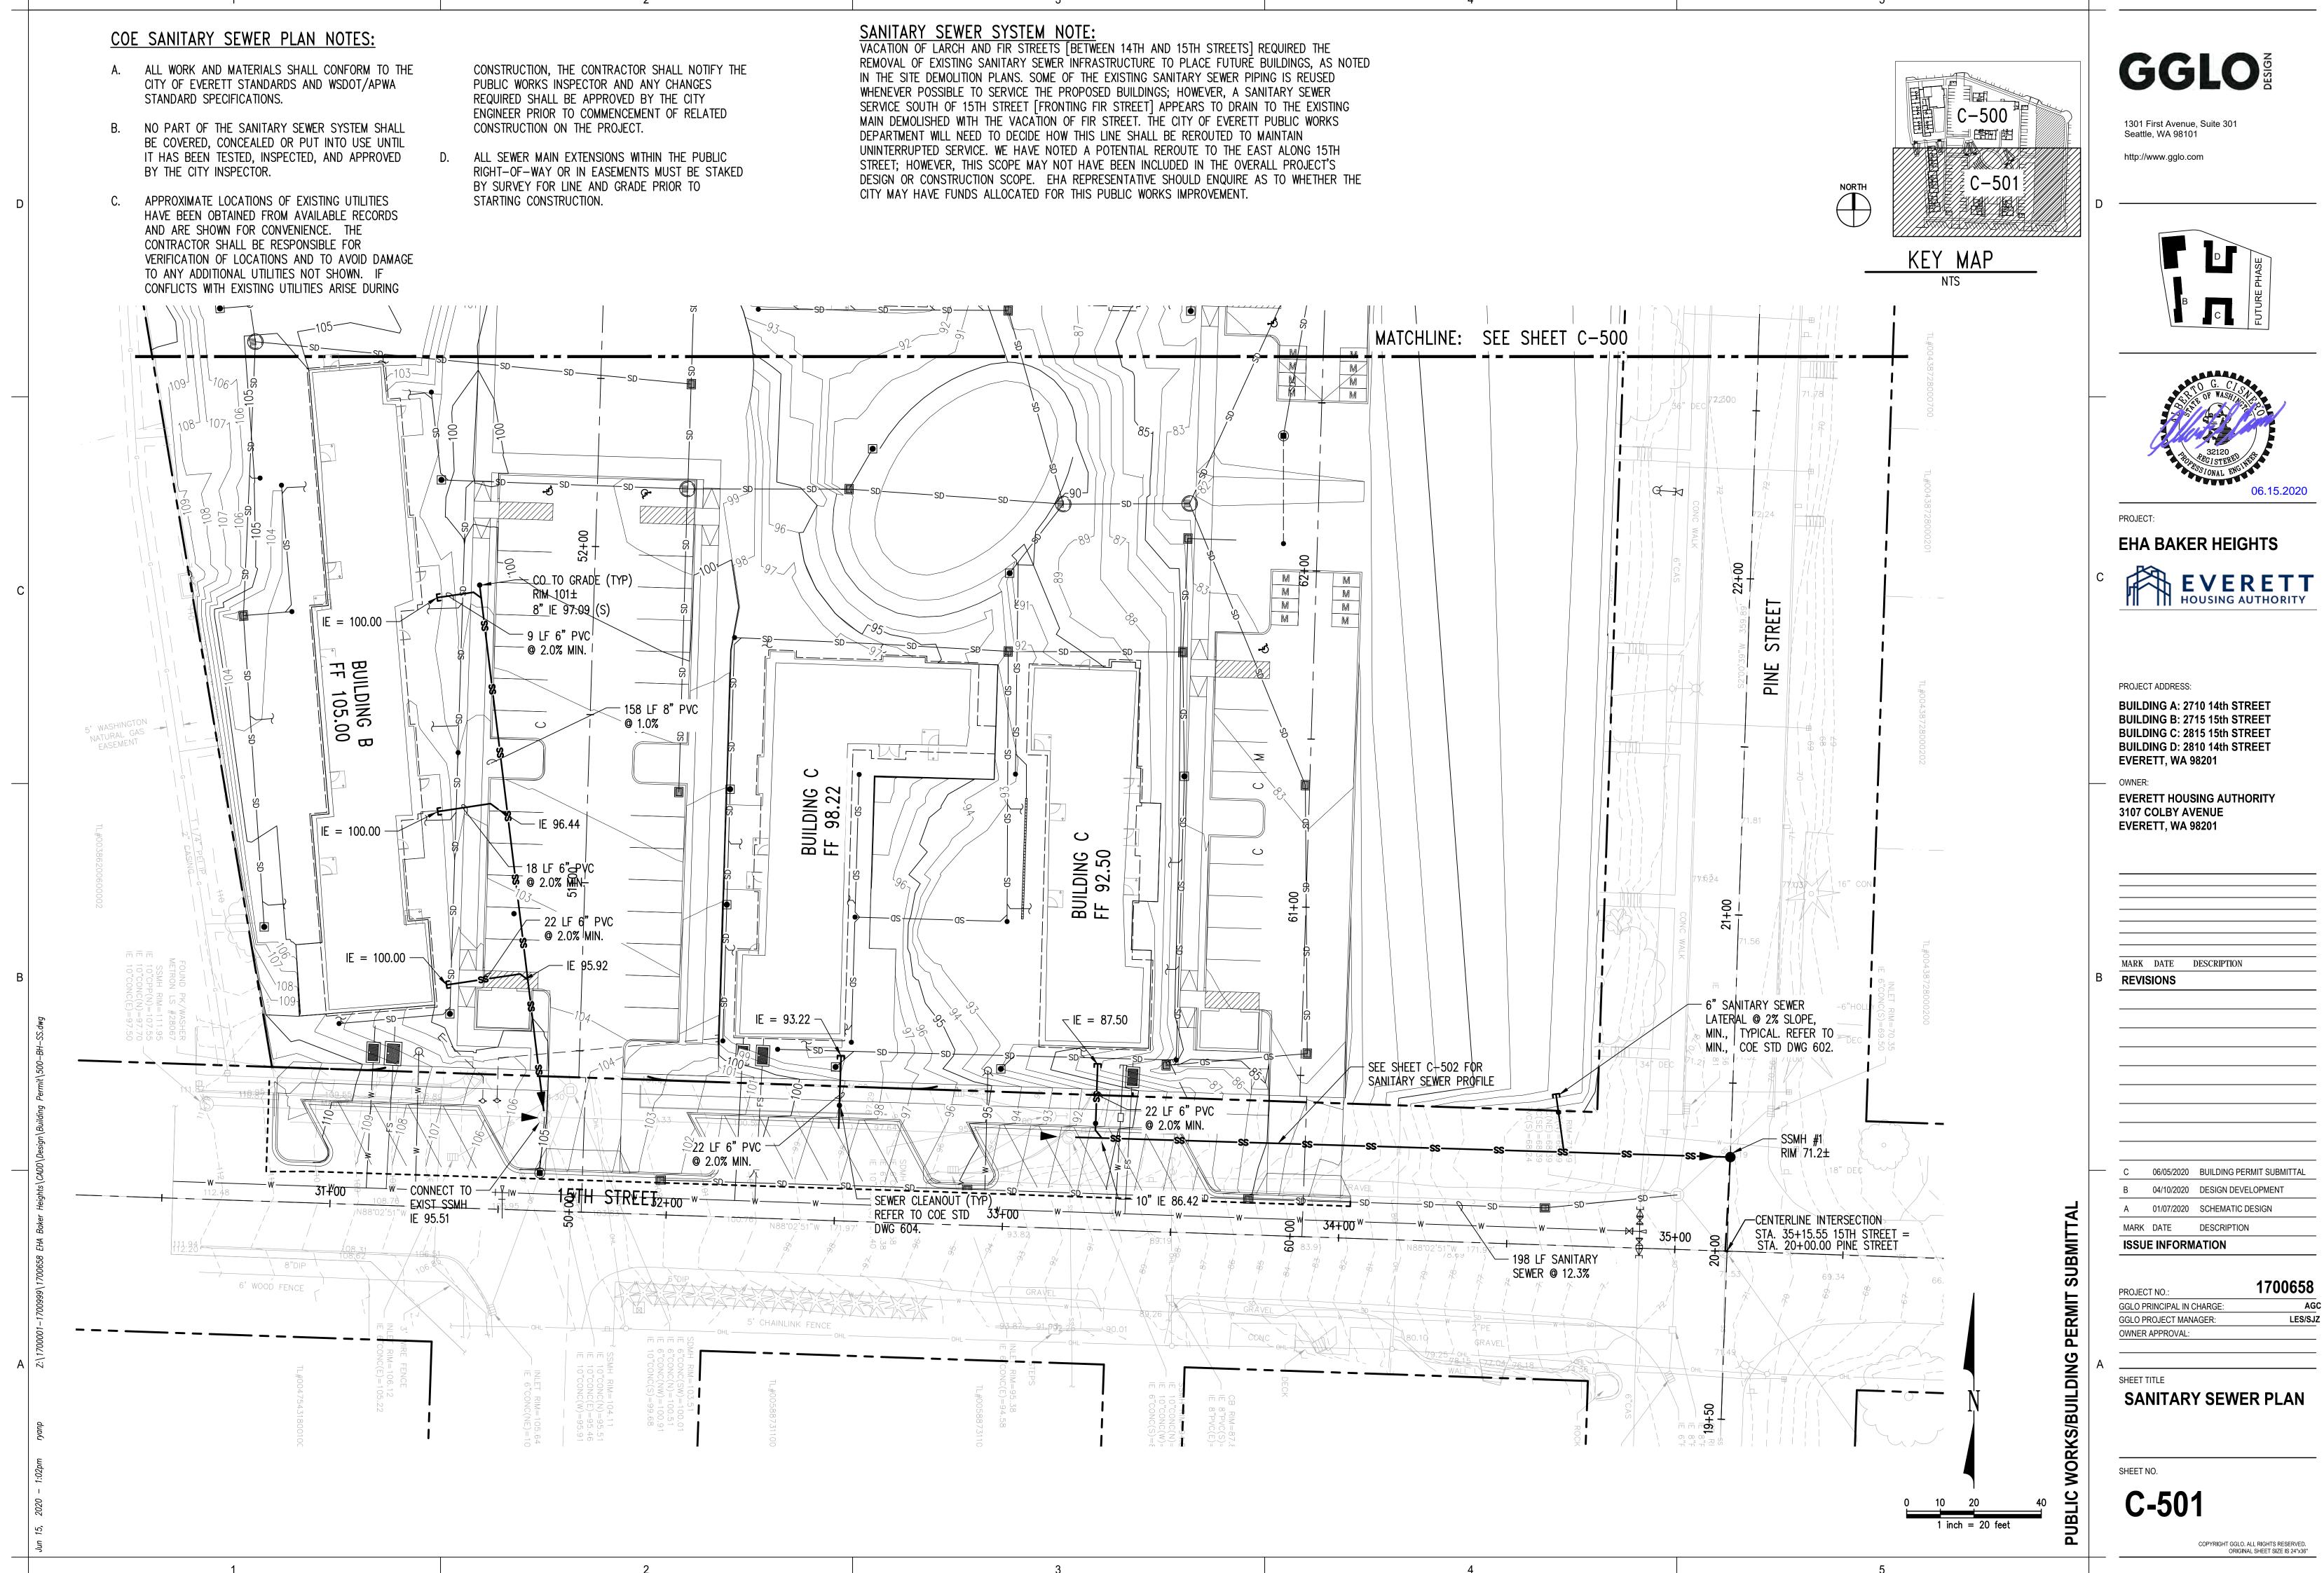

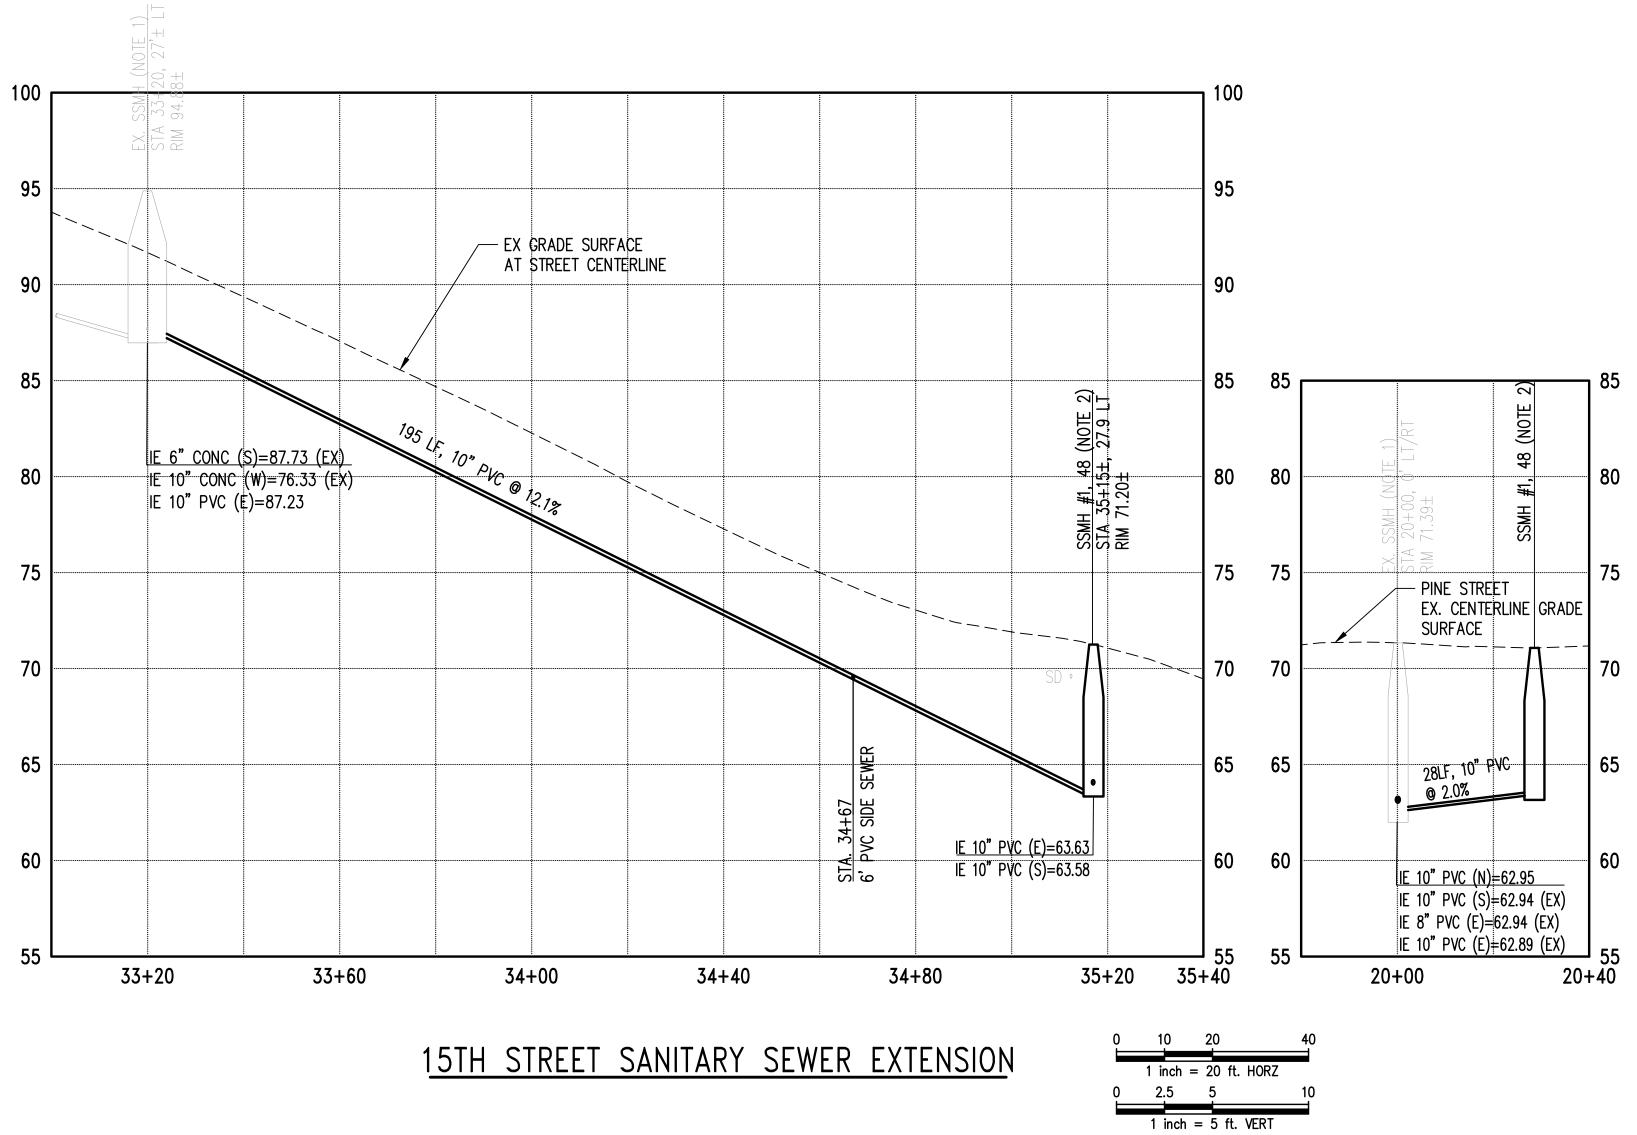NOTES:


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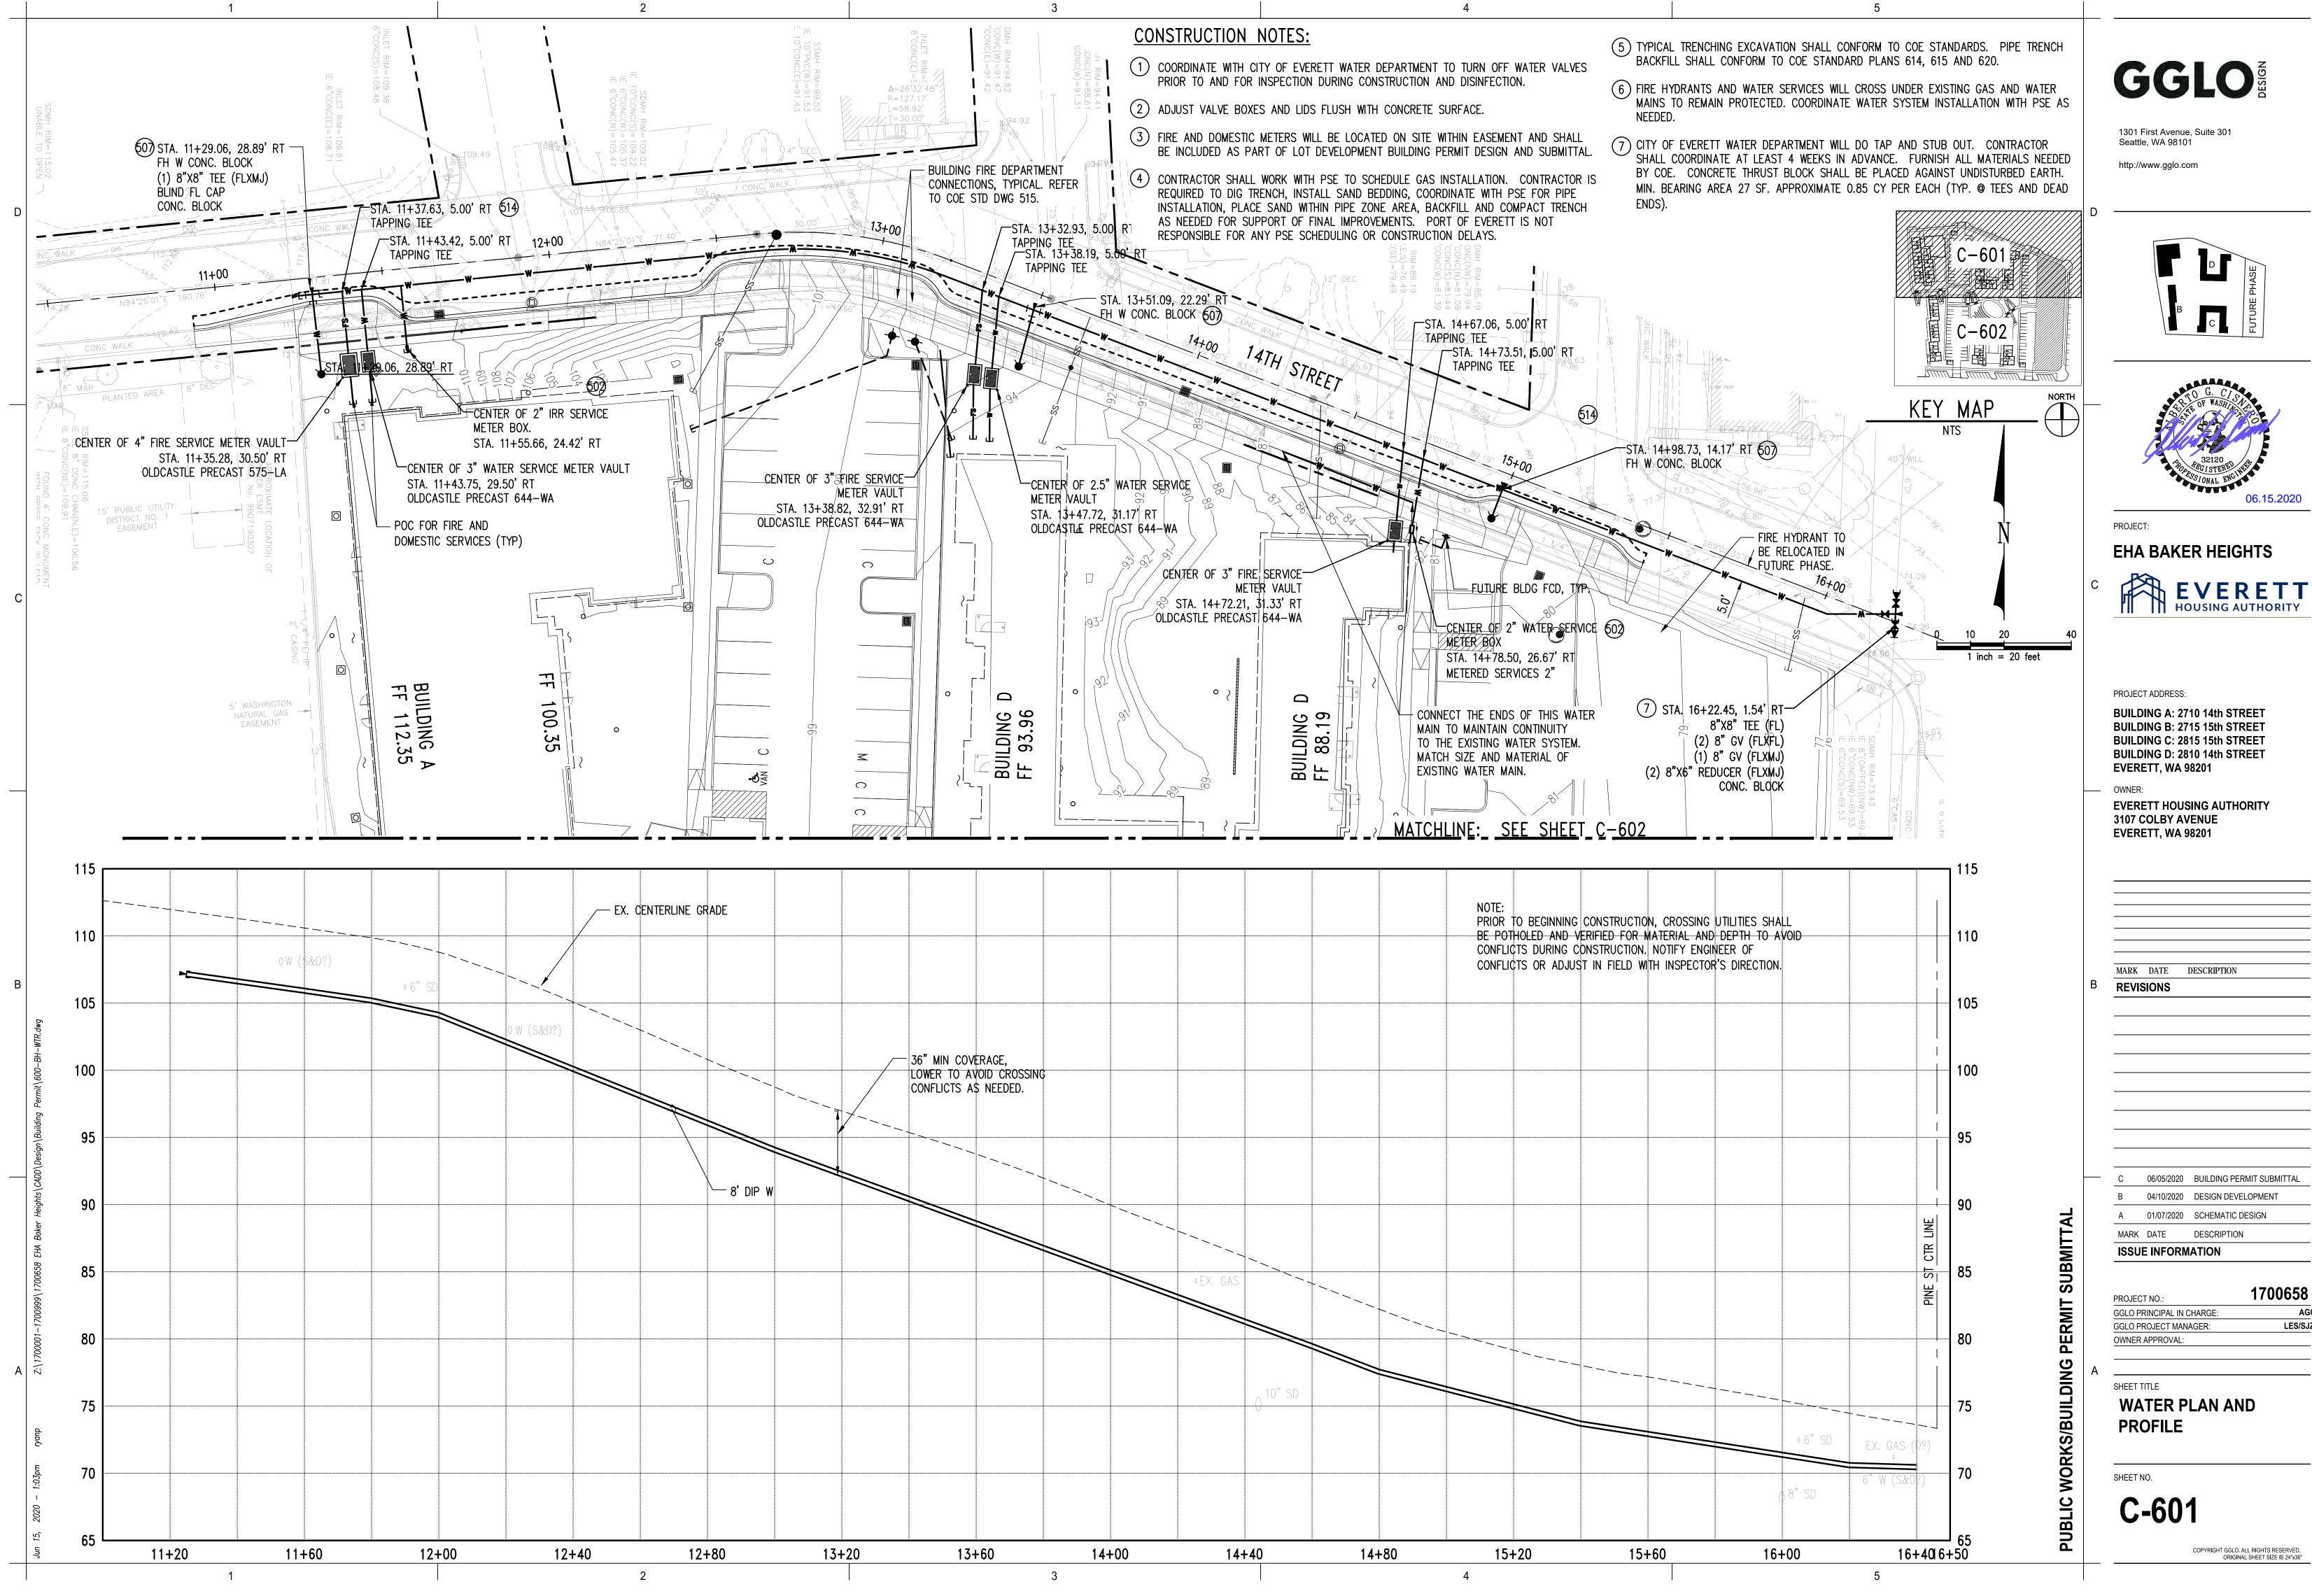
A N

1. FIELD VERIFY EXISTING SSMH RIM ELEVATION TO UNDERSTAND AND OBTAIN NEEDED MATERIALS TO LOWER RIM TO MATCH FINISHED GRADE.

2. PROTECT EXISTING INLET STORM PIPE DURING INSTALLATION OF SANITARY SEWER MANHOLE.

5		
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		PROJECT ADDRESS: BUILDING A: 2710 14th STREET BUILDING B: 2715 15th STREET BUILDING C: 2815 15th STREET BUILDING D: 2810 14th STREET EVERETT, WA 98201 OWNER: EVERETT HOUSING AUTHORITY 3107 COLBY AVENUE EVERETT, WA 98201
	В	MARK DATE DESCRIPTION REVISIONS
PERMIT SUBMITTAL		C 06/05/2020 BUILDING PERMIT SUBMITTAL B 04/10/2020 DESIGN DEVELOPMENT A 01/07/2020 SCHEMATIC DESIGN MARK DATE DESCRIPTION ISSUE INFORMATION IT7006588 GGLO PRINCIPAL IN CHARGE: AGC GGLO PROJECT MANAGER: LES/SJZ OWNER APPROVAL: I
PUBLIC WORKS/BUILDING PE	A	OWNER APPROVAL: SHEET TITLE SANITARY SEWER PROFILE SHEET NO. C-502 COPYRIGHT GGLO. ALL RIGHTS RESERVED. DRIGINAL SHEET SIZE IS 24*X36*



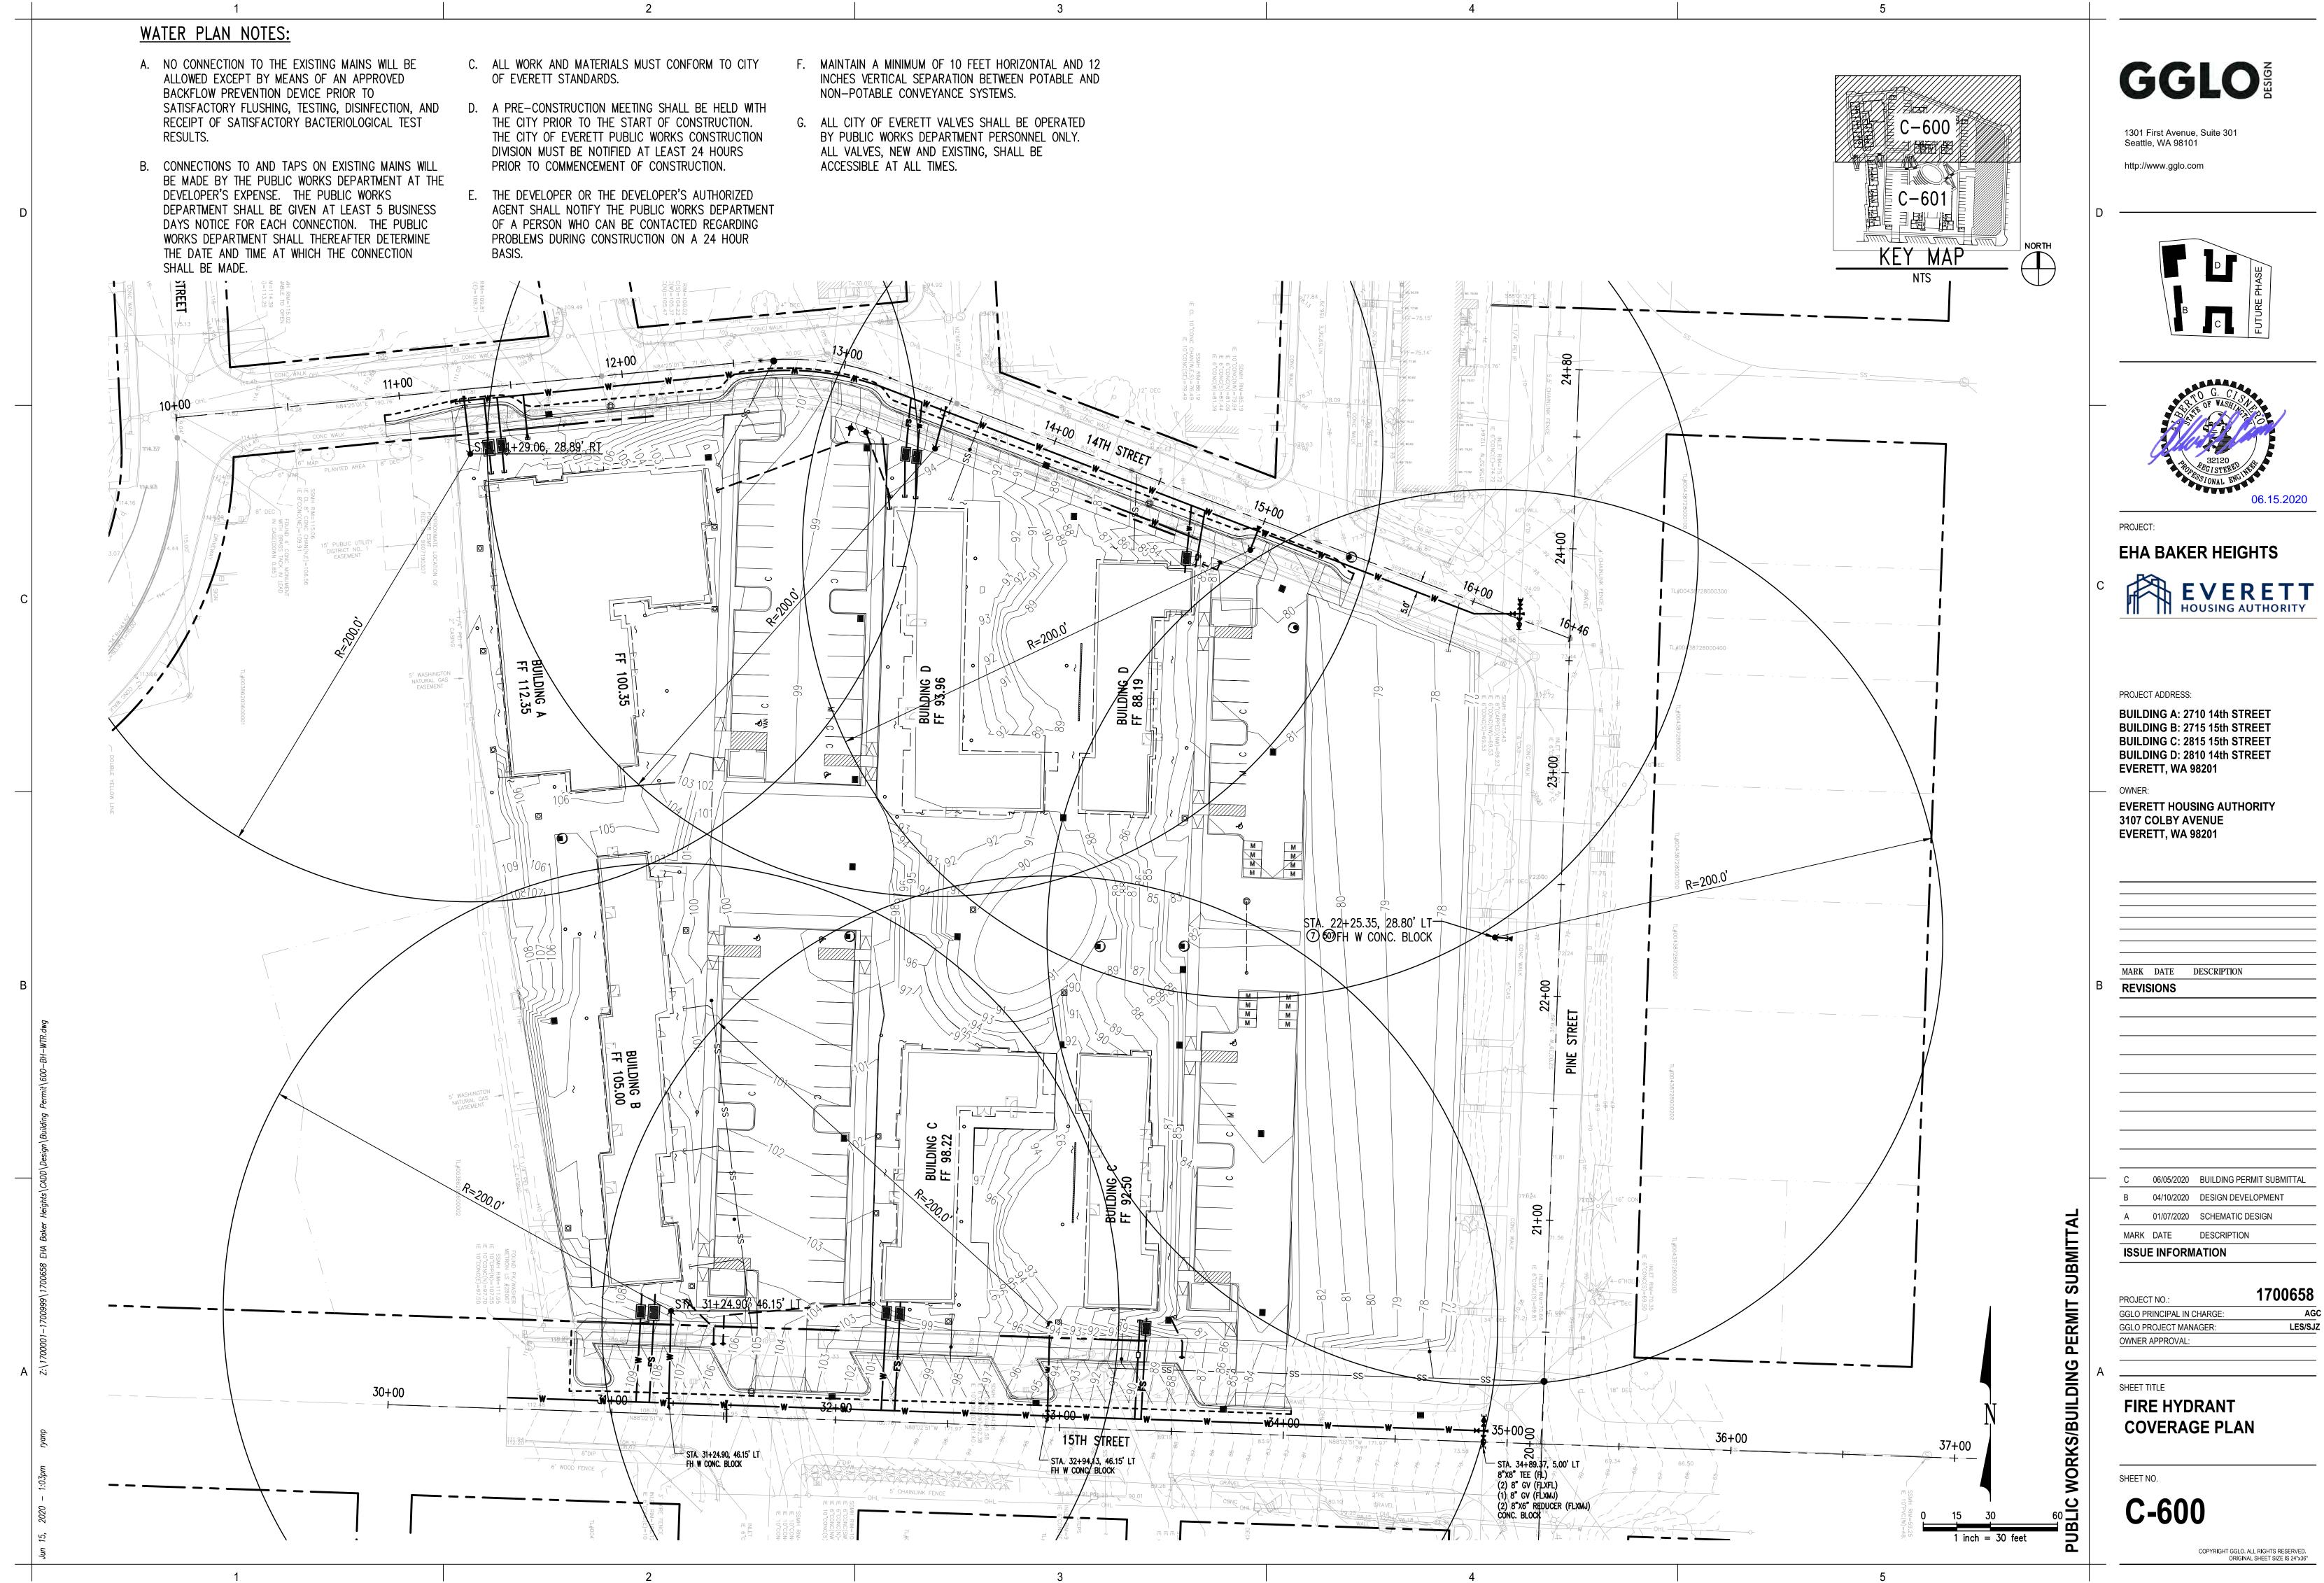

AGC

LES/SJZ

