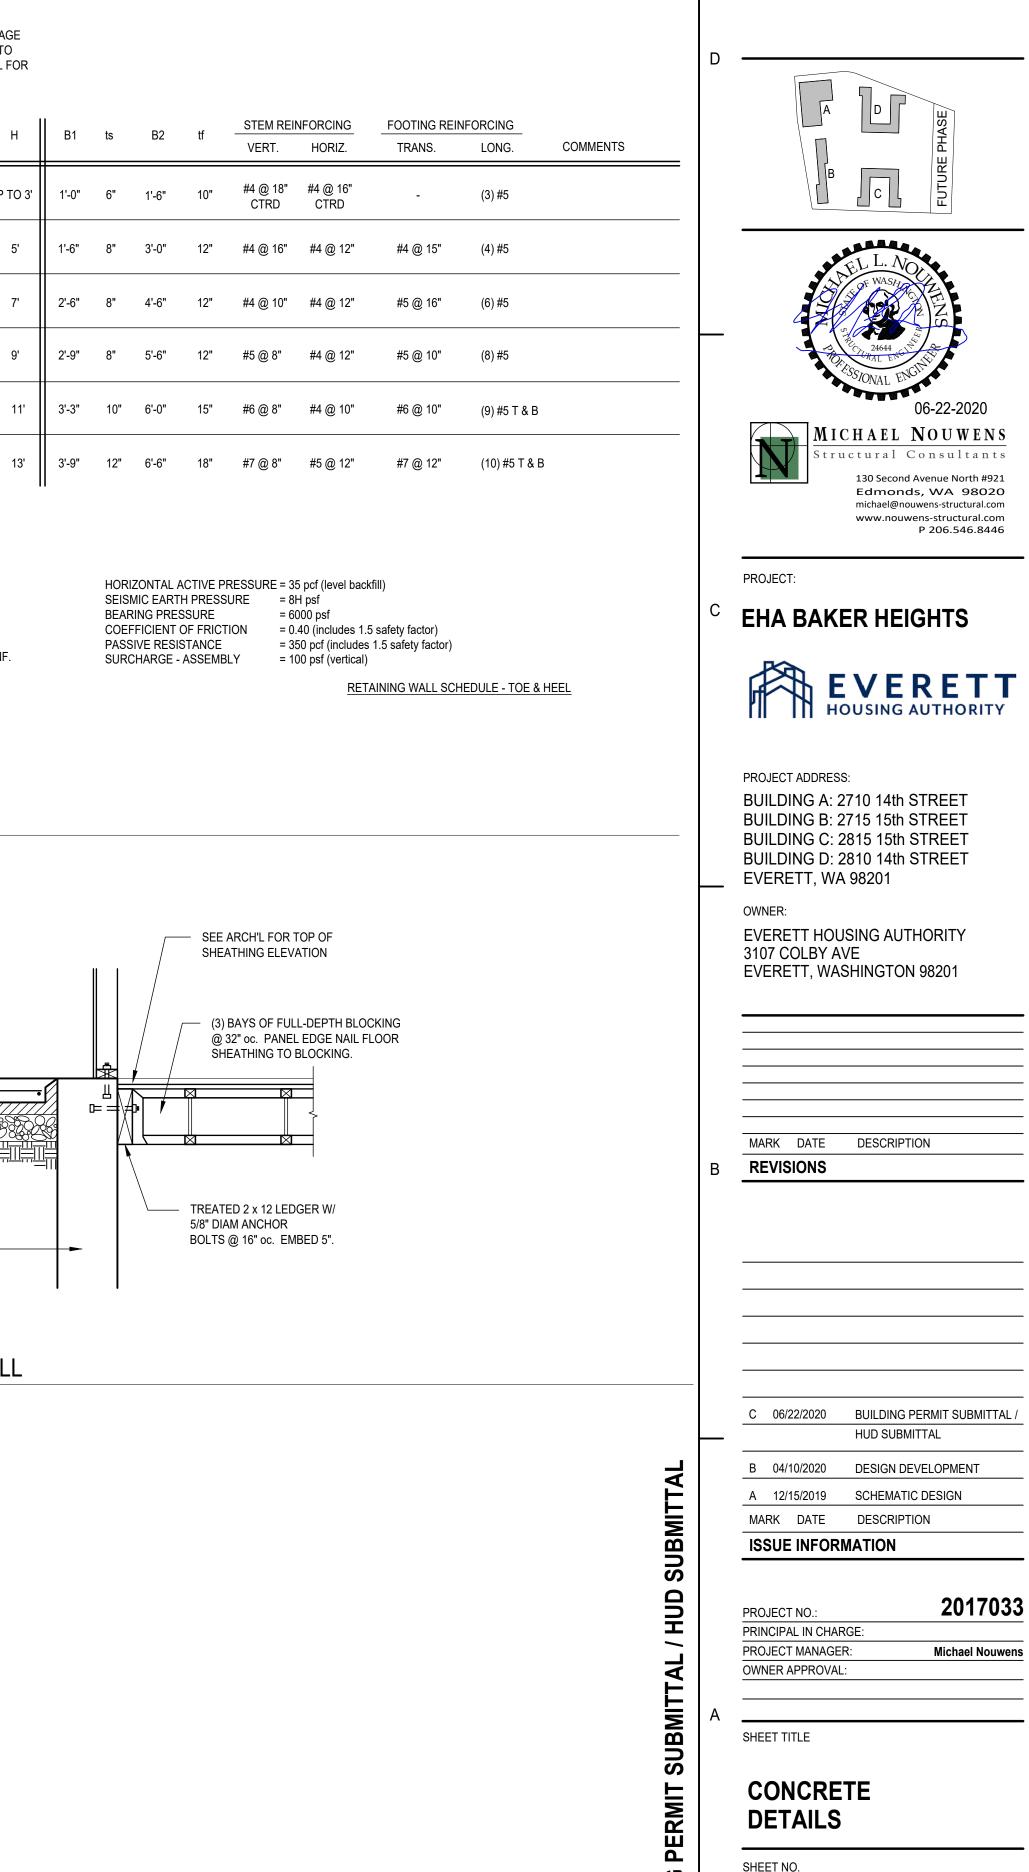


# **GGLO**

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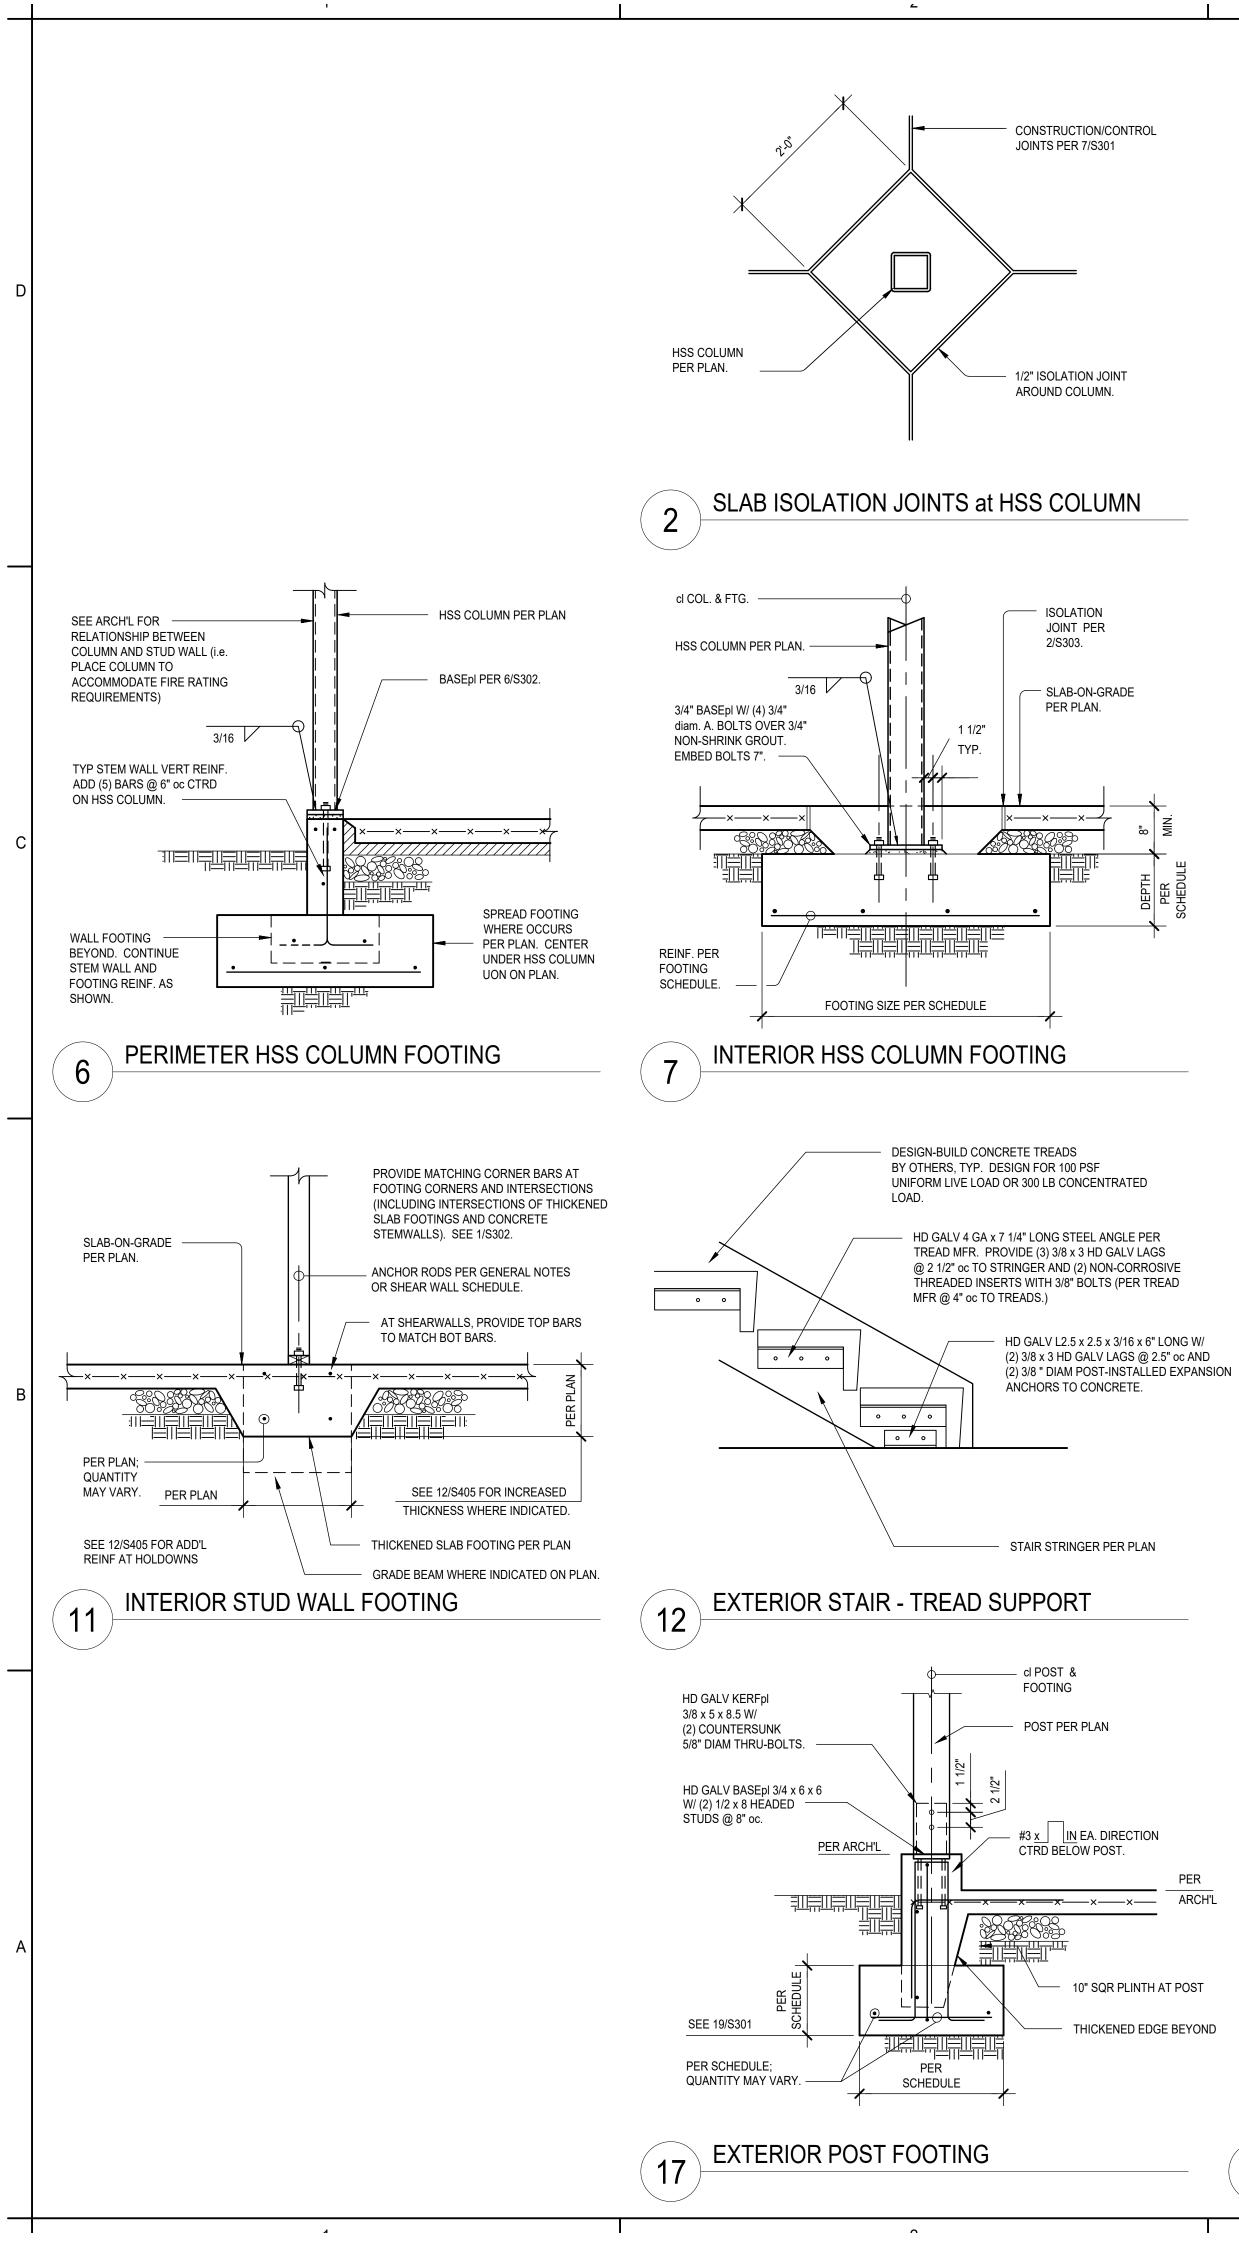
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ORIGINAL SHEET SIZE IS 24"x36"

SHEET NO.

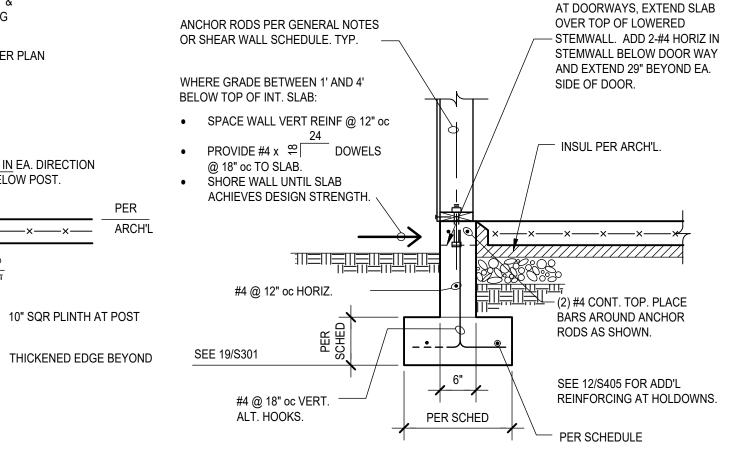
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### EXTERIOR STUD WALL FOOTING 18

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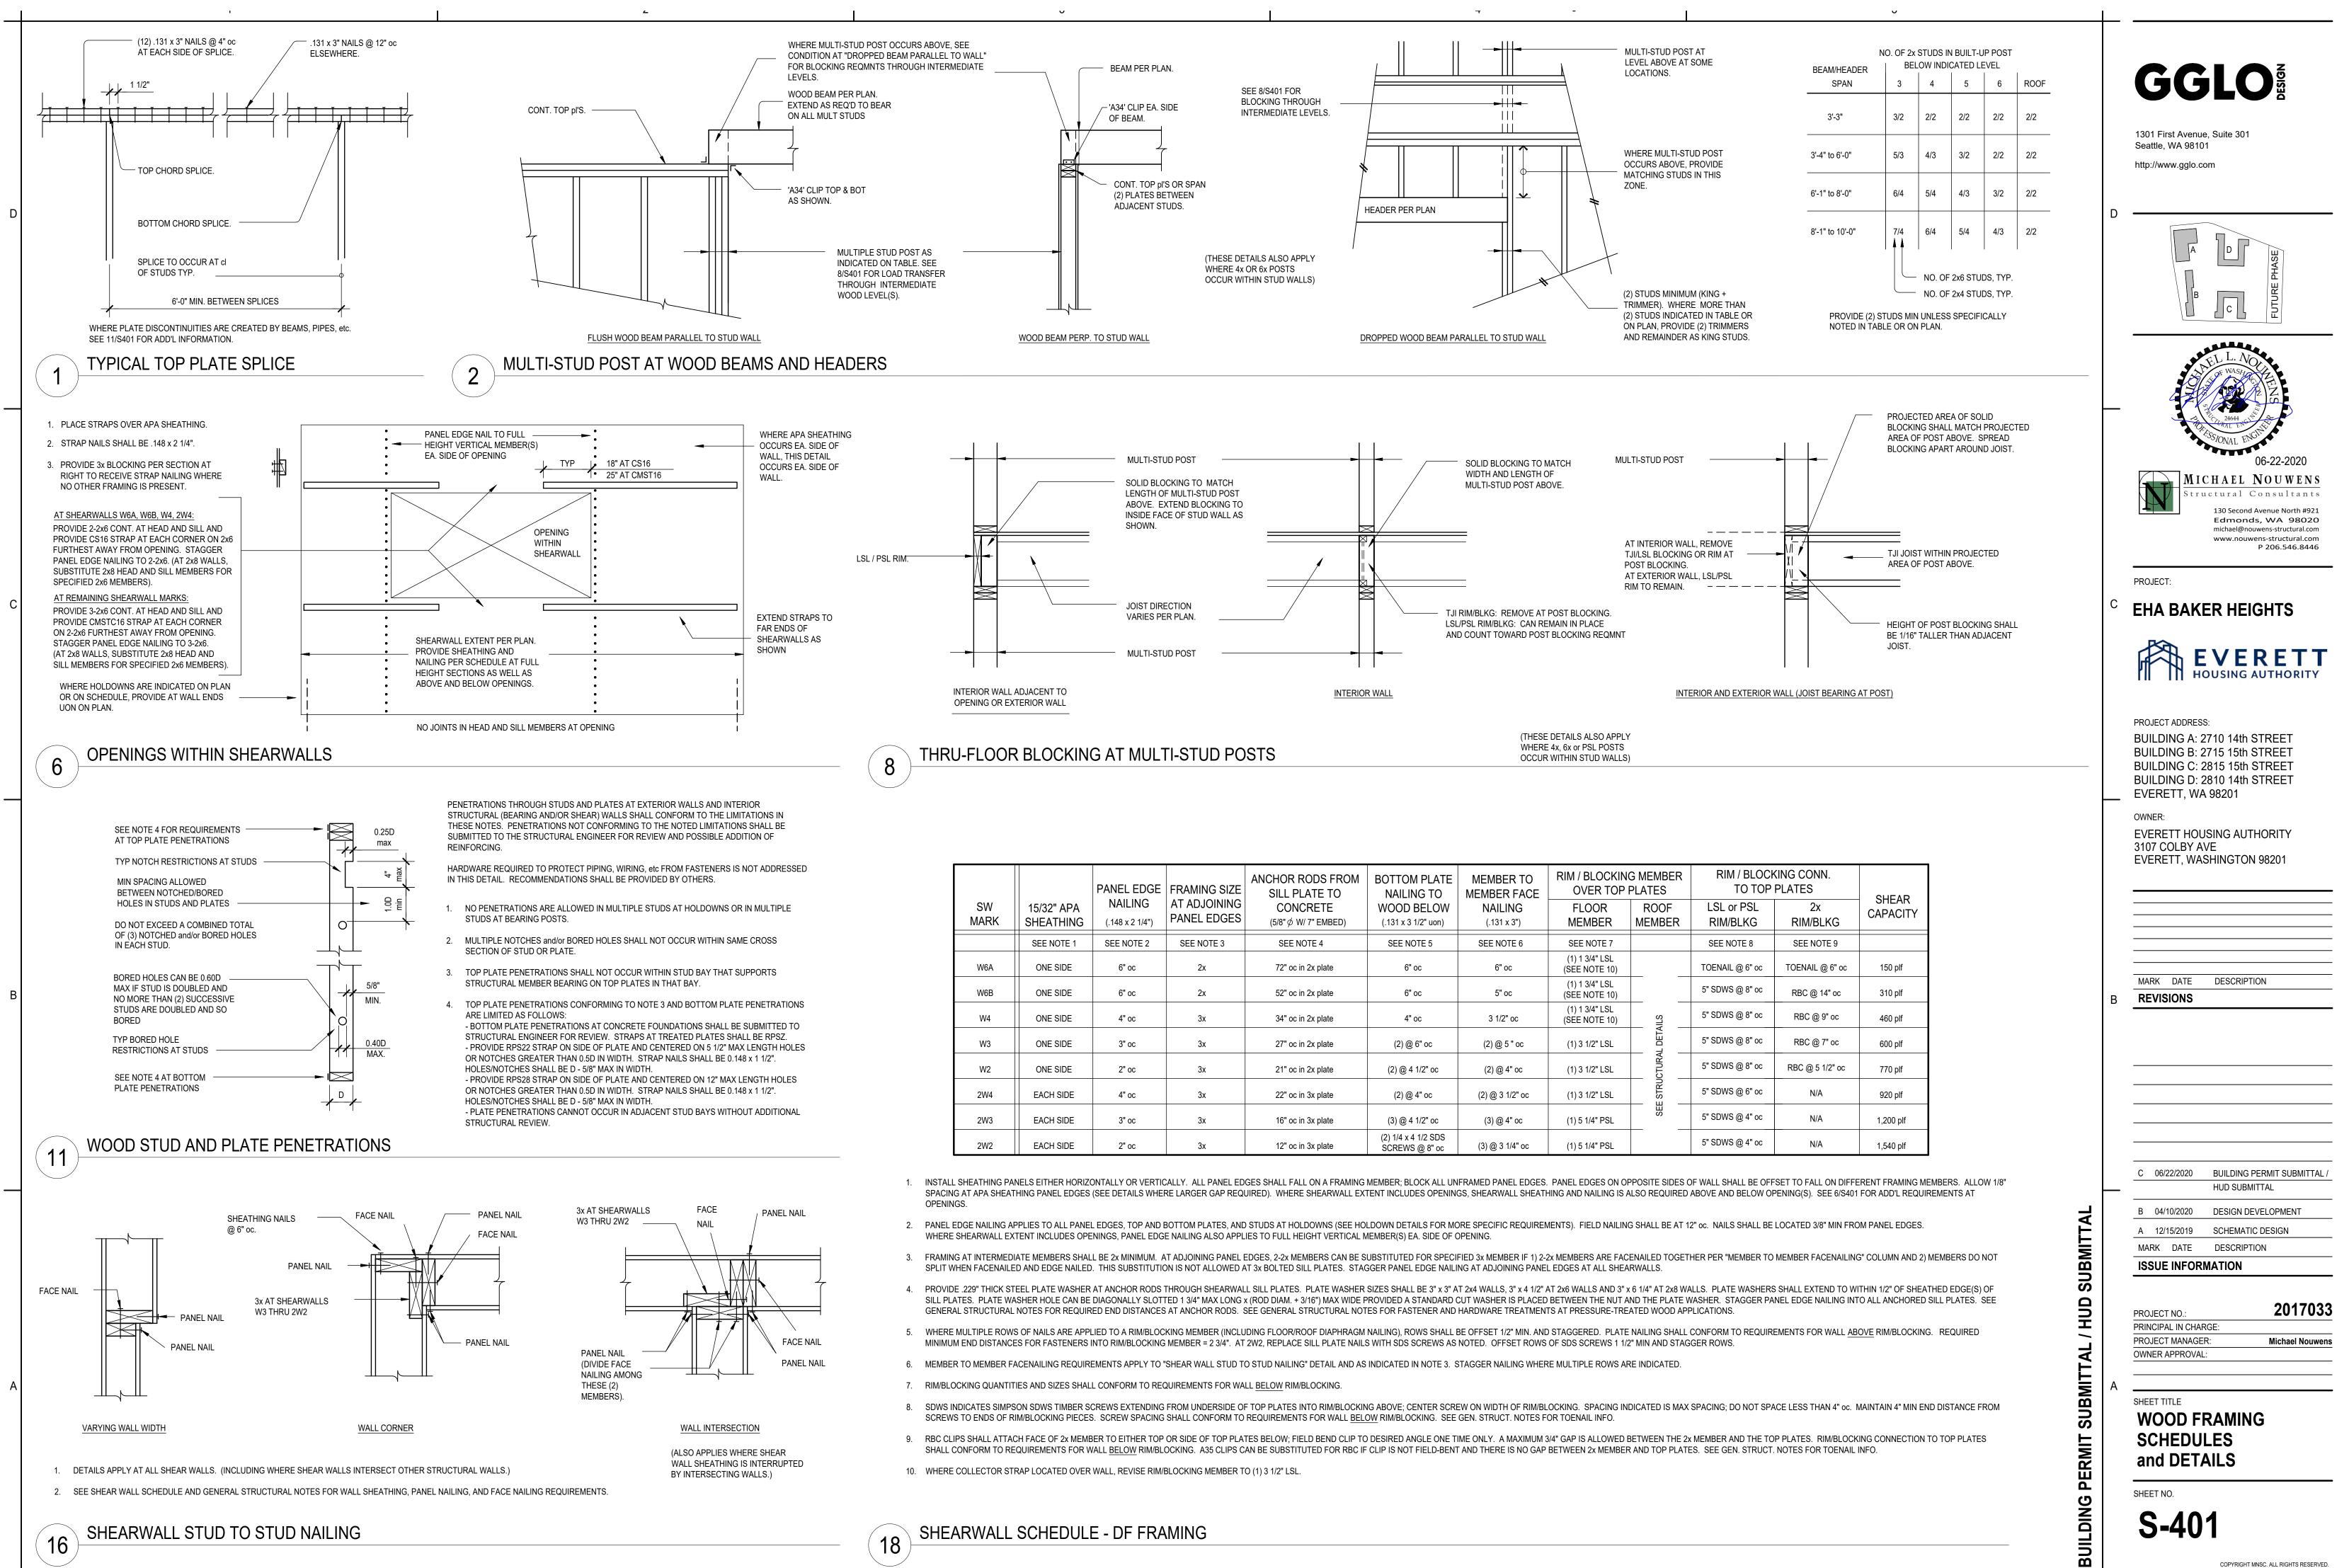


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	<b>GGGLOS</b> 1301 First Avenue, Suite 301 Seattle, WA 98101 http://www.gglo.com
D	A C HASE
	THE L. NO WASSING CONTRACTOR OF THE CONTRACTOR O
	06-22-2020 MICHAEL NOUWENS Structural Consultants 130 Second Avenue North #921 Edmonds, WA 98020 michael@nouwens-structural.com P 206.546.8446
с	PROJECT: EHA BAKER HEIGHTS
	<b>EVERETT</b> HOUSING AUTHORITY
	PROJECT ADDRESS: BUILDING A: 2710 14th STREET BUILDING B: 2715 15th STREET BUILDING C: 2815 15th STREET BUILDING D: 2810 14th STREET EVERETT, WA 98201 OWNER:
	EVERETT HOUSING AUTHORITY 3107 COLBY AVE EVERETT, WASHINGTON 98201
В	MARK DATE DESCRIPTION REVISIONS
	C 06/22/2020 BUILDING PERMIT SUBMITTAL / HUD SUBMITTAL
TAL	B04/10/2020DESIGN DEVELOPMENTA12/15/2019SCHEMATIC DESIGN
SUBMITTA	MARK DATE DESCRIPTION
HU /	PROJECT NO.: 2017033 PRINCIPAL IN CHARGE: PROJECT MANAGER: Michael Nouwens
ITAL	OWNER APPROVAL:
BUILDING PERMIT SUBMITTAL / HU	SHEET TITLE MISC FOUNDATION DETAILS
	SHEET NO. <b>S-303</b> COPYRIGHT MNSC. ALL RIGHTS RESERVED.

ORIGINAL SHEET SIZE IS 24"x36"

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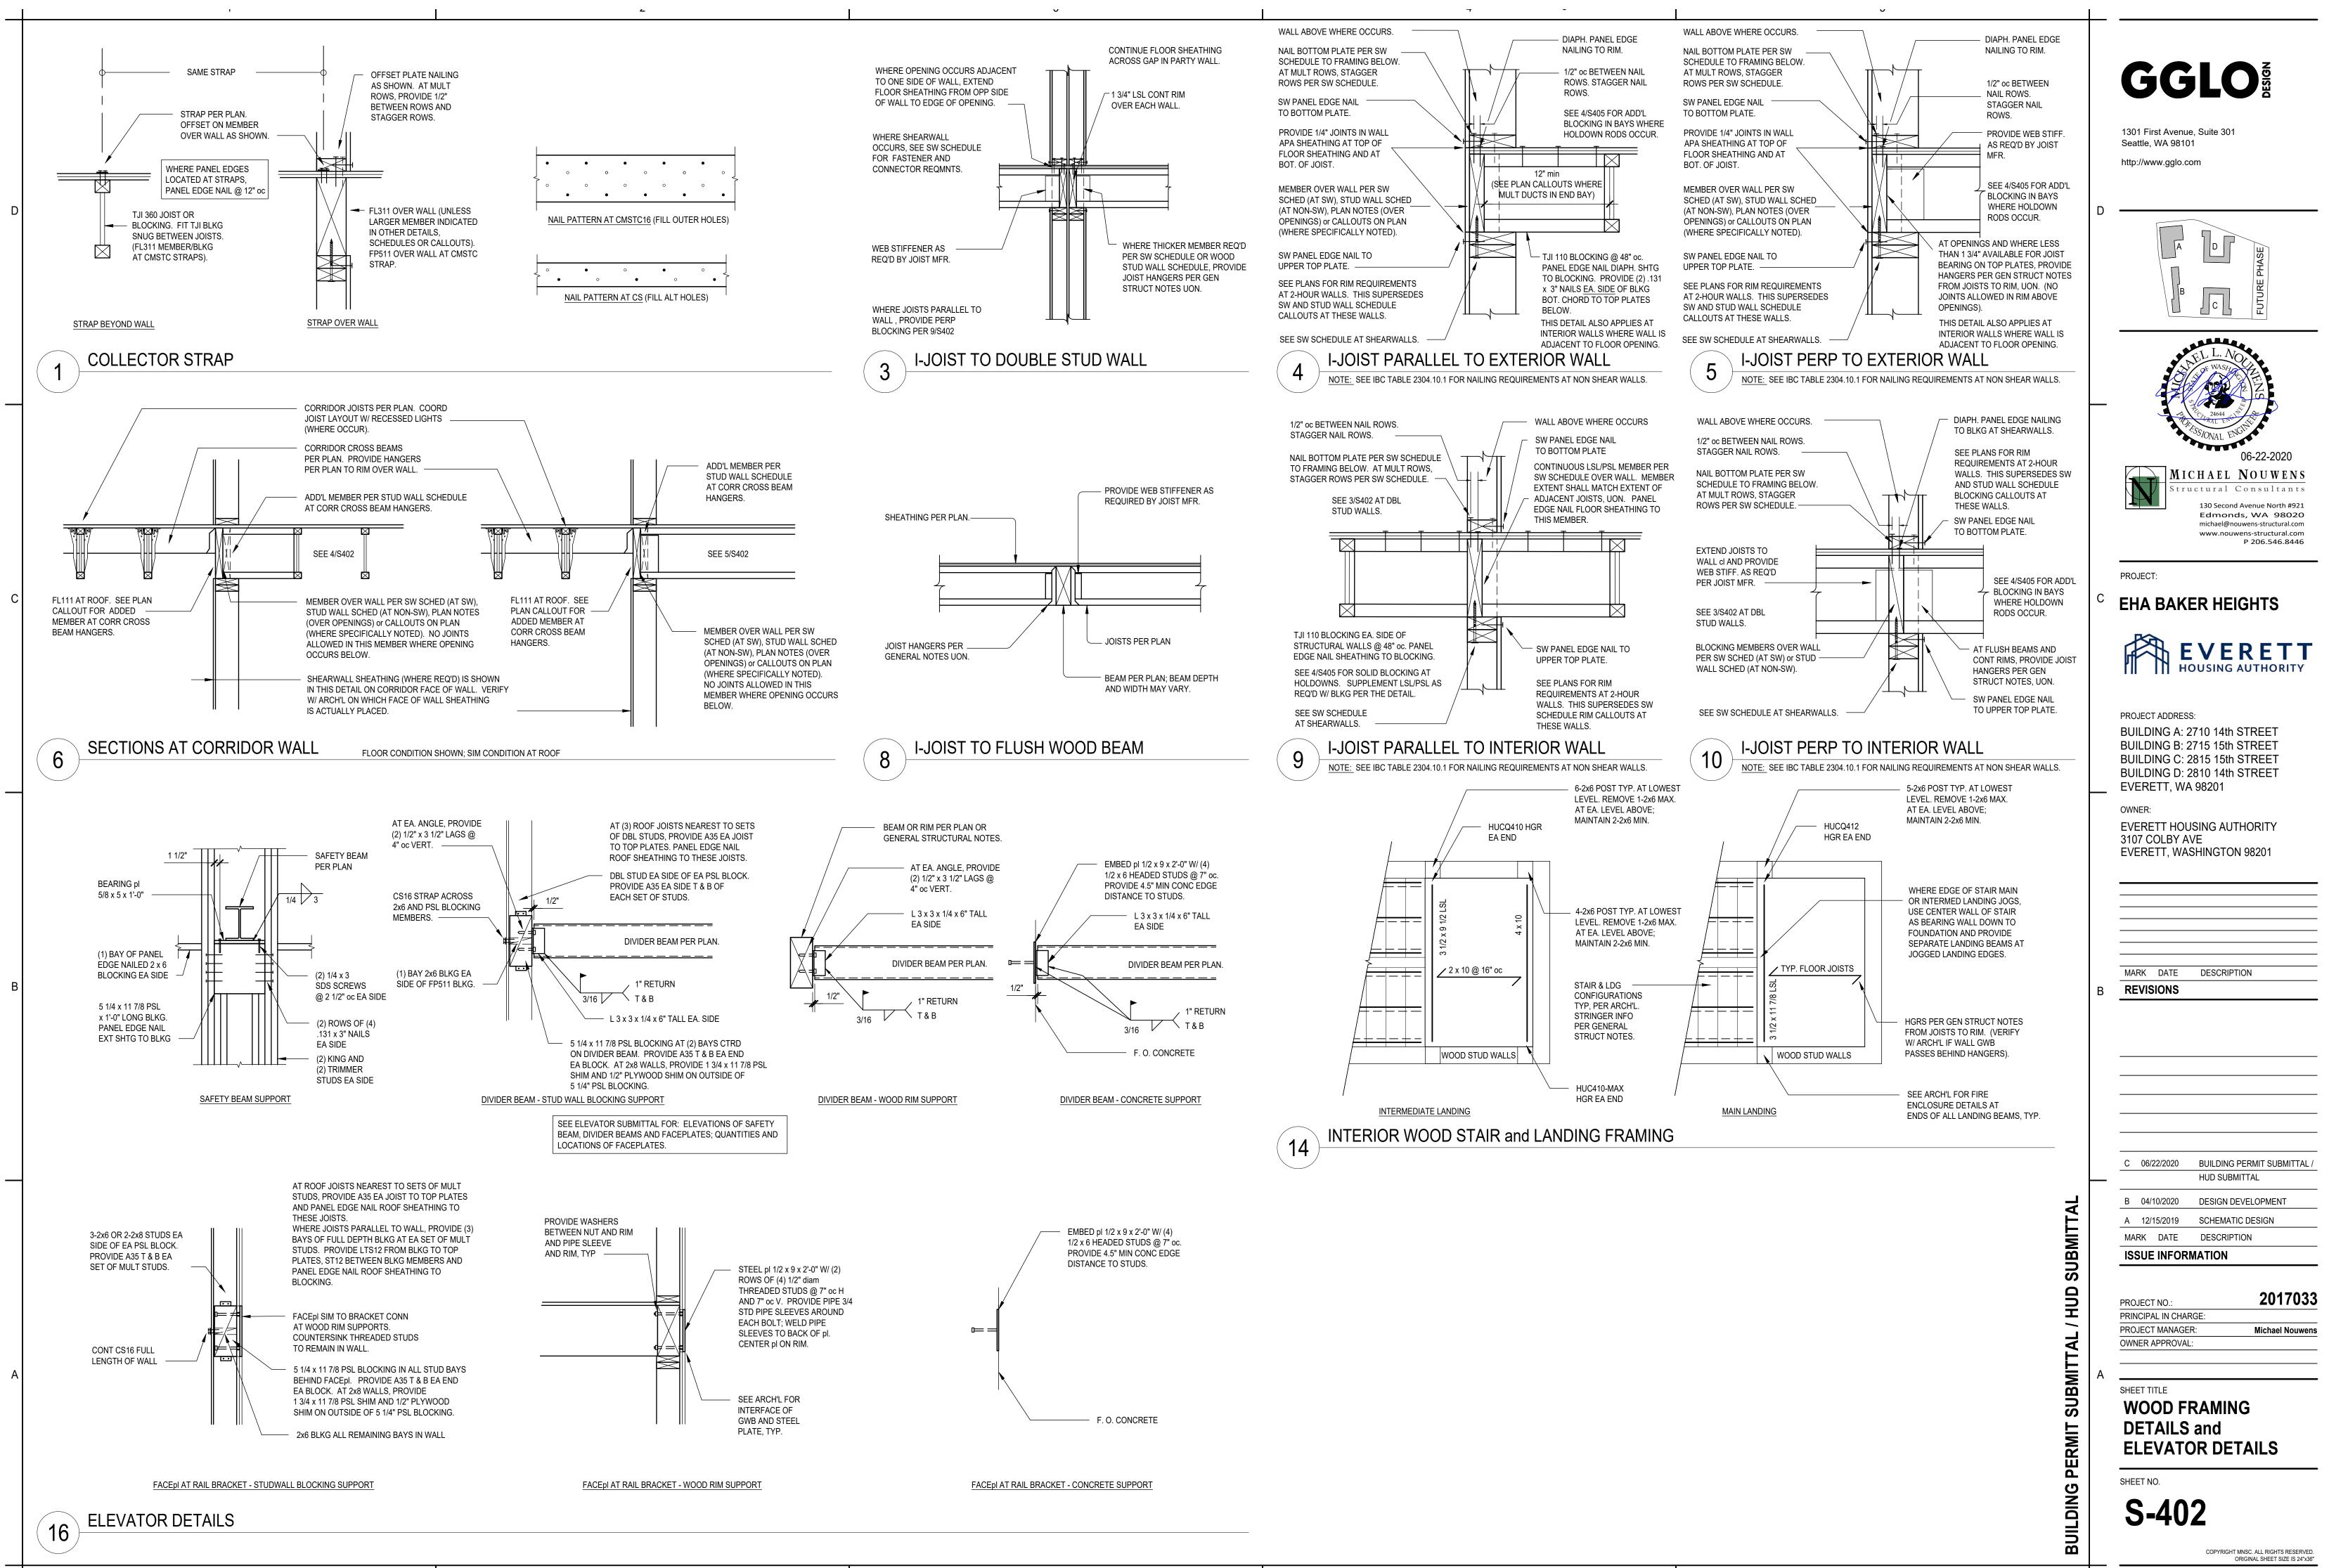
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		PANEL EDGE	FRAMING SIZE	ANCHOR RODS FROM SILL PLATE TO	BOTTOM PLATE NAILING TO	MEMBER TO MEMBER FACE	RIM / BLOCKIN OVER TOP	
SW MARK	15/32" APA SHEATHING	NAILING (.148 x 2 1/4")	AT ADJOINING PANEL EDGES	CONCRETE (5/8" Ø W/ 7" EMBED)	WOOD BELOW (.131 x 3 1/2" uon)	NAILING (.131 x 3")	FLOOR MEMBER	RO MEM
	SEE NOTE 1	SEE NOTE 2	SEE NOTE 3	SEE NOTE 4	SEE NOTE 5	SEE NOTE 6	SEE NOTE 7	
W6A	ONE SIDE	6" ос	2x	72" oc in 2x plate	6" ос	6" ос	(1) 1 3/4" LSL (SEE NOTE 10)	
W6B	ONE SIDE	6" ос	2x	52" oc in 2x plate	6" ос	5" ос	(1) 1 3/4" LSL (SEE NOTE 10)	
W4	ONE SIDE	4" oc	3x	34" oc in 2x plate	4" oc	3 1/2" oc	(1) 1 3/4" LSL (SEE NOTE 10)	c
W3	ONE SIDE	3" ос	3x	27" oc in 2x plate	(2) @ 6" oc	(2) @ 5 " oc	(1) 3 1/2" LSL	
W2	ONE SIDE	2" oc	3x	21" oc in 2x plate	(2) @ 4 1/2" oc	(2) @ 4" oc	(1) 3 1/2" LSL	
2W4	EACH SIDE	4" oc	3x	22" oc in 3x plate	(2) @ 4" oc	(2) @ 3 1/2" oc	(1) 3 1/2" LSL	
2W3	EACH SIDE	3" ос	3x	16" oc in 3x plate	(3) @ 4 1/2" oc	(3) @ 4" oc	(1) 5 1/4" PSL	
2W2	EACH SIDE	2" oc	3x	12" oc in 3x plate	(2) 1/4 x 4 1/2 SDS SCREWS @ 8" oc	(3) @ 3 1/4" oc	(1) 5 1/4" PSL	

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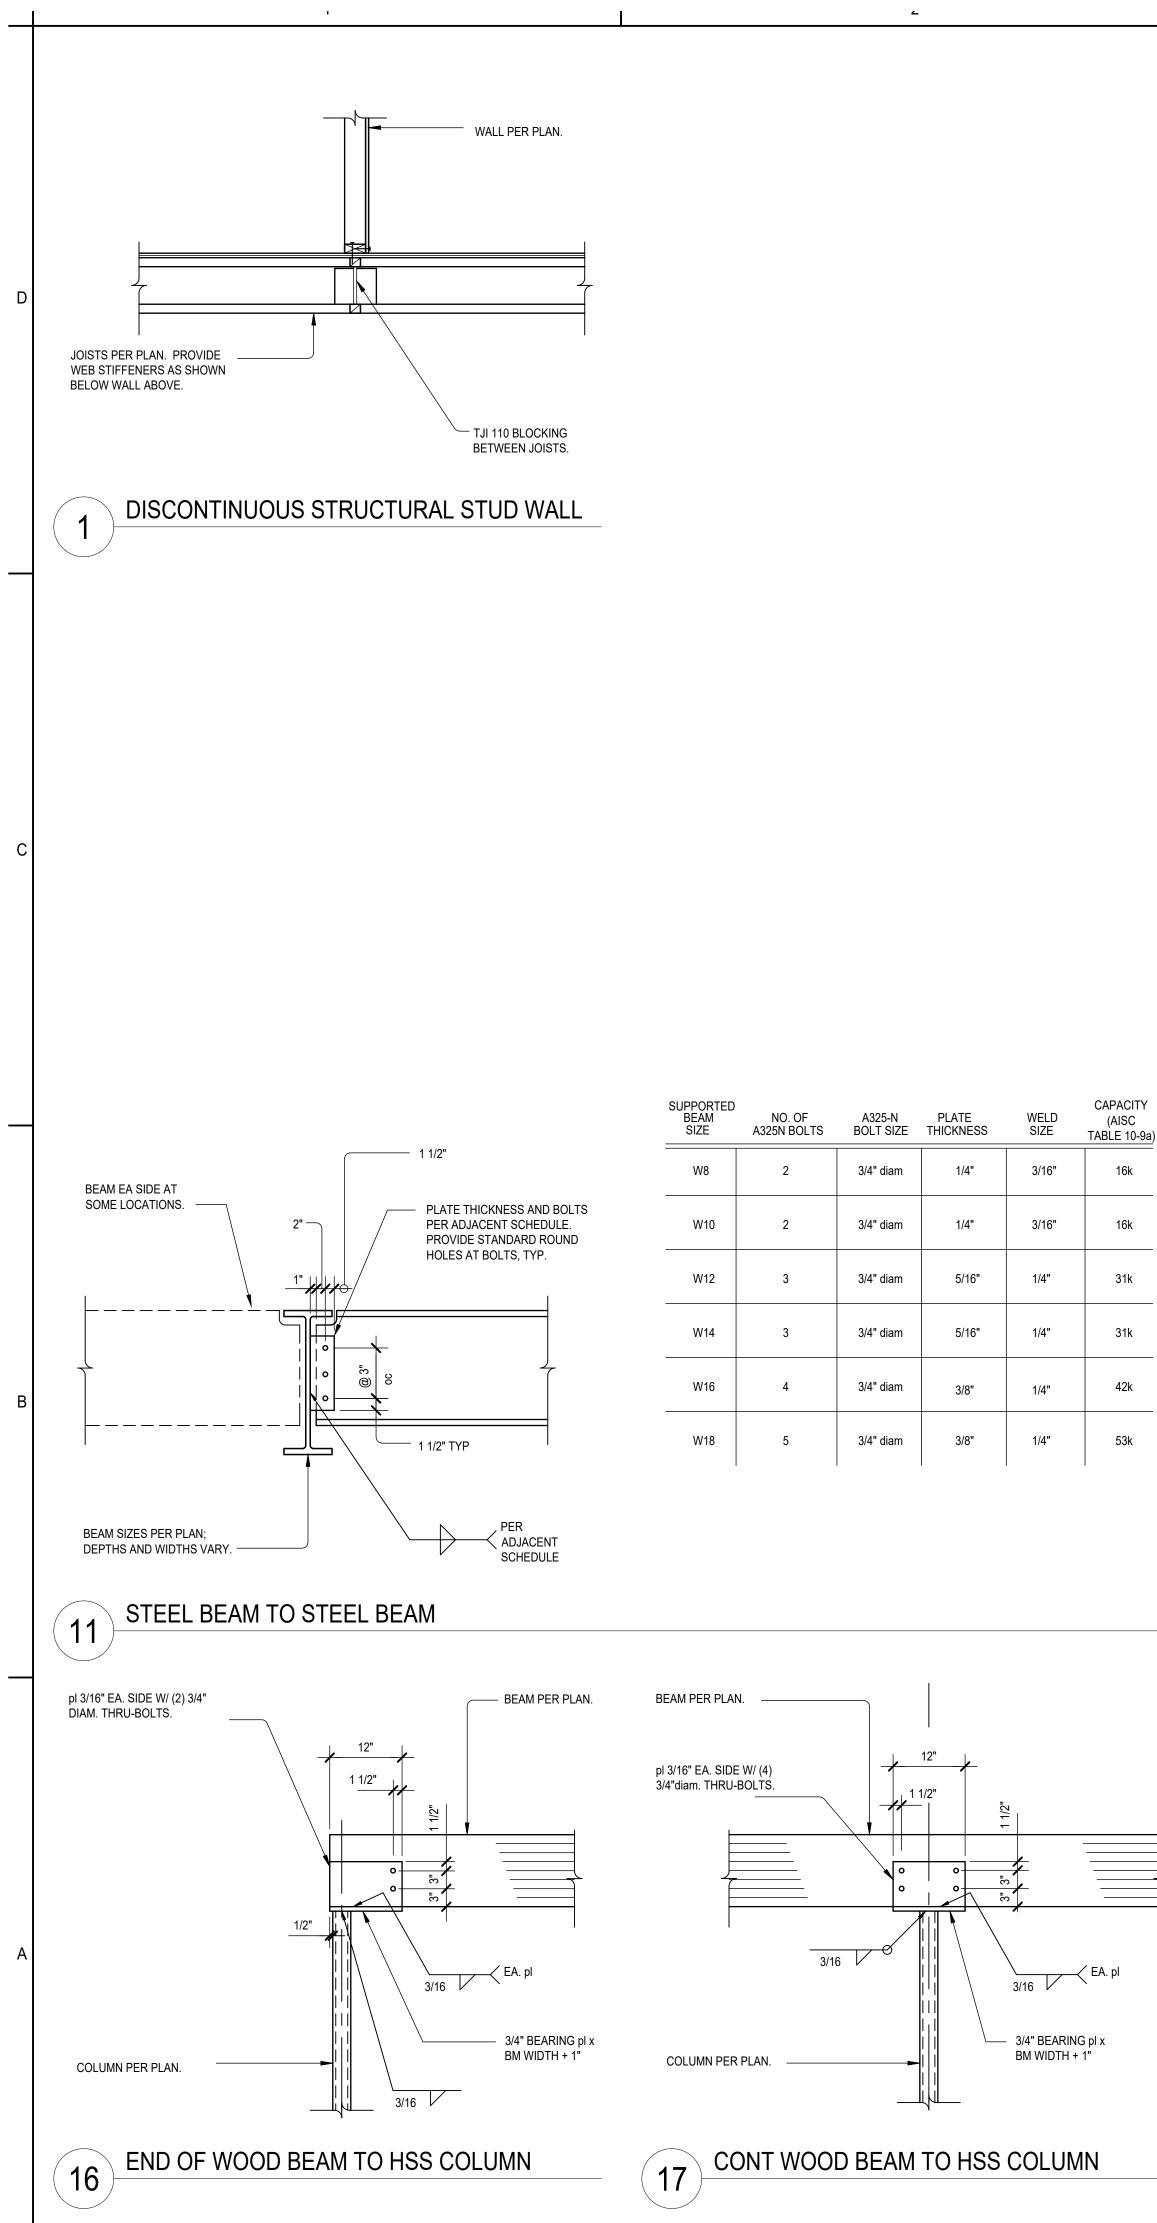
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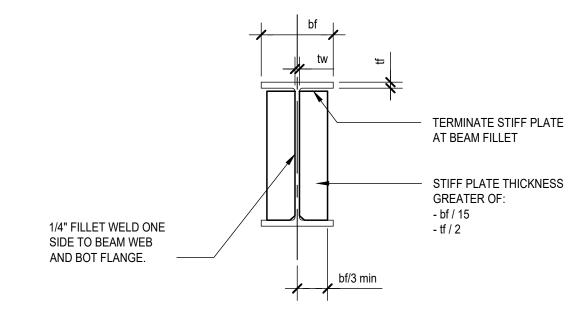
APPLICABLE TO DETAILS

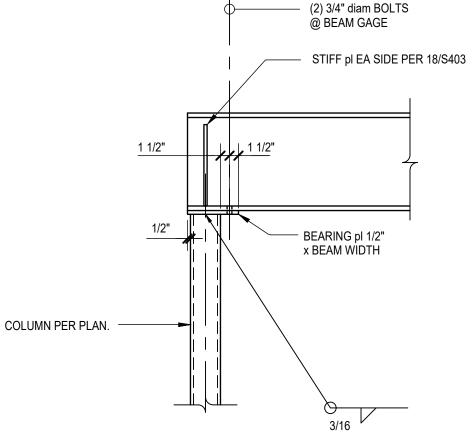
26 AND 27/S402

END OF STEEL BEAM TO HSS COLUMN

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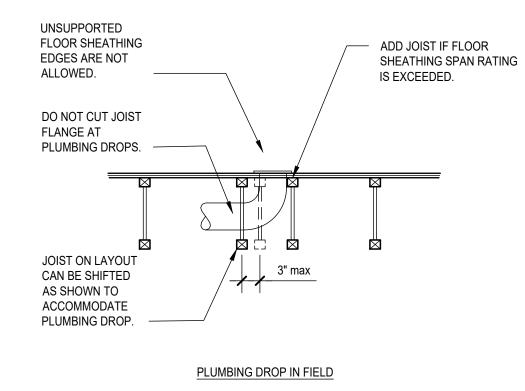
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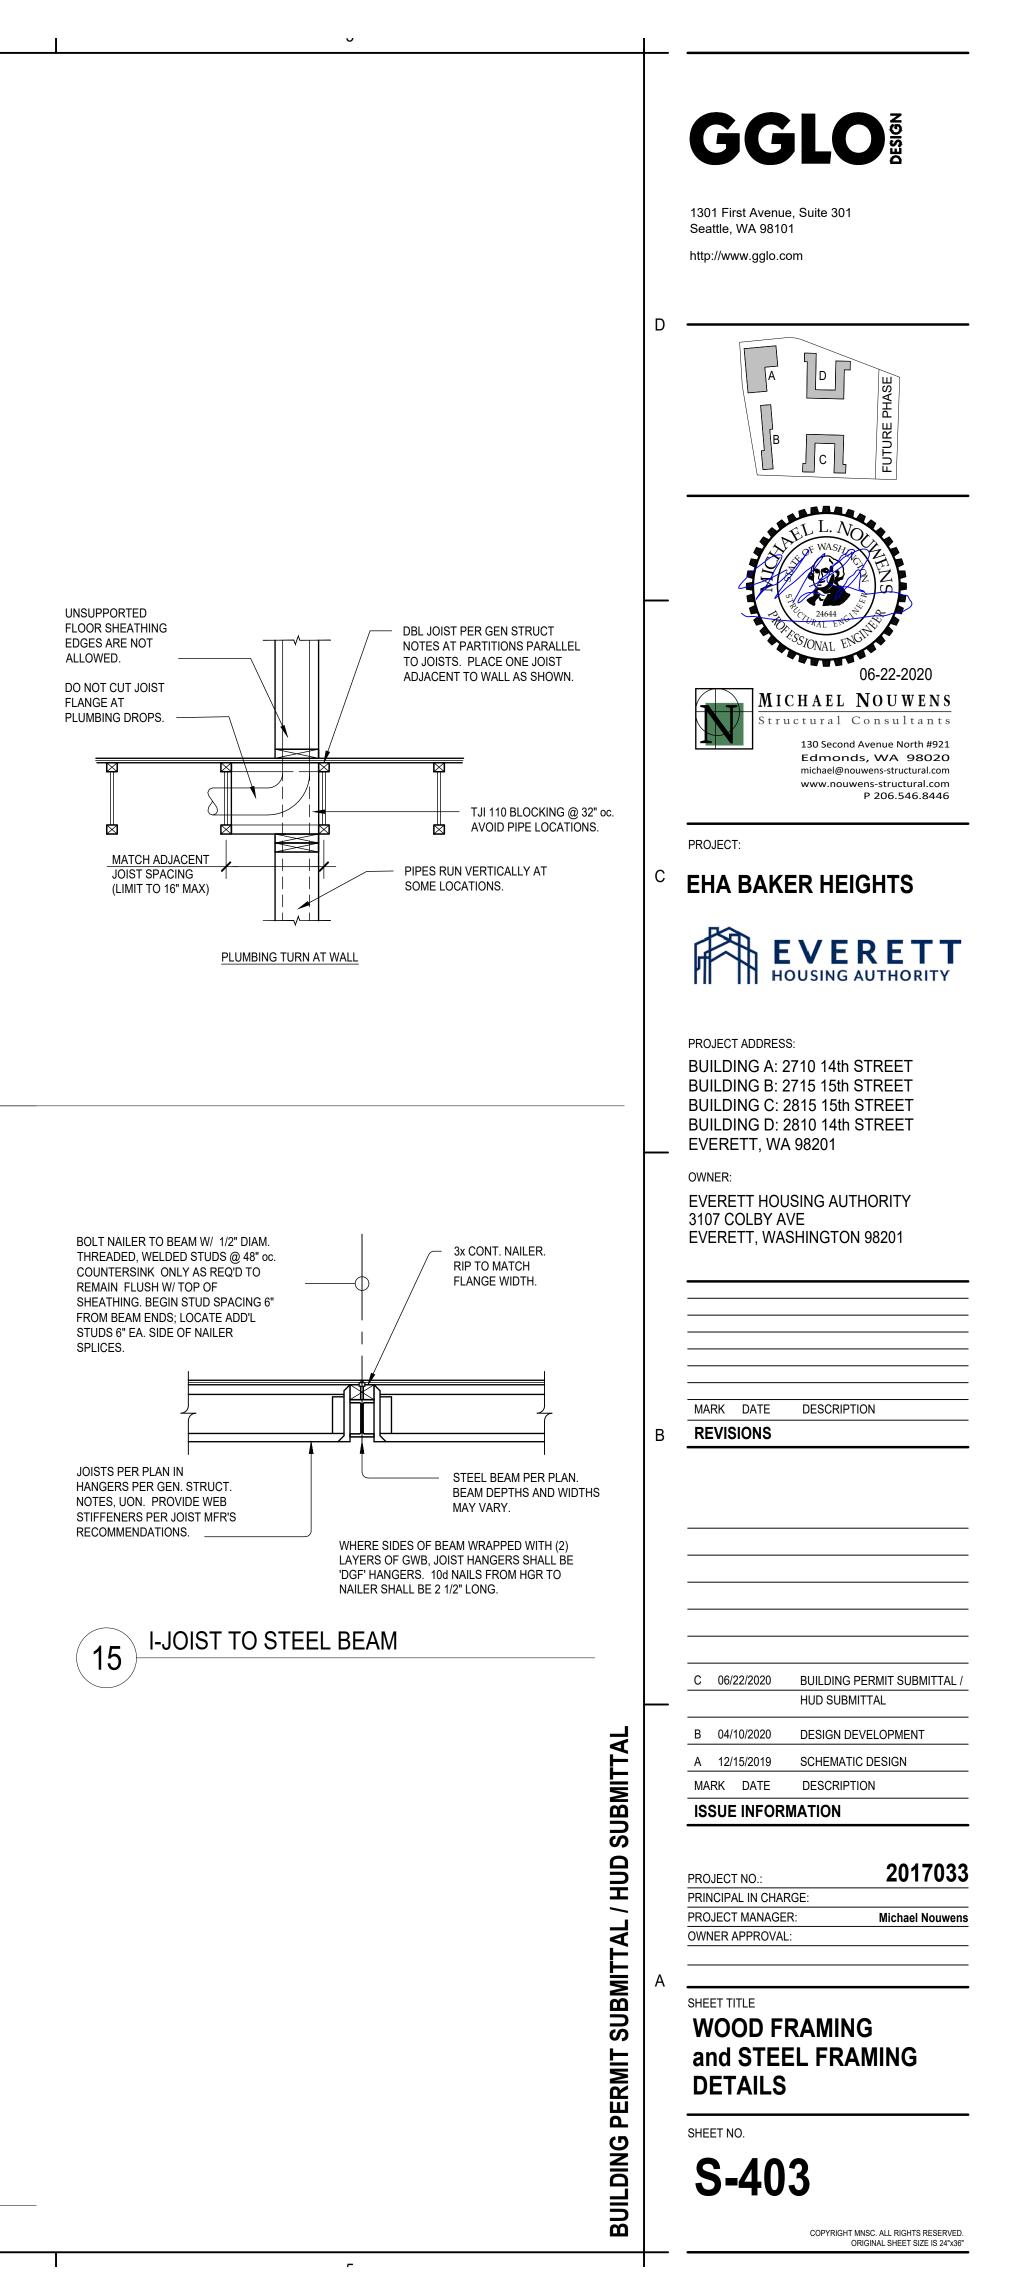


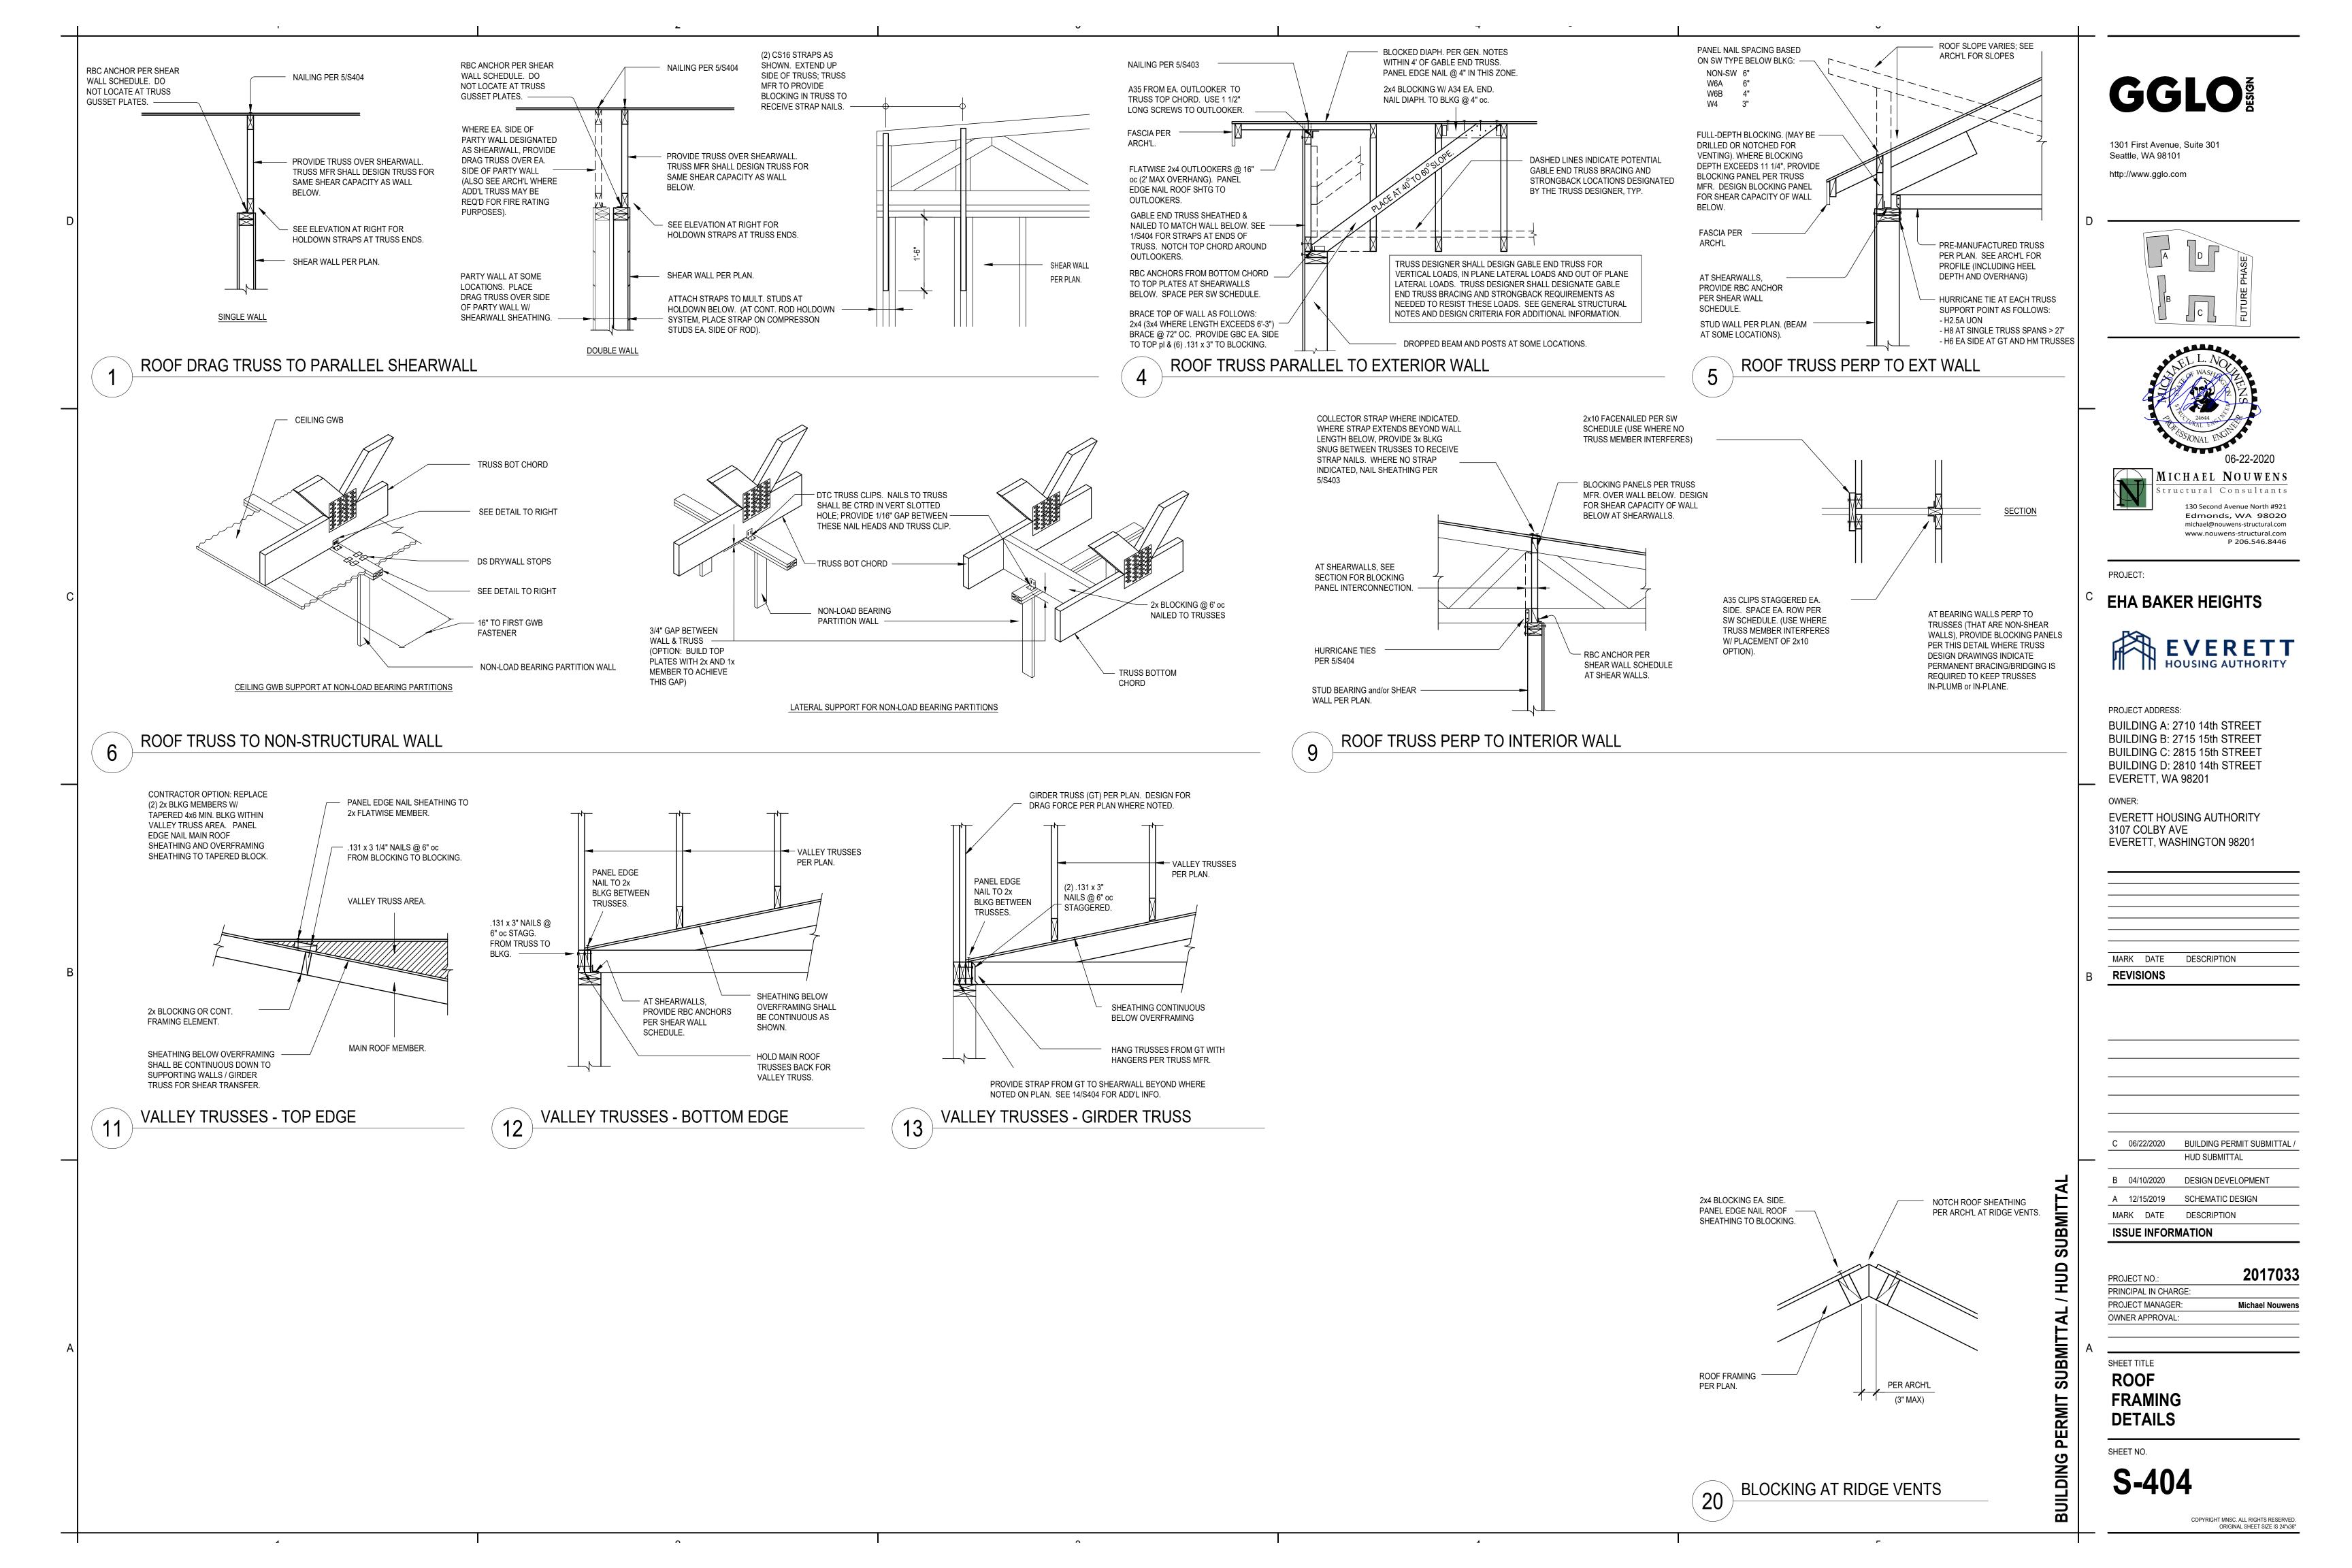


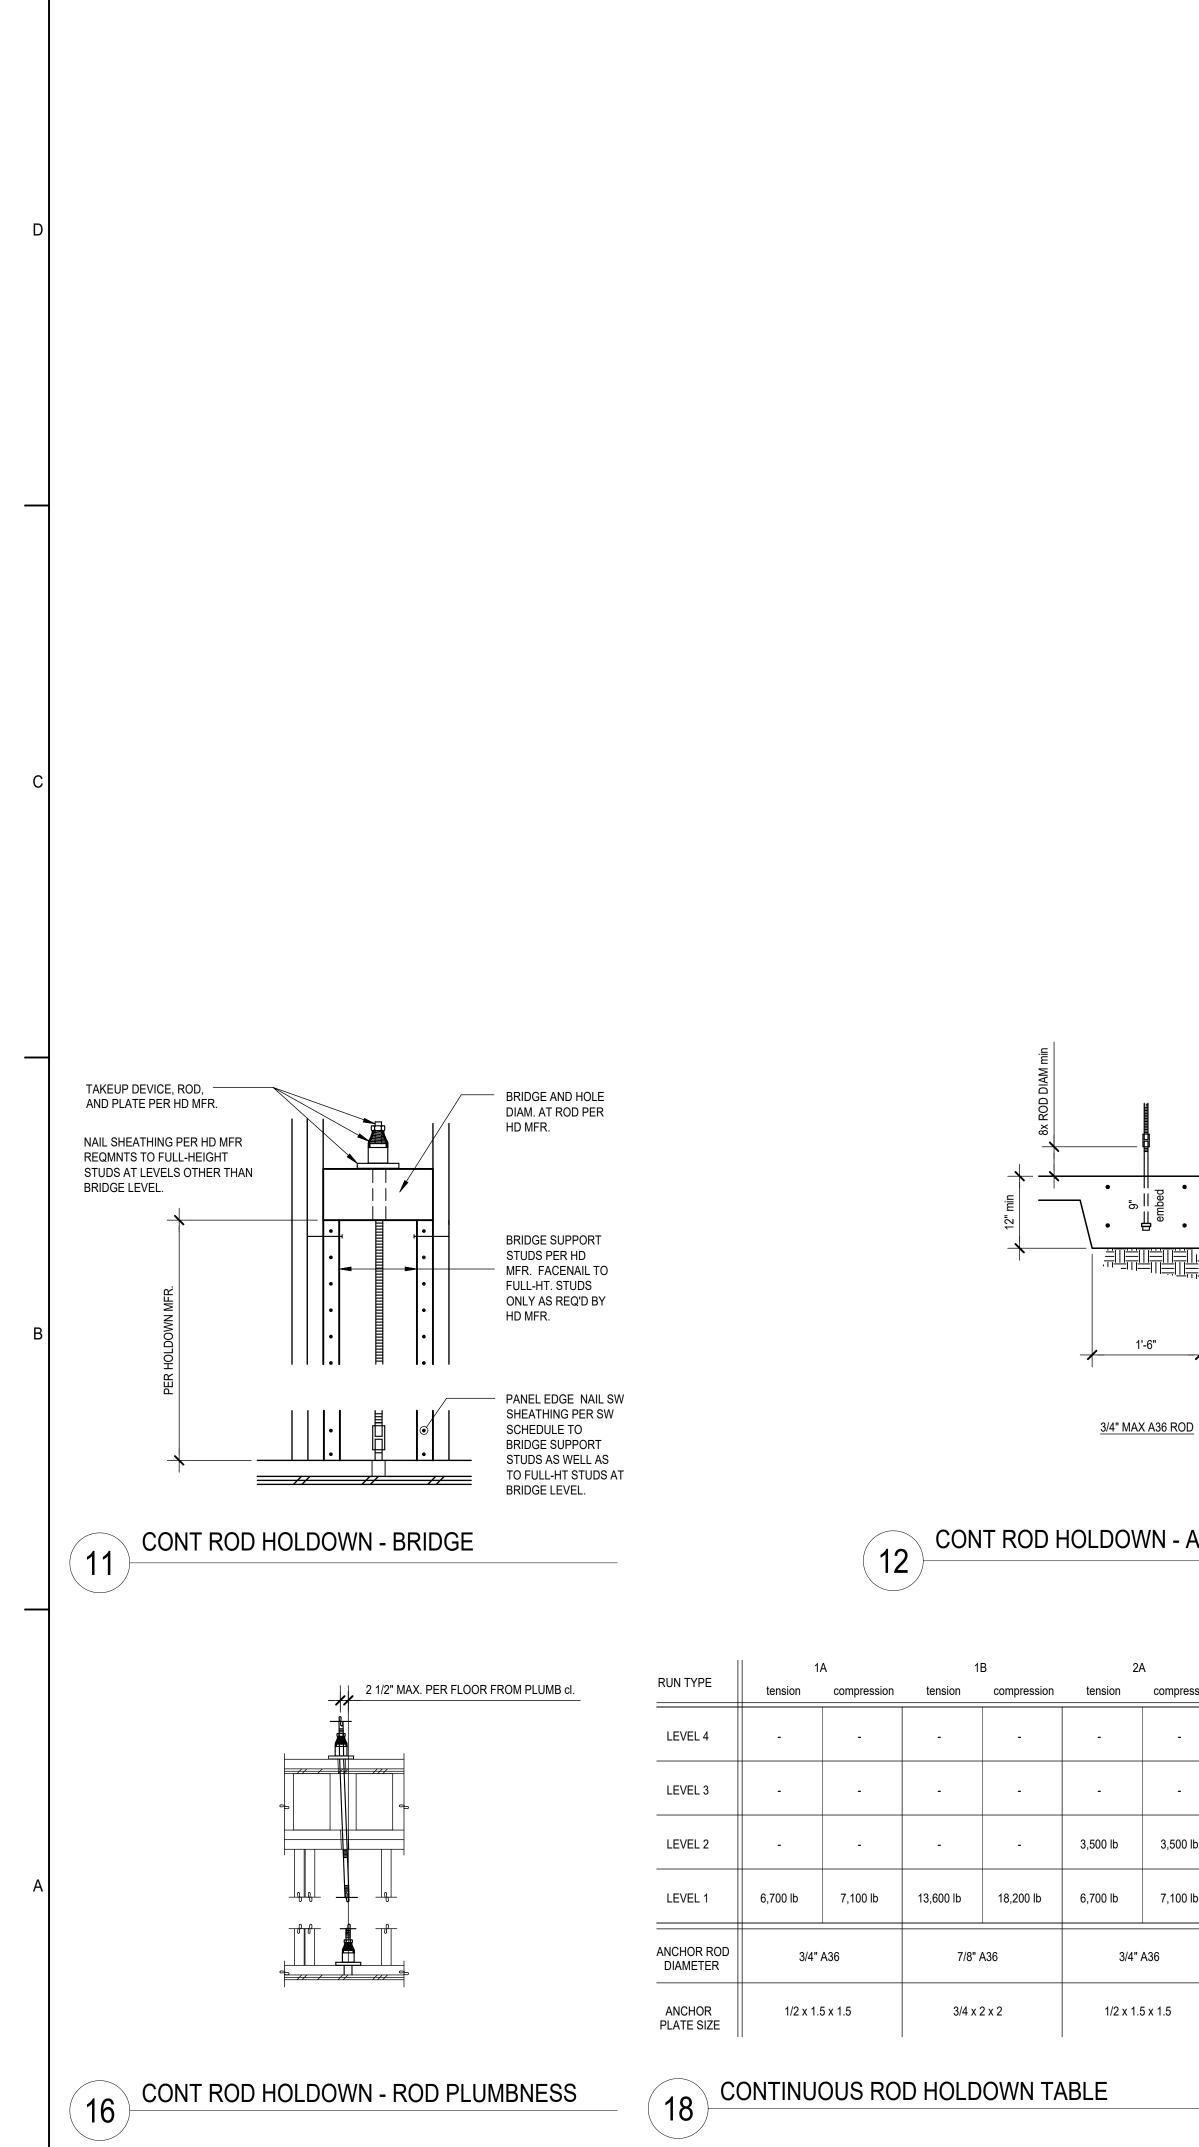
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JOIST LAYOUT AT PLUMBING DROP 9





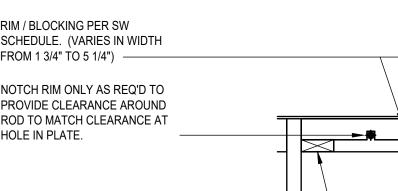


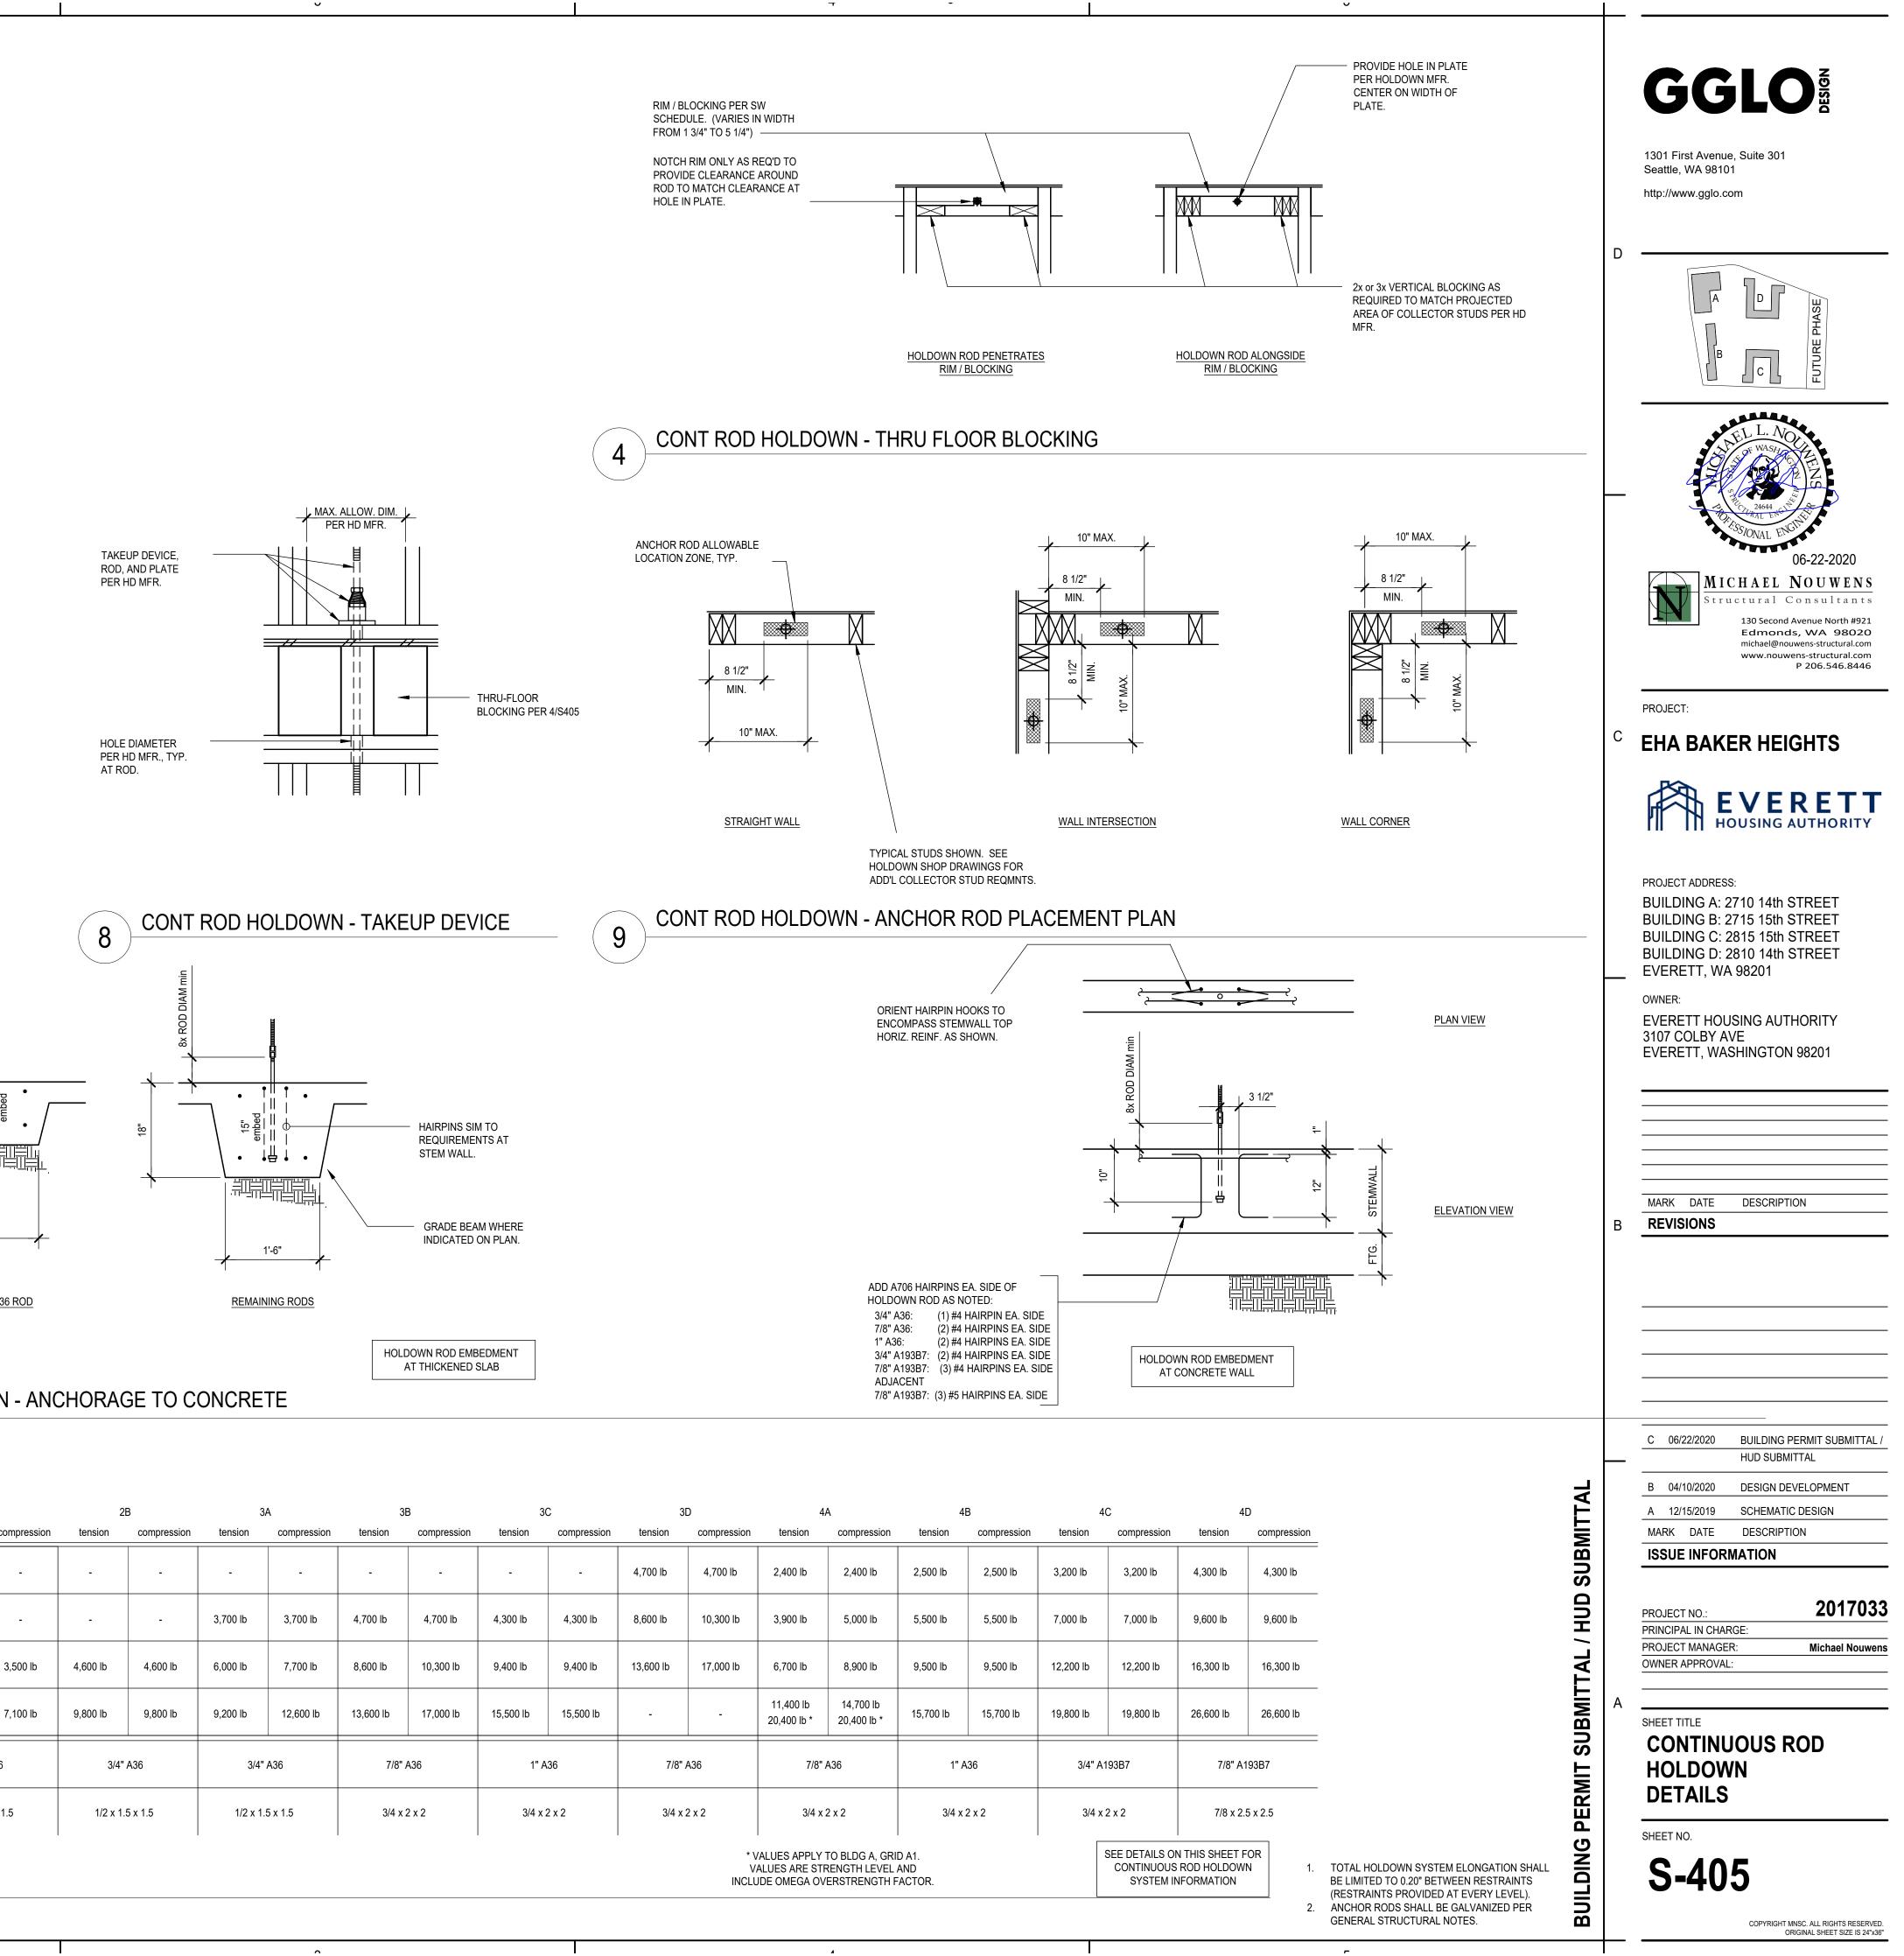


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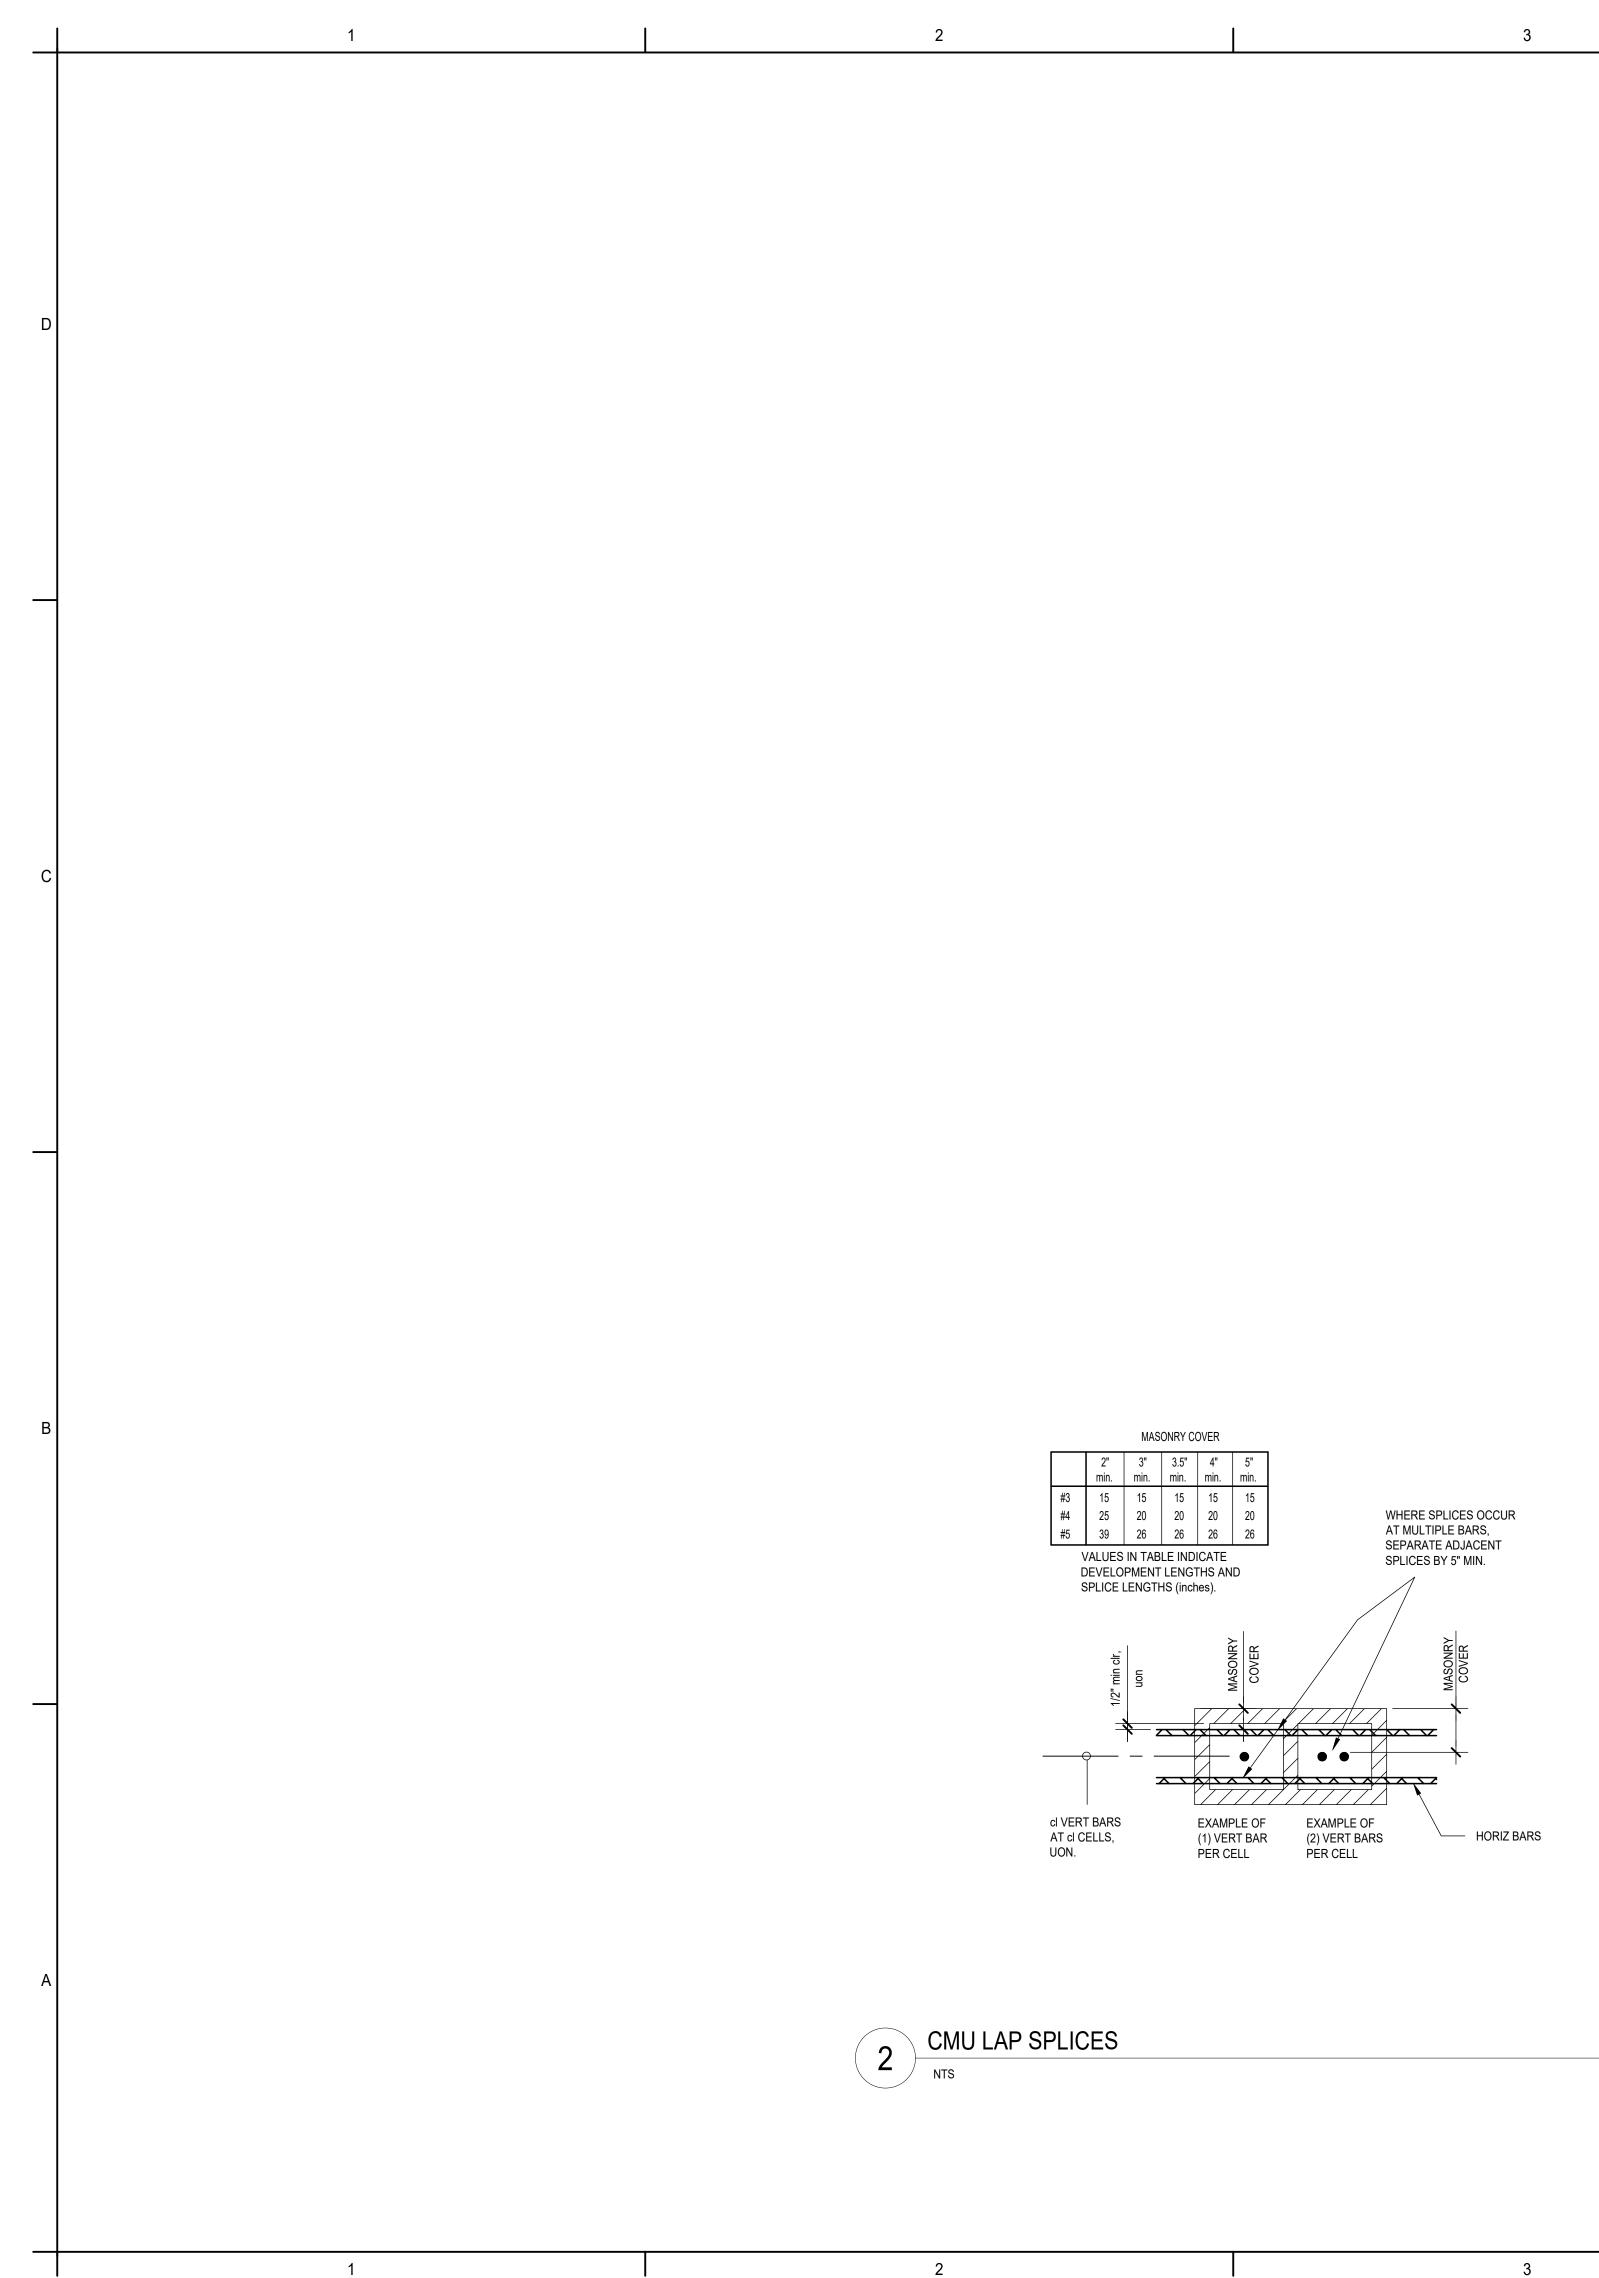
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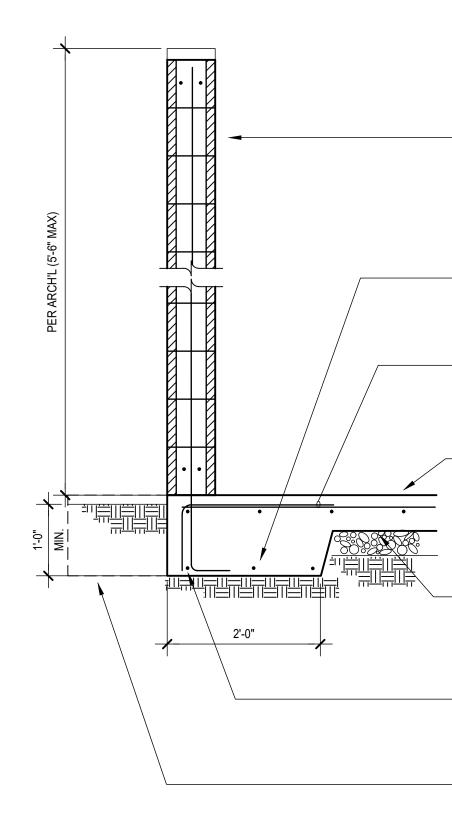




CONT ROD HOLDOWN - ANCHORAGE TO CONCRETE

2/	A	2	В	3/	4	38	3	30	C	31	C	4/	4	48	3
	compression	tension	compression	tension	compression	tension	compression	tension	compression	tension	compression	tension	compression	tension	compression
	-	-	-	-	-	-	-	-	-	4,700 lb	4,700 lb	2,400 lb	2,400 lb	2,500 lb	2,500 lb
	-	-	-	3,700 lb	3,700 lb	4,700 lb	4,700 lb	4,300 lb	4,300 lb	8,600 lb	10,300 lb	3,900 lb	5,000 lb	5,500 lb	5,500 lb
	3,500 lb	4,600 lb	4,600 lb	6,000 lb	7,700 lb	8,600 lb	10,300 lb	9,400 lb	9,400 lb	13,600 lb	17,000 lb	6,700 lb	8,900 lb	9,500 lb	9,500 lb
	7,100 lb	9,800 lb	9,800 lb	9,200 lb	12,600 lb	13,600 lb	17,000 lb	15,500 lb	15,500 lb	-	-	11,400 lb 20,400 lb *	14,700 lb 20,400 lb *	15,700 lb	15,700 lb
4" .	436	3/4"	A36	3/4"	A36	7/8" /	436	1" A	36	7/8" /	A36	7/8" /	436	1" A	36
1.	5 x 1.5	1/2 x 1.	5 x 1.5	1/2 x 1.	5 x 1.5	3/4 x 2	2 x 2	3/4 x 2	2 x 2	3/4 x :	2 x 2	3/4 x 2	2 x 2	3/4 x 2	2 x 2
											V	ALUES ARE STF	TO BLDG A, GRII RENGTH LEVEL A	AND	





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### THICKENED SLAB FOOTING 3/4" = 1'-0"

CONCRETE MASONRY UNIT WALLS SHALL BE CONSTRUCTED OF MEDIUM WEIGHT UNITS UNITS SHALL NOT EXCEED 0.065 PERCENT. UNIT DENSITY SHALL BE 110 pcf MINIMUM. MC REQUIREMENTS FOR TYPE S (TYPE N AT INTERIOR NON-PARTICIPATING WALLS) PER TABL TYPE SHALL BE COARSE AND SHALL CONFORM TO ASTM C476; REQUIRED COMPRESSIVE SEE S104 FOR INSPECTION AND VERIFICATION REQUIREMENTS.

COMPRESSIVE STRENGTH REQUIREMENTS: MASONRY UNITS: 2,000 psi; F'm = 2,000 psi

SPECIFIED F'm VALUES SHALL BE VERIFIED IN ACCORDANCE WITH TMS 602-13 1.4 B.2 UNIT STRENGTH VERIFICATION METHOD PER TMS 602-13 1.4 B.3 PROVIDING RESPONSIBILITY I DEPARTMENT.

WALL REINFORCING SHALL BE AS FOLLOWS:

8" WALLS #5 @ 48" oc V (2) #4 @ 48" oc H

AT ALL WALLS, PROVIDE (2) ADDITIONAL VERTICAL BARS AT EACH SIDE OF OPENINGS, AT ADDITIONAL HORIZONTAL BARS AT TOPS AND BOTTOMS OF WALLS AND ABOVE AND BEL BEAMS. EXTEND HORIZONTAL REINFORCEMENT ABOVE AND BELOW OPENINGS 40 BAR D ARE UNAVAILABLE, EXTEND AS FAR AS POSSIBLE AND HOOK. PROVIDE MATCHING CORN SEE DETAIL 3 FOR REQUIRED LAP LENGTHS AT REINFORCING SPLICES.

PROVIDE GROUT IN ALL CELLS CONTAINING REINFORCEMENT OR EMBEDDED ITEMS AND PROVIDE CLEANOUTS IN ACCORDANCE WITH TMS 602-13 SECTION 3.2F.

BETWEEN GROUT POURS, STOP ALL WYTHES AT THE SAME ELEVATION AND FORM A GRO JOINT, EXCEPT AT THE TOP OF A WALL.

COLD WEATHER CONSTRUCTION SHALL CONFORM TO TMS 602-13 1.8 C AND HOT WEATH

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			GGGLOg 1301 First Avenue, Suite 301 Seattle, WA 98101 http://www.gglo.com
8" CMU WALL PER ARCH'L. SEE GEN NOTES FOR STRUCTURAL REQUIREMENTS.		D	A D B
#3 x @ 24" o.c.			EL L. NO WASH SOF WASH 2464 CHAL ENCY (1) (1) (1) (1) (1) (1) (1) (1) (1) (1)
6" SLAB ON GRADE REINF W/ #3 @ 12" oc EW CTRD. SEE ARCH'L FOR SLAB ELEVATION AND SLOPES.			06-22-2020 MICHAEL NOUWENS Structural Consultants 130 Second Avenue North #921
SUBGRADE PREP PER GEOTECH ENGR.			Edmonds, WA 98020 michael@nouwens-structural.com www.nouwens-structural.com P 206.546.8446
		С	
WHERE HSS COLUMNS OCCUR, EXTEND FOOTING 12" AND PROVIDE BASEPLATE PER 6/S302.			HOUSING AUTHORITY
			PROJECT ADDRESS: BUILDING A: 2710 14th STREET BUILDING B: 2715 15th STREET BUILDING C: 2815 15th STREET BUILDING D: 2810 14th STREET EVERETT, WA 98201
			OWNER: EVERETT HOUSING AUTHORITY 3107 COLBY AVE EVERETT, WASHINGTON 98201
		В	MARK DATE DESCRIPTION REVISIONS
	_		
EIGHT UNITS, CONFORMING TO ASTM C90, LAID IN A RUNNING BOND. LINEAR SHRINKAGE OF MINIMUM. MORTAR SHALL CONFORM TO ASTM C270 PROPERTY SPECIFICATION LLS) PER TABLE SC-2 OF TMS 602-13. MASONRY CEMENT MORTAR SHALL NOT BE USED. GRO OMPRESSIVE STRENGTH OF 2,000 psi SHALL BE MEASURED IN ACCORDANCE WITH ASTM C10	DUT		C 06/22/2020 BUILDING PERMIT SUBMITTAL /
"m = 2,000 psi 13 1.4 B.2 UNIT STRENGTH METHOD. CONTRACTOR MAY PROPOSE TO SUBSTITUTE PRISM TE 'ONSIBILITY IS ACCEPTED FOR ANY ADDITIONAL COSTS OR SUBMITTALS TO THE BUILDING	IBMITTAL		HUD SUBMITTAL       B     04/10/2020       DESIGN DEVELOPMENT       A     12/15/2019       SCHEMATIC DESIGN       MARK     DATE       DESCRIPTION       ISSUE INFORMATION
DPENINGS, AT WALL CORNERS AND INTERSECTIONS AND AT FREE ENDS OF WALLS AND (2) DVE AND BELOW ALL OPENINGS. ALL HORIZONTAL REINFORCEMENT SHALL BE PLACED IN BO NGS 40 BAR DIAMETERS (2'-0" min) BEYOND FACE OF OPENING. IF 40 BAR DIAMETERS (2'-0" m "CHING CORNER BARS TO LAP HORIZONTAL REINFORCING AT CORNERS AND INTERSECTION D ITEMS AND IN ALL CELLS BELOW GRADE. DO NOT PROVIDE GROUT IN OTHER CELLS, UON.	SUD (ND S.		PROJECT NO.: 2017033 PRINCIPAL IN CHARGE: PROJECT MANAGER: Michael Nouwens OWNER APPROVAL:
FORM A GROUT KEY BY TERMINATING THE GROUT A MINIMUM OF 1 1/2" BELOW A MORTAR HOT WEATHER CONSTRUCTION SHALL CONFORM TO TMS 602-13 1.8 D.	PERMIT SUBMITT	A	SHEET TITLE TRASH ENCLOSURE STRUCTURAL DETAILS AND NOTES
	BUILDING PE		SHEET NO. <b>S-501</b> COPYRIGHT MNSC. ALL RIGHTS RESERVED.

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### GENERAL SITE PLAN NOTES

- 1. SITE INFORMATION CONTAINED HEREIN, INCLUDING BUT NOT LIMITED TO, DIMENSIONS AND LOCATIONS OF EXISTING UTILITIES, IS BASED ON THE SURVEY ON SHEET V-001 AND IS PROVIDED FOR INFORMATIONAL PURPOSES ONLY. THE ARCHITECT TAKES NO RESPONSIBILITY FOR ITS ACCURACY.
- 2. VERIFY LOCATION OF ALL EXISTING UTILITIES. DO NOT DAMAGE TO OR DISTURB EXISTING UTILITIES.
- 3. FOR EXITING INFORMATION SEE SHEET A-XXX.
- 4. SEE LANDSCAPE PLAN FOR ADDITIONAL INFORMATION NOT ON THIS PLAN.
- 5. OFF-SITE IMPROVEMENTS

EHA - BA	KER HEI	GHTS: RE	QUIRED	PARKING	G CALCULA	TIONS
<u>30% AMI</u> units	no. of units	prkg zone	req'd cars per unit	Total cars req'd	Prkg reduction for 30% AMI or less	Overall total req'd
1BR	20	Outside	1	20	0.5	10
2BR	39	Outside	1.5	58.5	0.5	29.25
3BR	8	Outside	2	16	0.5	8
	67					47.25
<u>60% AMI</u> <u>units</u>	no. of units	prkg zone	req'd cars per unit	Total cars req'd	Prkg reduction for 60% AMI or less	Overall total req'd
1BR	21	Outside	1	21	0.65	13.65
2BR	15	Outside	1.5	22.5	0.65	14.625
3BR	2	Outside	2	4	0.65	2.6
	38					30.875
		Residential R	equired Stalls	2		
		Resid at 30%		67	>	47.25
		Resid at 60%		38	>	30.875
				105	units	78
		ECEAP Requi	red Stalls	-	+	3
		Office Requir	ed Stalls	+	3	
			ycle Reductio	n	+	-4
		Max. Bicycle			+	-4
		· · · ·		Total	<b>Required Stalls</b>	76

PARKING SCHEDULE					
ТҮРЕ	STALL COUNT	% STALLS			
EVERETT - 8' STALL (COMPACT)	11	12%			
EVERETT - 8' STALL ADA VAN	1	1%			
EVERETT - 9' STALL (MEDIUM)	3	3%			
EVERETT - 9.5' STALL (LARGE)	57	61%			
EVERETT - 9.5' STALL (LARGE) ADA	5	5%			
EVERETT - MOTORCYCLE STALL	16	17%			
τοται	93	100%			

BIKE PARKING SCHEDULE					
BUILDING LOCATION	STALL COUNT				
	2				
BUILDING B	38				
BUILDING C	12				
BUILDING D	12				
TOTAL	64				

Zone standatds	R-4 reg'd	Notes	Proposed
Min Lot Area	5000 st	· · · · · · · · ·	138,290 sf
Min Required setbade		1 1	
Front	10'		10-2" MIN
Rear	20'		N/A
Side (street)	10'		N/A
Side (interior)	5	5	10'
Lot wigh min	50'	1.1.1	318'-11"
Lot depth min	80*		338-9"
Max lot coverage by building	N/A	1.1	
Max bailding height	60'	.8	42'-0. 1/2"
Landscape category	A	10	A

### Note

(5) Minimum setback for multiple-family dwellings shall be twenty-five feet when abutting R-S or R-1 zones, and fifteen feet when abutting R-2 zones. For unit tot subdivisions allowed under Chapter 19 15A, the minimum interior side setback from the exterior property boundary of the parent lot shall be twenty feet. Building setbacks for buildings which are permitted to exceed thirty-five feet in height shall be an additional five feet for each ten feet or fraction thereof by which the building exceeds thirty-five feet in height for only those portions of the building which exceed thirty-five feet in (8) Twenty-eight feet for any portion of building within fifty feet of lots located in the R-S R-1, R-2, R-1(A), or R-2(A) zones. In the R-4 and R-5 zones, forty-five feet when located at least fifty feet but less than two hundred feet from lots located in the R-S, R-1, R-2, R-1(A) or R-2(A) zones.

(10) Landscape Category B for permitted nonresidential uses. Landscape Category E for single-family dotached or two-family (duplex) dwellings

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BUILDING PERMIT SUBMITTAL / HUD SUBMITTAL

SHEET TITLE

PROJECT NO .:

OWNER APPROVAL:

C 06/22/2020 BUILDING PERMIT SUBMITTAL /

04/10/2020 DESIGN DEVELOPMENT

GGLO PROJECT MANAGER: SCOTT SCHREFFLER

A 01/07/2020 SCHEMATIC DESIGN

MARK DATE DESCRIPTION

**ISSUE INFORMATION** 

GGLO PRINCIPAL IN CHARGE:

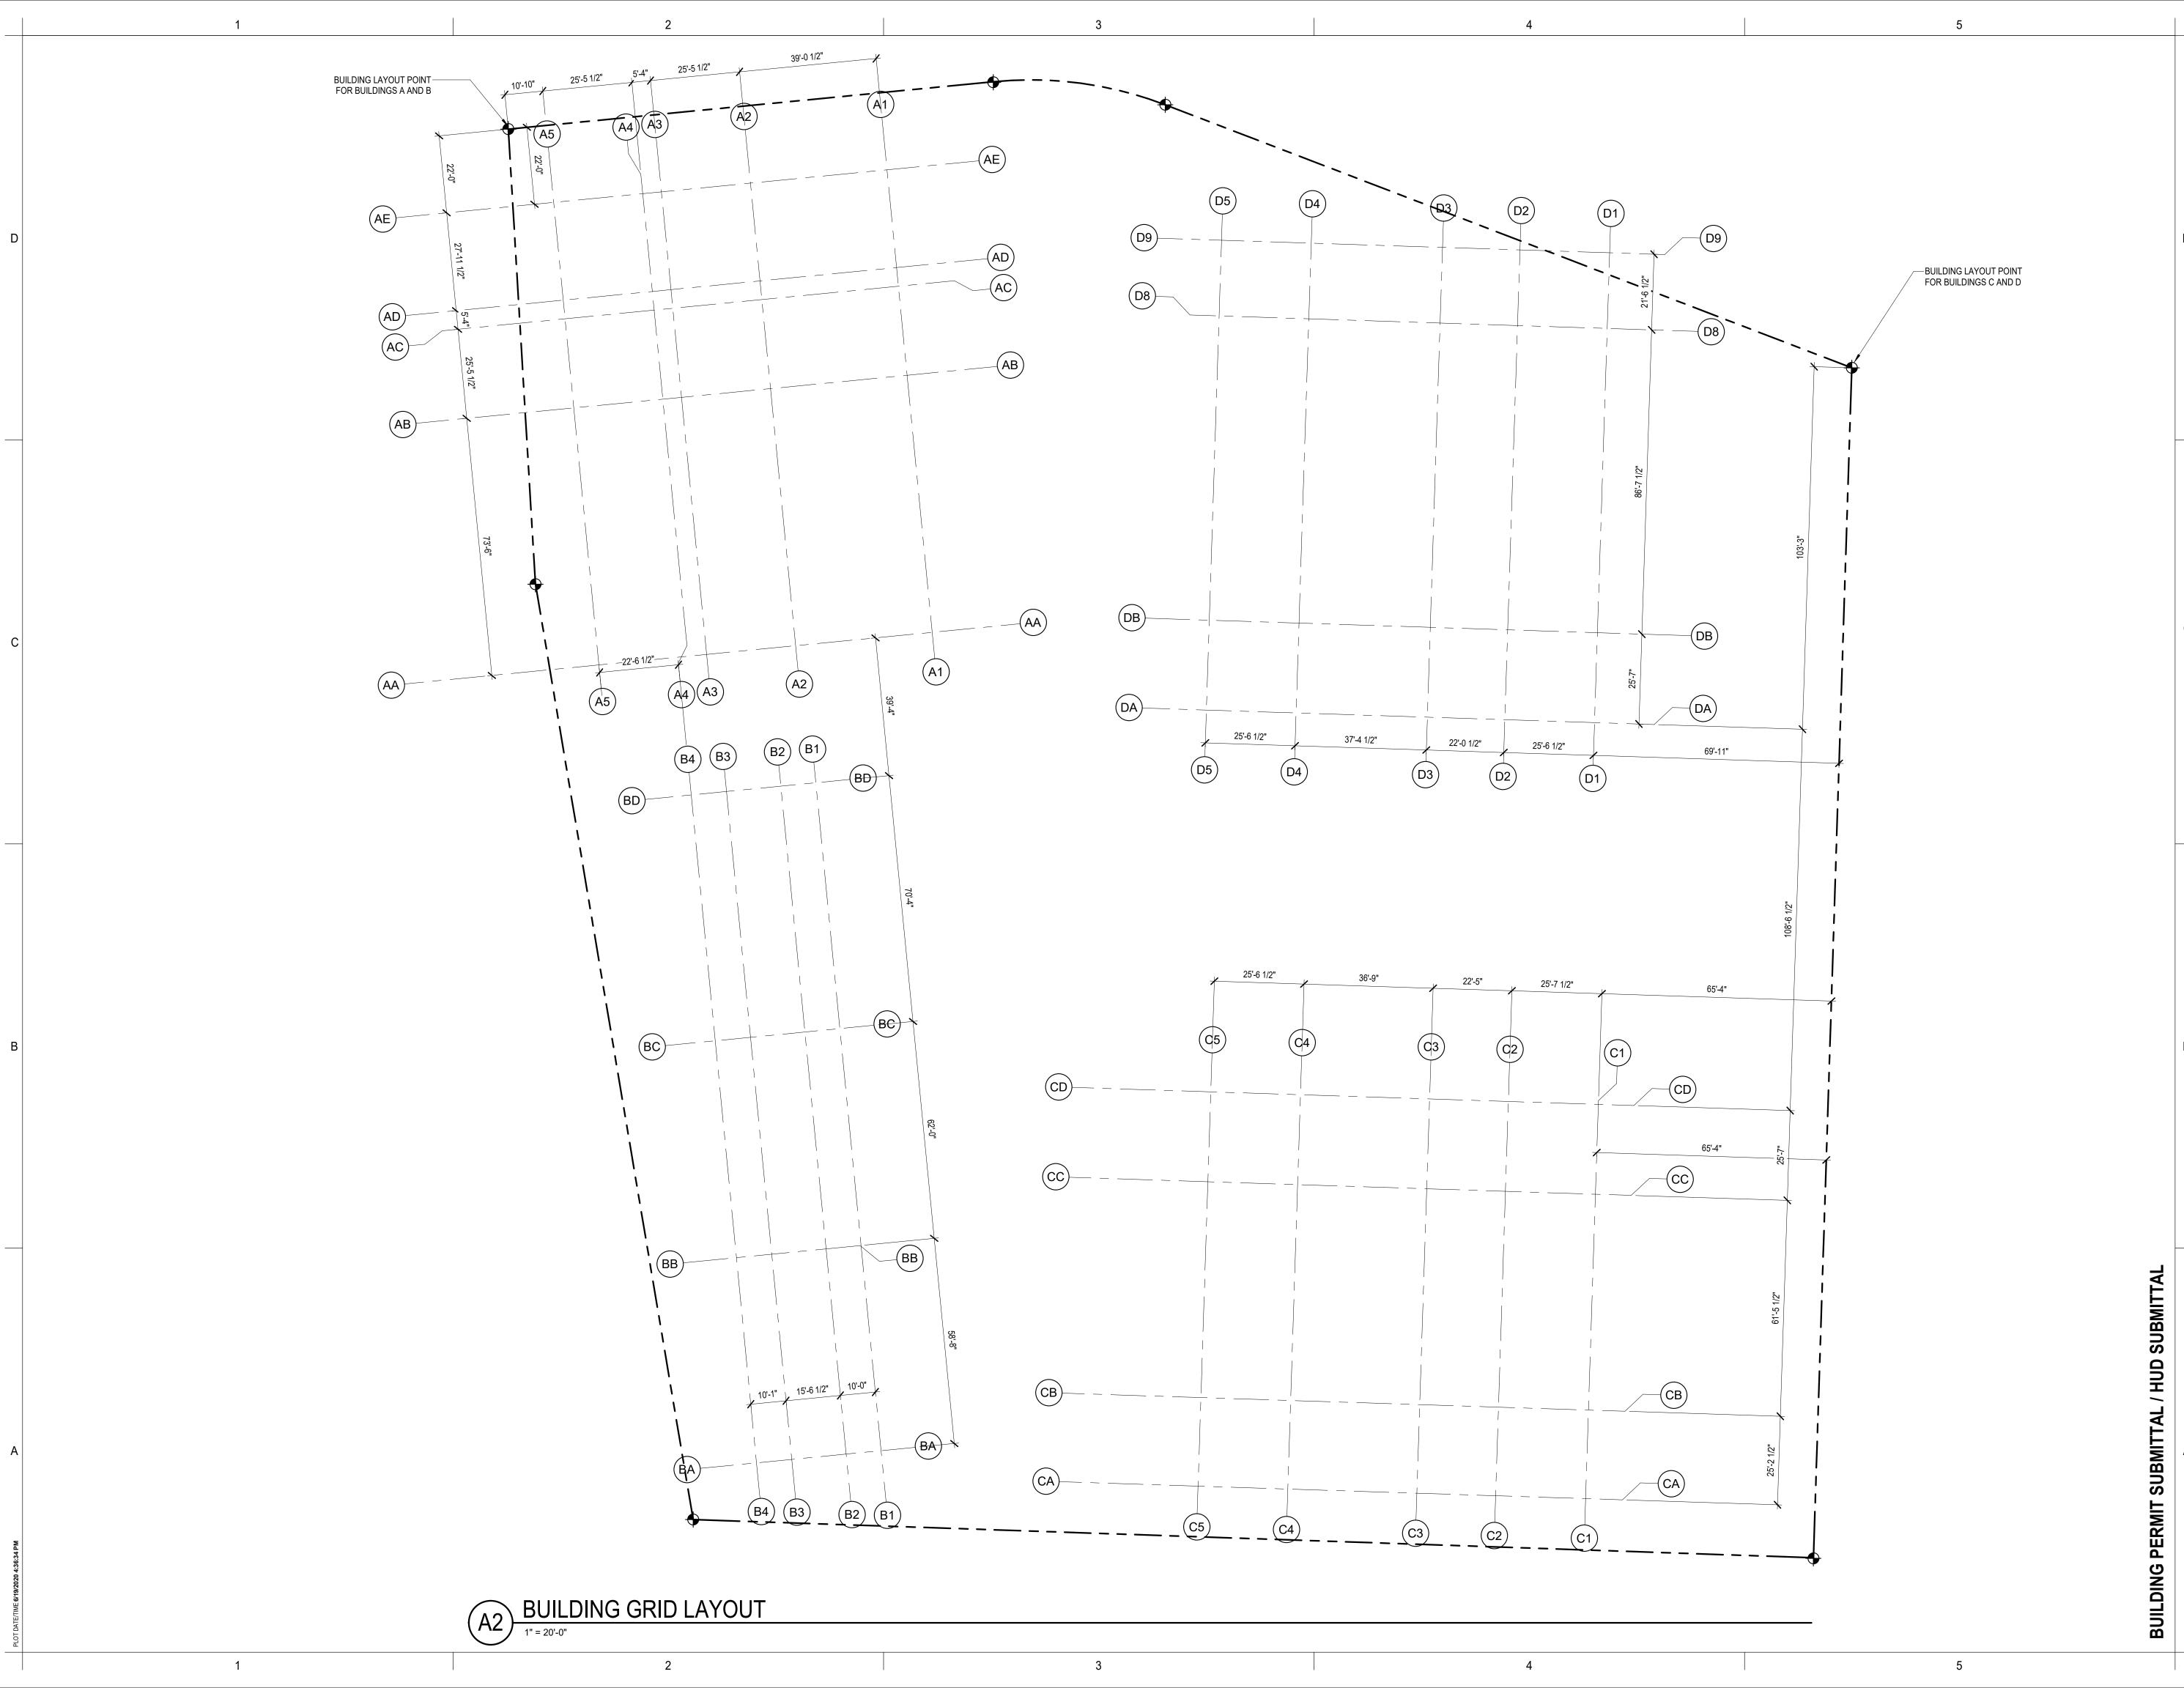
HUD SUBMITTAL

2017033.00

JON HALL

SHEET NO.

A-101



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SHEET NO.

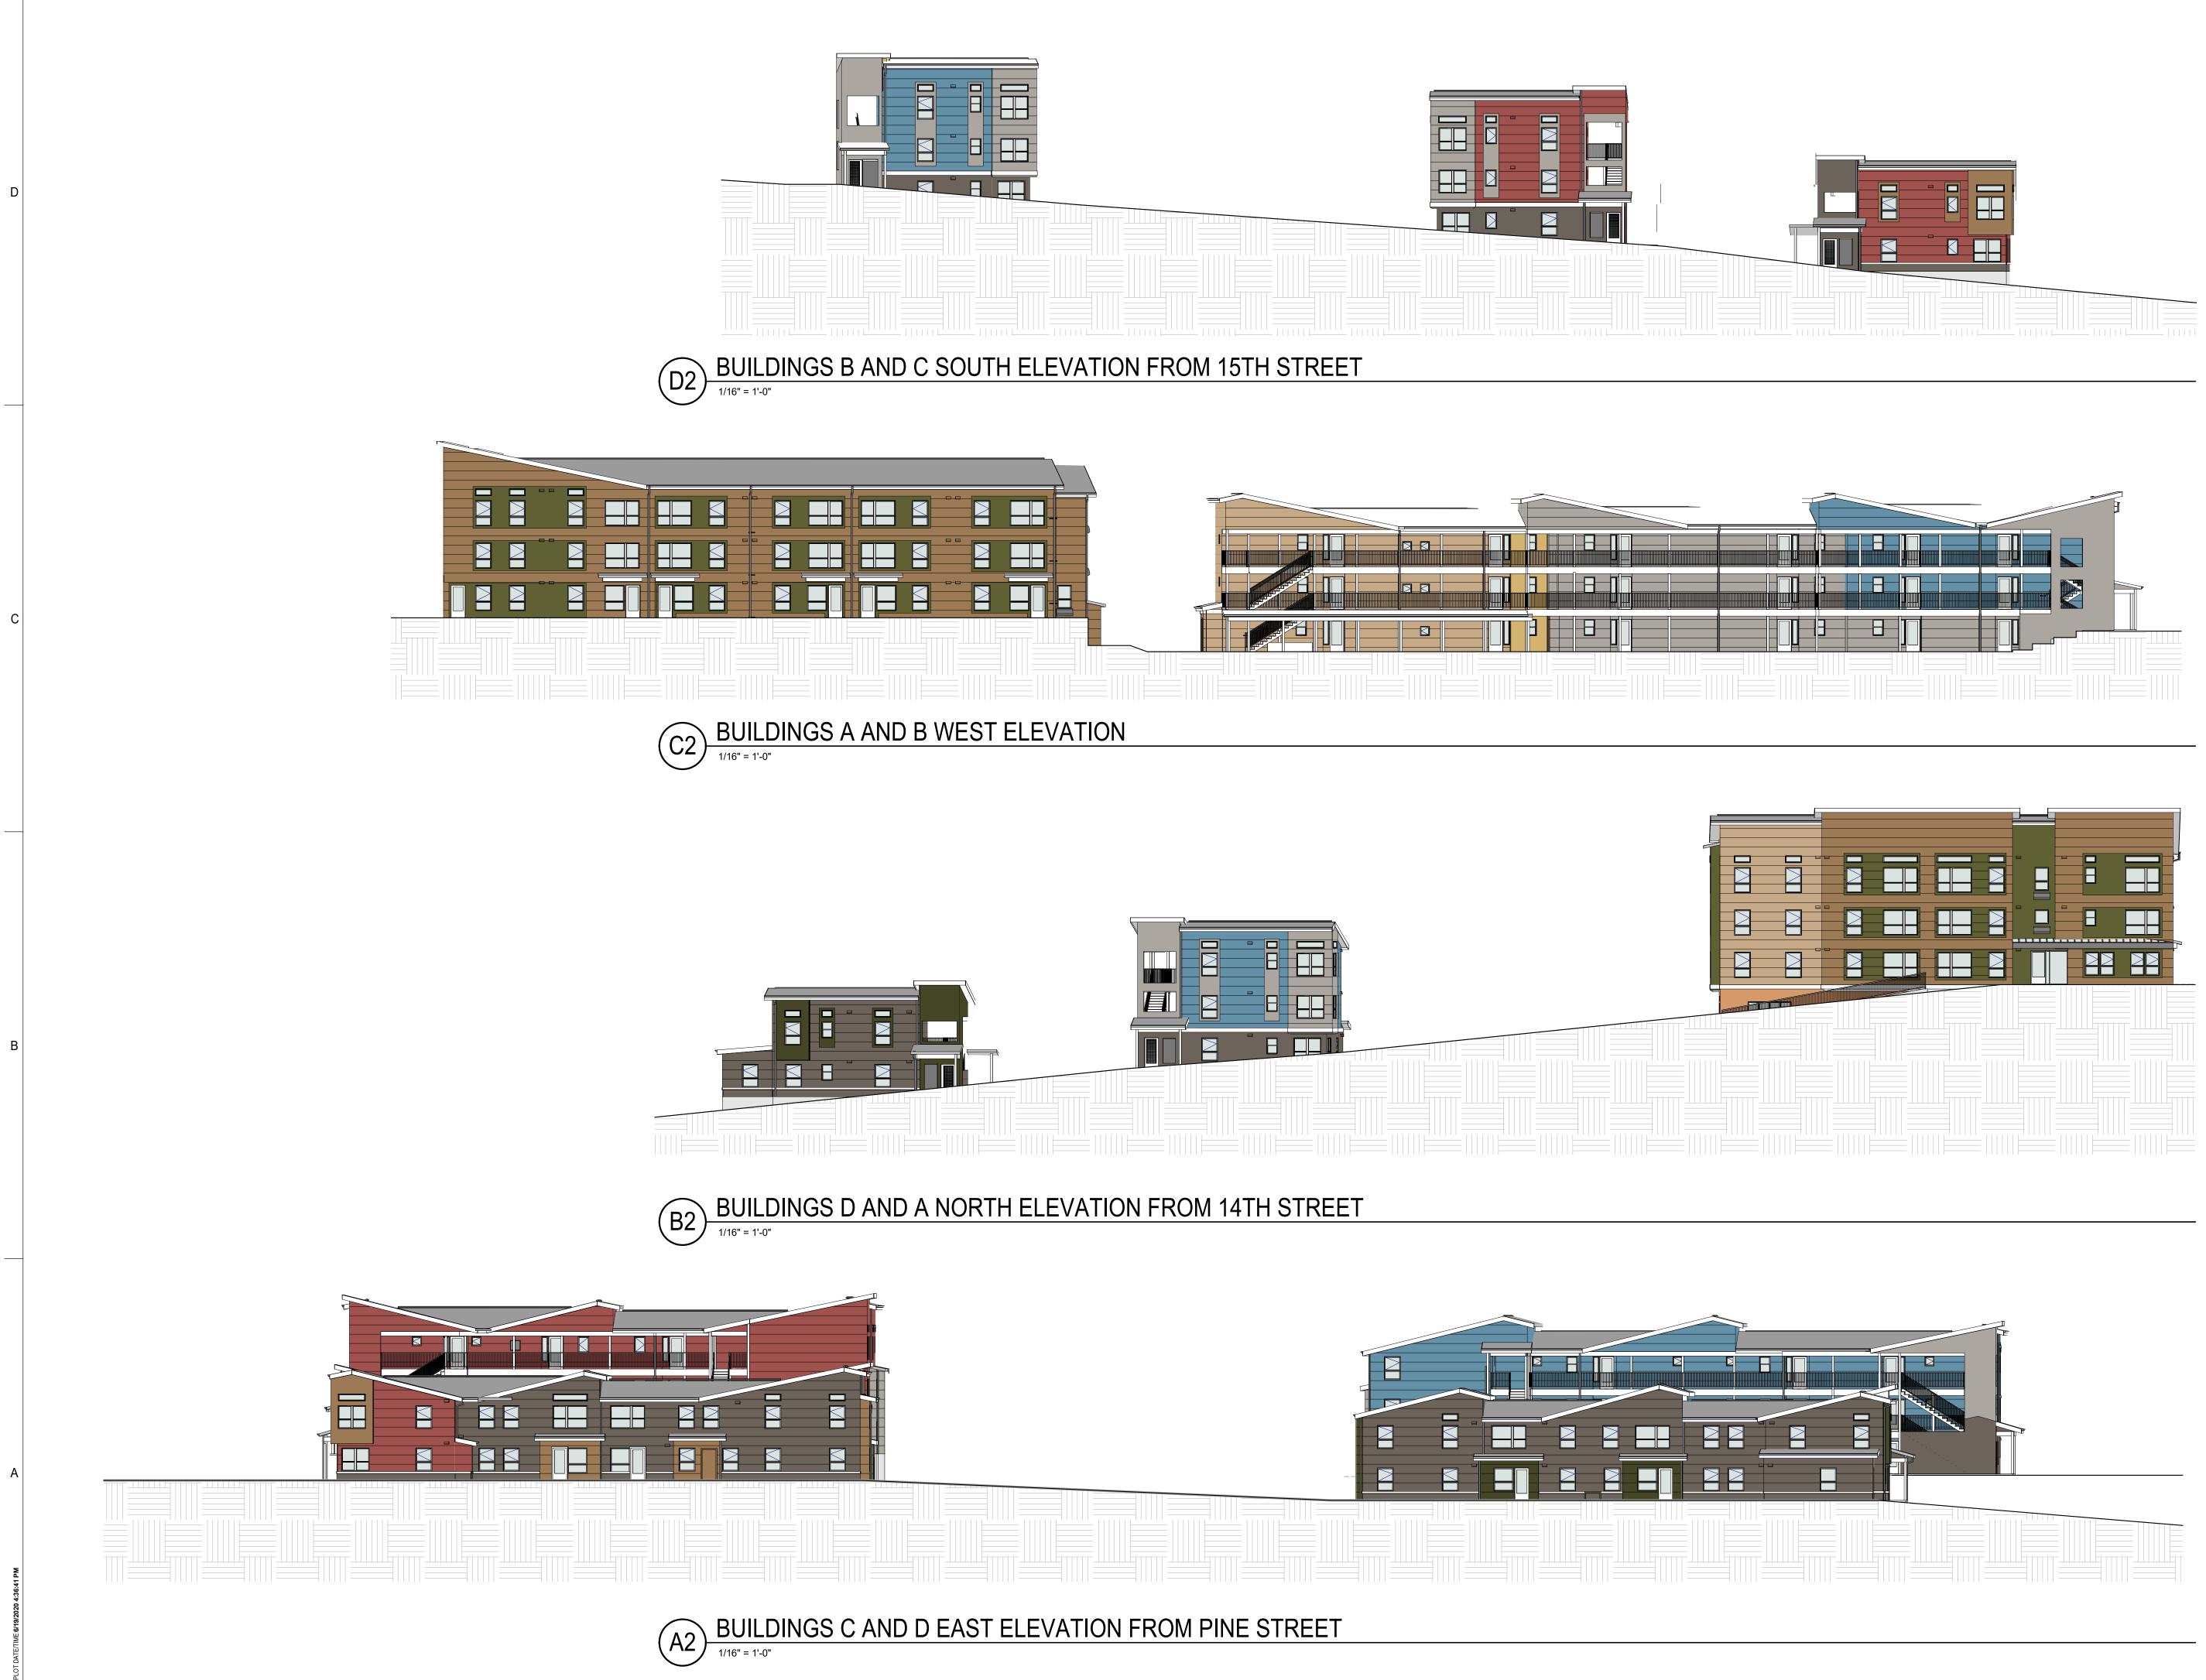
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1301 First Avenue, Suite 301 Seattle, WA 98101

http://www.gglo.com



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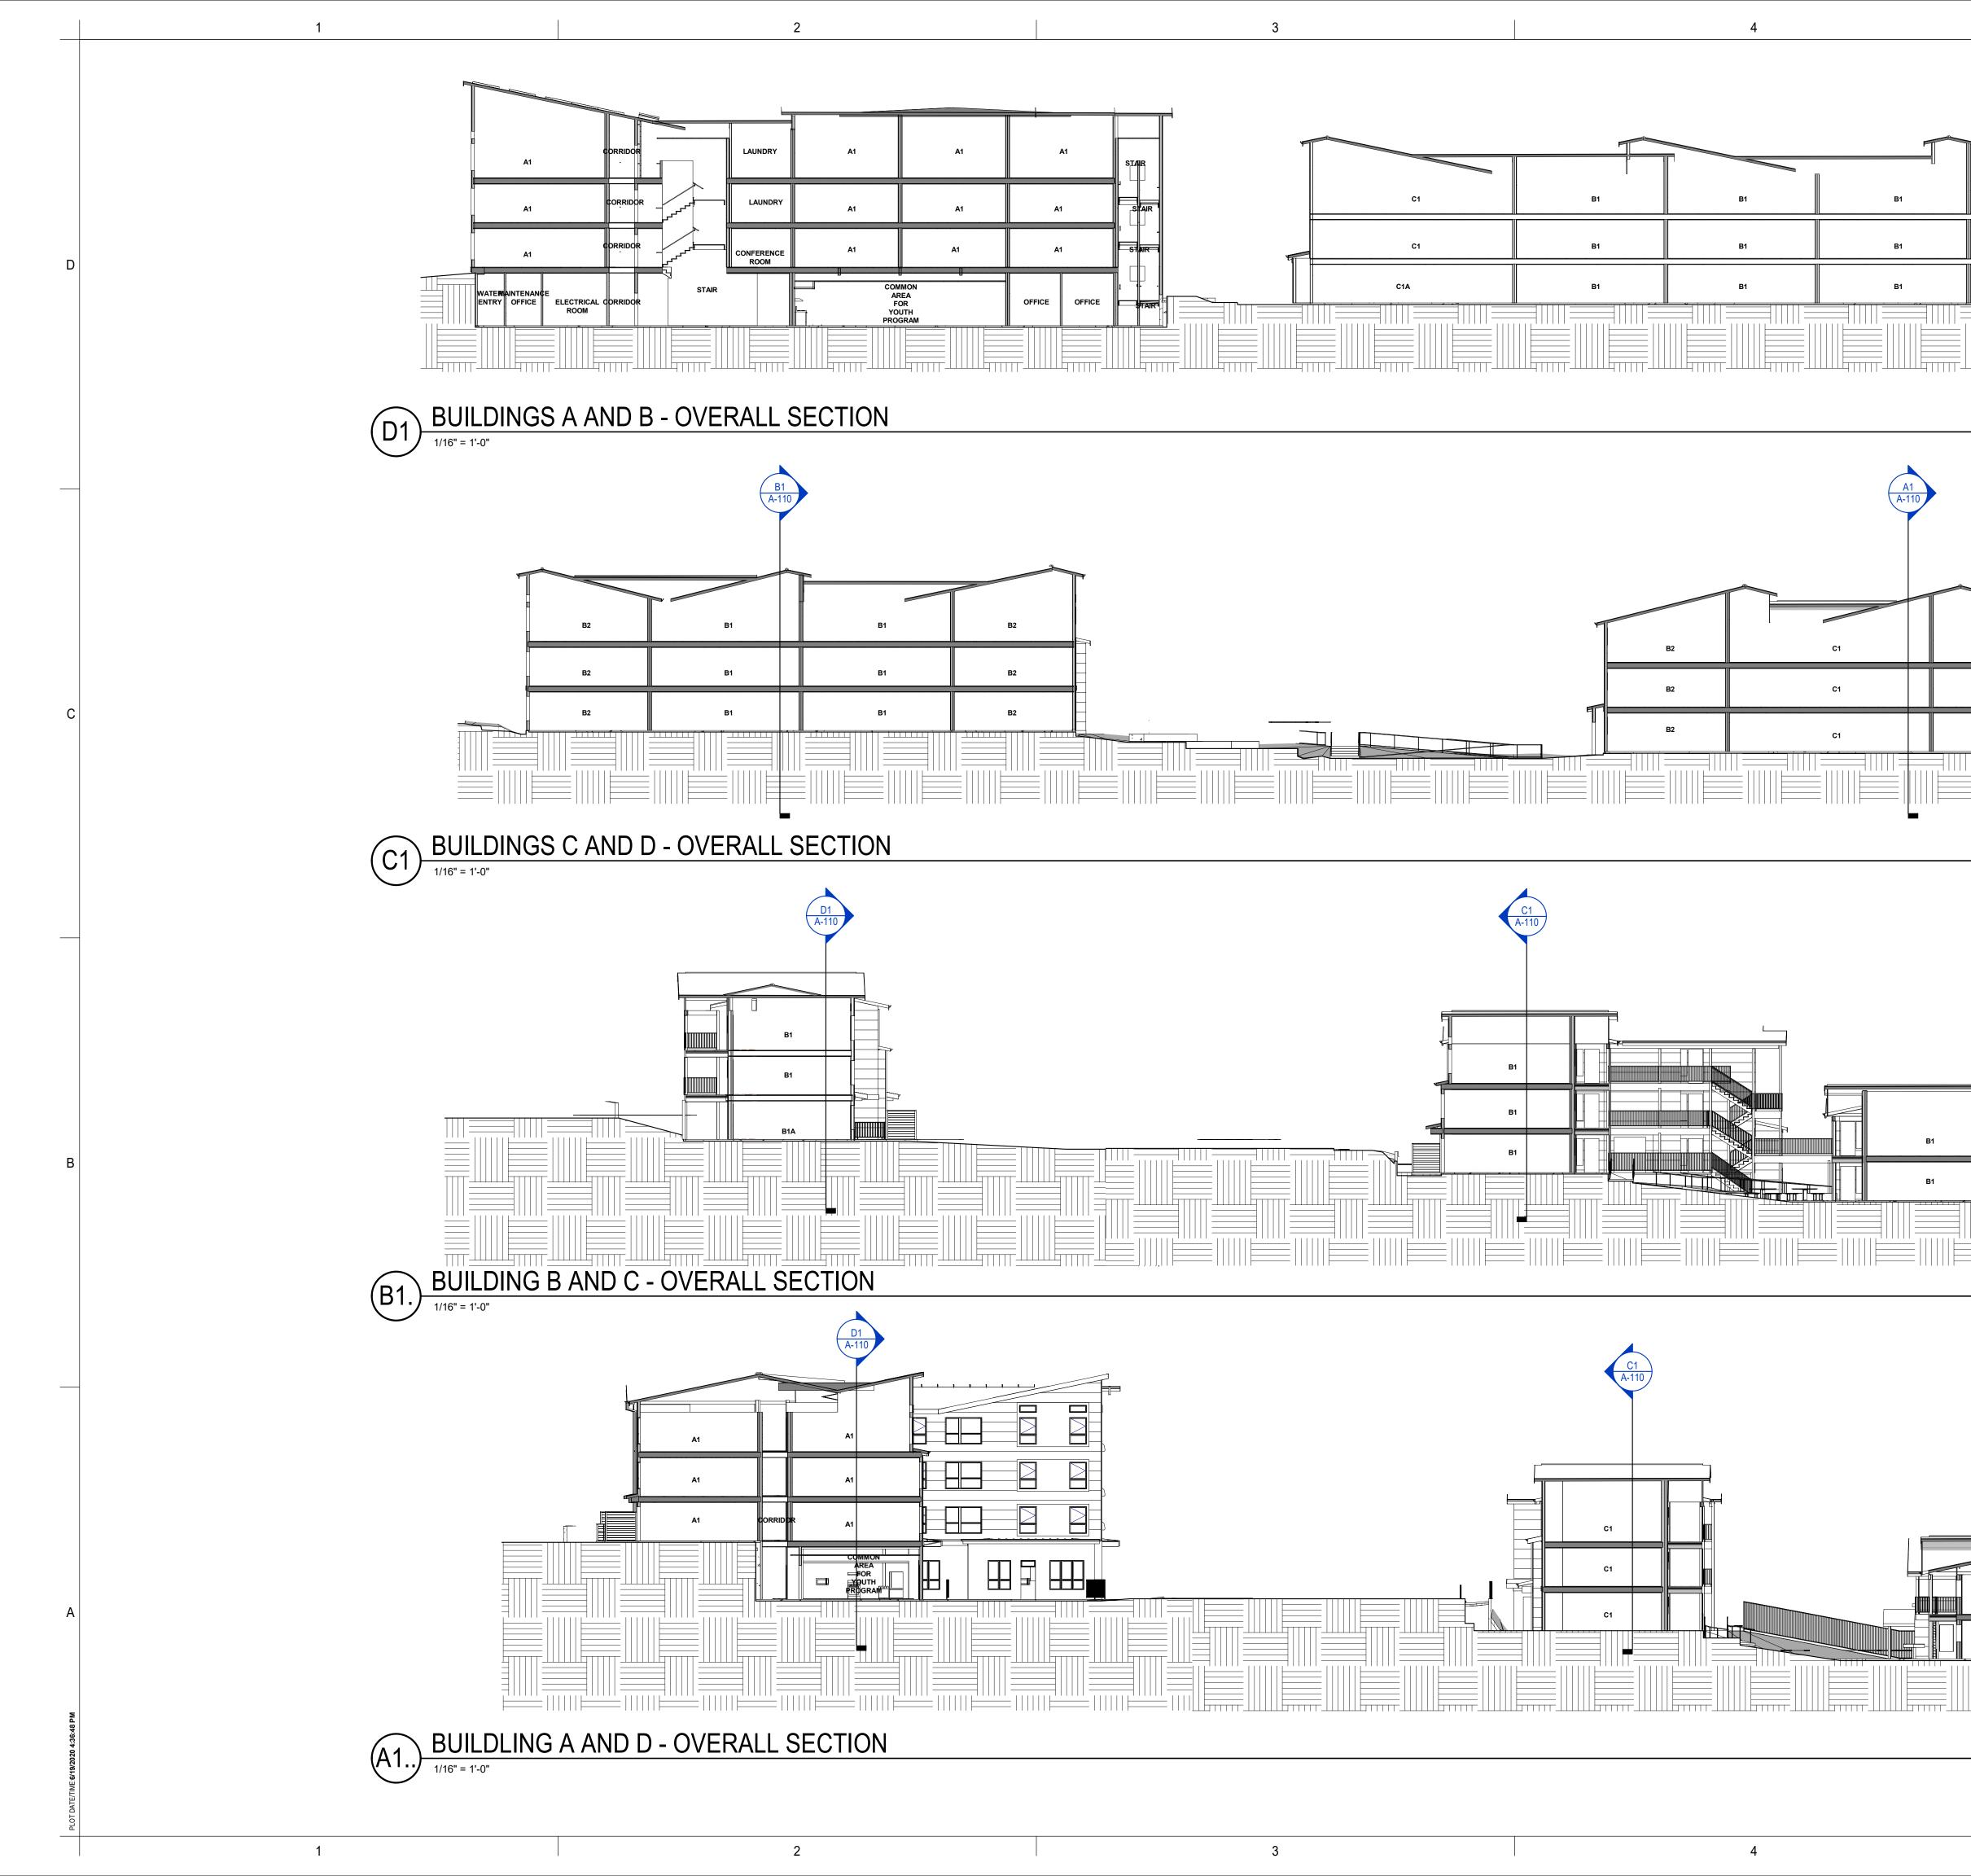
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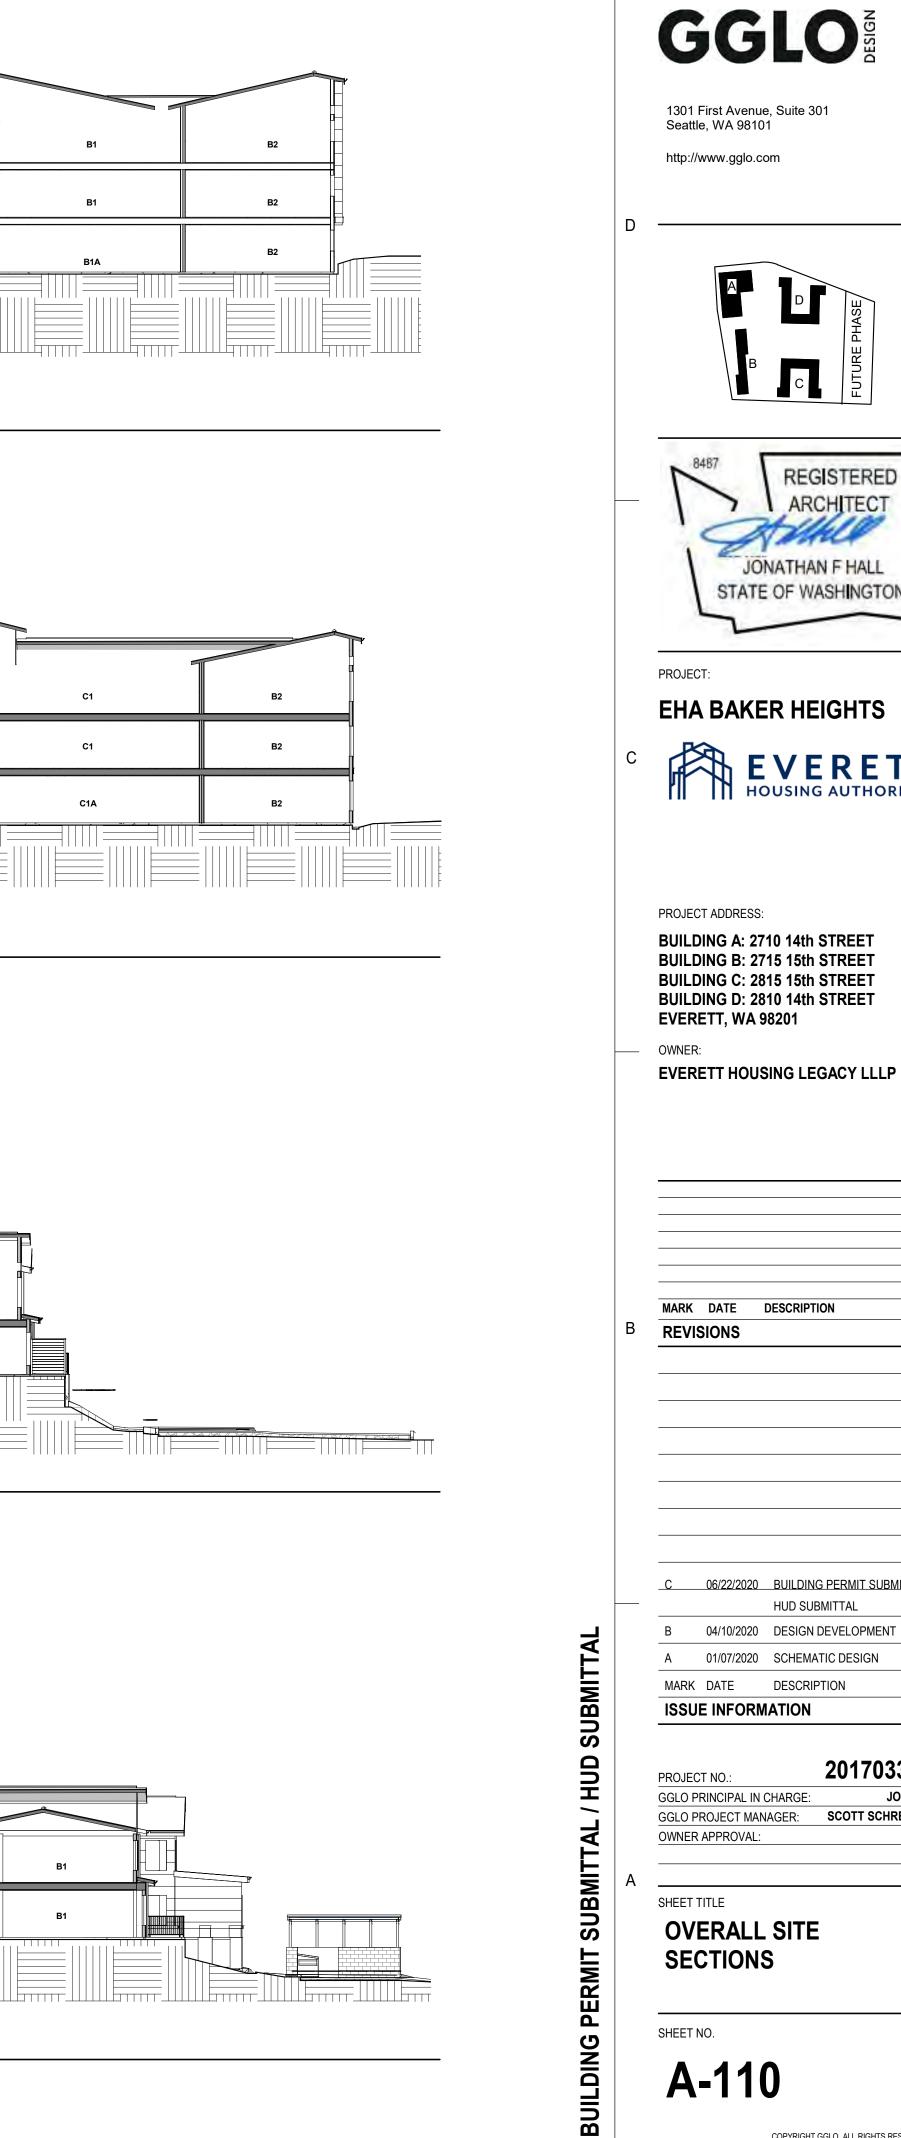
1301 First Avenue, Suite 301 Seattle, WA 98101

http://www.gglo.com

SHEET NO.

A-105





A-110

06/22/2020 BUILDING PERMIT SUBMITTAL

HUD SUBMITTAL

2017033.00

SCOTT SCHREFFLER

JON HALL

04/10/2020 DESIGN DEVELOPMENT

MARK DATE DESCRIPTION

**ISSUE INFORMATION** 

http://www.gglo.com

8487

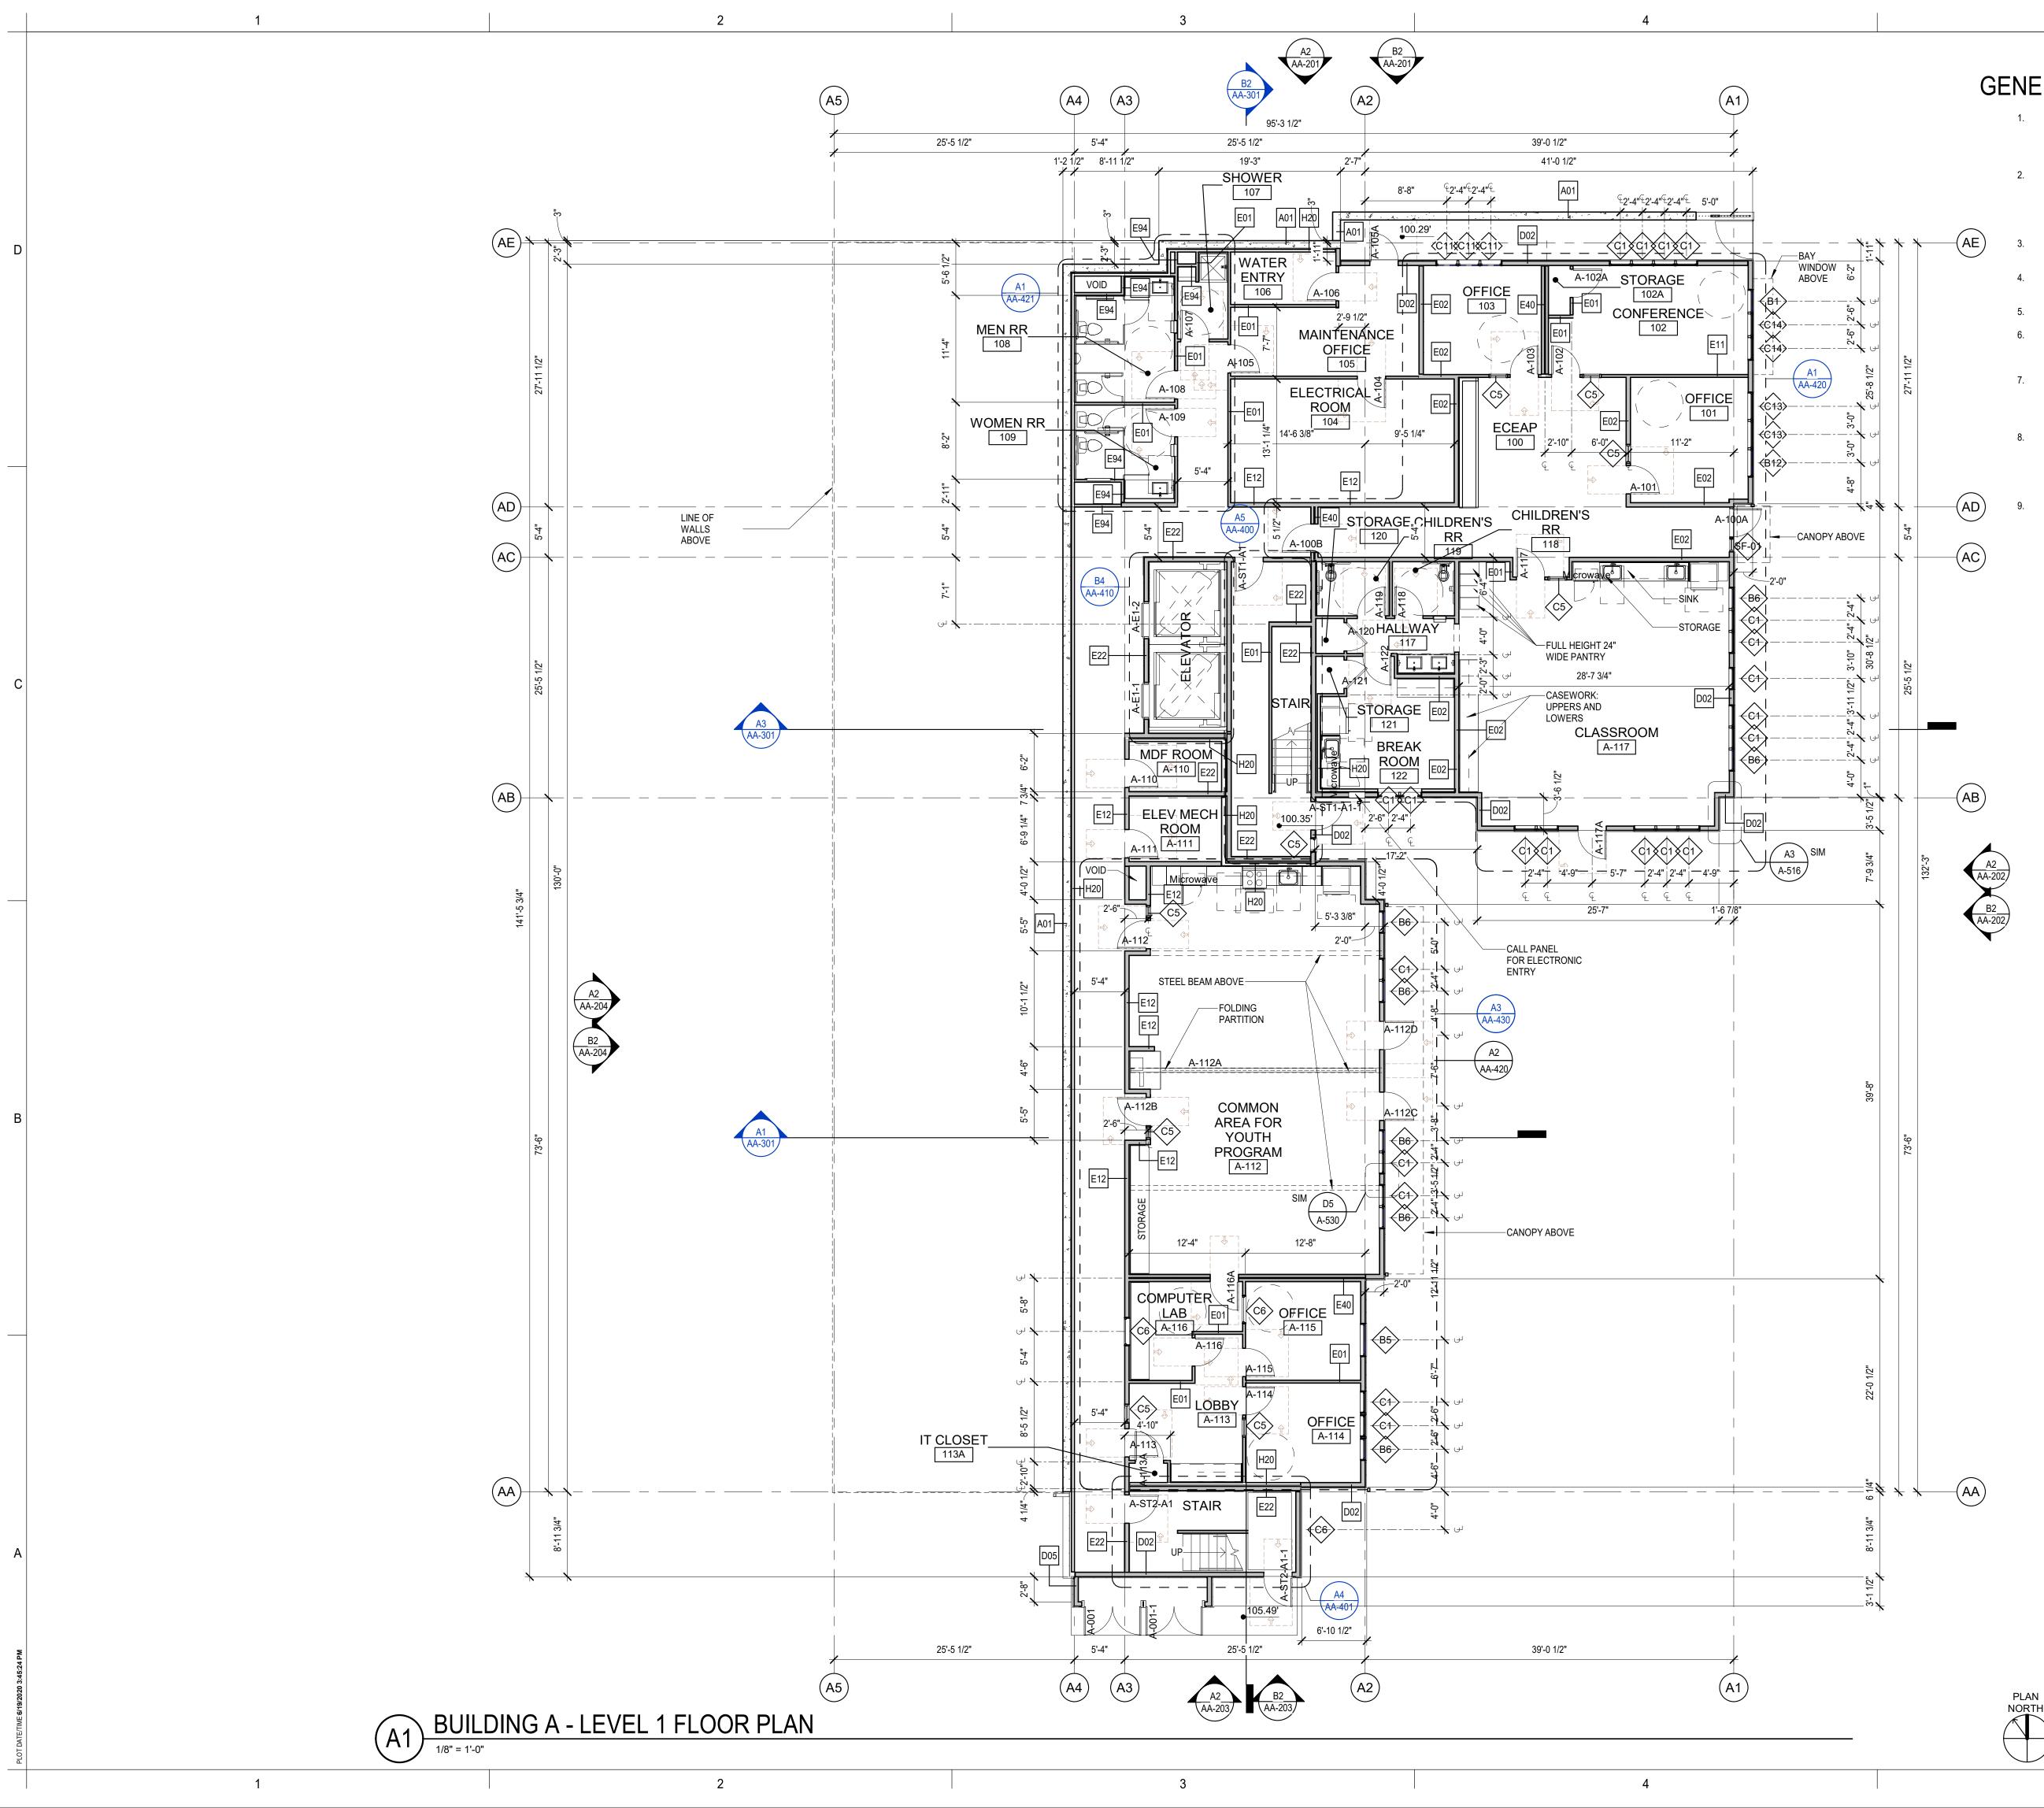
REGISTERED

ARCHITECT

JONATHAN F HALL STATE OF WASHINGTON

**EVERETT** HOUSING AUTHORITY

MARK DATE DESCRIPTION



## GENERAL FLOOR PLAN NOTES

- PLAN DIMENSIONS ARE TO FACE OF STUD, FACE OF CONCRETE WALL, CENTERLINE OF COLUMN, OR CENTERLINE OF ROUGH OPENINGS, UON. CONTACT ARCHITECT FOR CLARIFICATIONS.
- DOORS AND CASED OPENINGS INDICATED ADJACENT TO WALL INTERSECTIONS SHALL BE LOCATED WITH THE EDGE OF FINISH OPENING SIX INCHES FROM THE ADJACENT WALL AT THE EXTERIOR AND FOUR INCHES FROM THE ADJACENT WALL.
- SEE SHEET A-540 & A-620 FOR WINDOW LEGEND AND DETAILS.
- SEE SHEET A-545 & A-615 FOR DOOR SCHEDULE AND DETAILS.
- SEE SHEET A-605 FOR WALL ASSEMBLIES.
- INSTALL BLOCKING FOR GRAB BARS IN ALL BATHROOM WALLS SURROUNDING WATER CLOSET, BATHTUB AND SHOWER. REF A-501.
- HANDRAILS SHALL RETURN TO A WALL, GUARD OR THE WALKING SURFACE OR SHALL BE CONTINUOUS TO THE HANDRAIL OF AN ADJACENT STAIR FLIGHT OR RAMP RUN -PER IBC 1012.5.
- CONTRACTOR SHALL INSTALL FURRING, SHIMS AND ADDITIONAL LAYERS OF GYPSUM BOARD AS NECESSARY TO ACHIEVE FLUSH FINISH WHERE SURFACES OF ADJACENT WALL OR SHAFT ASSEMBLIES ARE NOT, BUT ARE INTENDED TO BE, ALIGNED.
- SEE SHEETS A-190 THROUGH A-193 FOR TYPICAL UNIT PLANS ENLARGED.

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	REGISTERED ARCHITECT JONATHAN F HALL STATE OF WASHINGTON
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	PROJECT: EHA BAKER HEIGHTS
С	
	HOUSING AUTHORITY
	PROJECT ADDRESS: BUILDING A: 2710 14th STREET
	BUILDING B: 2715 15th STREET BUILDING C: 2815 15th STREET BUILDING D: 2810 14th STREET
	EVERETT, WA 98201
	EVERETT, WA 98201 OWNER: EVERETT HOUSING AUTHORITY
	EVERETT, WA 98201 OWNER:
	EVERETT, WA 98201 OWNER: EVERETT HOUSING AUTHORITY 3107 COLBY AVE
	EVERETT, WA 98201 OWNER: EVERETT HOUSING AUTHORITY 3107 COLBY AVE
	EVERETT, WA 98201 OWNER: EVERETT HOUSING AUTHORITY 3107 COLBY AVE
	EVERETT, WA 98201 OWNER: EVERETT HOUSING AUTHORITY 3107 COLBY AVE
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	EVERETT, WA 98201 OWNER: EVERETT HOUSING AUTHORITY 3107 COLBY AVE EVERETT, WA 98201
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	EVERETT, WA 98201         OWNER:         EVERETT HOUSING AUTHORITY 3107 COLBY AVE EVERETT, WA 98201
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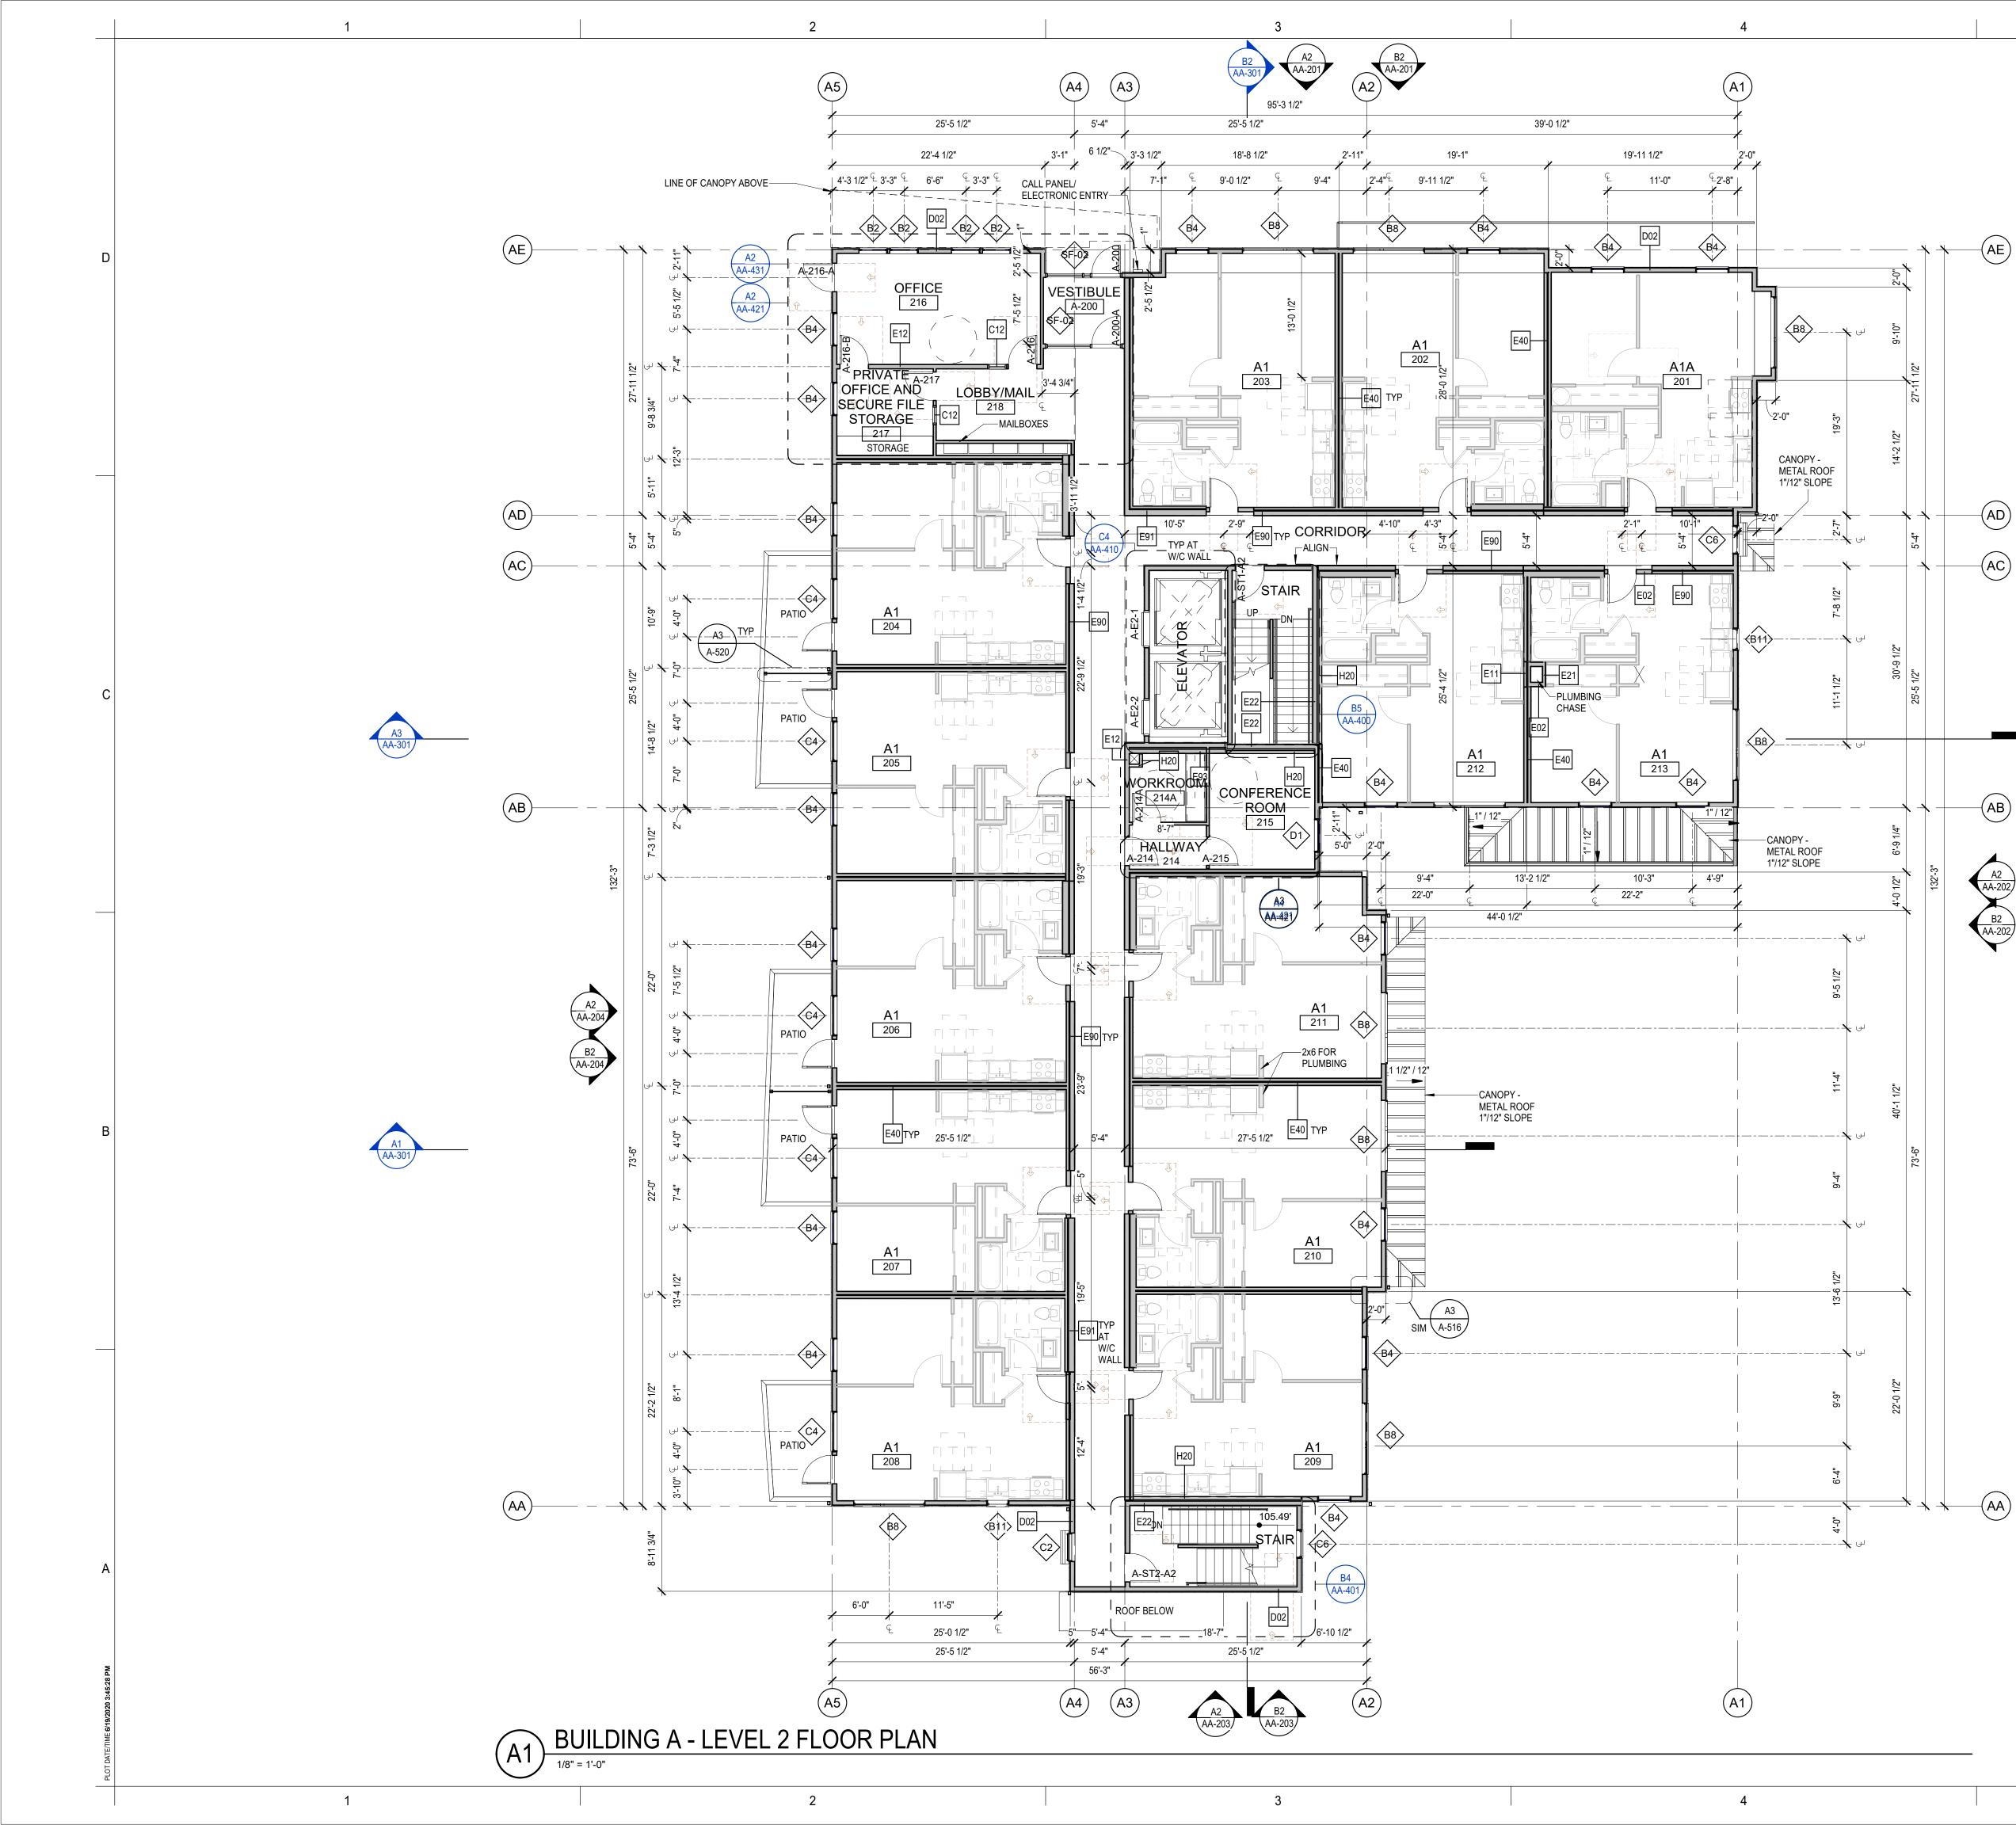
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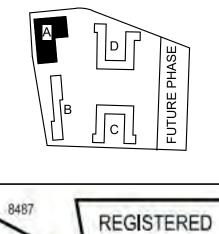
### GENERAL FLOOR PLAN NOTES

- 1. PLAN DIMENSIONS ARE TO FACE OF STUD, FACE OF CONCRETE WALL, CENTERLINE OF COLUMN, OR CENTERLINE OF ROUGH OPENINGS, UON. CONTACT ARCHITECT FOR CLARIFICATIONS.
- DOORS AND CASED OPENINGS INDICATED ADJACENT TO WALL INTERSECTIONS SHALL BE LOCATED WITH THE EDGE OF FINISH OPENING SIX INCHES FROM THE ADJACENT WALL AT THE EXTERIOR AND FOUR INCHES FROM THE ADJACENT WALL.
- 3. SEE SHEET A-540 & A-620 FOR WINDOW LEGEND AND DETAILS.
- SEE SHEET A-545 & A-615 FOR DOOR SCHEDULE AND 4. DETAILS.
- 5. SEE SHEET A-605 FOR WALL ASSEMBLIES.
- INSTALL BLOCKING FOR GRAB BARS IN ALL BATHROOM 6 WALLS SURROUNDING WATER CLOSET, BATHTUB AND SHOWER. REF A-501.
- 7. HANDRAILS SHALL RETURN TO A WALL, GUARD OR THE WALKING SURFACE OR SHALL BE CONTINUOUS TO THE HANDRAIL OF AN ADJACENT STAIR FLIGHT OR RAMP RUN PER IBC 1012.5.
- CONTRACTOR SHALL INSTALL FURRING, SHIMS AND 8. ADDITIONAL LAYERS OF GYPSUM BOARD AS NECESSARY TO ACHIEVE FLUSH FINISH WHERE SURFACES OF ADJACENT WALL OR SHAFT ASSEMBLIES ARE NOT, BUT ARE INTENDED TO BE, ALIGNED.
- SEE SHEETS A-190 THROUGH A-193 FOR TYPICAL UNIT PLANS 9 ENLARGED.

<b>BUILDING A - UNIT COUNT</b>					
UNIT NAME	UNIT TYPE	NUMBER OF UNITS			
A1	1 BED	37			
A1A	1 BED TYPE A	4			
TOTAL		41			



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PROJECT:

### EHA BAKER HEIGHTS



PROJECT ADDRESS:

BUILDING A: 2710 14th STREET BUILDING B: 2715 15th STREET BUILDING C: 2815 15th STREET BUILDING D: 2810 14th STREET **EVERETT, WA 98201** 

OWNER: **EVERETT HOUSING AUTHORITY** 3107 COLBY AVE EVERETT, WA 98201

Date 1 Revision 1 MARK DATE DESCRIPTION

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A 01/07/2020 SCHEMATIC DESIGN

**BUILDING A - LEVEL 2** 

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MARK DATE DESCRIPTION

**ISSUE INFORMATION** 

GGLO PRINCIPAL IN CHARGE:

FLOOR PLAN

AA-111

GGLO PROJECT MANAGER:

PROJECT NO .:

**OWNER APPROVAL** 

SHEET TITLE

SHEET NO.

C 06/22/2020 BUILDING PERMIT SUBMITTAL

HUD SUBMITTAL

2017033

Scott Schreffler

Jon Hall

04/10/2020 DESIGN DEVELOPMENT





- 1. PLAN DIMENSIONS ARE TO FACE OF STUD, FACE OF CONCRETE WALL, CENTERLINE OF COLUMN, OR CENTERLINE OF ROUGH OPENINGS, UON. CONTACT ARCHITECT FOR CLARIFICATIONS.
- DOORS AND CASED OPENINGS INDICATED ADJACENT TO 2 WALL INTERSECTIONS SHALL BE LOCATED WITH THE EDGE OF FINISH OPENING SIX INCHES FROM THE ADJACENT WALL AT THE EXTERIOR AND FOUR INCHES FROM THE ADJACENT WALL.
- SEE SHEET A-540 & A-620 FOR WINDOW LEGEND AND DETAILS.
- SEE SHEET A-545 & A-615 FOR DOOR SCHEDULE AND DETAILS.
- SEE SHEET A-605 FOR WALL ASSEMBLIES. 5.
- INSTALL BLOCKING FOR GRAB BARS IN ALL BATHROOM WALLS SURROUNDING WATER CLOSET, BATHTUB AND SHOWER. REF A-501.
- HANDRAILS SHALL RETURN TO A WALL, GUARD OR THE 7. WALKING SURFACE OR SHALL BE CONTINUOUS TO THE HANDRAIL OF AN ADJACENT STAIR FLIGHT OR RAMP RUN -PER IBC 1012.5.
- CONTRACTOR SHALL INSTALL FURRING, SHIMS AND ADDITIONAL LAYERS OF GYPSUM BOARD AS NECESSARY TO ACHIEVE FLUSH FINISH WHERE SURFACES OF ADJACENT WALL OR SHAFT ASSEMBLIES ARE NOT, BUT ARE INTENDED TO BE, ALIGNED.
- SEE SHEETS A-190 THROUGH A-193 FOR TYPICAL UNIT PLANS ENLARGED.

<b>BUILDING A - UNIT COUNT</b>				
UNIT NAME	UNIT TYPE	NUMBER OF UNITS		
A1	1 BED	37		
A1A	1 BED TYPE A	4		
TOTAL		41		



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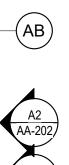
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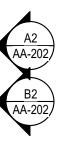
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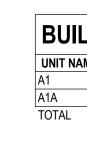
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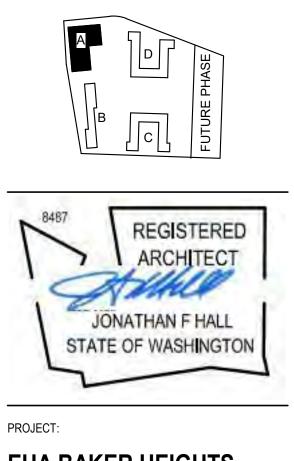








Seattle, WA 98101 http://www.gglo.com



EHA BAKER HEIGHTS



PROJECT ADDRESS:

BUILDING	A: 2710	14th	STREET	•
BUILDING	B: 2715	15th	STREET	-
BUILDING	C: 2815	15th	STREET	•
BUILDING	D: 2810	14th	STREET	•
EVERETT,	WA 982	01		
OWNER:				

**EVERETT HOUSING AUTHORITY** 3107 COLBY AVE **EVERETT, WA 98201** 

06/22/2020 BUILDING PERMIT SUBMITTAL

HUD SUBMITTAL

2017033

Scott Schreffler

Jon Hall

04/10/2020 DESIGN DEVELOPMENT

A 01/07/2020 SCHEMATIC DESIGN

**BUILDING A - LEVEL 3** 

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MARK DATE DESCRIPTION

**ISSUE INFORMATION** 

GGLO PRINCIPAL IN CHARGE:

FLOOR PLAN

AA-112

GGLO PROJECT MANAGER:

PROJECT NO .:

**OWNER APPROVAL** 

SHEET TITLE

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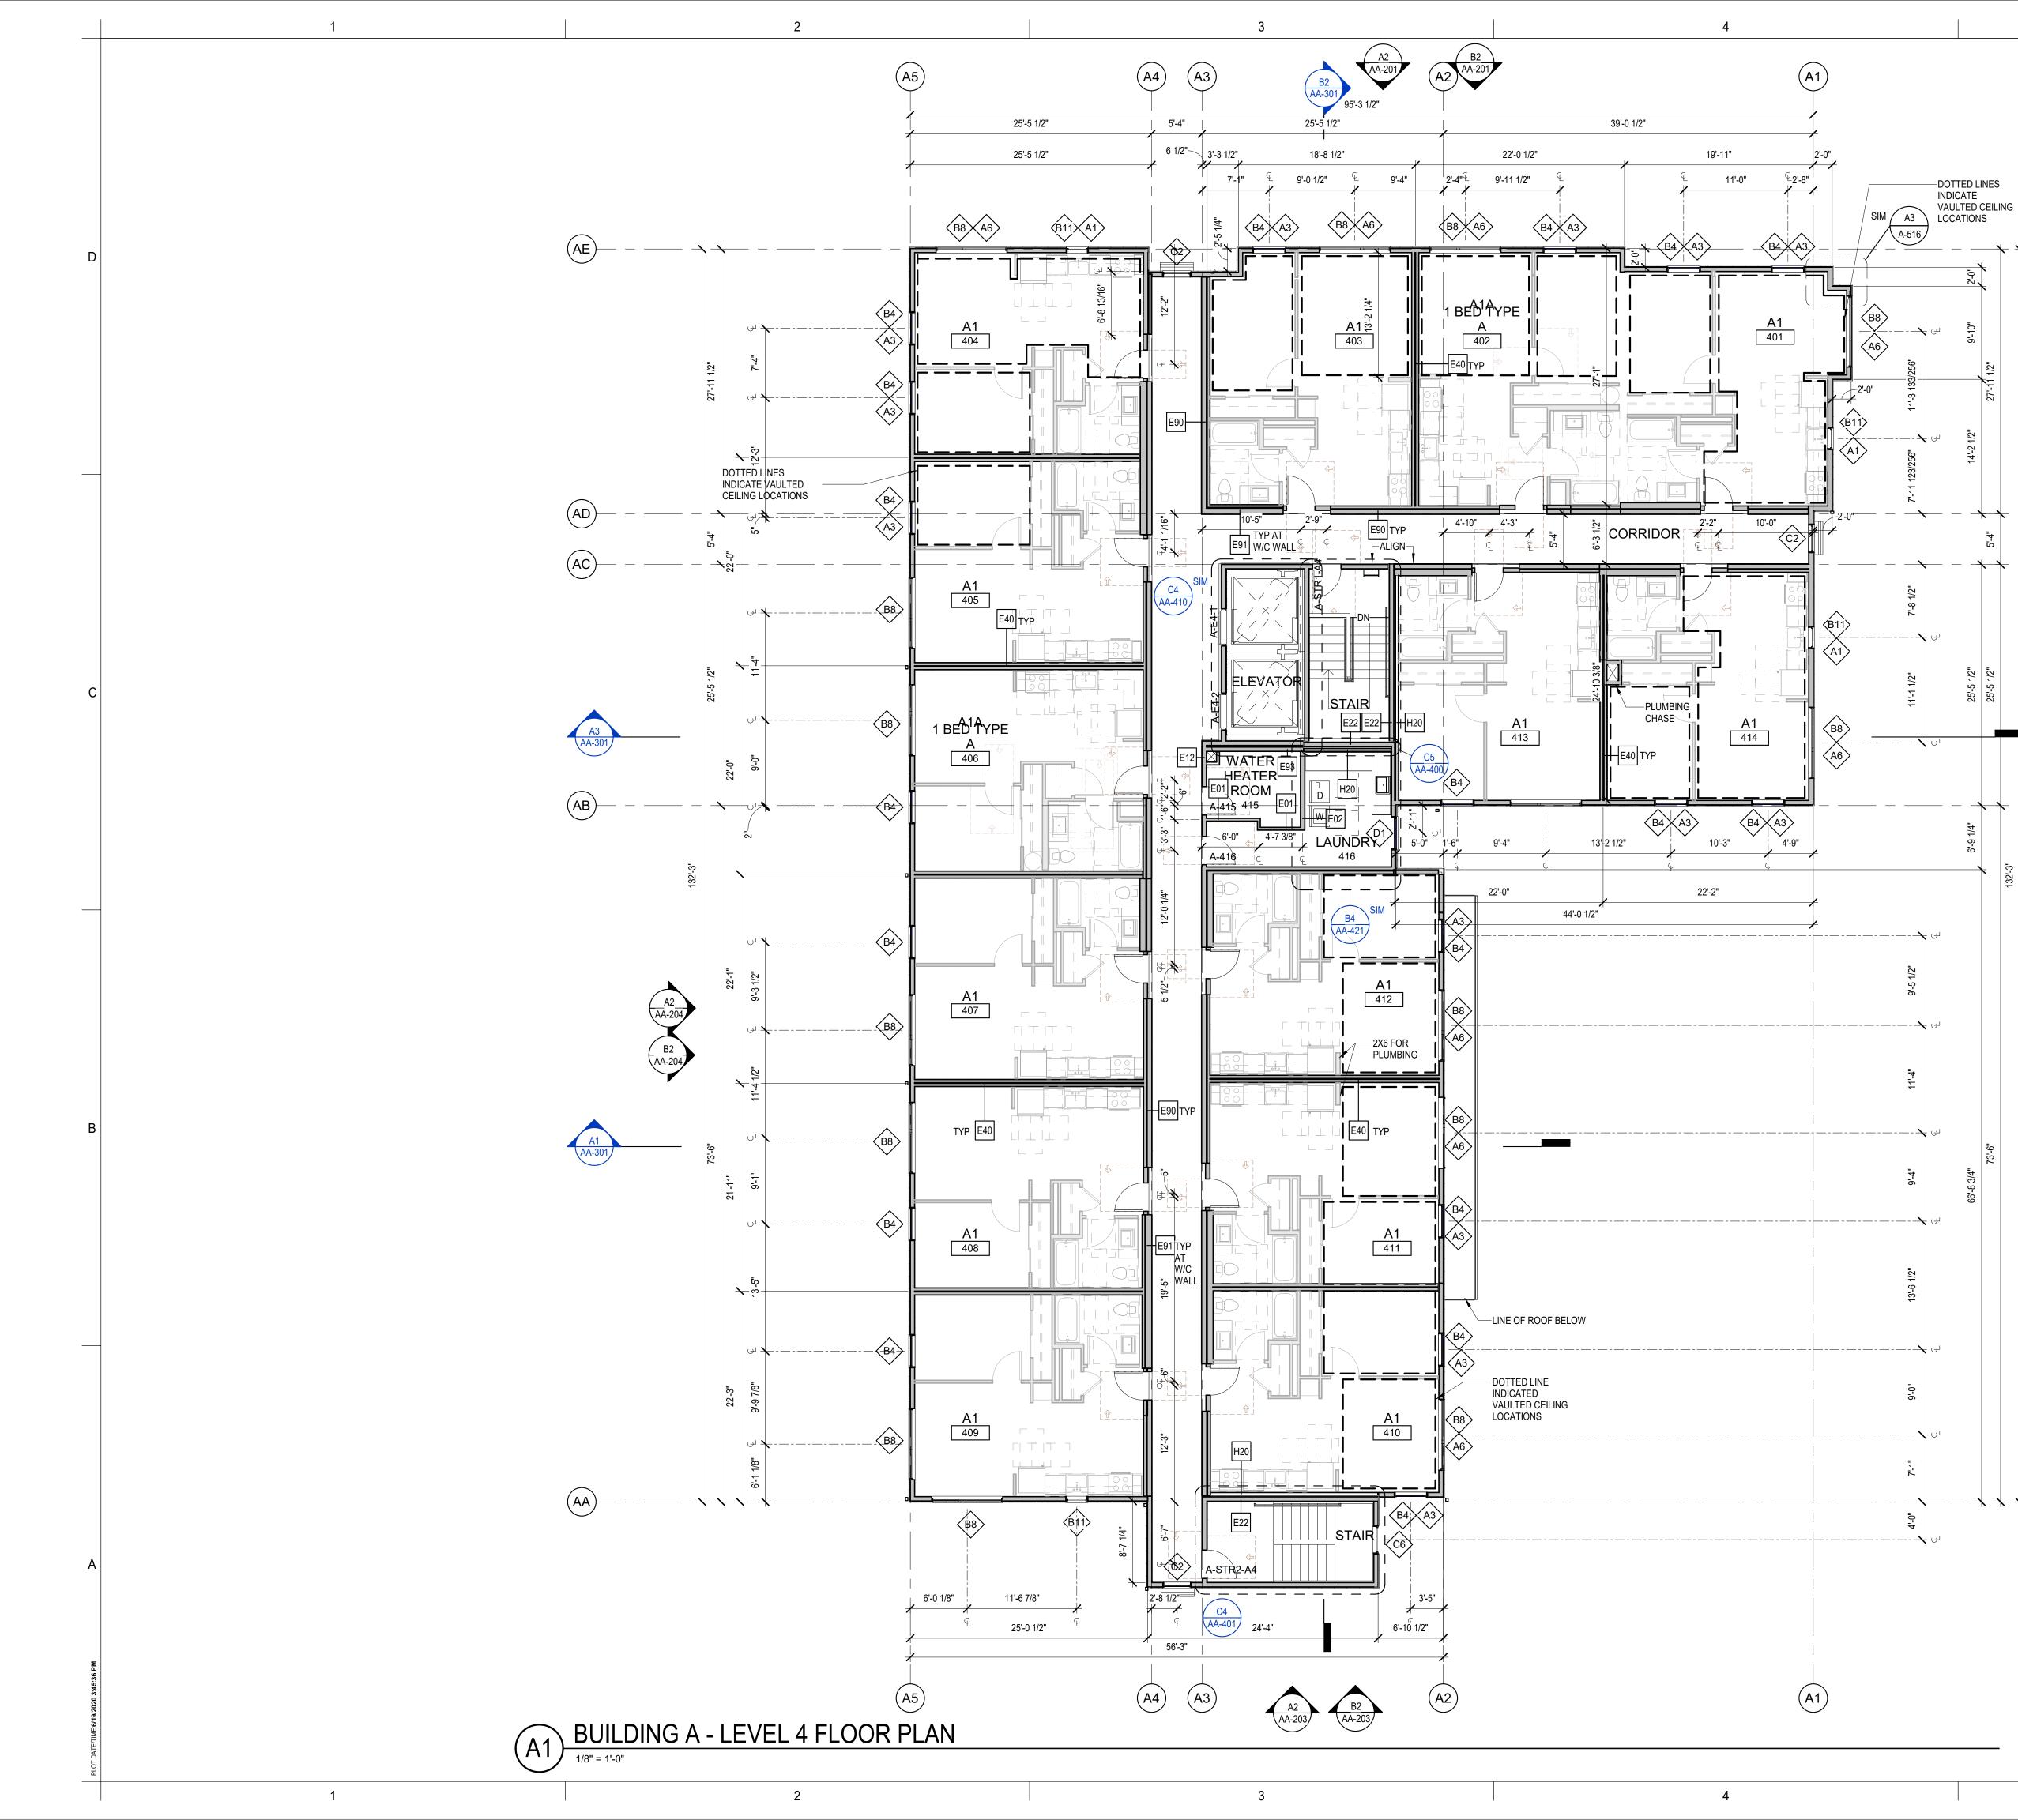
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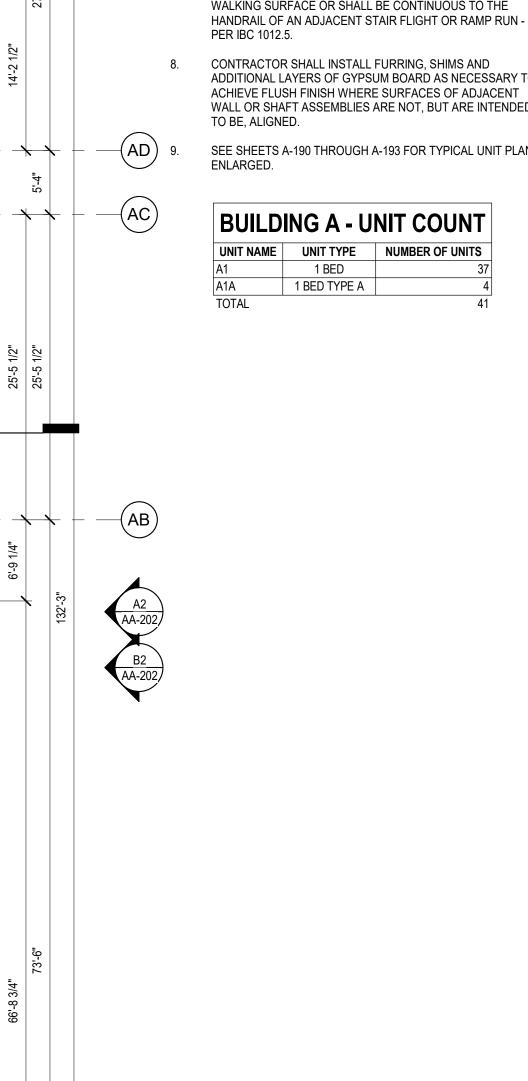


## GENERAL FLOOR PLAN NOTES

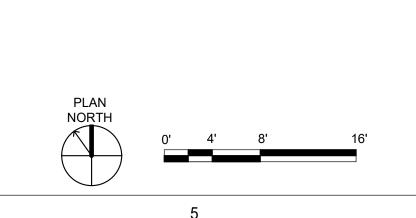
- 1. PLAN DIMENSIONS ARE TO FACE OF STUD, FACE OF CONCRETE WALL, CENTERLINE OF COLUMN, OR CENTERLINE OF ROUGH OPENINGS, UON. CONTACT ARCHITECT FOR CLARIFICATIONS.
  - DOORS AND CASED OPENINGS INDICATED ADJACENT TO WALL INTERSECTIONS SHALL BE LOCATED WITH THE EDGE OF FINISH OPENING SIX INCHES FROM THE ADJACENT WALL AT THE EXTERIOR AND FOUR INCHES FROM THE ADJACENT WALL.
  - SEE SHEET A-540 & A-620 FOR WINDOW LEGEND AND DETAILS.
- SEE SHEET A-545 & A-615 FOR DOOR SCHEDULE AND DETAILS.
- SEE SHEET A-605 FOR WALL ASSEMBLIES.

-(AE)

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- SEE SHEETS A-190 THROUGH A-193 FOR TYPICAL UNIT PLANS ENLARGED.



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0\	WNER:
	VERETT HOUSING AUTHORITY 107 COLBY AVE
-	VERETT, WA 98201

Date 1 Revision 1 MARK DATE DESCRIPTION

REVISIONS

С	06/22/2020	BUILDING PERMIT SUBMI
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A	01/07/2020	SCHEMATIC DESIGN
MARK	DATE	DESCRIPTION
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SHEET TITLE

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**BUILDING A - LEVEL 4** FLOOR PLAN

SHEET NO.

AA-113

GGLO PRINCIPAL IN CHARGE:

GGLO PROJECT MANAGER:

**OWNER APPROVA** 

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Jon Hall

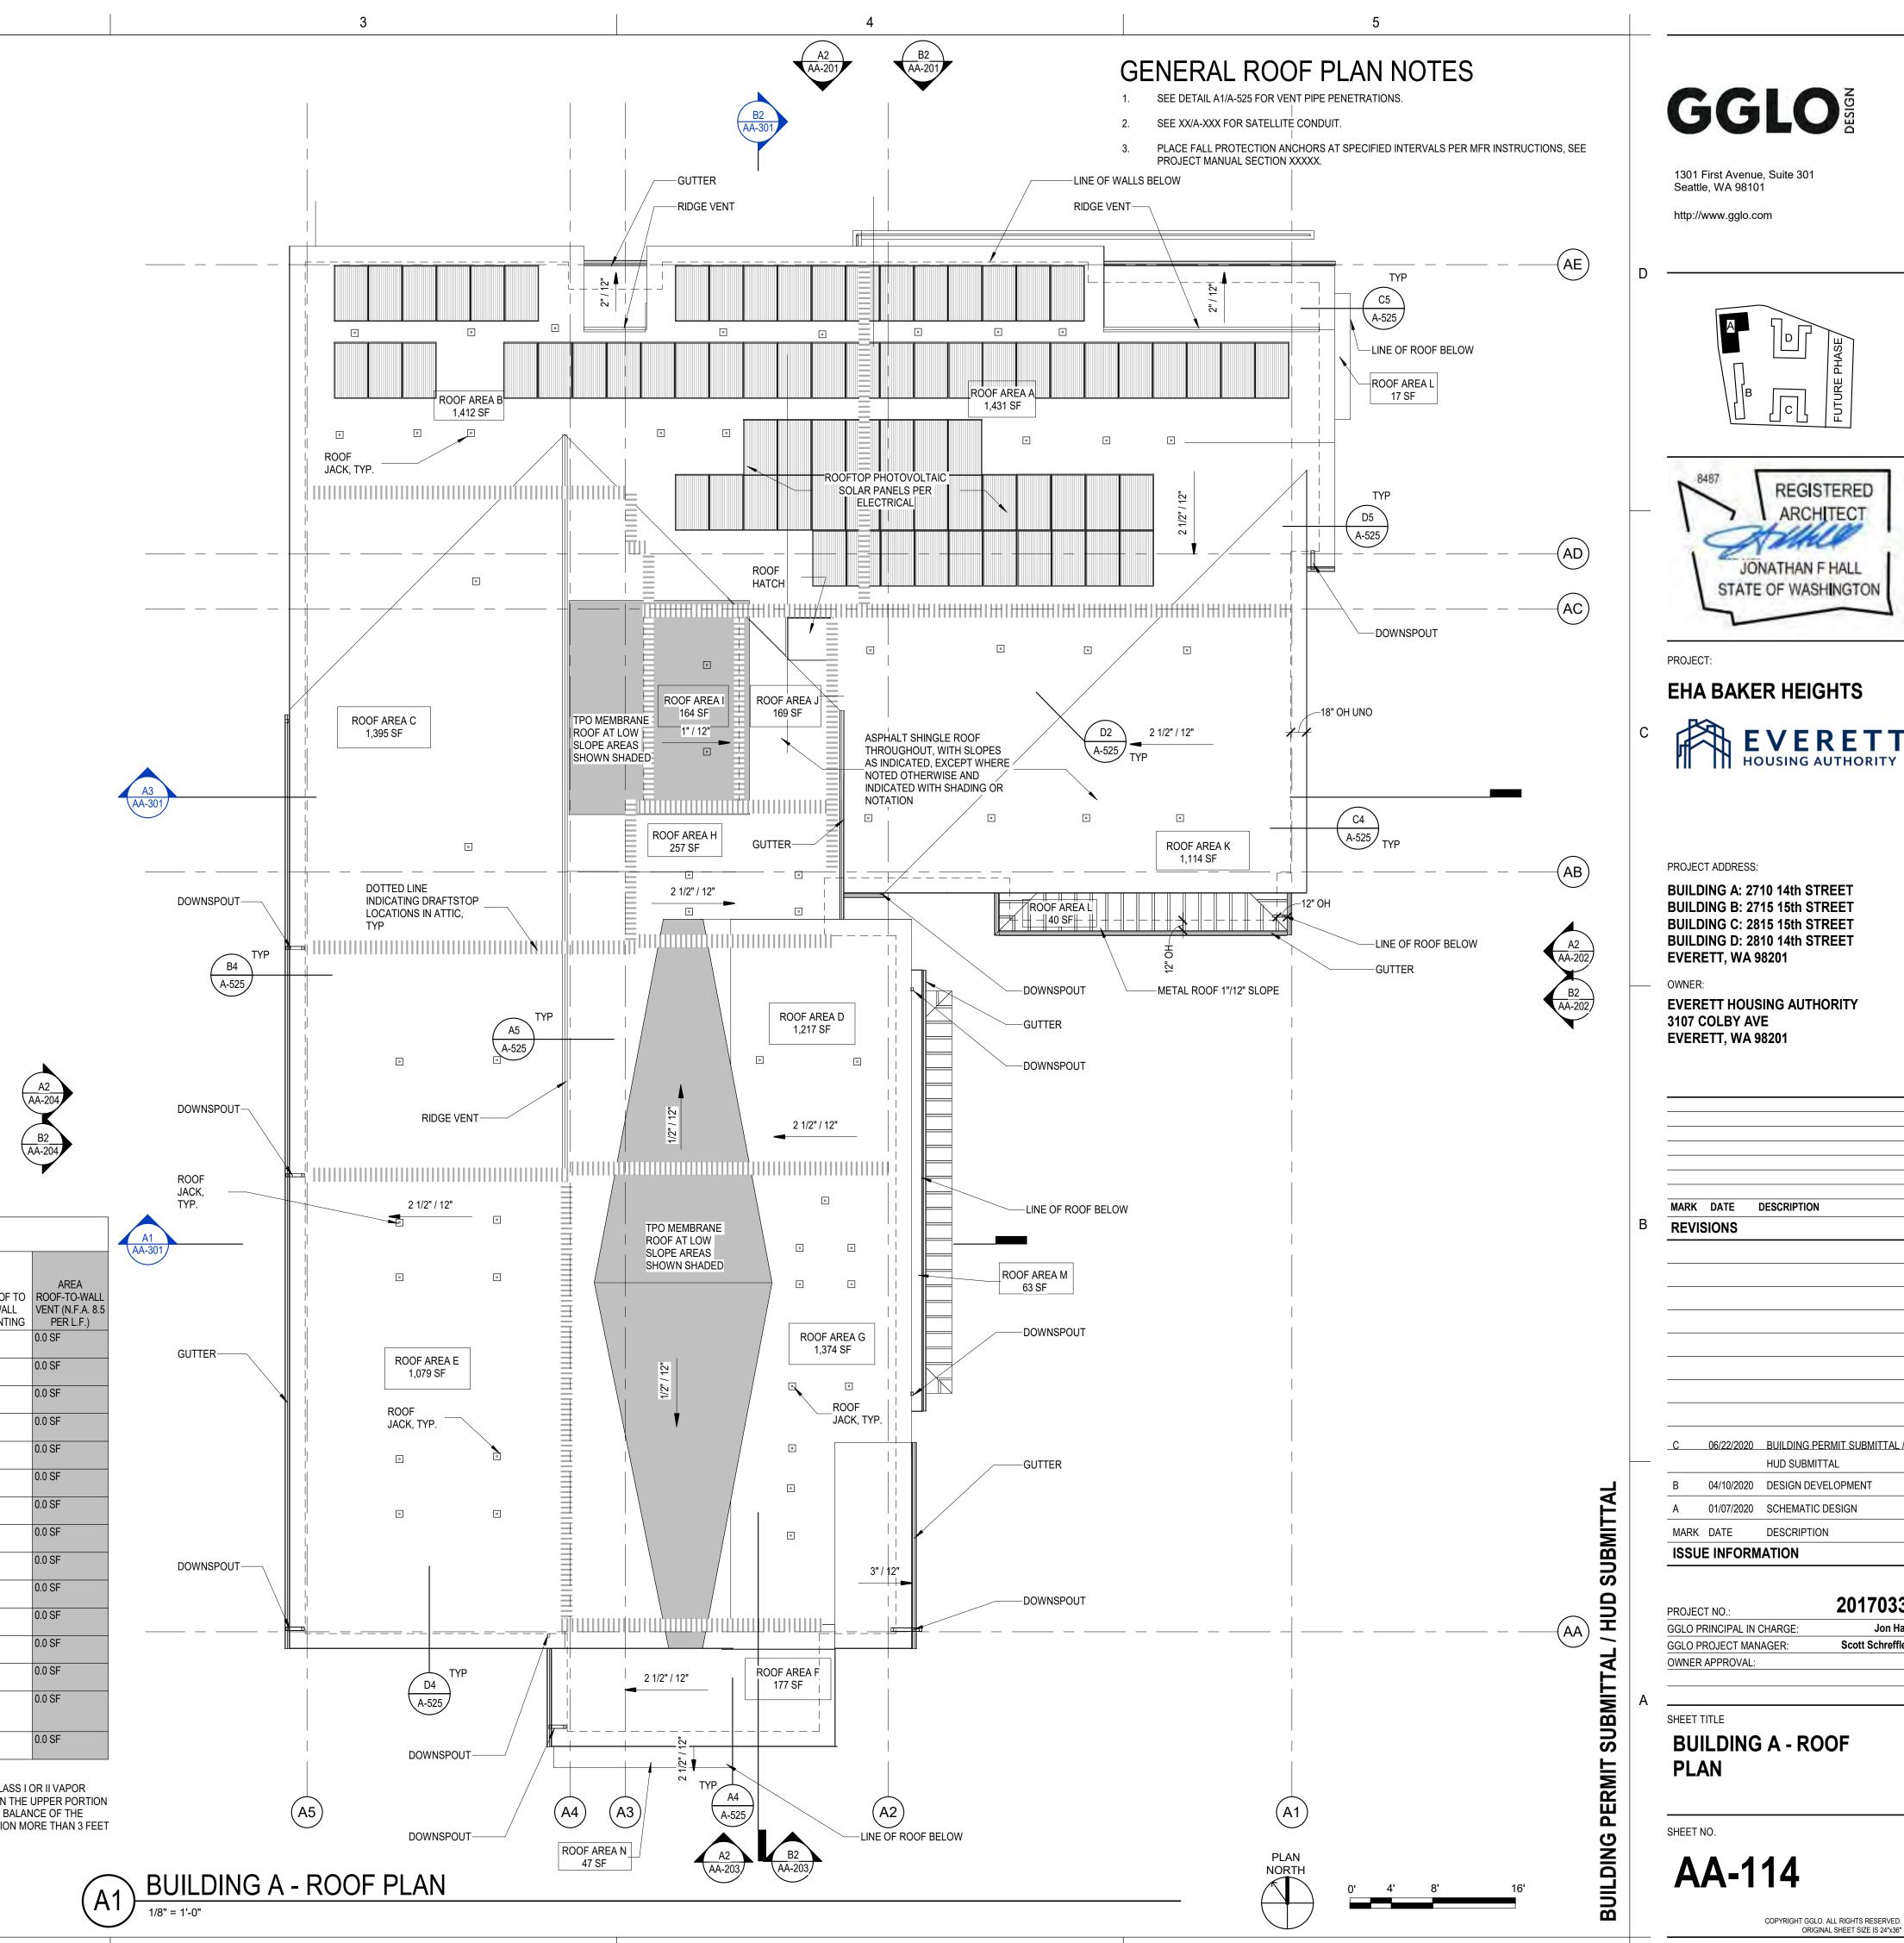
Scott Schreffler

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	NAME	AREA	REQUIRED VENT AREA - 1/300	PROVIDED VENT AREA	% OF REQ'D VENTING 3' ABOVE EAVE VENTS	% OF TOTAL VENT AREA 3' ABOVE EAVE	RIDGE	AREA RIDGE VENTING	EAVE VENTING-LOW TWO 2" DIAMETER HOLES/LF	AREA EAVE VENTING- LOW (NFVA 3.14 SQ IN/LF)	EAVE VENTING- HIGH TWO 2" DIAMETER HOLES/LF	VENTING- HIGH	LOW ROOF JACKS COUNT	AREA LOW ROOF JACK (NFVA: 55 SQ. IN. PER ROOF JACK)	HIGH ROOF JACKS COUNT	AREA HIGH ROOF JACK (NFVA: 55 SQ IN. PER JACK)	ROOF T WALL VENTIN
	ROOF AREA A	1,435 SF	4.8 SF	5.1 SF	65%	61%	22 LF	2 SF	43 LF	0.9 SF	0 LF	0.0 SF	3	1 SF	3	1.1 SF	0 LF
	ROOF AREA B	1,414 SF	4.7 SF	5.0 SF	52%	49%	6 LF	1 SF	33 LF	0.7 SF	0 LF	0.0 SF	5	2 SF	5	1.9 SF	0 LF
	ROOF AREA C	1,394 SF	4.6 SF	5.3 SF	93%	82%	44 LF	4 SF	29 LF	0.6 SF	0 LF	0.0 SF	1	0 SF	1	0.4 SF	0 LF
	ROOF AREA D	1,217 SF	4.1 SF	4.1 SF	68%	67%	22 LF	2 SF	29 LF	0.6 SF	0 LF	0.0 SF	2	1 SF	2	0.8 SF	0 LF
	ROOF AREA E	1,079 SF	3.6 SF	3.6 SF	42%	42%	0 LF	0 SF	29 LF	0.6 SF	0 LF	0.0 SF	4	2 SF	4	1.5 SF	0 LF
	ROOF AREA F	177 SF	0.6 SF	0.9 SF	0%	0%	0 LF	0 SF	44 LF	0.9 SF	0 LF	0.0 SF	0	0 SF	0	0.0 SF	0 LF
	ROOF AREA G	1,374 SF	4.6 SF	4.7 SF	41%	41%	0 LF	0 SF	44 LF	0.9 SF	0 LF	0.0 SF	5	2 SF	5	1.9 SF	0 LF
	ROOF AREA H	257 SF	0.9 SF	1.5 SF	89%	50%	0 LF	0 SF	0 LF	0.0 SF	0 LF	0.0 SF	2	1 SF	2	0.8 SF	0 LF
	ROOF AREA I	163 SF	0.5 SF	1.5 SF	70%	25%	0 LF	0 SF	38 LF	0.8 SF	0 LF	0.0 SF	1	0 SF	1	0.4 SF	0 LF
	ROOF AREA J	169 SF	0.6 SF	0.6 SF	0%	0%	0 LF	0 SF	28 LF	0.6 SF	0 LF	0.0 SF	0	0 SF	0	0.0 SF	0 LF
	ROOF AREA K	1,110 SF	3.7 SF	3.8 SF	41%	40%	0 LF	0 SF	38 LF	0.8 SF	0 LF	0.0 SF	4	2 SF	4	1.5 SF	0 LF
	ROOF AREA L	17 SF	0.1 SF	0.8 SF	0%	0%	0 LF	0 SF	38 LF	0.8 SF	0 LF	0.0 SF	0	0 SF	0	0.0 SF	0 LF
	ROOF AREA L	40 SF	0.1 SF	0.3 SF	0%	0%	0 LF	0 SF	13 LF	0.3 SF	0 LF	0.0 SF	0	0 SF	0	0.0 SF	0 LF
4	ROOF AREA M	63 SF	0.2 SF	0.6 SF	0%	0%	0 LF	0 SF	30 LF	0.6 SF	0 LF	0.0 SF	0	0 SF	0	0.0 SF	0 LF
	ROOF AREA N	47 SF	0.2 SF	0.2 SF	0%	0%	0 LF	0 SF	8 LF	0.2 SF	0 LF	0.0 SF	0	0 SF	0	0.0 SF	0 LF

PER 2015 IBC WITH WASHINGTON AMENDMENTS, SECTION 1203.2, EXCEPTION 1: THE NET FREE CROSS-VENTILATION AREA SHALL BE PERMITTED TO BE REDUCED TO 1/300 PROVIDED THAT A CLASS I OR II VAPOR RETARDER IS INSTALLED ON THE WARM-IN WINTER SIDE OF THE CEILING. AT LEAST 40% AND NOT MORE THAN 50% OF THE REQUIRED VENTING AREA IS PROVIDED BY VENTILATORS LOCATED IN THE UPPER PORTION OF THE ATTIC OR RAFTER SPACE. UPPER VENTILATORS SHALL BE LOCATED NOT MORE THAN 3 FEET BELOW THE RIDGE OR HIGHEST POINT OF THE SPACE, MEASURED VERTICALLY, WITH THE BALANCE OF THE VENTILATION PROVIDED BY EAVE OR CORNICE VENTS. WHERE THE LOCATION OF WALL OR ROOF FRAMING MEMBERS CONFLICTS WITH THE INSTALLATION OF UPPER VENTILATORS, INSTALLTION MORE THAN 3 FEET BELOW THE RIDGE OR HIGHEST POINT OF THE SPACE SHALL BE PERMITTED.

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2017033

Scott Schreffler

Jon Hall

ARCHITECT

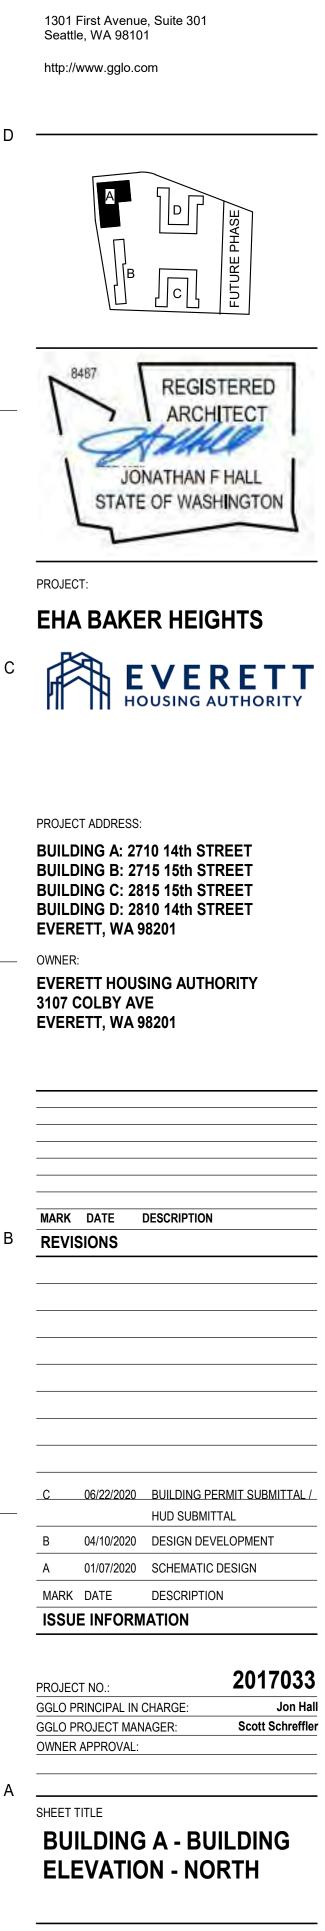
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LEVEL 1 100.35'

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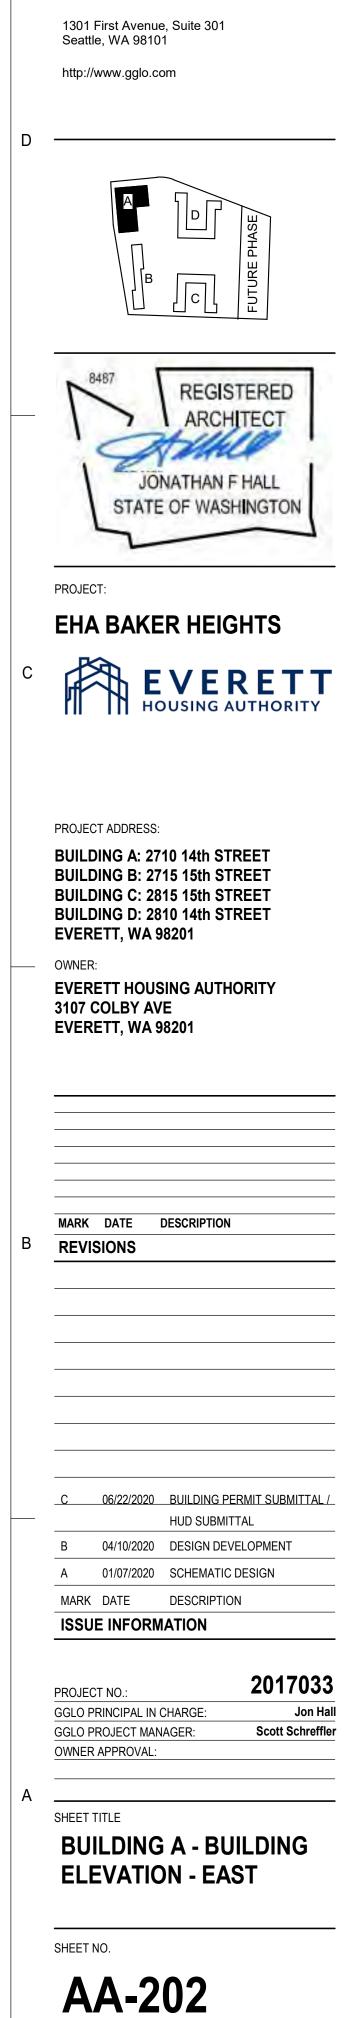
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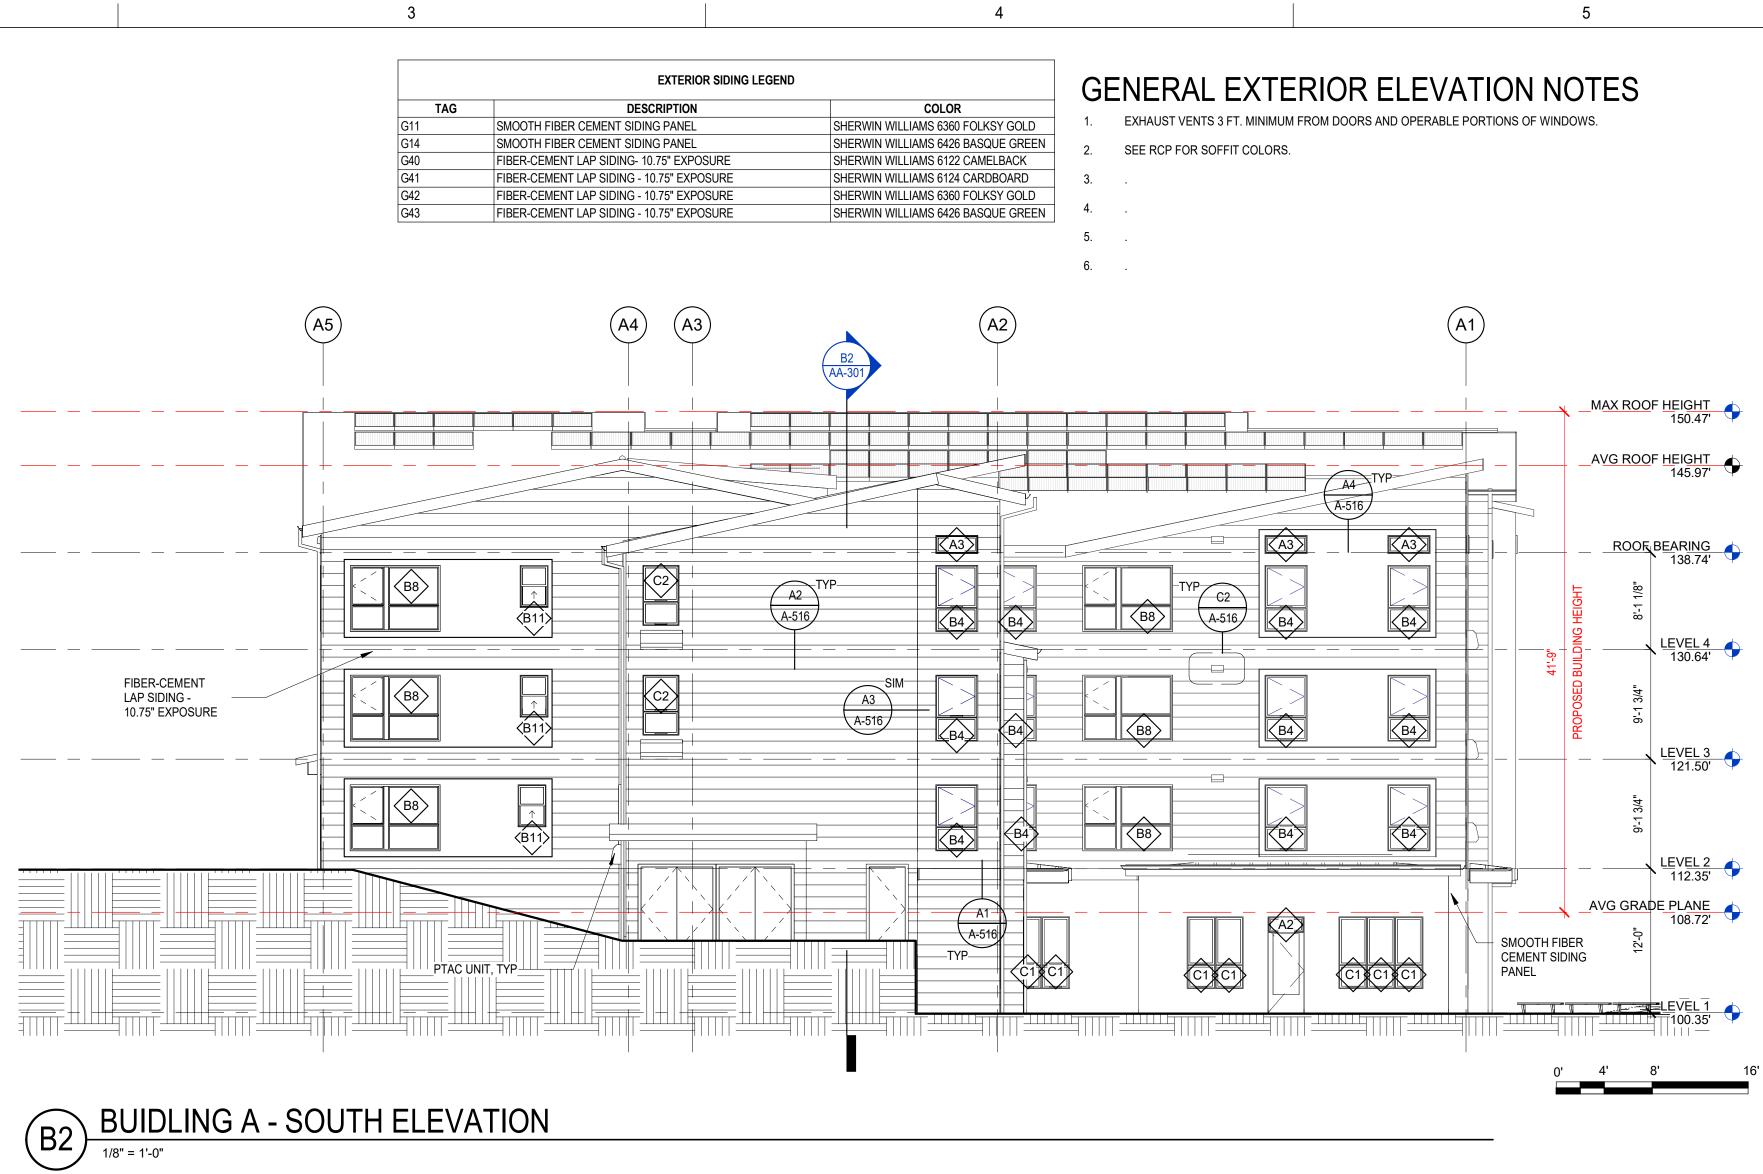
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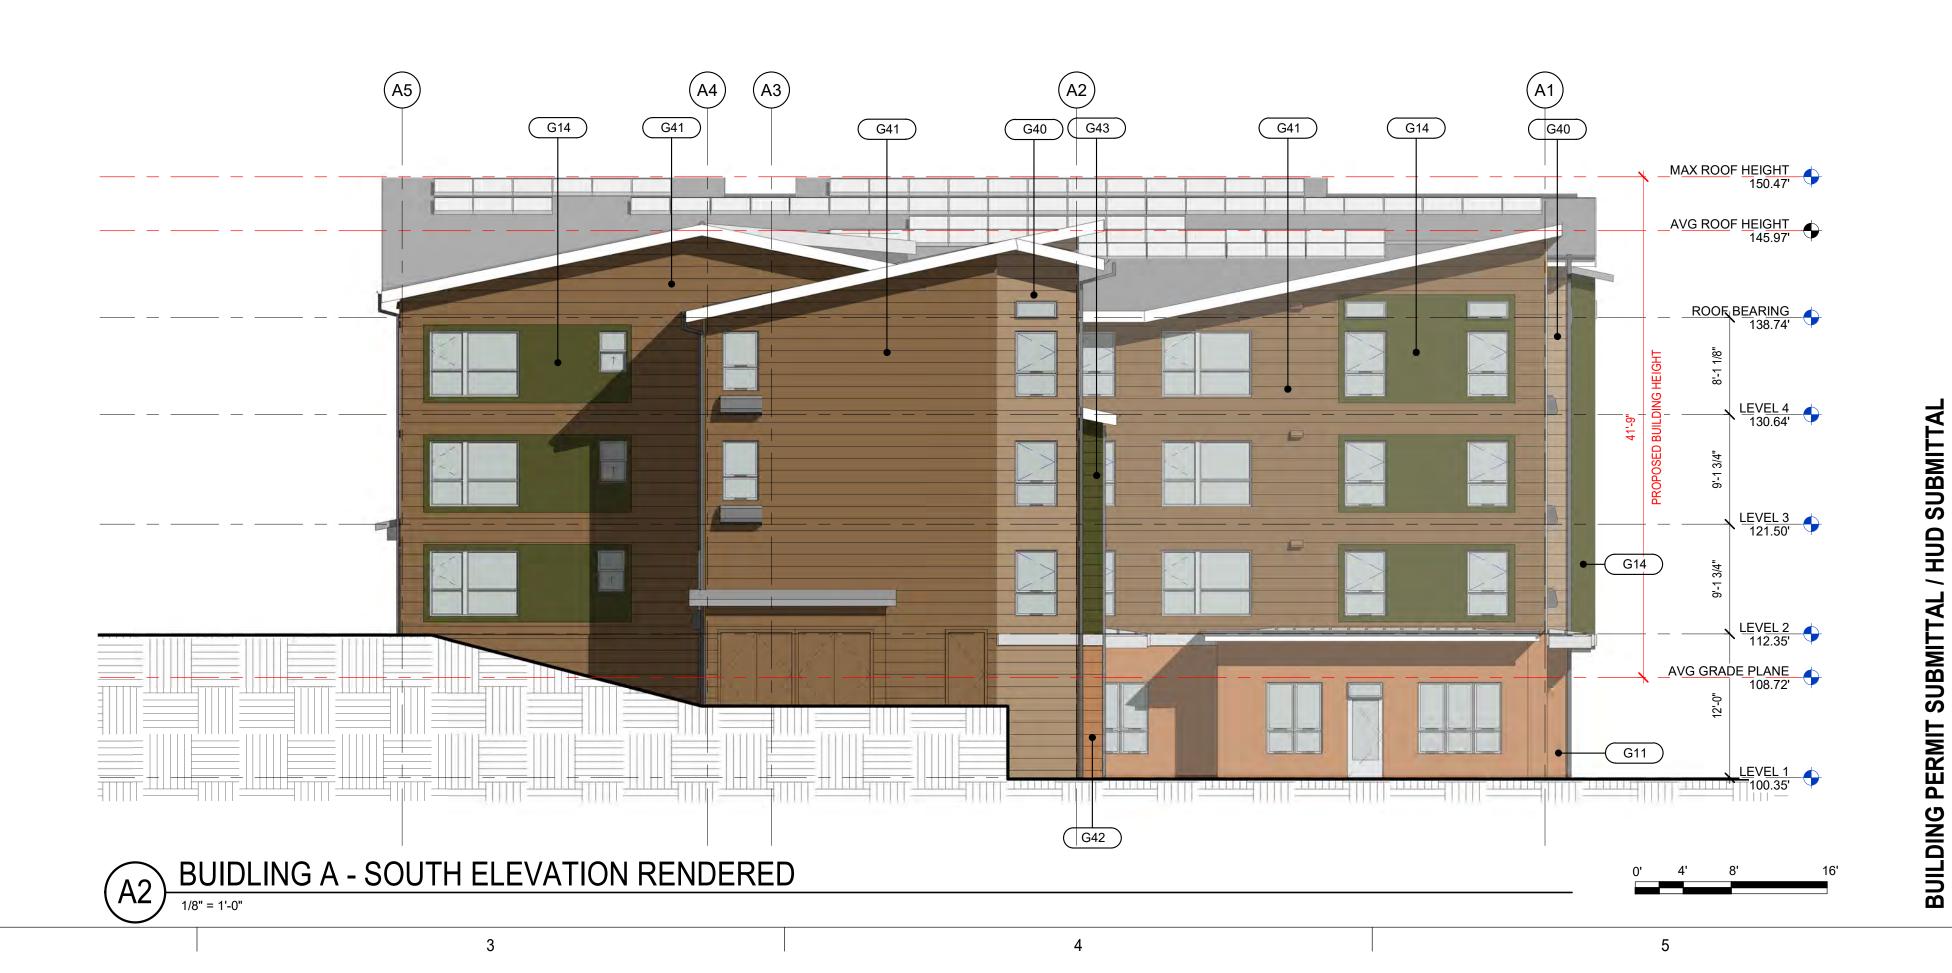
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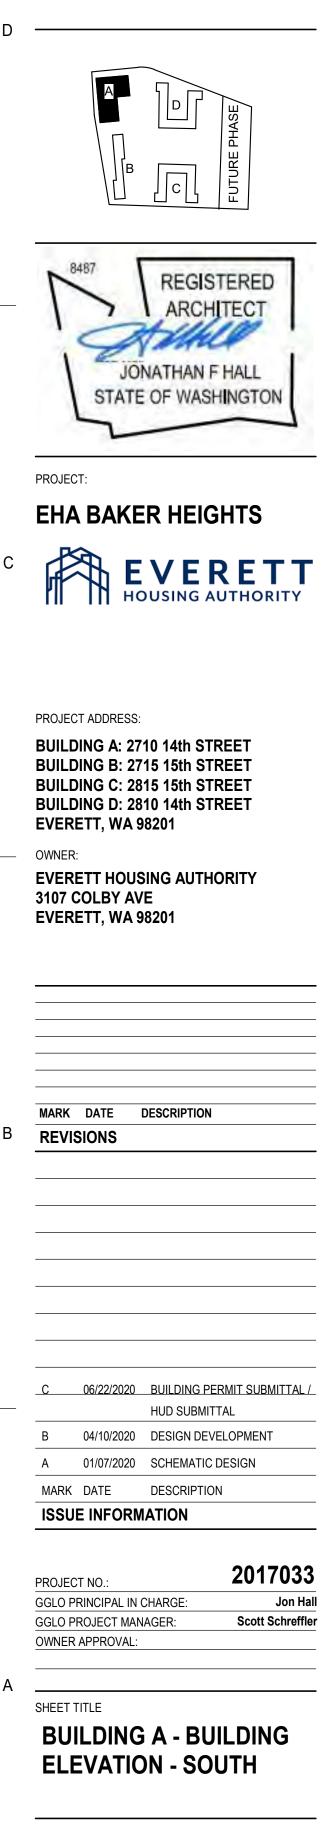
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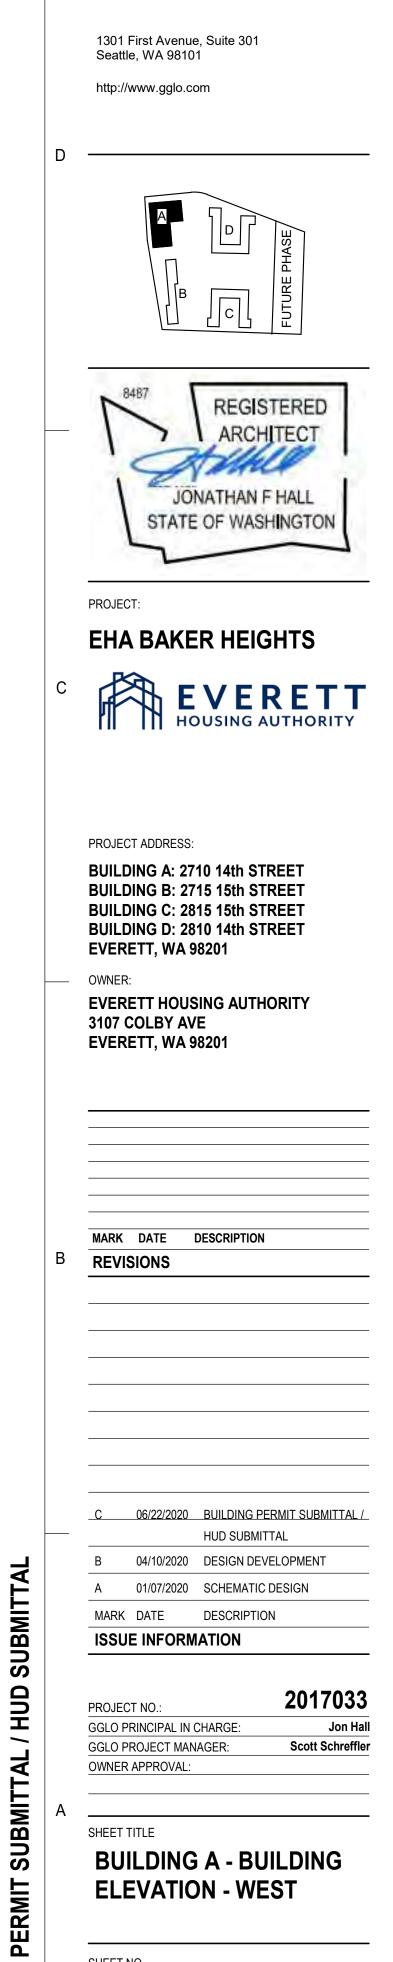
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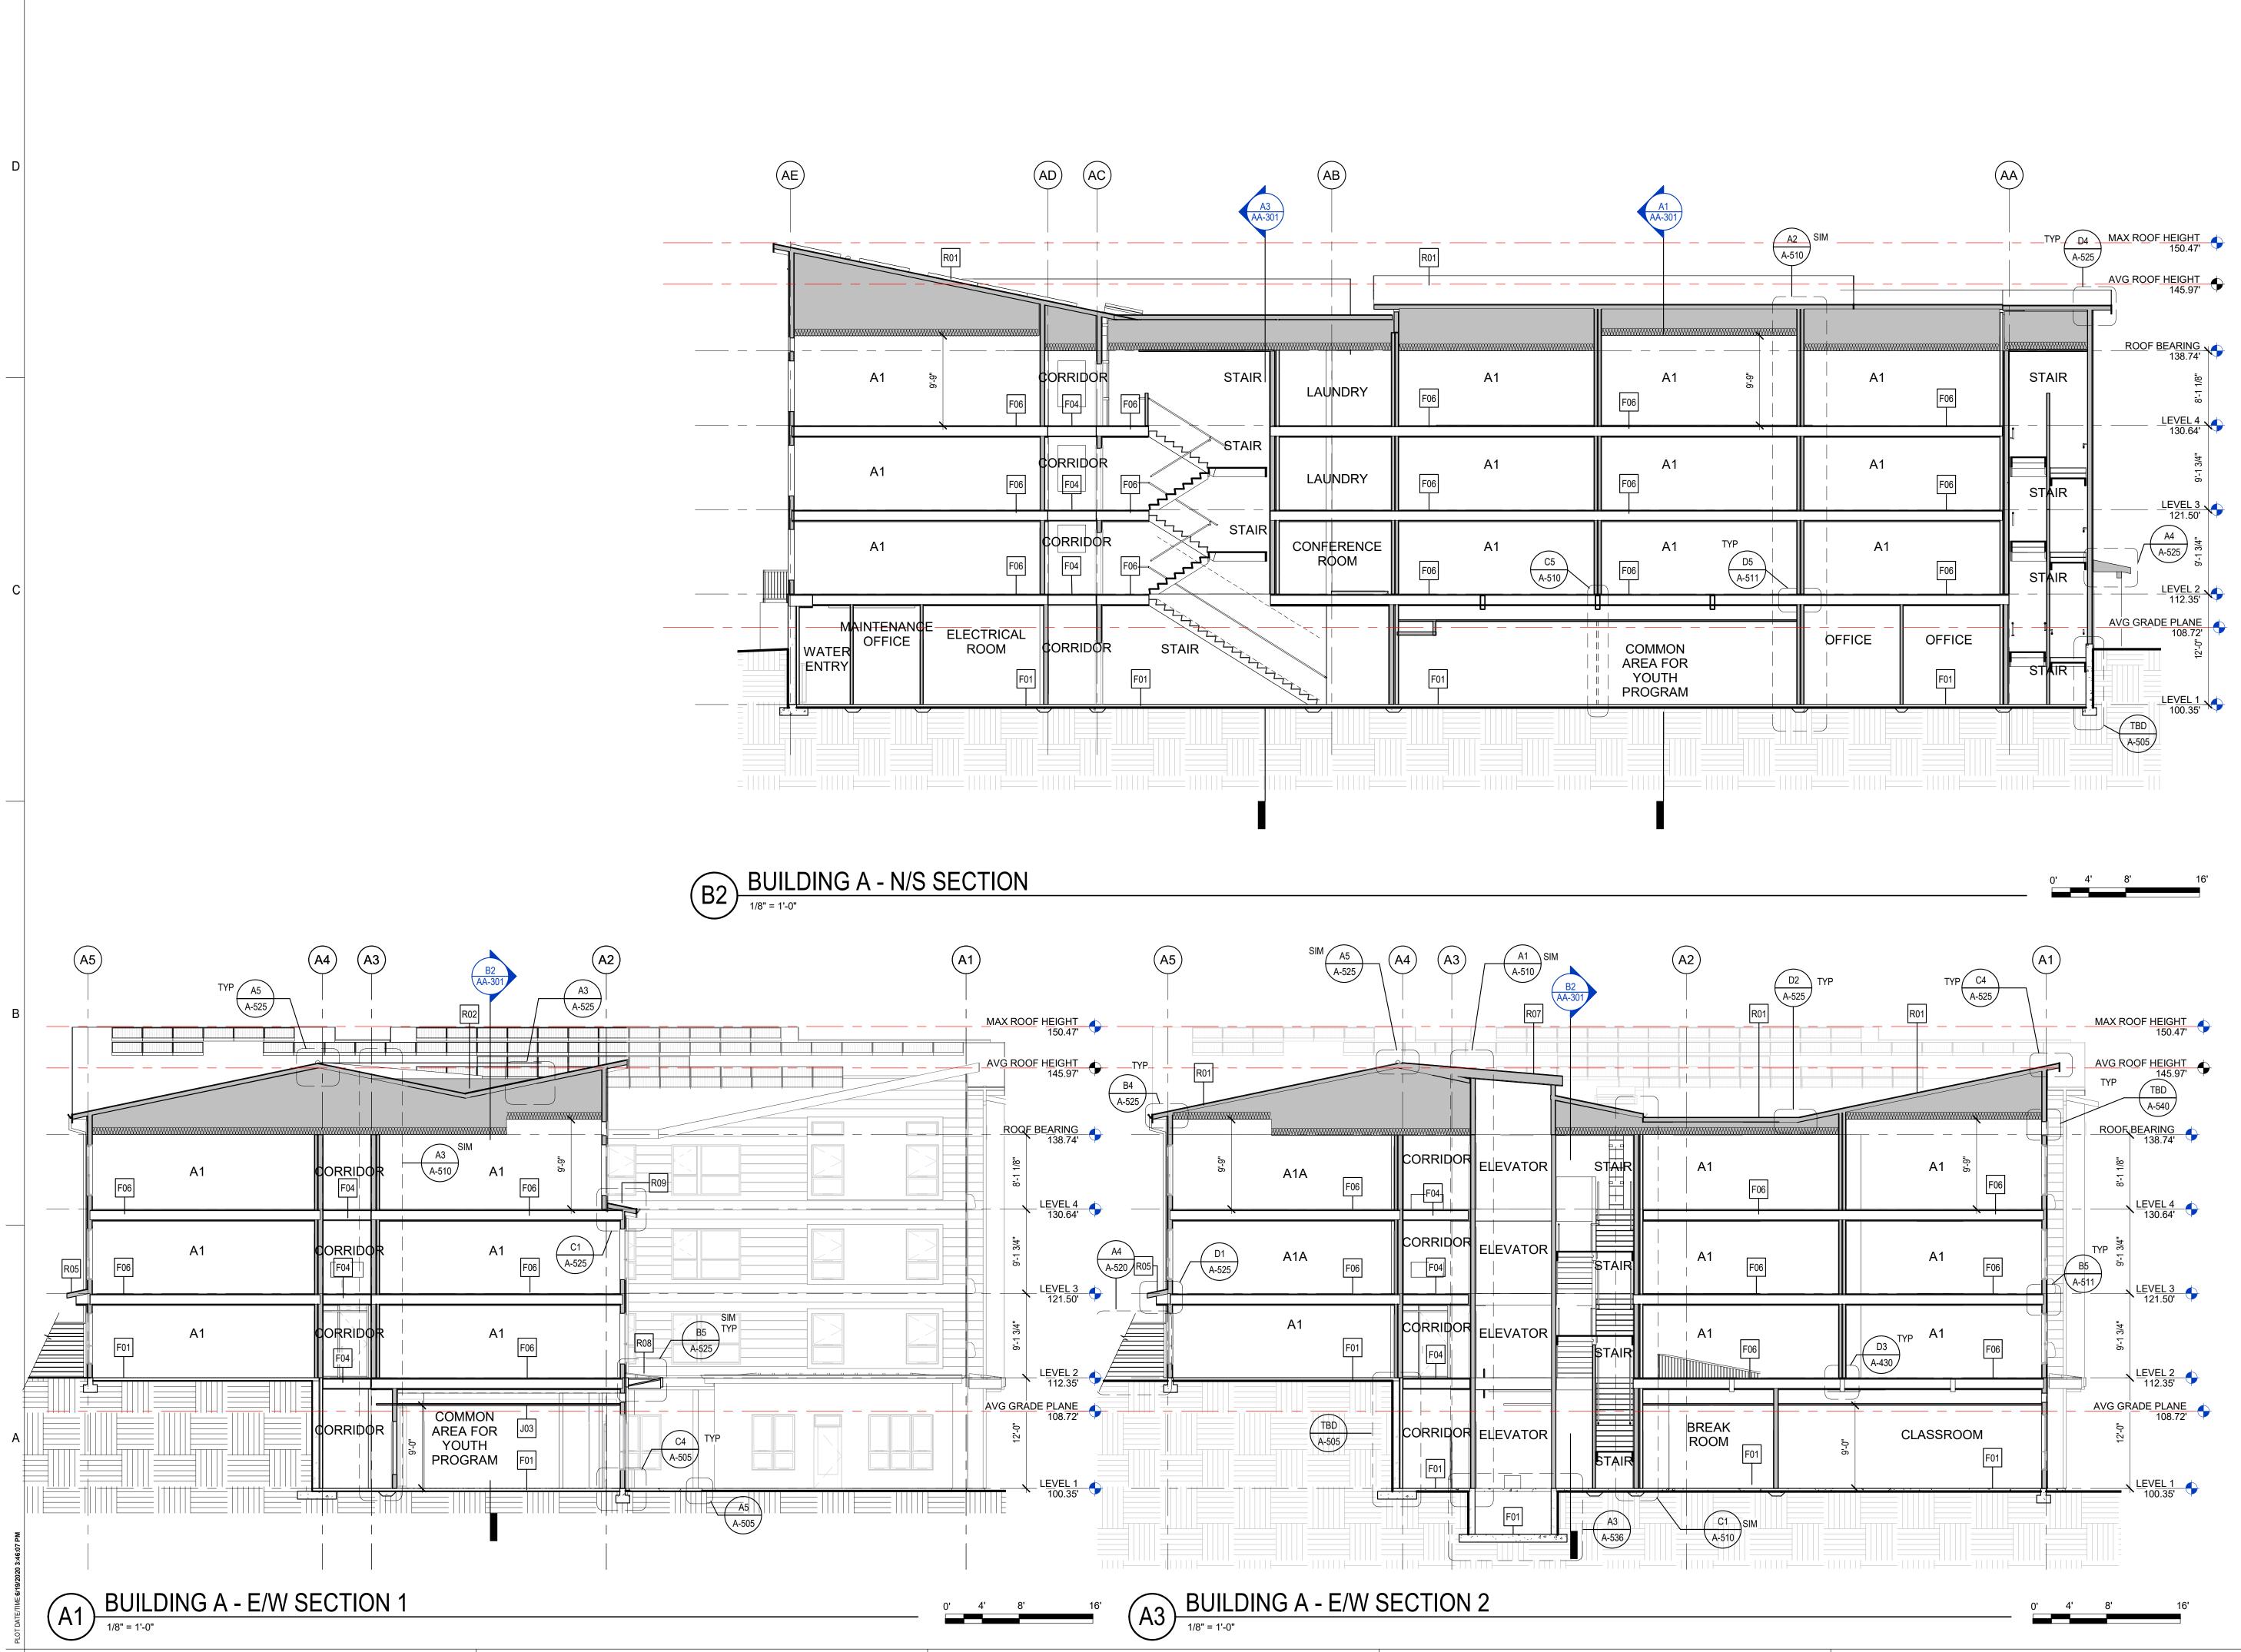
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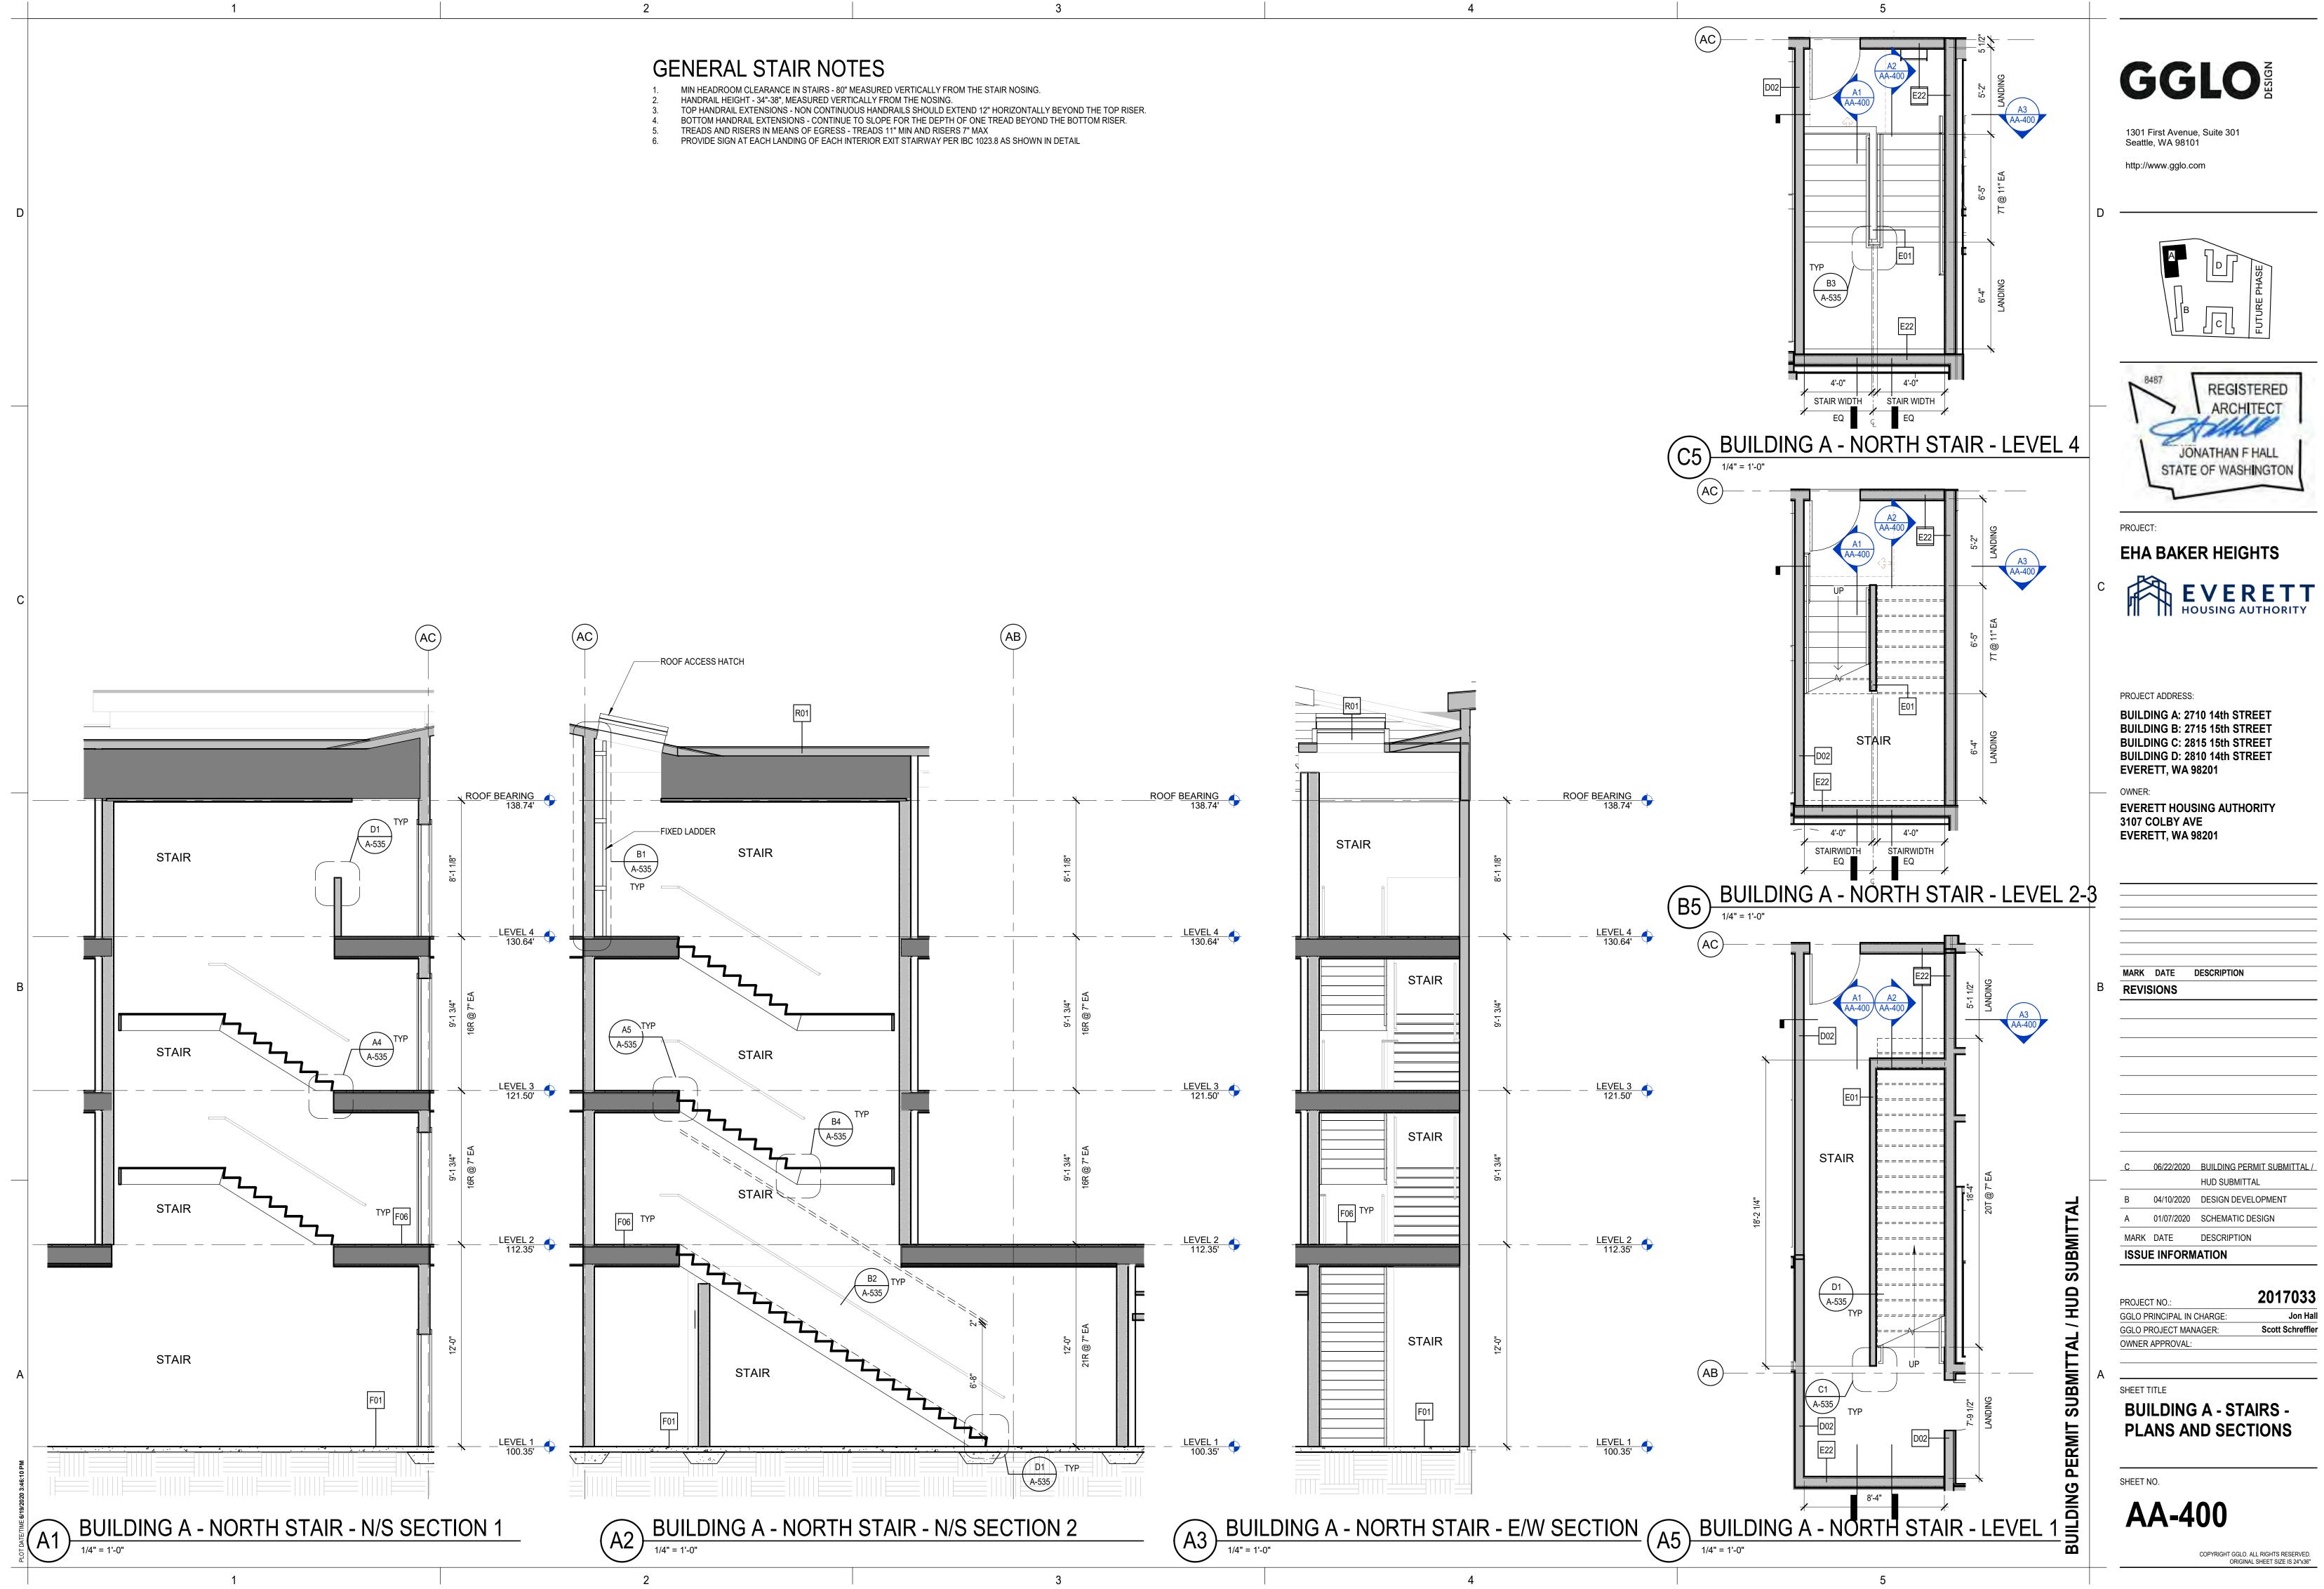
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**AA-301** 



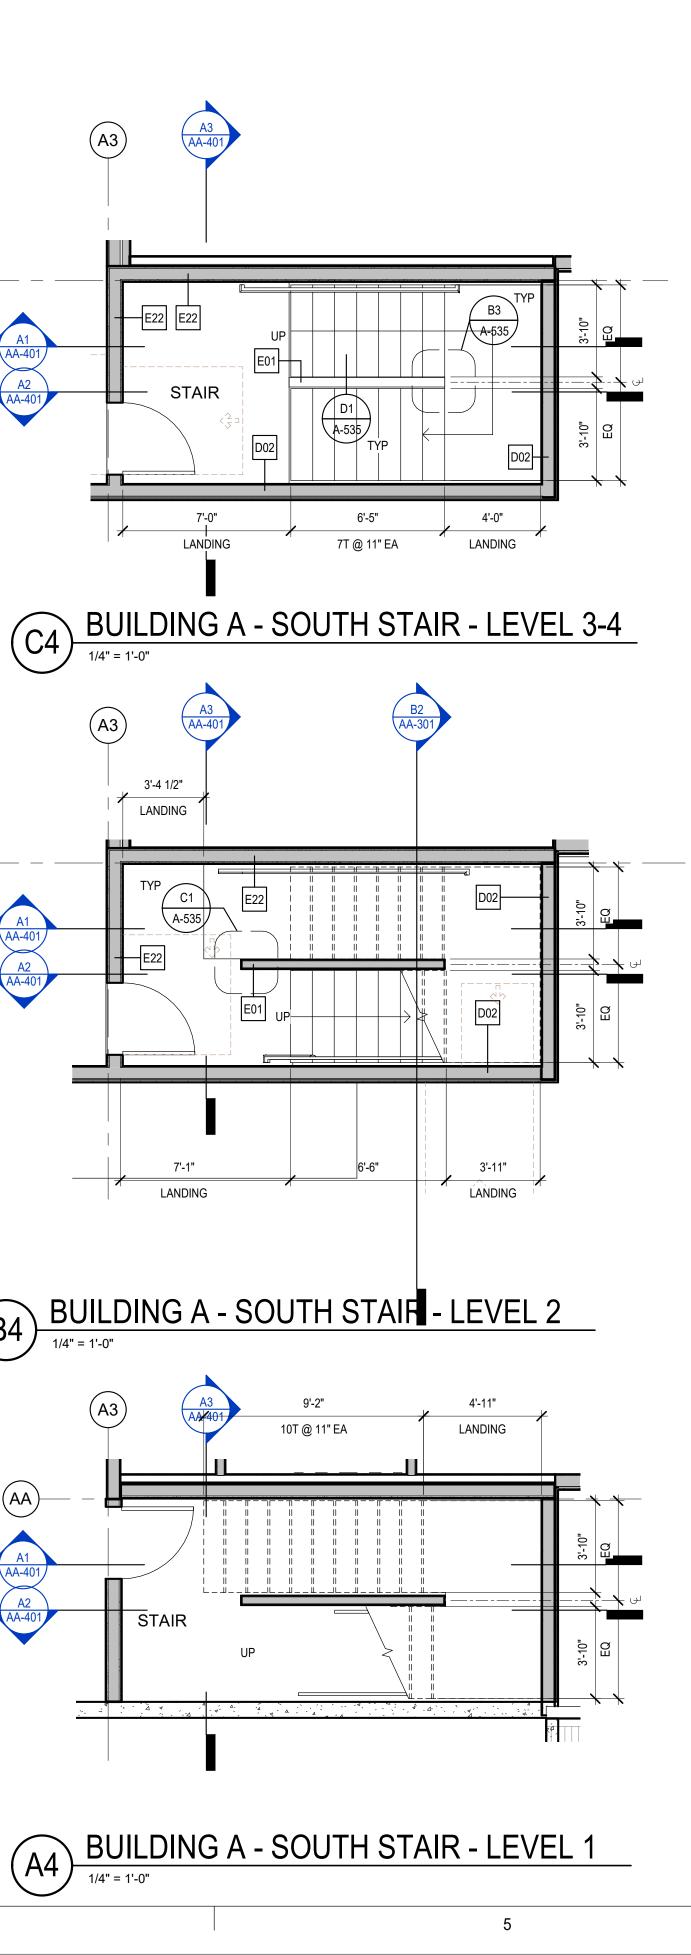


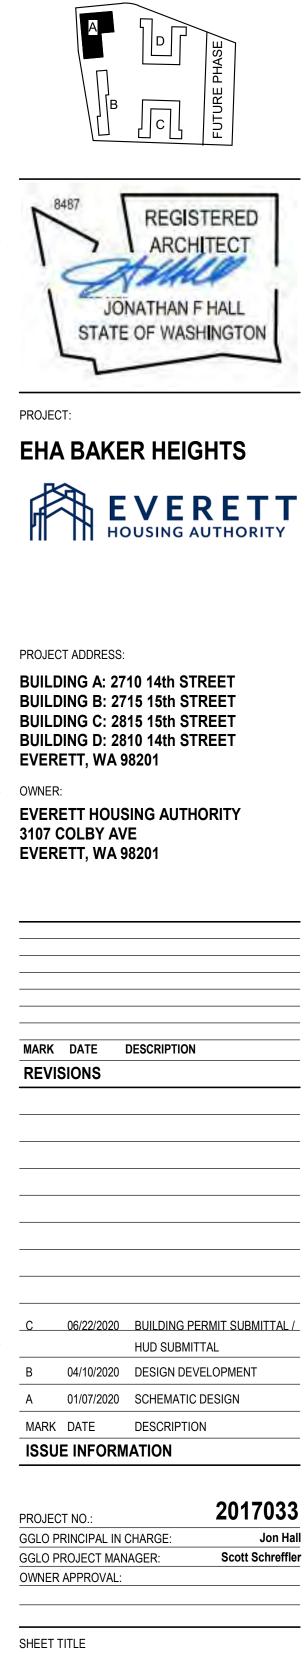


### GENERAL STAIR NOTES

MIN HEADROOM CLEARANCE IN STAIRS - 80" MEASURED VERTICALLY FROM THE STAIR NOSING. HANDRAIL HEIGHT - 34"-38", MEASURED VERTICALLY FROM THE NOSING.

TOP HANDRAIL EXTENSIONS - NON CONTINUOUS HANDRAILS SHOULD EXTEND 12" HORIZONTALLY BEYOND THE TOP RISER. BOTTOM HANDRAIL EXTENSIONS - CONTINUE TO SLOPE FOR THE DEPTH OF ONE TREAD BEYOND THE BOTTOM RISER. TREADS AND RISERS IN MEANS OF EGRESS - TREADS 11" MIN AND RISERS 7" MAX PROVIDE SIGN AT EACH LANDING OF EACH INTERIOR EXIT STAIRWAY PER IBC 1023.8 AS SHOWN IN DETAIL





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Seattle, WA 98101

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**BUILDING A - STAIRS -PLANS AND SECTIONS** 

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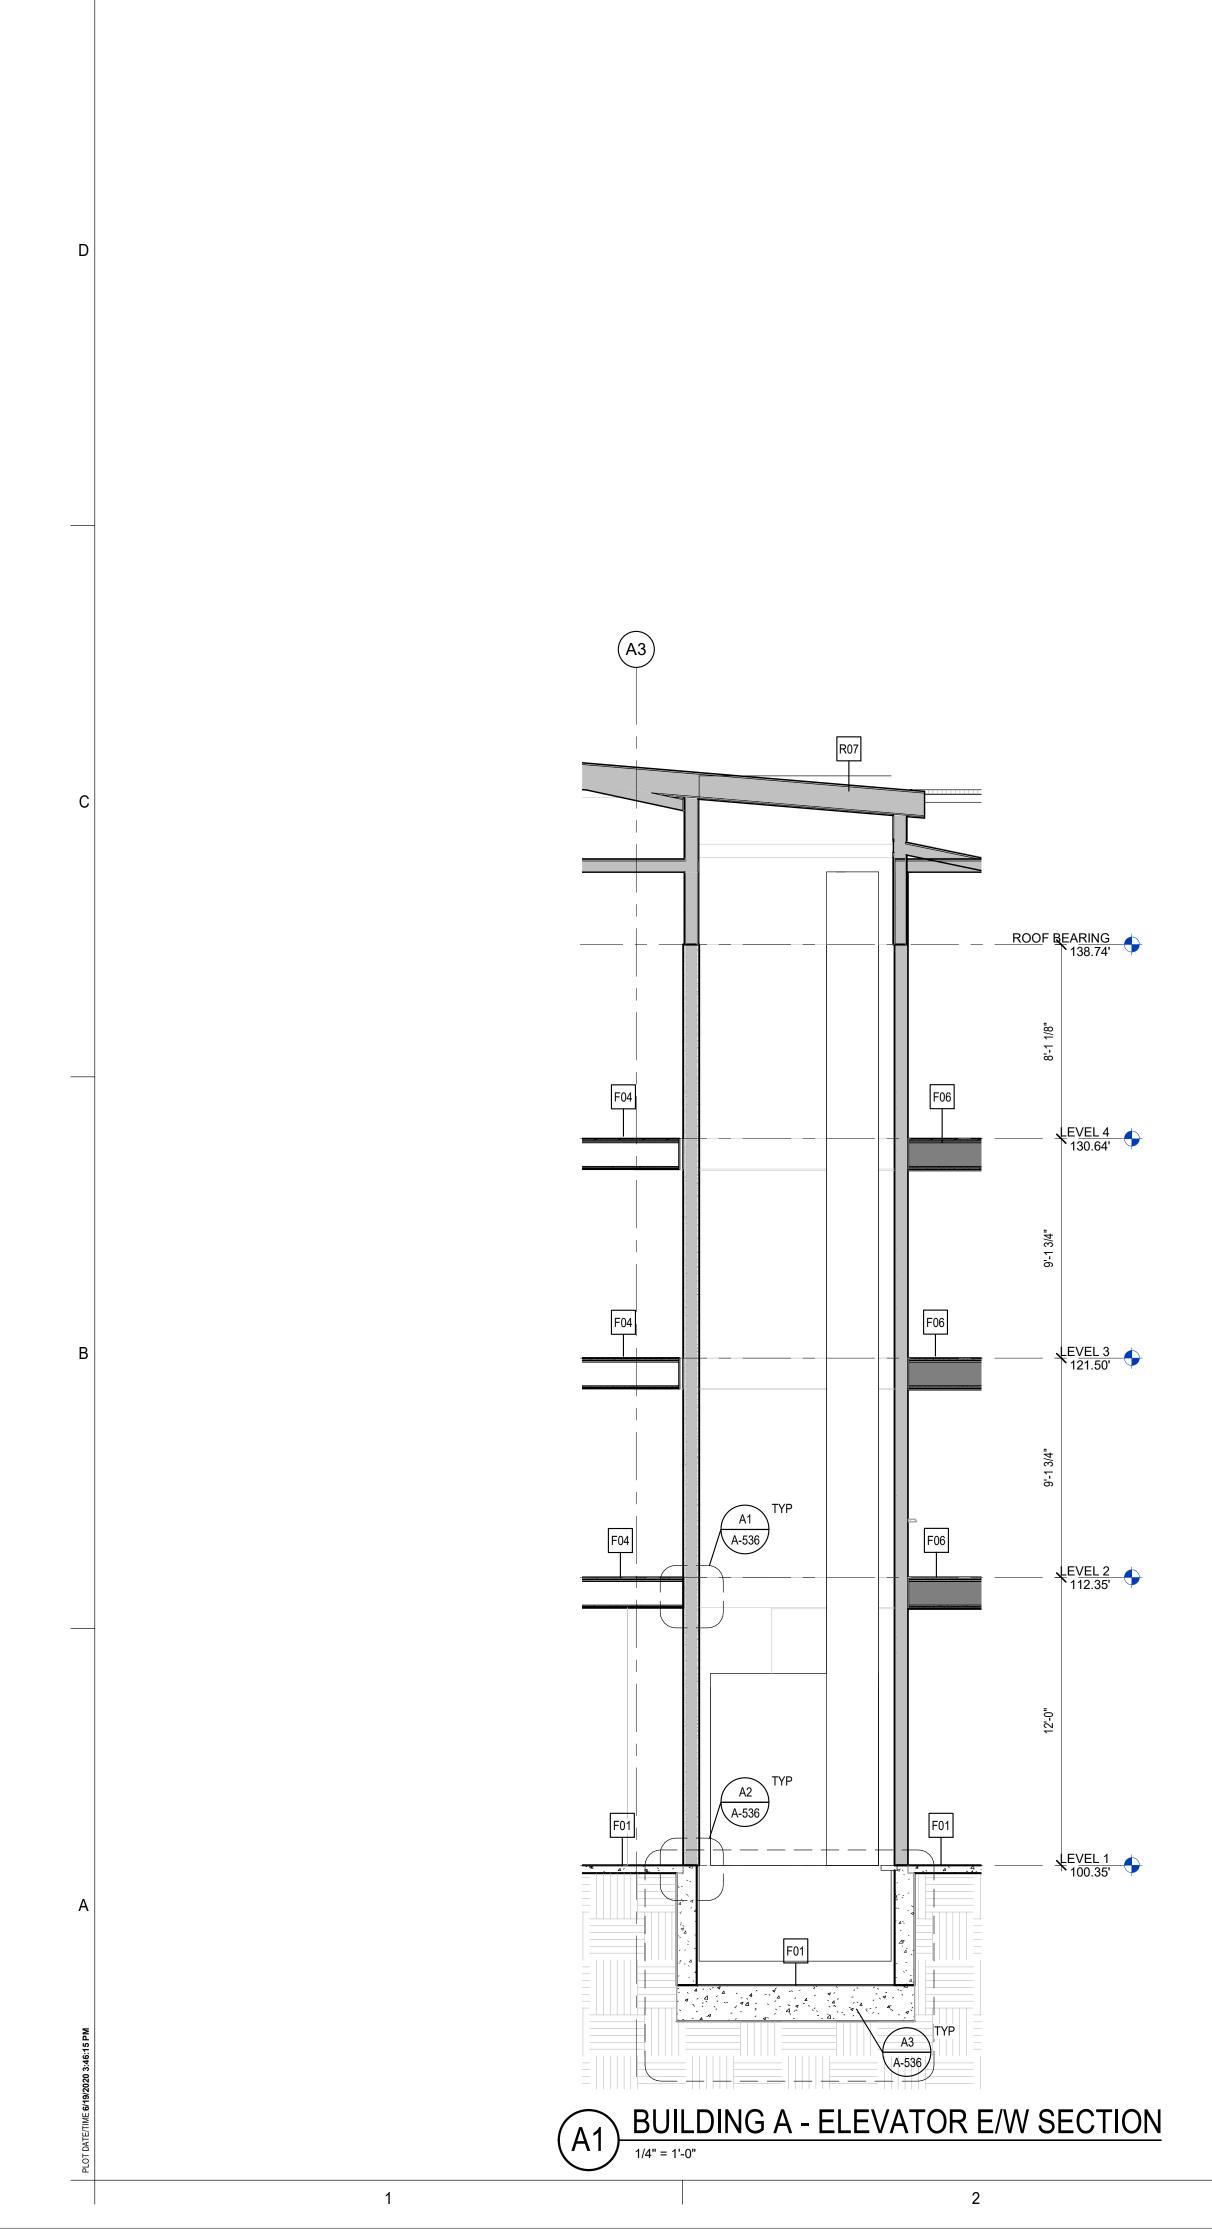
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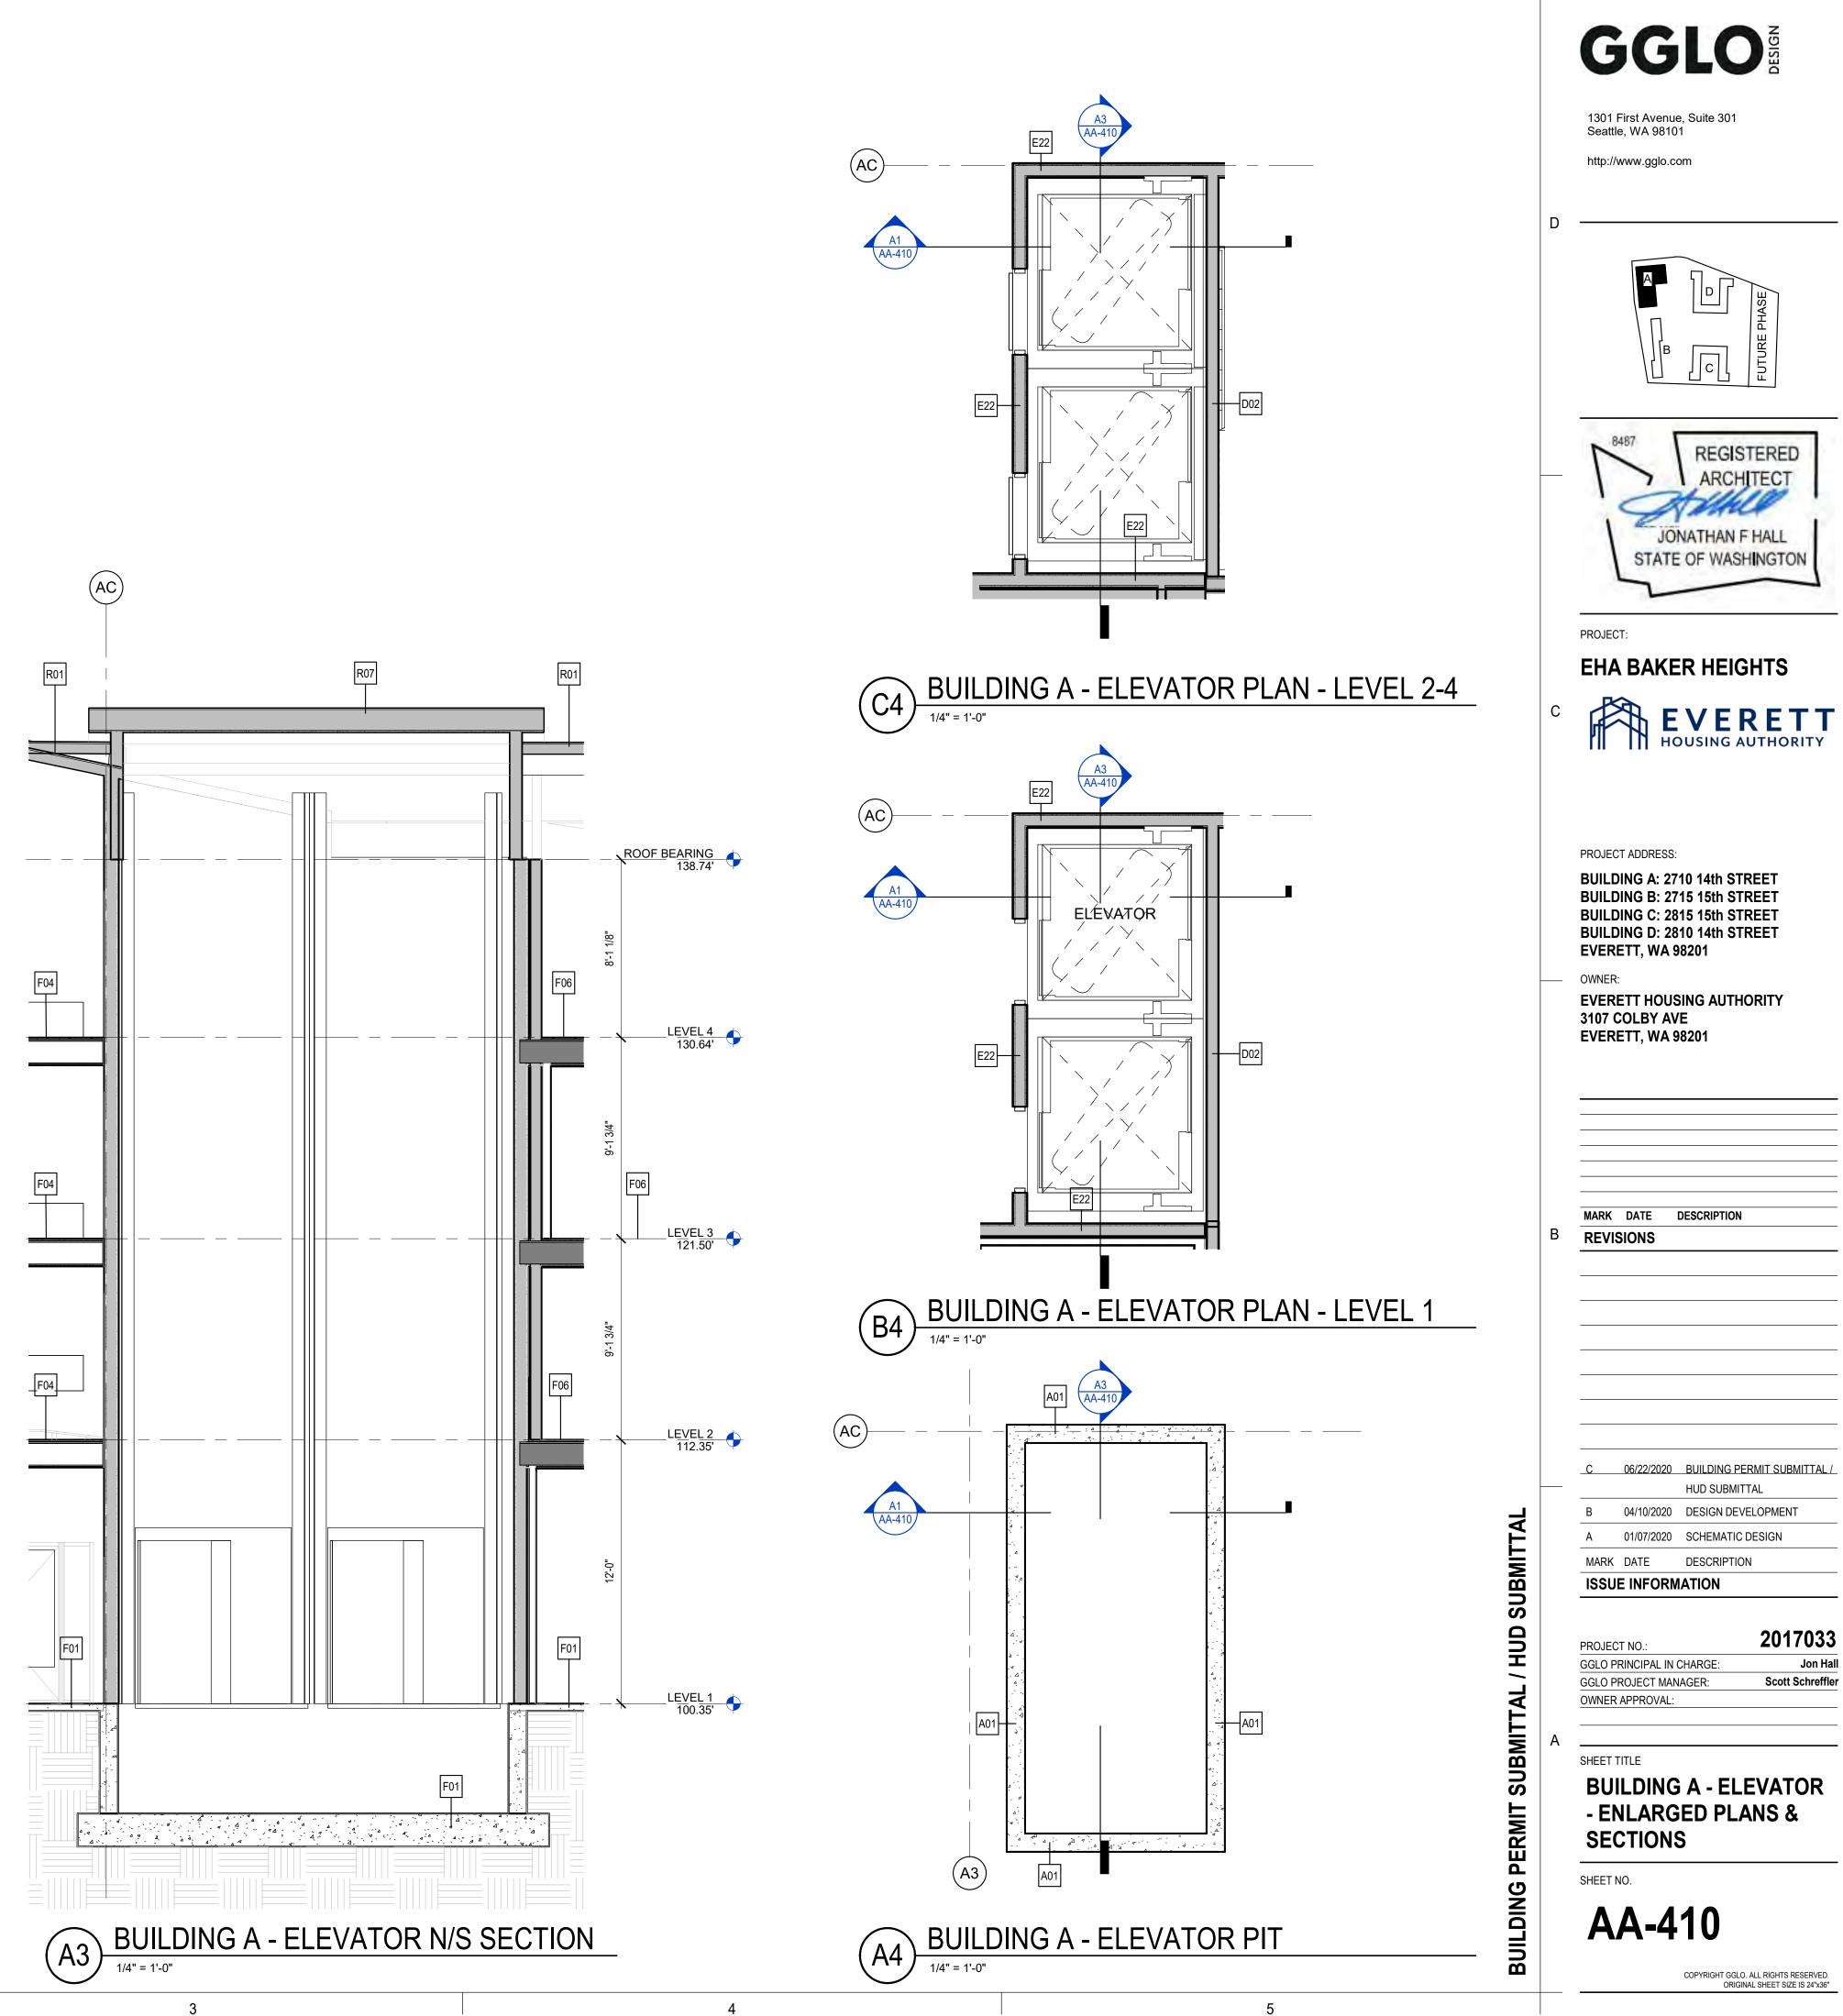
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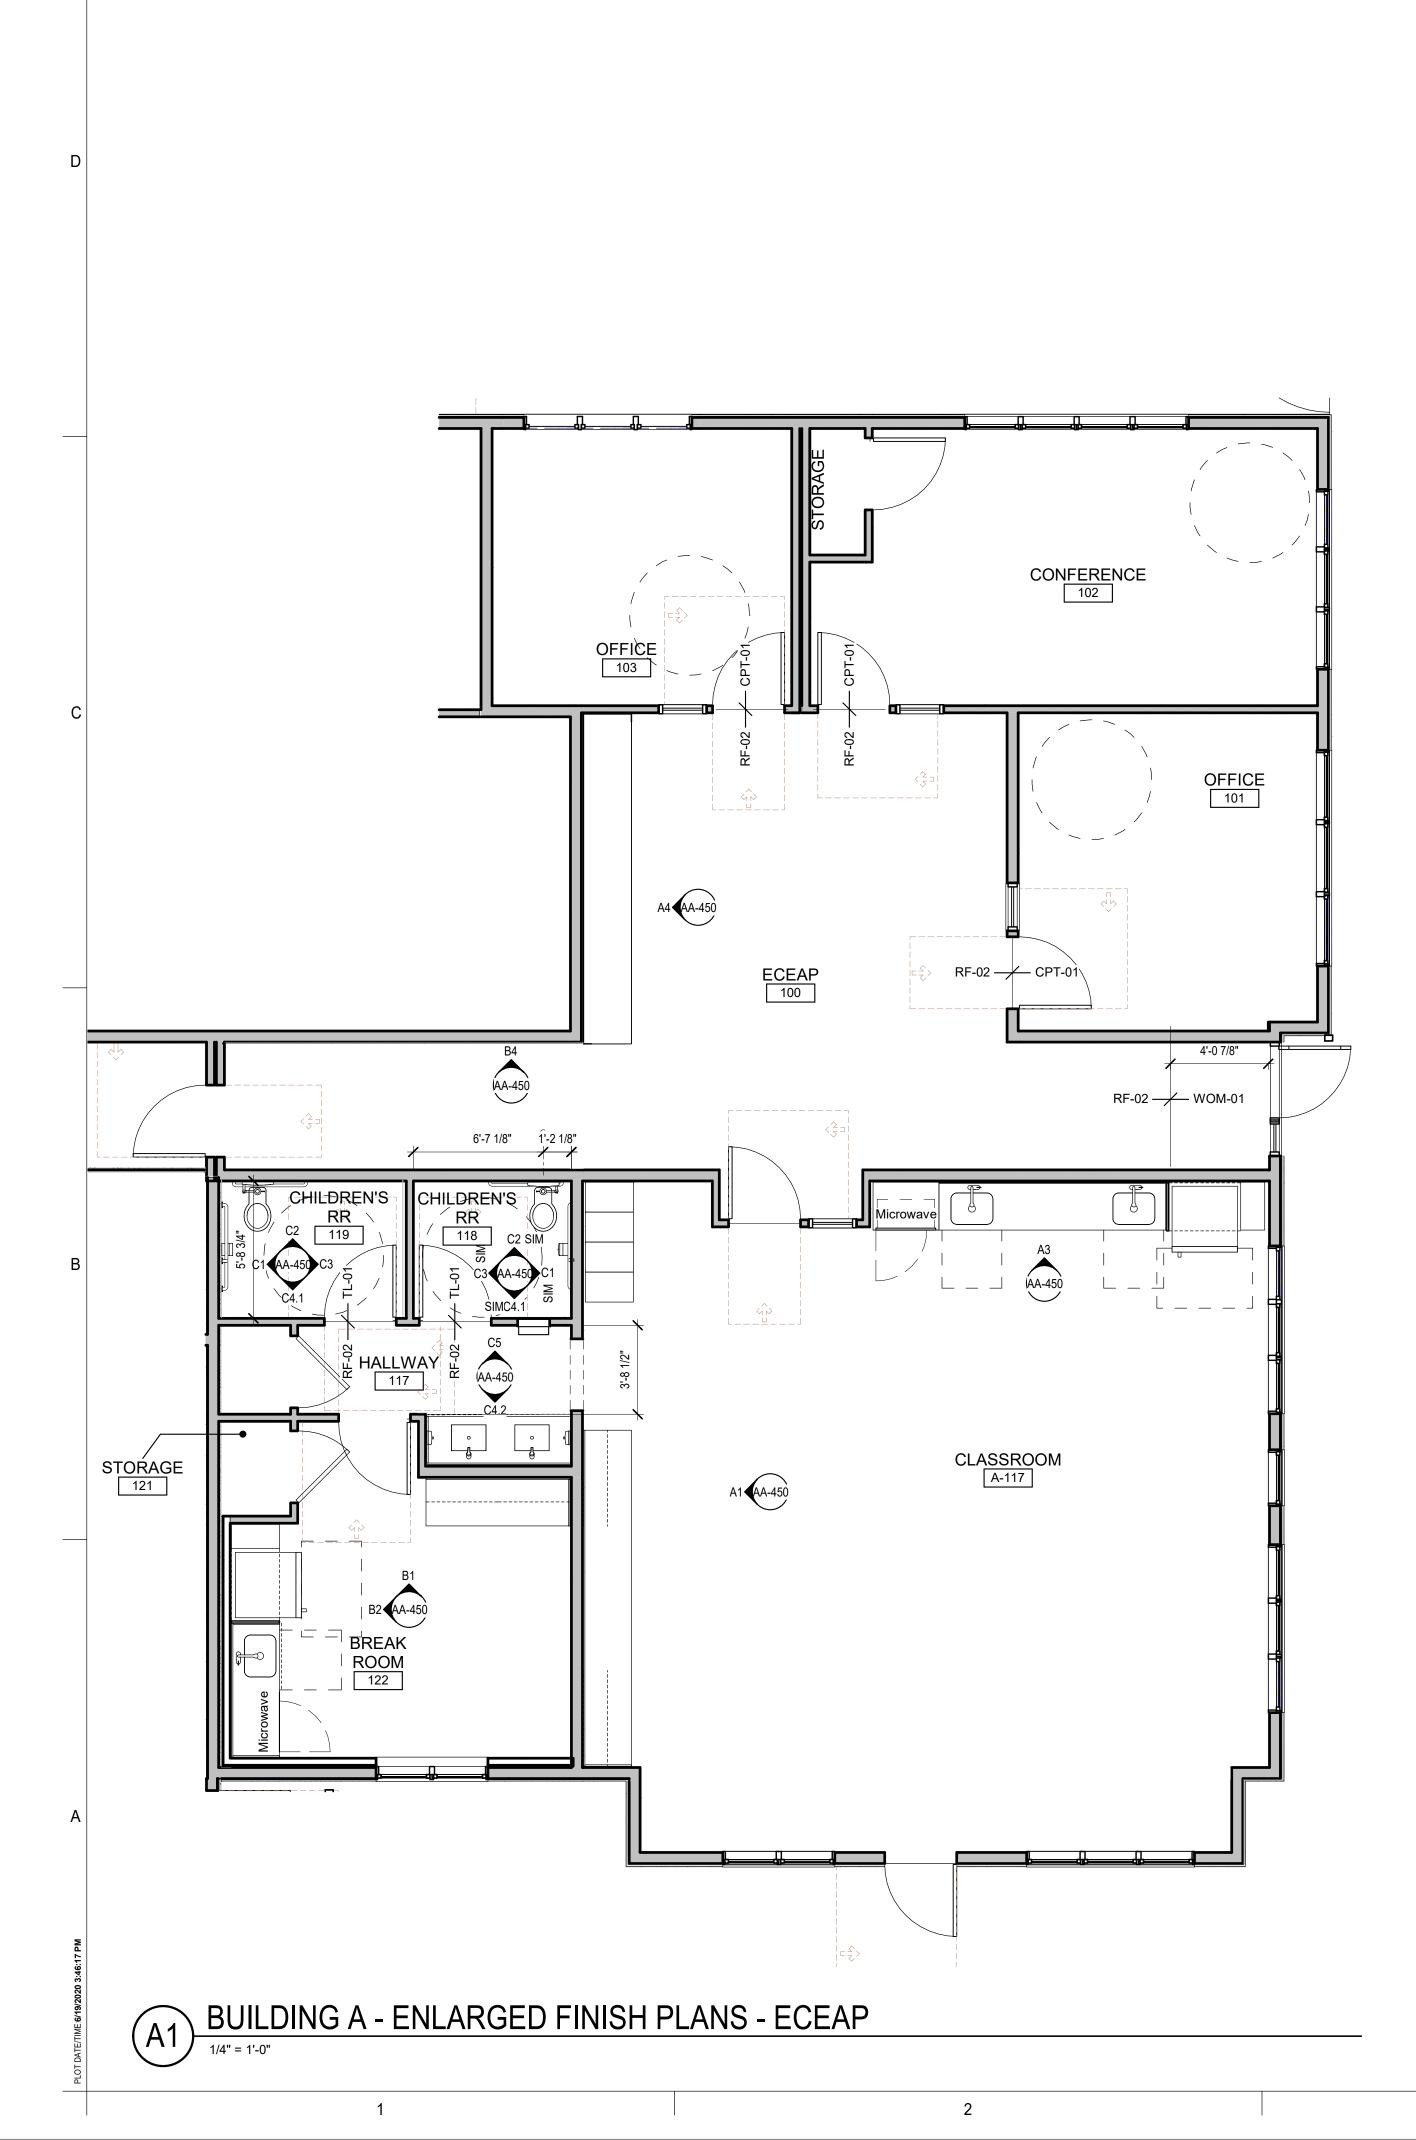
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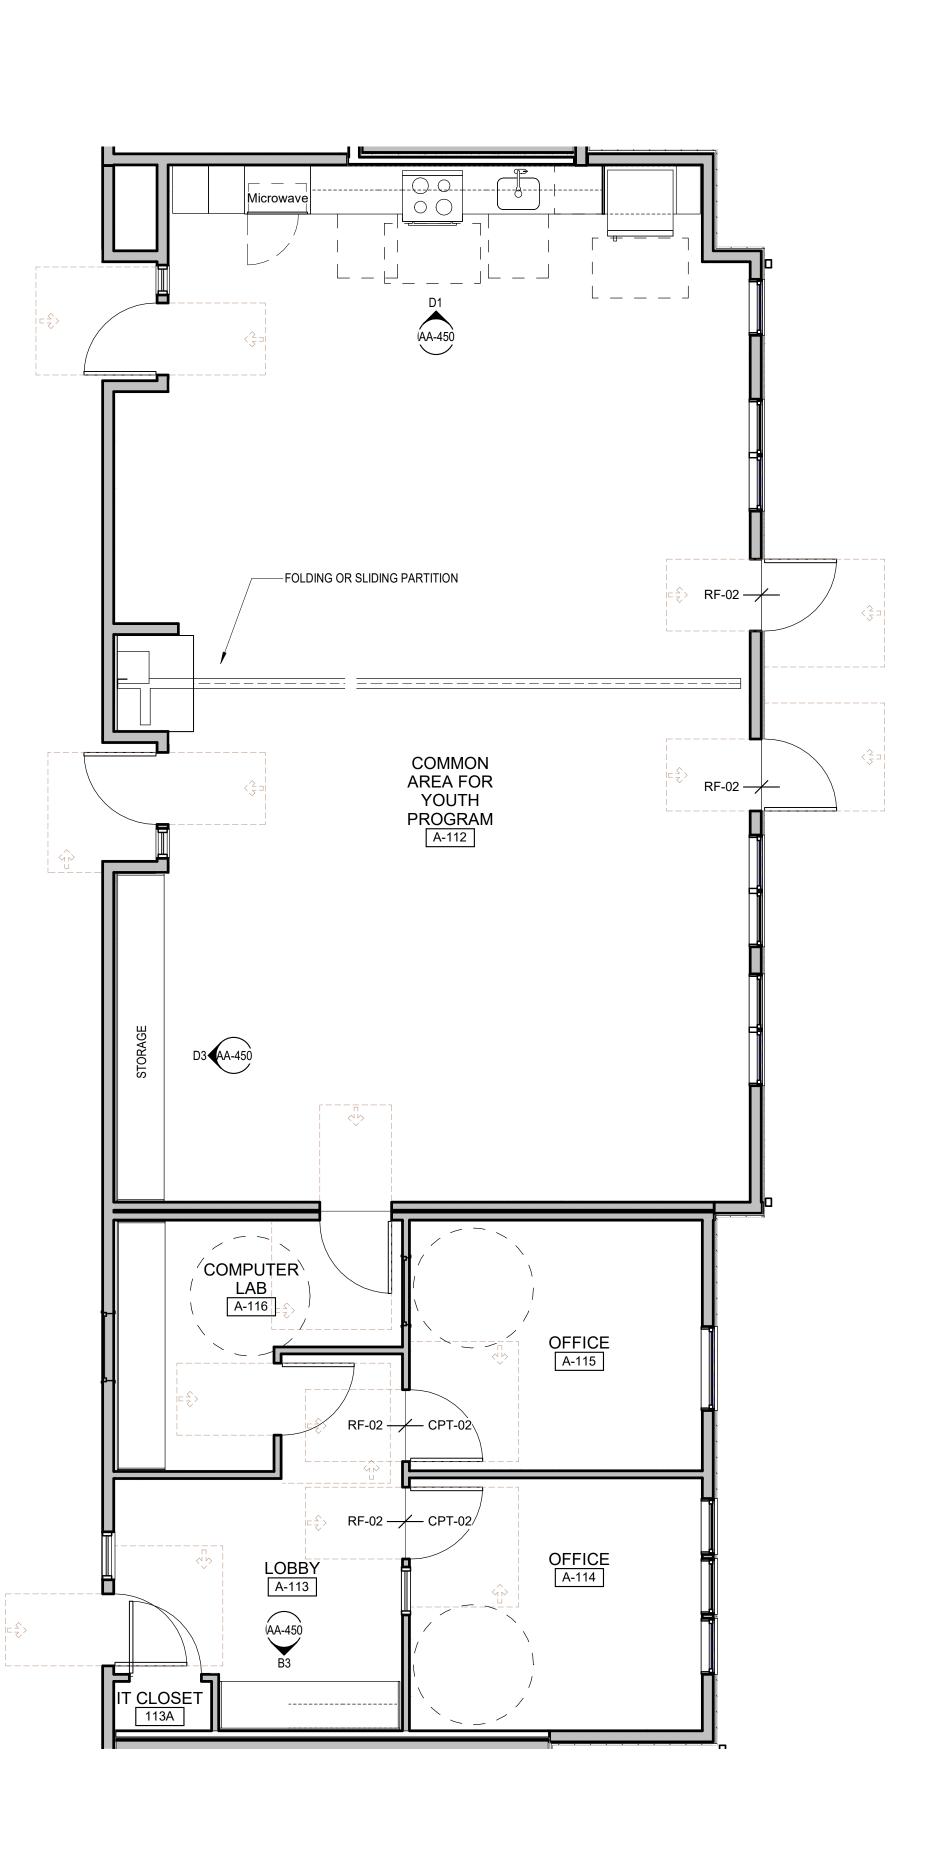
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(A3) BUILDING A - ENLARGED FINISH PLANS - COMMON AREA & OFFICES

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## GENERAL NOTES- FINISH PLAN

1. REFER TO FINISH LEGEND FOR ADDITIONAL INFORMATION 2. INSTALL CORNER GUARD AT ALL EXPOSED CORNERS IN PUBLIC AREAS



1301 First Avenue, Suite 301 Seattle, WA 98101 http://www.gglo.com

	A B C HASE
	REGISTERED ARCHITECT JONATHAN F HALL STATE OF WASHINGTON
	PROJECT: EHA BAKER HEIGHTS
С	EVERET HOUSING AUTHORITY
	PROJECT ADDRESS: BUILDING A: 2710 14th STREET BUILDING B: 2715 15th STREET BUILDING C: 2815 15th STREET BUILDING D: 2810 14th STREET EVERETT, WA 98201 OWNER:
В	MARK DATE DESCRIPTION REVISIONS
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	REVISIONS         C       06/22/2020         BUILDING PERMIT SUBMITTAL         HUD SUBMITTAL         B       04/10/2020         DESIGN DEVELOPMENT         A       01/07/2020         SUBLINFORMATION

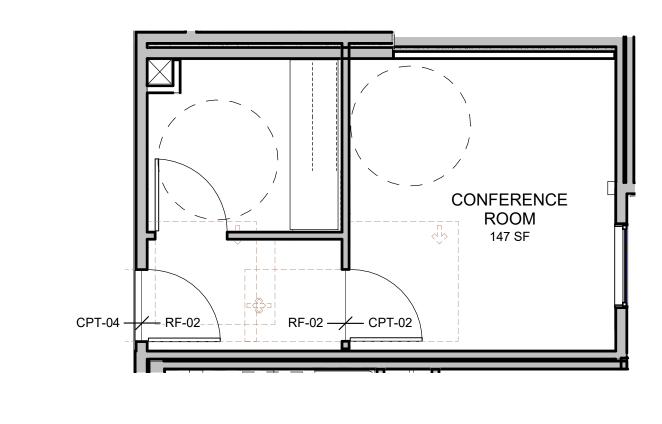
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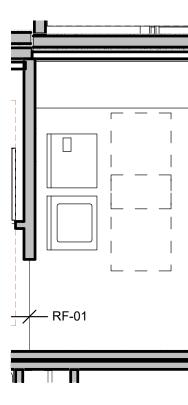
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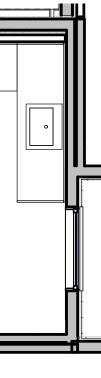
### GENERAL NOTES- FINISH PLAN

1. REFER TO FINISH LEGEND FOR ADDITIONAL INFORMATION 2. INSTALL CORNER GUARD AT ALL EXPOSED CORNERS IN PUBLIC AREAS



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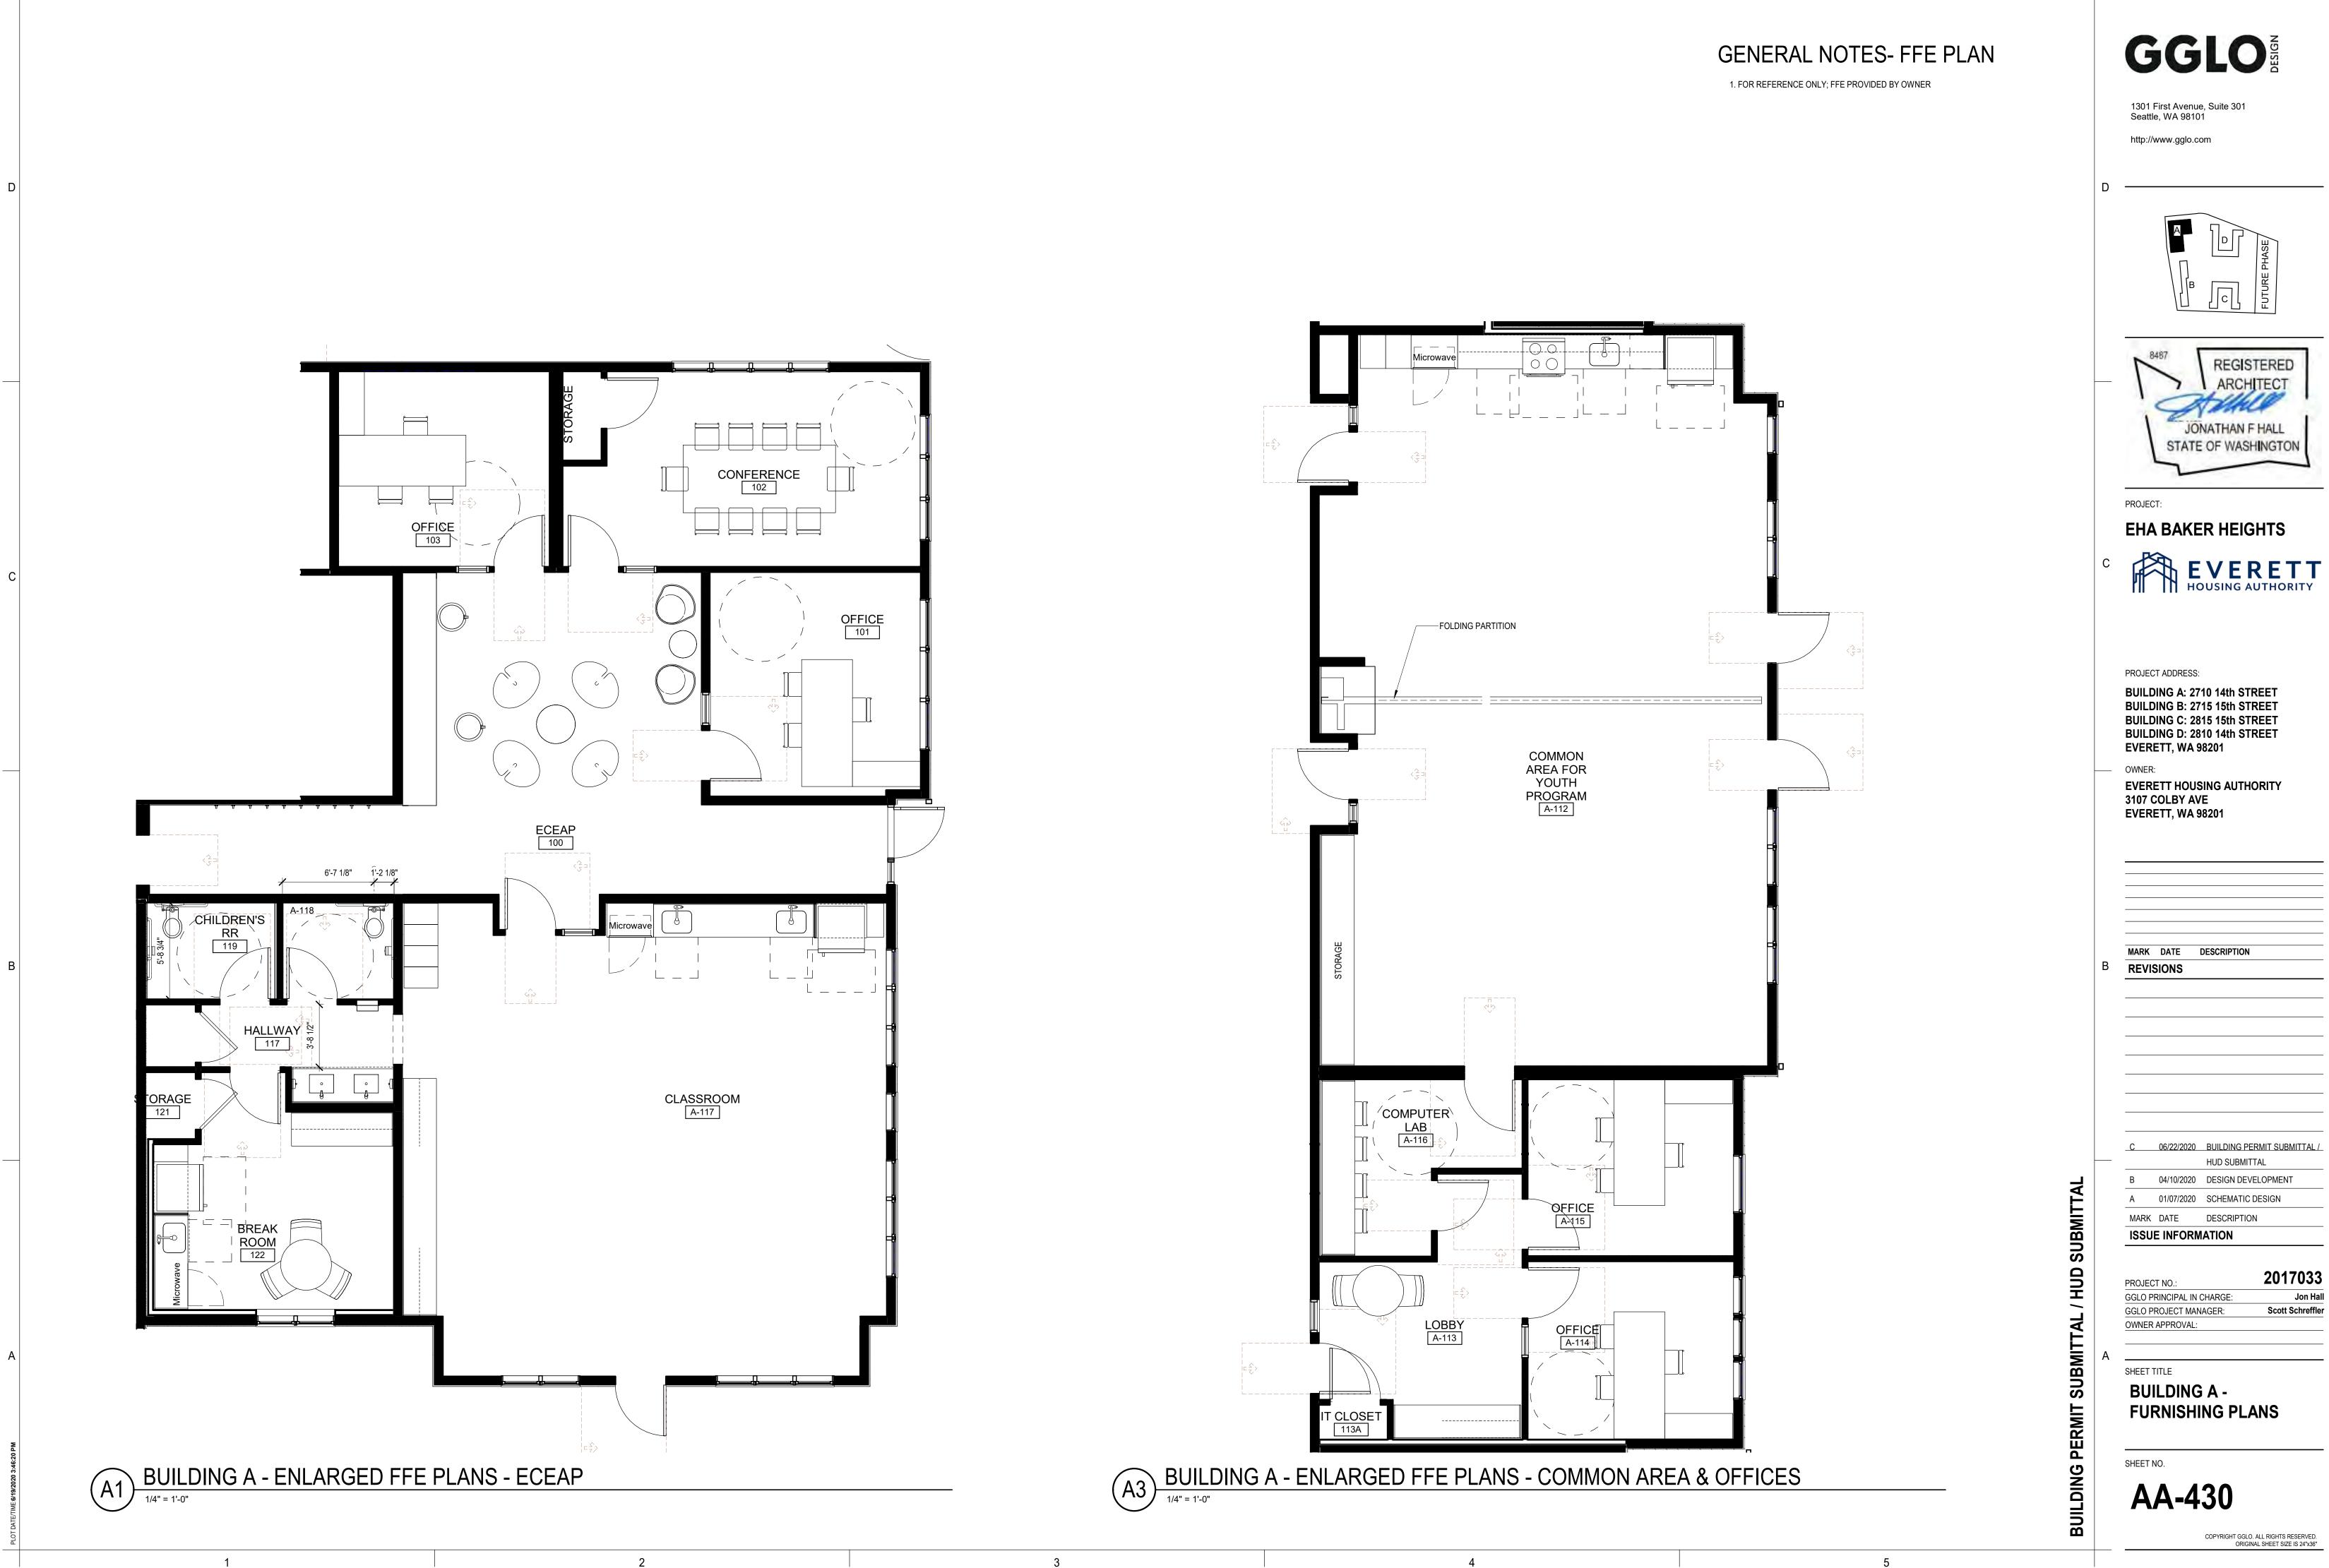
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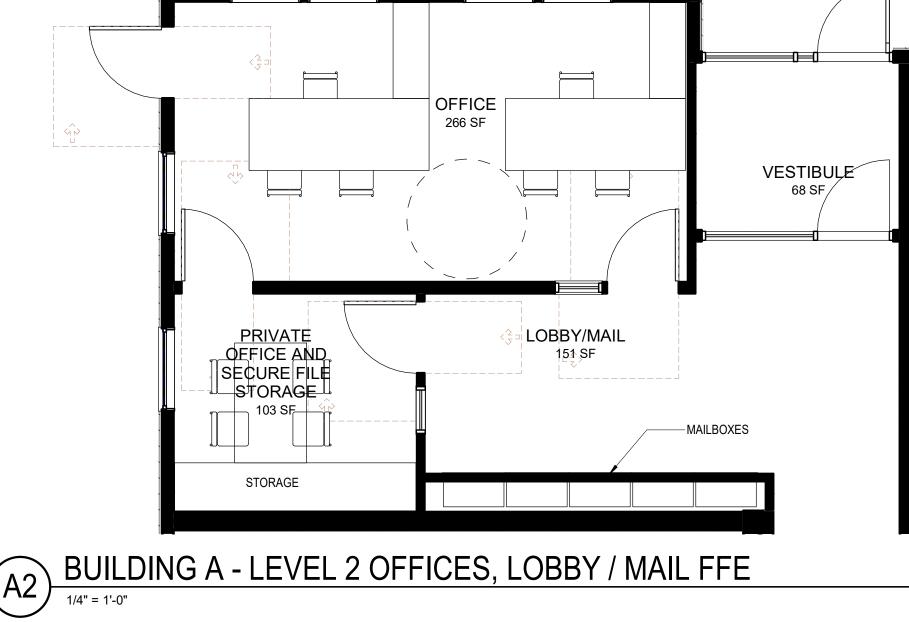
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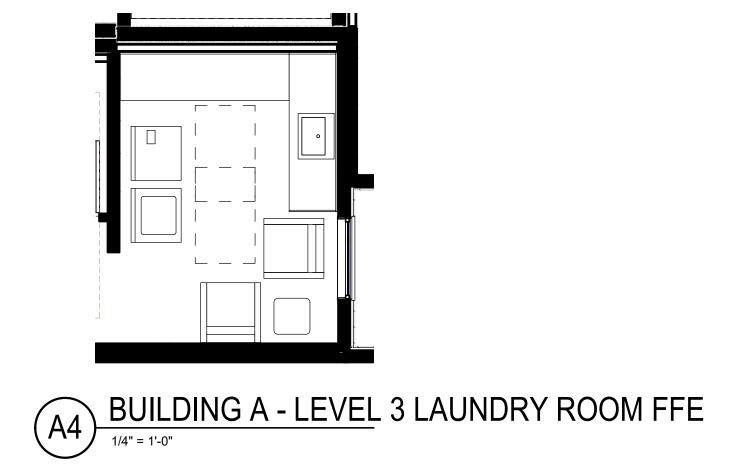


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### GENERAL NOTES- FFE PLAN

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1. FOR REFERENCE ONLY; FFE PROVIDED BY OWNER

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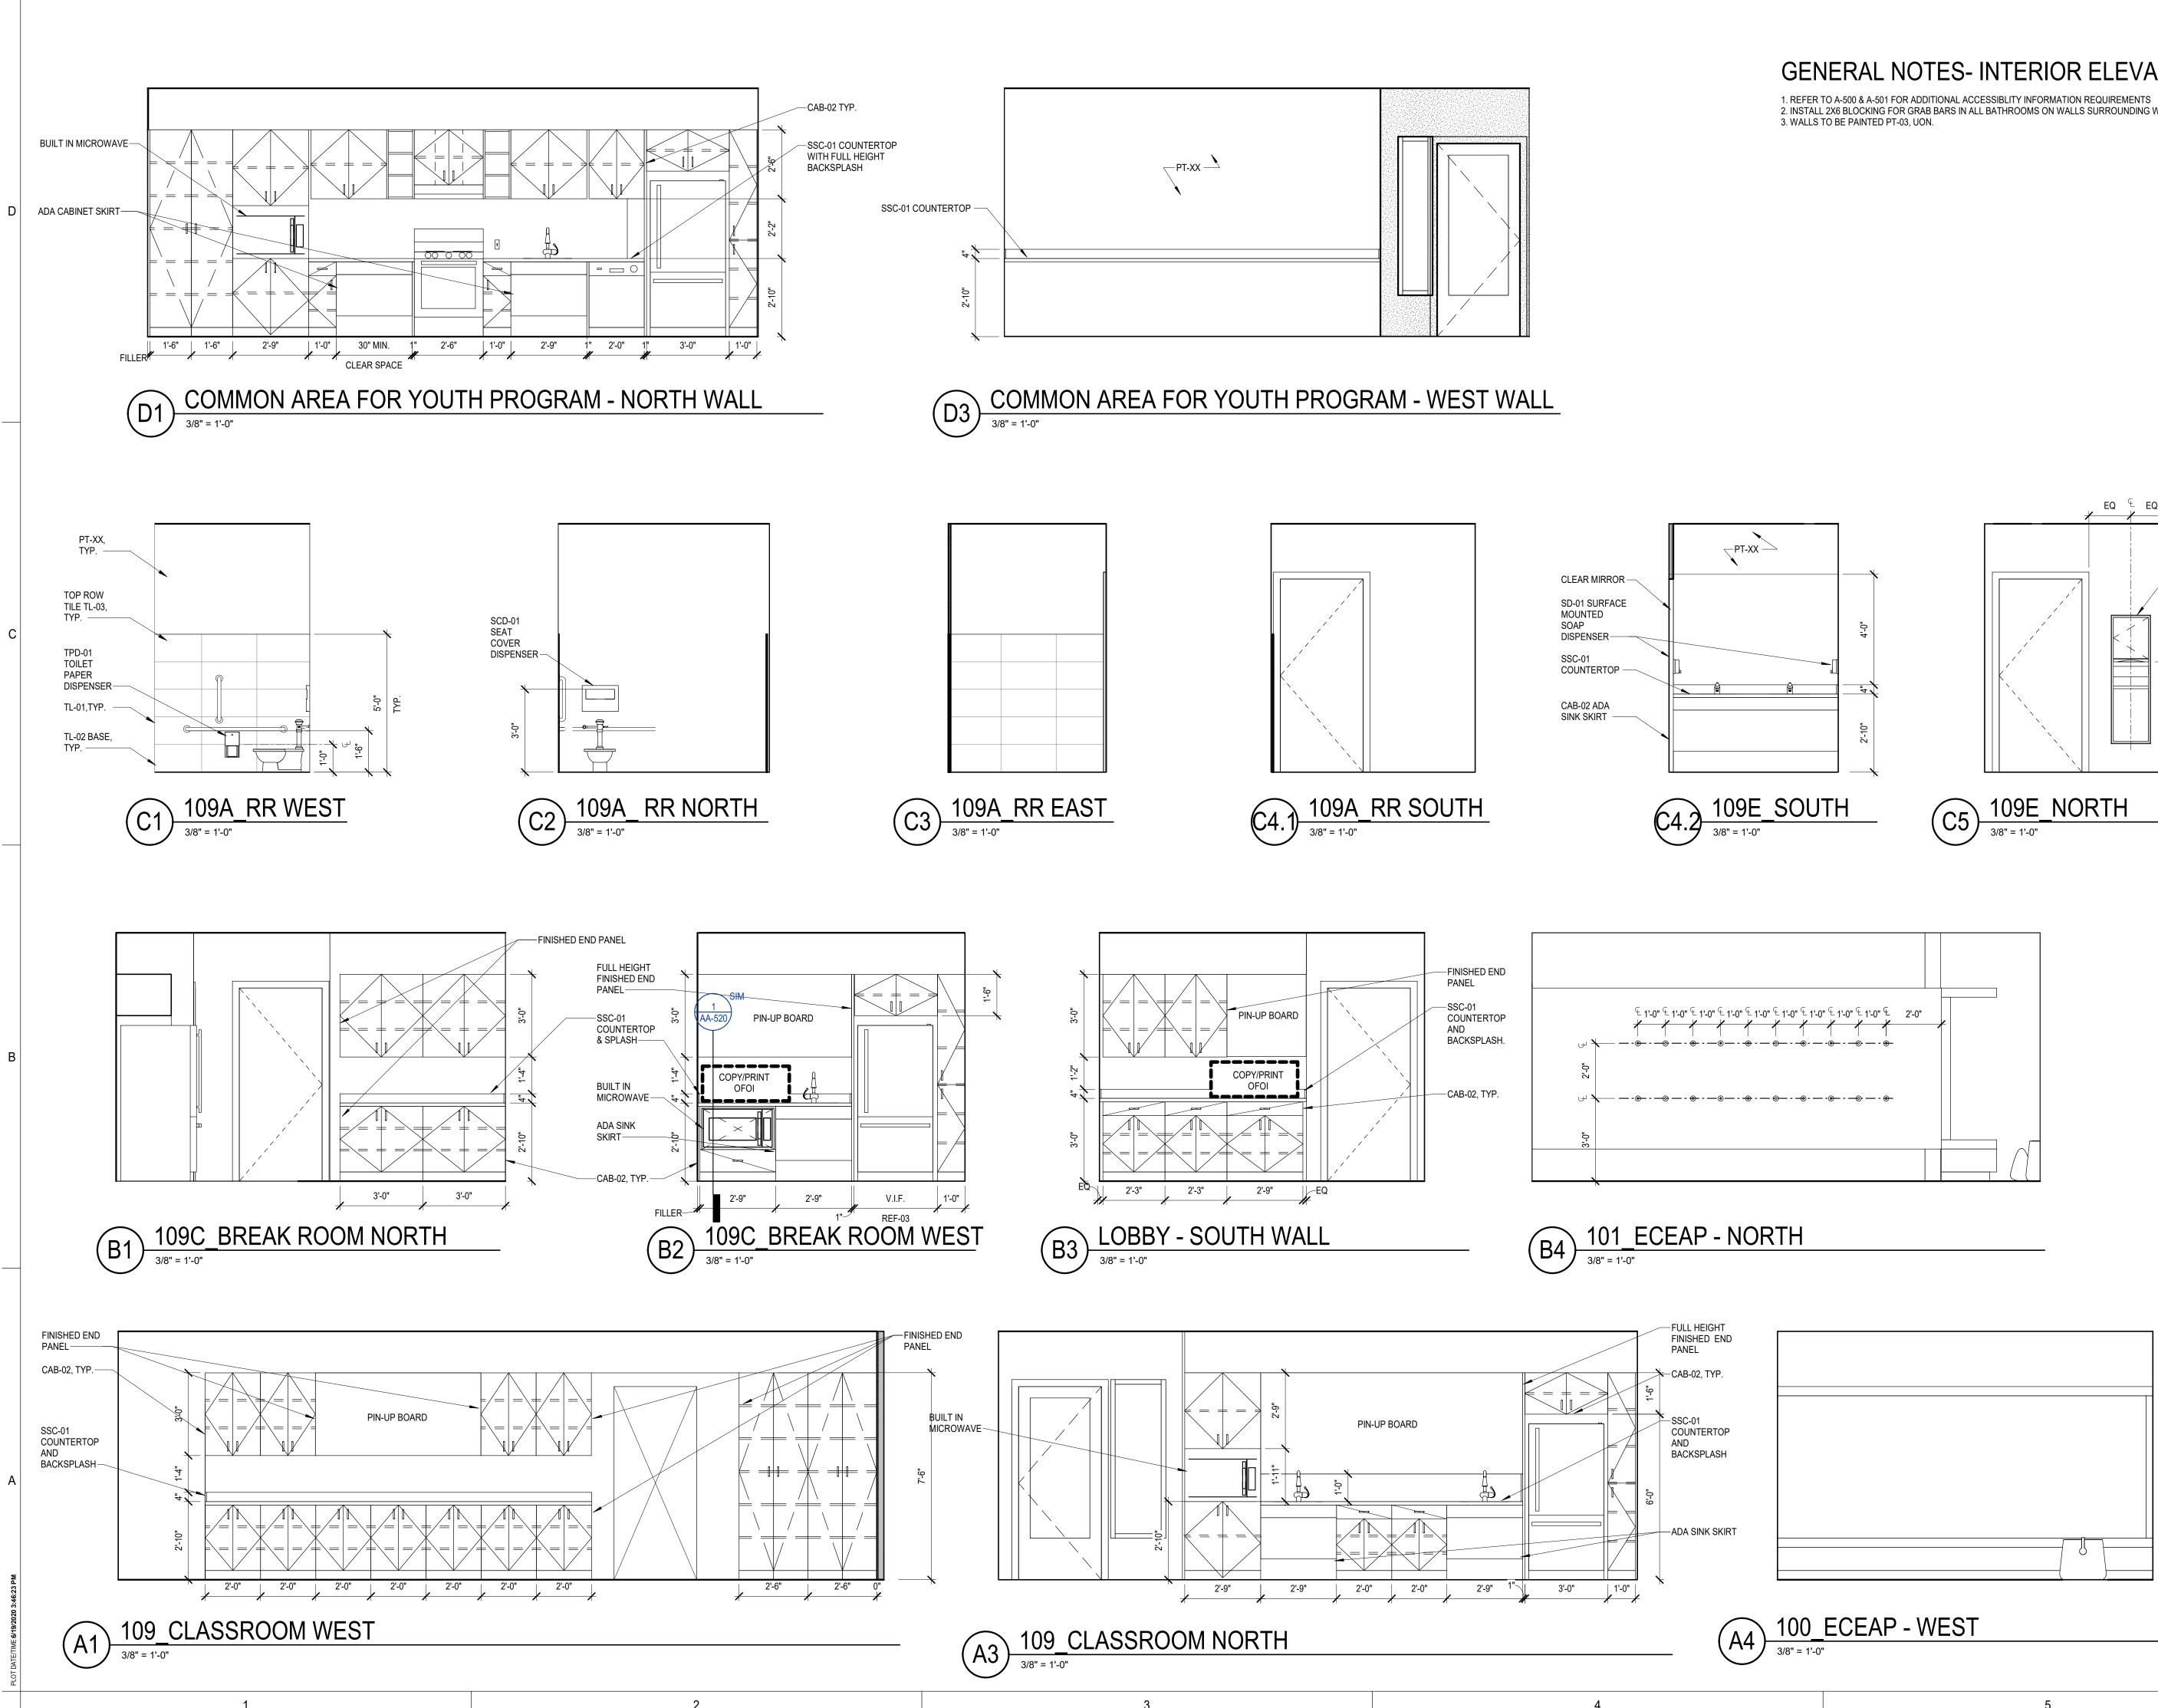


	REGISTERED ARCHITECT
	STATE OF WASHINGTON
	PROJECT: EHA BAKER HEIGHTS
С	<b>EVERETT</b> HOUSING AUTHORITY
	PROJECT ADDRESS: BUILDING A: 2710 14th STREET BUILDING B: 2715 15th STREET BUILDING C: 2815 15th STREET BUILDING D: 2810 14th STREET EVERETT, WA 98201
	OWNER: EVERETT HOUSING AUTHORITY 3107 COLBY AVE
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	REVISIONS         C       06/22/2020         B       04/10/2020         DESIGN DEVELOPMENT         A       01/07/2020         SCHEMATIC DESIGN         MARK       DATE         DESCRIPTION         ISSUE INFORMATION         PROJECT NO.:       2017033         GGLO PRINCIPAL IN CHARGE:       Jon Hall         GGLO PROJECT MANAGER:       Scott Schreffler         OWNER APPROVAL:       SHEET TITLE         BUILDING A - FURNISHING PLANS
	REVISIONS

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HUD SUBMIT **SUBMI BUILDING PERMIT** 

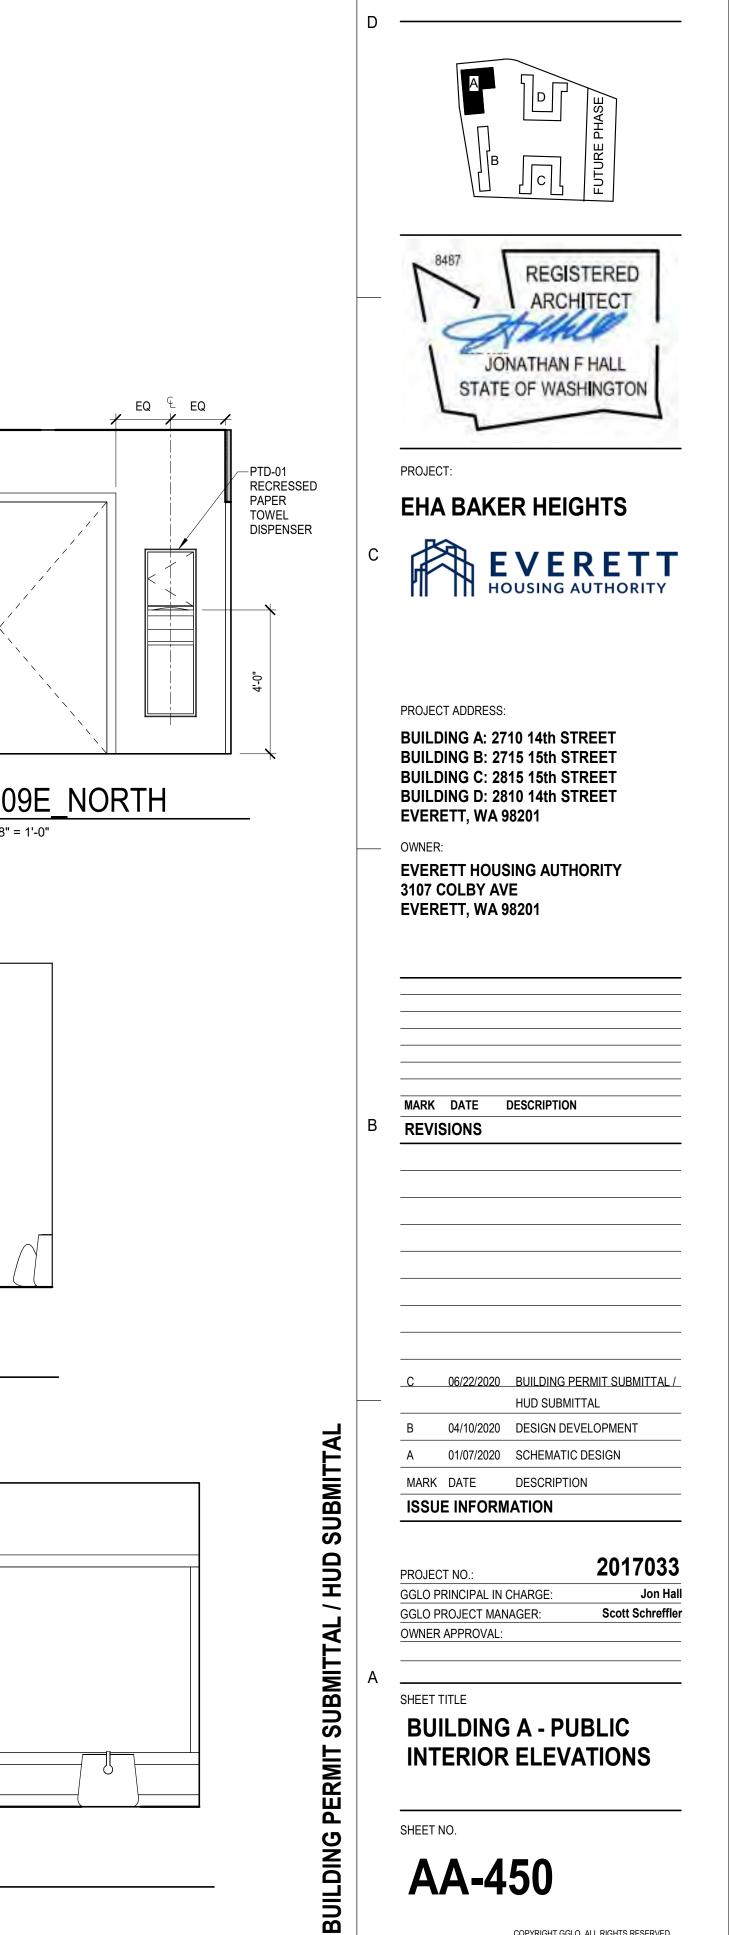
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## **GENERAL NOTES- INTERIOR ELEVATIONS**

2. INSTALL 2X6 BLOCKING FOR GRAB BARS IN ALL BATHROOMS ON WALLS SURROUNDING WATER CLOSETS

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ORIGINAL SHEET SIZE IS 24"x36"

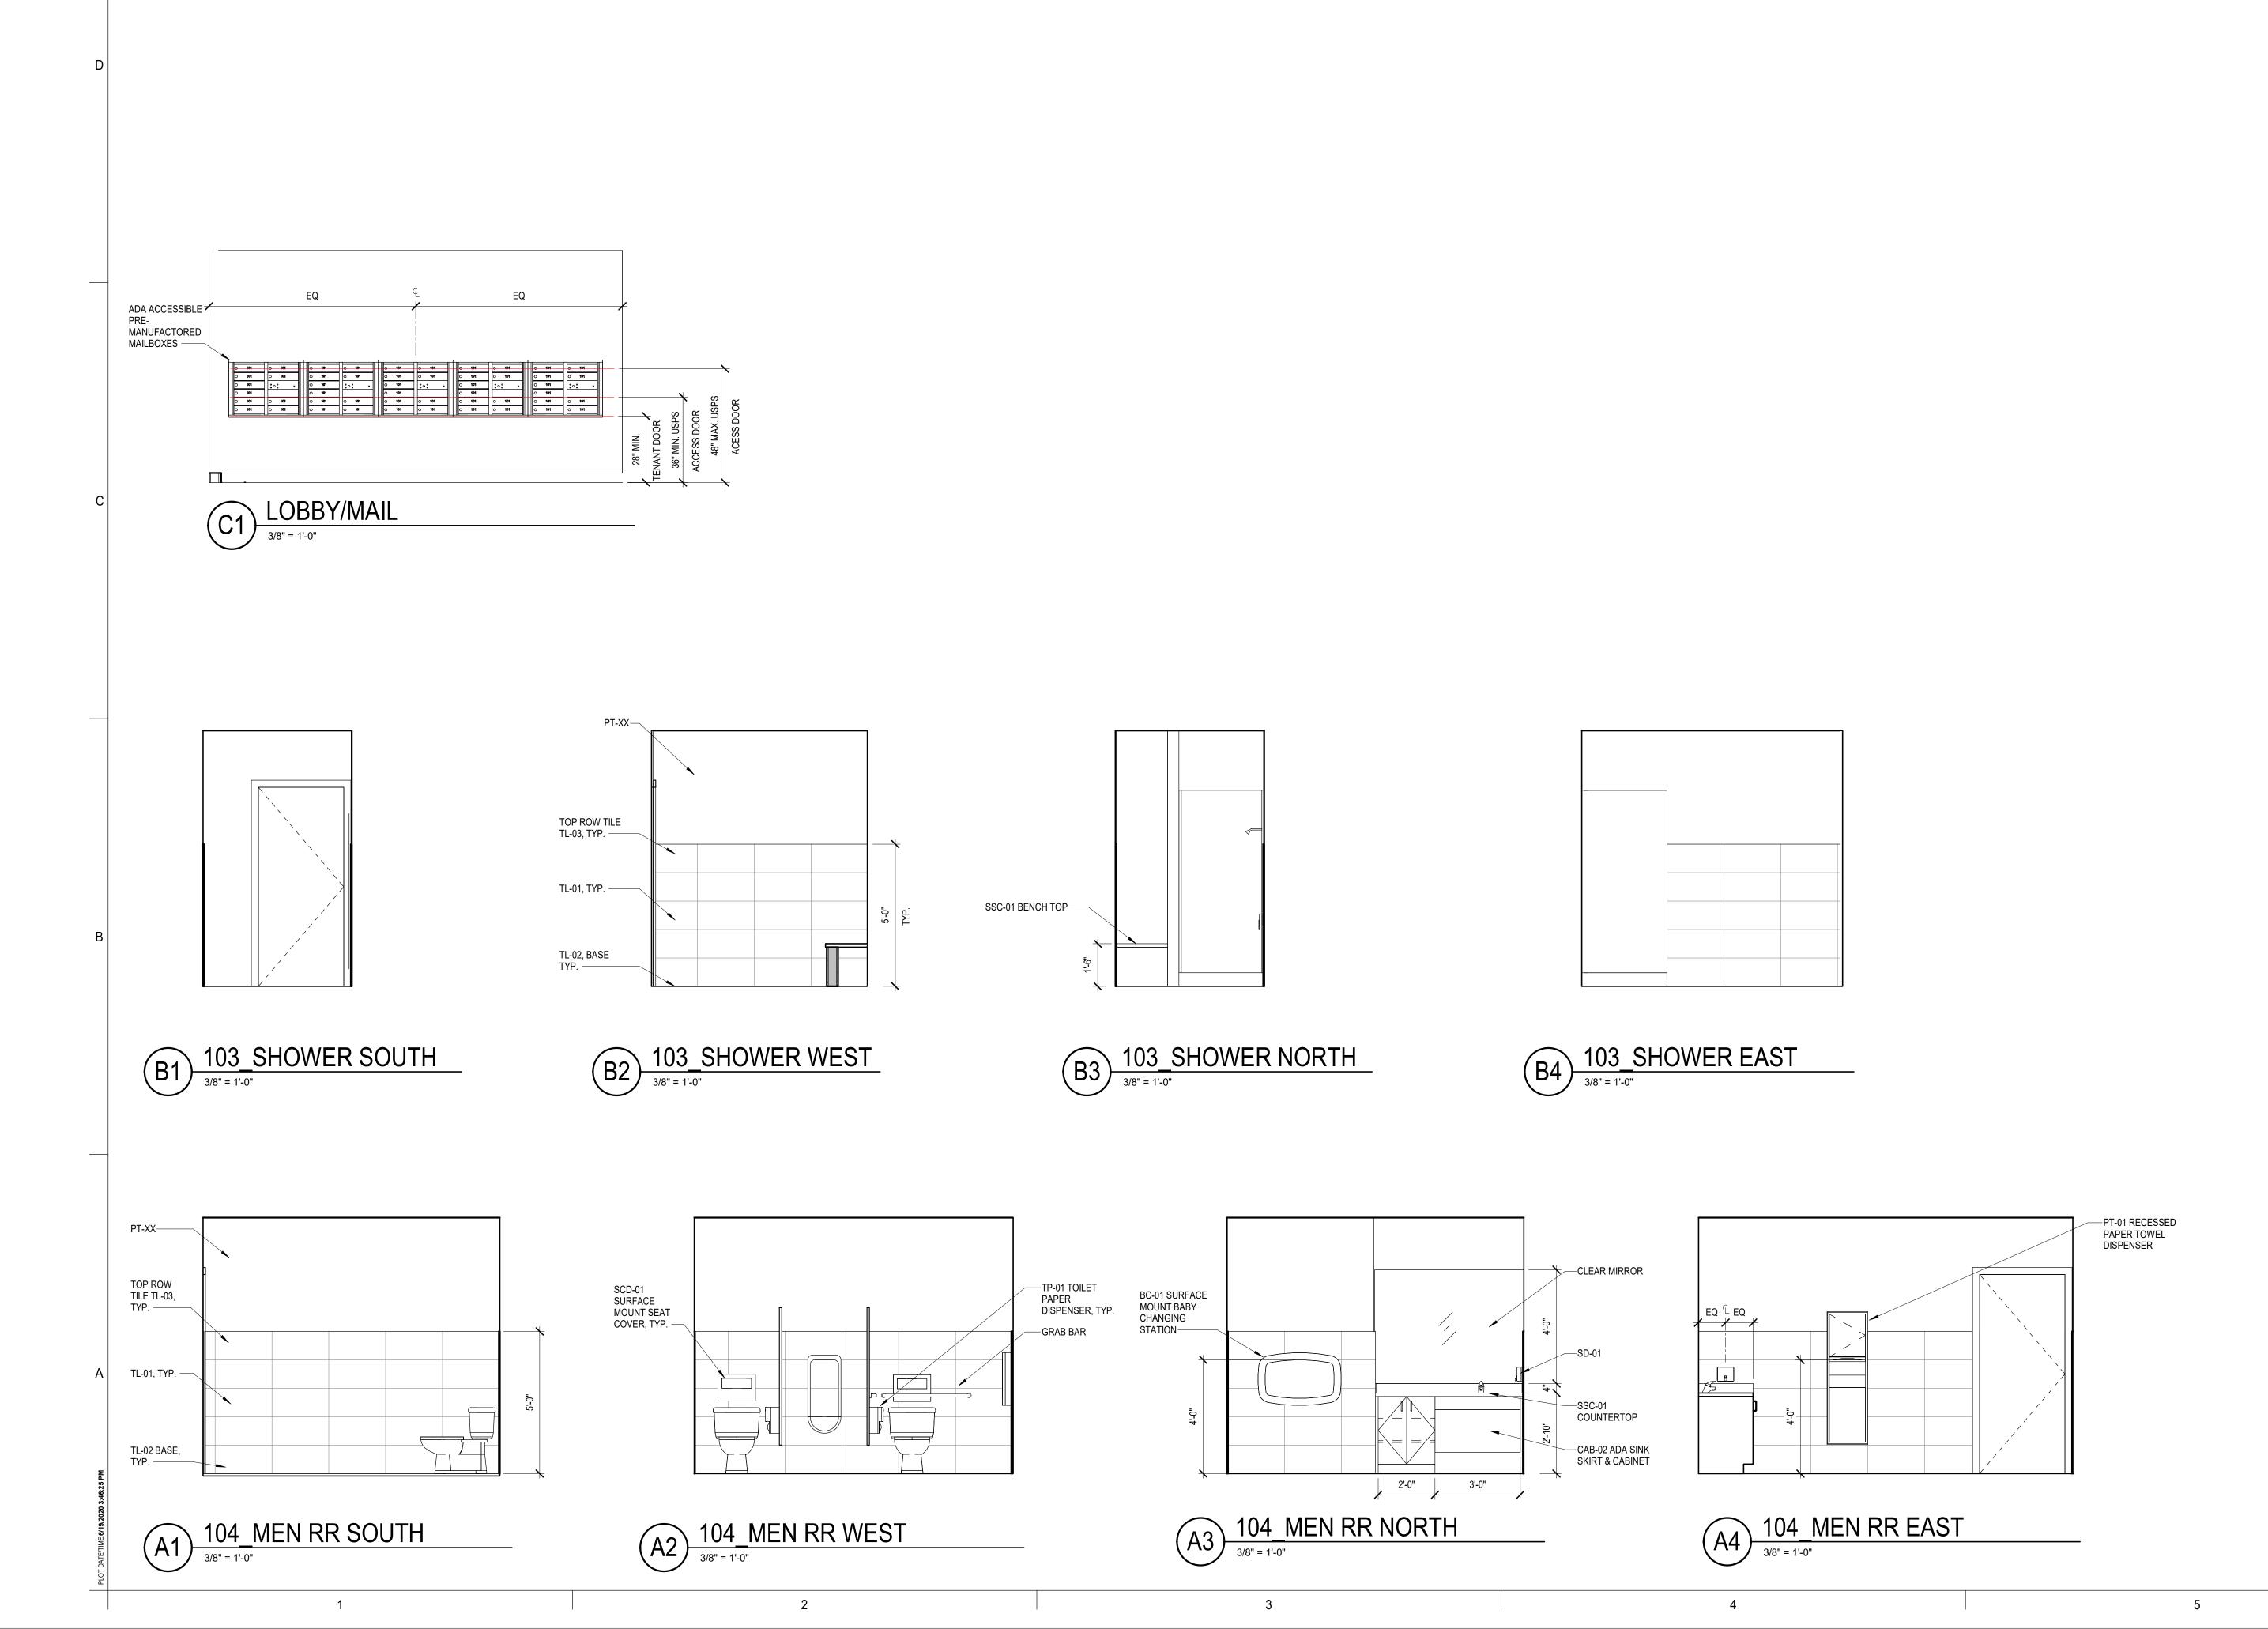
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## **GENERAL NOTES- INTERIOR ELEVATIONS**

1. REFER TO A-500 & A-501 FOR ADDITIONAL ACCESSIBLITY INFORMATION REQUIREMENTS 2. INSTALL 2X6 BLOCKING FOR GRAB BARS IN ALL BATHROOMS ON WALLS SURROUNDING WATER CLOSETS 3. WALLS TO BE PAINTED PT-03, UON.



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		JONATHAN F HALL STATE OF WASHINGTON
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		PROJECT: EHA BAKER HEIGHTS
	С	<b>EVERETT</b> HOUSING AUTHORITY
		PROJECT ADDRESS: BUILDING A: 2710 14th STREET
		BUILDING B: 2715 15th STREET BUILDING C: 2815 15th STREET BUILDING D: 2810 14th STREET
		EVERETT, WA 98201 OWNER: EVERETT HOUSING AUTHORITY
		3107 COLBY AVE EVERETT, WA 98201
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ID SUB		ISSUE INFORMATION 2017033
AL / HL		PROJECT NO.:     ZOTTOJO       GGLO PRINCIPAL IN CHARGE:     Jon Hall       GGLO PROJECT MANAGER:     Scott Schreffler       OWNER APPROVAL:     Vertical Science
RMIT SUBMITTAL / HUD SUBMITTAL	A	SHEET TITLE
MIT SU		BUILDING A - PUBLIC INTERIOR ELEVATION
<b>BUILDING PERI</b>		SHEET NO.
LDIN		AA-451
Б		

MARK	ТҮРЕ	LOCATION (GENERAL)	MANUFACTURER	PRODUCT NAME	COLOR NAME	FINISH	SIZE	NOTES / PRODUCT REPRESENTATIVE							
APC-01	ACOUSTIC PANEL CEILING														
CAB-02	CABINETRY	PUBLIC	CERO WORKS	FRAMELESS FLAT FRONT BIRCH PLYWOOD CUSTOM CASEWORK		HYDRO-PURE CLEAR FINISH GEMINI LACQUER		AMY DEL OLMO amy@creoworks.com 206.922.8007							
CG-01	CORNER GUARD	ALL PUBLIC CORNERS	KOROSEAL	F SERIES		TBD	CORNER WING LENGTH: 1.	5"							
CPT-01	CARPET	ECEAP OFFICE	SHAW CONTRACT	OBSERVE COLOR TILE 5T309	MOUNTAIN LAKE 05327	= -	PLANK: 9" X 36"	MATT CHAMBERS: matt.chambers@shawcontract.com 206 499 8847							
CPT-02	CARPET	OFFICES	SHAW CONTRACT	OBSERVE TILE 5T306	FRAGILE 05760		PLANK: 9" X 36"	MATT CHAMBERS: matt.chambers@shawcontract.com 206 499 8847							
CPT-03	CARPET	OFFICES	SHAW CONTRACT	OBSERVE TILE 5T306	WILD 05557		PLANK: 9" X 36"	MATT CHAMBERS: matt.chambers@shawcontract.com 206 499 8847							
CPT-04	CARPET	CORRIDORS	SHAW CONTRACT	PAVERS II TILE 5T201	STONE 98595		PLANK: 9" X 36"	MATT CHAMBERS: matt.chambers@shawcontract.com 206 499 8847							
AB-01	FABRIC	ECEAP	ARCHITEX	ULTRAPOSH	ISLE		54"W NO REPEAT	STEPHANIE DESHAIES stephaniedeshaies@architex-ljh.com 206.383.7215							
IDW-02	HARDWARE	PUBLIC													
PT-03	PAINT	TYPICAL WALLS & CEILING, UNO	SHERWIN WILLIAMS		SW2844 ROYCROFT MIST	SATIN									
PT-04	PAINT	ECEAP LOBBY WALL ACCENT	SHERWIN WILLIAMS		GRAY SW6193 PRIVILEGE	SATIN									
PT-05	PAINT	ECEAP BATHROOMS ACCENT	SHERWIN WILLIAMS		GREEN SW7741 WILLOW TREE	V SATIN									
PT-06	PAINT	CASEWORK LOBBY ACCENT	SHERWIN		SW0012 EMPIRE	SATIN									
PT-07	PAINT	CASEWORK OFFICES	SHERWIN		SW0045	SATIN									
PT-08	PAINT	SUPPORT OFFICES	SHERWIN		ANTIQUARIAN BROWN SW6054	SATIN									
PT-09	PAINT	ACCENT	WILLIAMS		CANYON CLAY	SATIN									
		RECESS	WILLIAMS		OLIVE										
PT-10	PAINT	CORRIDOR ENTY WOOD TRIM	SHERWIN WILLIAMS		SW 7069 IRON ORE	SATIN									
RB-01	RUBBER BASE	ALL PUBLIC SPACES	JOHNSONITE	DURACOVE	TBD		6" HIGH								
RF-01	RUBBER FLOORING	ELEVATOR CAB FLOOF	2												
RF-02	RESILIENT FLOORIN	G ECEAP/ ELEVATOR LANDINGS	FORBO	TI9103		-	THICKNESS: .1" LENGTH: 3 WIDTH: 9.8"	9.4"	FINISH	LEGEND: RES	DENTIAL UNIT	S - SCHEME	Ā		
SSC-01	SOLID SURFACE COUNTERTOP	ECEAP	PENTAL GRANITE AND MARBLE	PENTAL QUARTZ	BQ201P CASCADE	-	THICKNESS: 2CM	FLAT POLISHED EDGE	MARK	ТҮРЕ	LOCATION (GENERAL)	MANUFACTURER	PRODUCT NAME /	COLOR NAME /	FINISH
ST-01	STAIN	UNIT ENTY DOORS	CUSTOM TO MATCH DESIGNERS		WHITE JAVA ON BEACH	I SATIN			CAB-01	CABINETRY	KITCHEN & BATH		FRAMELESS FLAT FRONT DOORS AND DRAWERS WITH PLYWOOD BOXES	SERIA TEAK	THERMAFOIL W
TL-01	TILE	ECEAP	DALTILE		VL70 AMPLIFY BLACK		FIELD TILE 12" X 24"	CHUCK HILL: chuck.hill@daltile.com 206.999.6890	HDW-01	HARDWARE	TYPICAL THROUGHOUT	LANZ CABINETS	SQUARE PULL	SATIN NICKEL	
TL-02	TILE	ECEAP	DALTILE		VL70 AMPLIFY BLACK		COVE BASE TILE: 6" X 12"		PT-01	PAINT	TYPICAL WALL & CEILING	SHERWIN WILLIAMS		SW7009 PEARLY WHITE	SATIN
TL-03	TILE	ECEAP	DALTILE	VOLUME 1.0	VL70 AMPLIFY BLACK		BULLNOSE TILE: 3" X 12"		PT-02	PAINT	TYPICAL TRIM	SHERWIN WILLIAMS		SW7009 PEARLY	SEMI GLOSS
WC-01	BULLETIN BOARD	ECEAP	FORBO	BULLETIN BOARD	2209 BLACK OLIVE		THICKNESS: .25" LENGTH: 9	0'	RF-01	RESILIENT FLOOR	THROUGHOUT	CASCADE LUXURY VINYL	CREATIVE OPTIONS	WHITE ALMOND TOFFEE	
ND-01	WOOD	DOOR TRIM	GC TO SPECIFY		PT-10		4" WIDTH: 48		RF-03	RESILIENT FLOOR	TYPE A BATHROOMS	CASCADE LUXURY VINYL	TBD		
VOM-01	WALK OFF MAT	ENTRY FLOOR/	TANDUS CENTIVA	ABRASIVE ACTION II	TBD				PLM-01	PLASTIC LAMINATE	KITCHEN & BATH COUNTER	WILSON ART		SLATE GREY	Y 60 MATTE FINIS
	1	VESTIBULES				1									1

				1301 First Avenue, Suite 301 Seattle, WA 98101 http://www.gglo.com
				Image: Weight of the second
				PROJECT: EHA BAKER HEIGHTS
			C	HOUSING AUTHORITY
				PROJECT ADDRESS: BUILDING A: 2710 14th STREET BUILDING B: 2715 15th STREET BUILDING C: 2815 15th STREET BUILDING D: 2810 14th STREET EVERETT, WA 98201 OWNER: EVERETT HOUSING AUTHORITY 3107 COLBY AVE EVERETT, WA 98201
			В	MARK DATE DESCRIPTION REVISIONS
				C 06/22/2020 BUILDING PERMIT SUBMITTAL / HUD SUBMITTAL B 04/10/2020 DESIGN DEVELOPMENT
FINISH	SIZE	NOTES / PRODUCT REPRESENTATIVE		A 01/07/2020 SCHEMATIC DESIGN
MAFOIL WITH OOD BOXES	PER ELEVATIONS	JULIE GREEN JulieGreen@lanzcabinets.com (541) 485 ext 257	-4050	MARK DATE DESCRIPTION
GLOSS	96MM	JULIE GREEN JulieGreen@lanzcabinets.com (541) 485 ext 257		PROJECT NO.: 2017033 GGLO PRINCIPAL IN CHARGE: Jon Hall GGLO PROJECT MANAGER: Scott Schreffler OWNER APPROVAL:
	9" X 48" PLANK X 5MM THICK	MAXWELL LARKIN maxwell.larkin@wanke.com	T SUBMITTAL	SHEET TITLE BUILDING A - INTERIOR
TTE FINISH			BUILDING PERMIT	FINISH LEGENDS
			BUILDIN	<b>AA-630</b> COPYRIGHT GGLO. ALL RIGHTS RESERVED.

RIGHT GGLO. ALL RIGHTS RESERVED. ORIGINAL SHEET SIZE IS 24"x36"

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**BATH ACCESSORIES LEGEND: PUBLIC SPACES** 

MARK	ТҮРЕ	LOCATION (GENERAL)	MANUFACTURER	PRODUCT NAME /	COLOR NAME /	FINISH	SIZE
BC-01	BABY CHANGING STATION	PUBLIC RESTROOMS	KOALA KARE	KB200	01 GREY		35 3/16"W X 4"D X 22 1/4"H
PT-01	PAPER TOWEL DISPENSER	PUBLIC RESTROOMS	BOBRICK	B-3944	STAINLESS STEEL		
RB HK-02	CLOTHES HOOK	PUBLIC RESTROOMS	BOBRICK	B-233	STAINLESS STEEL		
SCD-01	SEAT COVER DISPENSER	PUBLIC RESTROOMS	BOBRICK	B-4221	STAINLESS STEEL		15 3/4"W X 2 3/16"D X 11 1/4"H
SD-01	SOAP DISPENSER	PUBLIC RESTROOMS	BOBRICK	B-4112	STAINLESS STEEL		7"W X 3 5/16" D X 6 1/8" H
SND-01	SANITARY NAPKIN DISPOSAL	PABLIC RESTROOMS	BOBRICK	B-270	STAINLESS STEEL		7 1/2"W X 3 13/16" D X 10"H
TPD-01	TOILET PAPER DISPENSER - SINGLE	PUBLIC RESTROOMS	BOBRICK	B-4288	STAINLESS STEEL		6 1/16" W X 5 15/16" D X 11"H
TLP-01	TOILET PARTITION	PUBLIC RESTROOMS	BOBRICK	1541 FLOOR ANCHORED	HIGH PRESSURE LAMINATE BLACK 1595-60		

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APPLIA	NCE LEGEND	PUBLIC SPACE	ES					APPLIA	NCE LEGEND	: RESIDEN	TIAL UNITS - TY	P ALL UNITS		
MARK	ТҮРЕ	LOCATION (GENERAL)	MANUFACTURER	PRODUCT NAME / MODEL NUMBER	FINISH	SIZE	NOTES / PRODUCT REPRESENTATIVE	MARK	ТҮРЕ	LOCATION (GE		PRODUCT NAME / MODEL NUMBER	FINISH	SIZ
DW-03	DISHWASHER	PUBLIC	GE	GDT226SSLSS ADA COMPLIANT STAINLESS STEEL INTERIOR	STAINLESS STEEL	32 1/4"H X 23 3/4"W X 23 1/2"D		DW-01	DISHWASHER	TYPICAL	GE	GSD3300KWW WHITE	E	34 H x 24 W x
DR-03	DRYER	PUBLIC	GE		WHITE			DW-02	DISHWASHER	TYPE A	GE	WHITE	1	
DISP-01	DISPOSAL	PUBLIC	INSINKARATOR	SEE UNITS LEGEND	NA			DISP-01	DISPOSAL	TYPICAL	INSINKERATOR	405300 BADGER NA 5 1/2 HP		
MICRO-03	BUILT IN MICROWAV	E PUBLIC	GE	PEB7227ANDD 2.2 BUILT IN MICROWAVE OVEN	STAINLESS STEEL	14"H X 24 1/8"W X 19 3/4"D	INSTALL WITH TRIM KIT: JX7230SLSS 30" BUILT IN TRIM KIT 18 7/8"H X 29 3/4"W	DR-01	DRYER	TYPICAL	GE	WHITE	Ξ	
RAN-03	RANGE	PUBLIC	GE	JB480SMSS 30" FREE STANDING RADIANT SMOOT.	STAINLESS STEEL	47"H X 30"W X 29"D		DR-02	DRYER	TYPICAL	GE	WHITE	Ξ	
REF-03	REFRIGERATOR	PUBLIC		GTE22JSNRSS ENERGY STAF 21.9 CU. FT. TOP FREEZER REFRIGERATOR	STAINLESS STEEL	66 3/8"H X 32 3/4"W X 34 1/2"D		RAN-01	RANGE	TYPICAL	HOT POINT	RBS160DMWW WHITE	Ē	30"W X 28 3/4'
REF-04	REFRIGERATOR	ВОН		GTE22JTNRWW ENERGY STAR 21.9 CU. FT. TOP FREEZER REFRIGERATOR	WHITE	66 3/8"H X 32 3/4"W X 34 1/2"D		RAN-02	RANGE	TYPE A	HOT POINT	WHITE	E	
WASH-03	WASHER	PUBLIC	GE		WHITE			REF-01	REFRIGERATOR	TYPICAL	GE	GTE19DTNRWW WHITE	E	66 3/8"H X 34 3/4"W
HOOD-01	HOOD VENT	PUBLIC	GE	JVX5305SJSS ENERGY STAR UNDER THE CABINET HOOD	STAINLESS STEEL	5 1/2"H X 29 7/8"W X 20"D	HARD WIRED TO SWITCH	VENT-01	VENT	TYPE A	GE	WHITE	Ξ	
				·				- WASH-01	WASHING MACHINE	TYPICAL	GE	WHITE	Ē	
								WASH-02	WASHING MACHINE	TYPICAL	GE	WHITE	E	

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### **BATH ACCESSORIES LEGEND: RESIDENTIAL UNITS - TYP ALL SCHEMES**

NOTES / PRODUCT REPRESENTATIVE SURFACE MOUNTED

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MARK	TYPE	LOCATION (GENERAL)	MANUFACTURE R	PRODUCT NAME /	COLOR NAME /	FINISH
RB HK-01	ROBE HOOK	BATHROOM	TAYMOR	SPELLBOUND 04-32101	POLISHED CHROME	
SR-01	SHOWER CURTAIN ROD	BATHROOM	MOEN	55-5	POLISHED CHROME	
TB-01	24" TOWEL BAR	BATHROOM	TAYMOR	SPELLBOUND 04-32124	POLISHED CHROME	
TR-01	HAND TOWEL BAR	BATHROOM	TAYMOR	SPELLBOUND 04-32110	POLISHED CHROME	
TPD-01	TOILET PAPER HOLDER	BATHROOM	TAYMOR	SPELLBOUND 04-32148	POLISHED CHROME	

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ENERGY STAR RATED APPLIANCES AND LIGHTING FIXTURES HAVE BEEN PROVIDED WITHIN THE PROJECT DESIGN DOCUMENTS WHERE THESE COMPONANTS ARE READILY AVAILABLE IN THE MARKETPLACE.

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SIZE	NOTES / PRODUCT REPRESENTATIVE
V x 25 3/4 D	
	STACKING
3/4"D X 46 3/4"H	
34 1/2" D X 29	
	STACKING

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SIZE	NOTES / PRODUCT REPRESENTATIVE
2 3/8"W X 1 7/8"D X 2"H	
60"W x 1"D	
26 3/8"W X 2 3/4"D X 1 5/8"H	
12 3/8"W X 2 3/4"D X 1 5/8"H	
7 1/16"W X 2 3/4"D X 1 5/8"H	

SIZE	NOTES / PRODUCT REPRESENTATIVE
3/8"W X 1 7/8"D X 2"H	
0"W x 1"D	
6 3/8"W X 2 3/4"D X 1 5/8"H	
2 3/8"W X 2 3/4"D X 1 5/8"H	

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**BUILDING A - INTERIOR** LEGENDS

SHEET NO.

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AA-631



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8487 REGISTERED ARCHITEC JONATHAN F HALL STATE OF WASHINGTON PROJECT: EHA BAKER HEIGHTS HOUSING AUTHORITY PROJECT ADDRESS: BUILDING A: 2710 14th STREET BUILDING B: 2715 15th STREET BUILDING C: 2815 15th STREET BUILDING D: 2810 14th STREET **EVERETT, WA 98201** OWNER: EVERETT HOUSING AUTHORITY 3107 COLBY AVE **EVERETT, WA 98201** MARK DATE DESCRIPTION REVISIONS C 06/22/2020 BUILDING PERMIT SUBMITTAL / HUD SUBMITTAL 04/10/2020 DESIGN DEVELOPMENT A 01/07/2020 SCHEMATIC DESIGN MARK DATE DESCRIPTION **ISSUE INFORMATION** 2017033 PROJECT NO .: GGLO PRINCIPAL IN CHARGE: Jon Hall GGLO PROJECT MANAGER: Scott Schreffler OWNER APPROVAL: SHEET TITLE **BUILDING A - 3D** REPRESENTATIONS

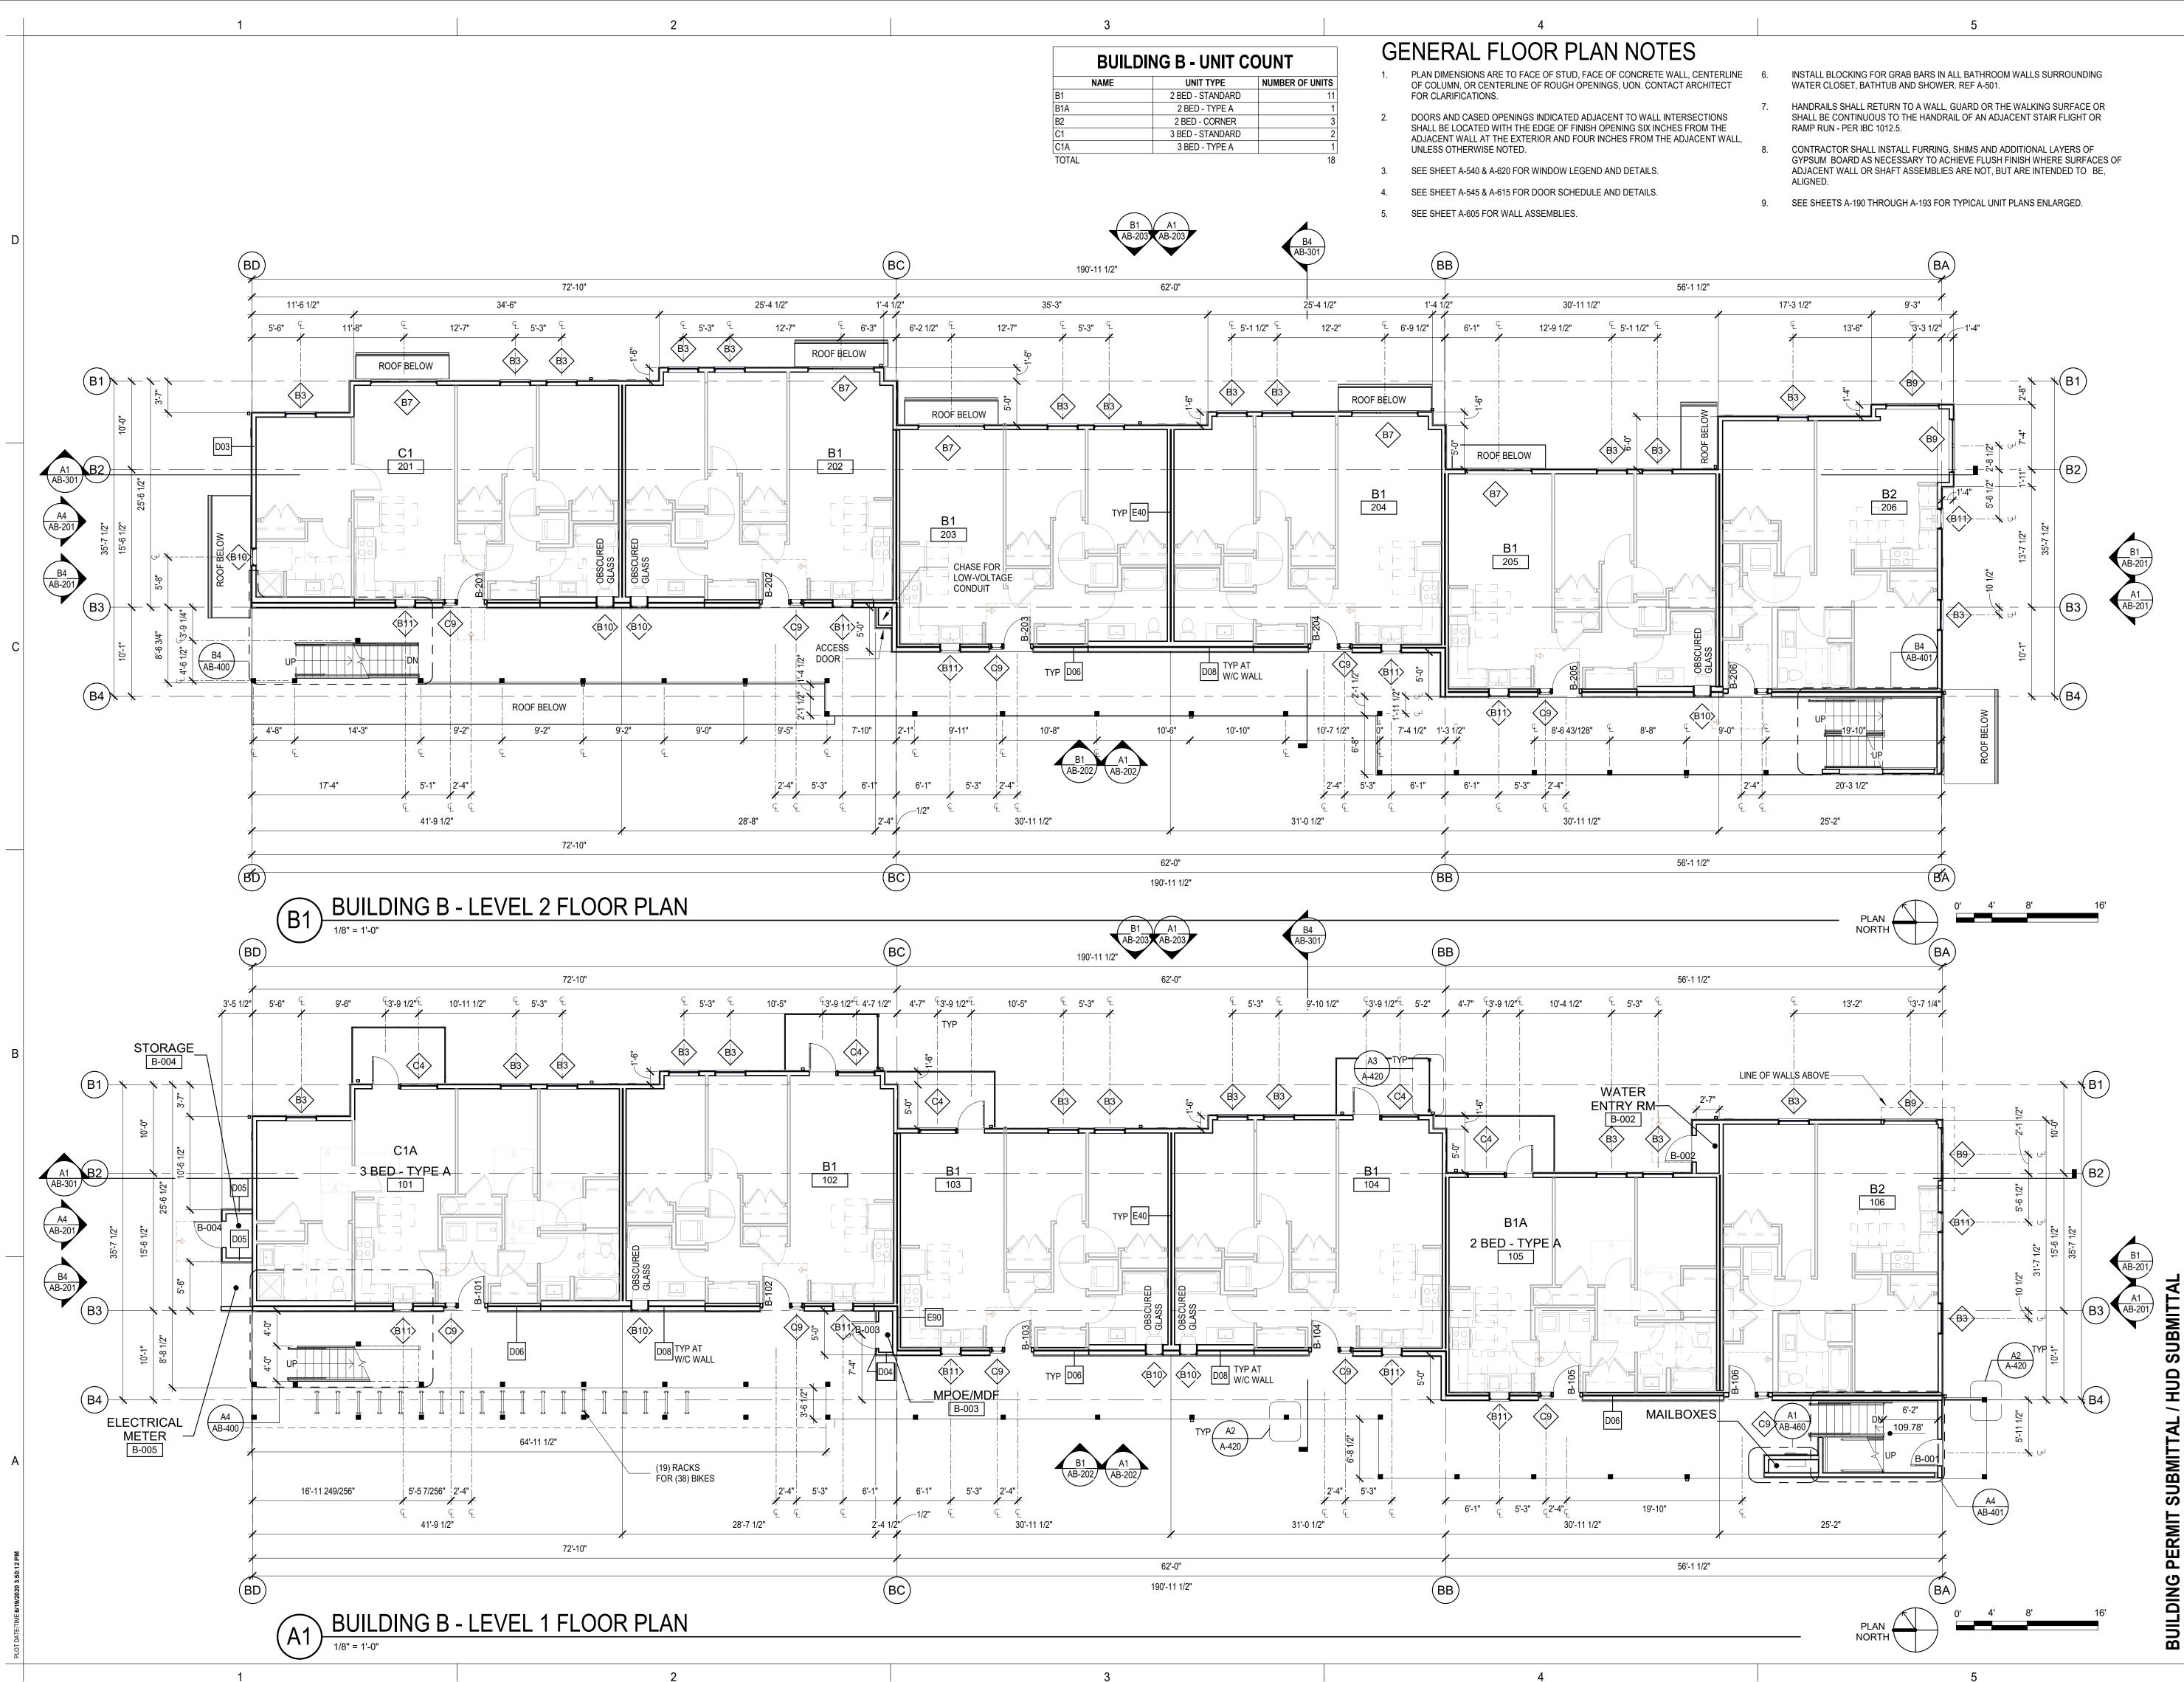
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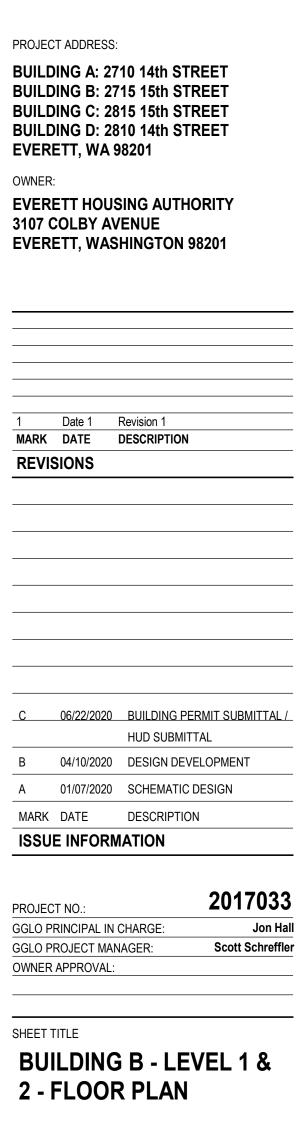
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SHEET NO.

AA-700





GGLO

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Seattle, WA 98101

http://www.gglo.com

8487

PROJECT:

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REGISTERED

ARCHITEC

JONATHAN F HALL

EVERET

HOUSING AUTHORITY

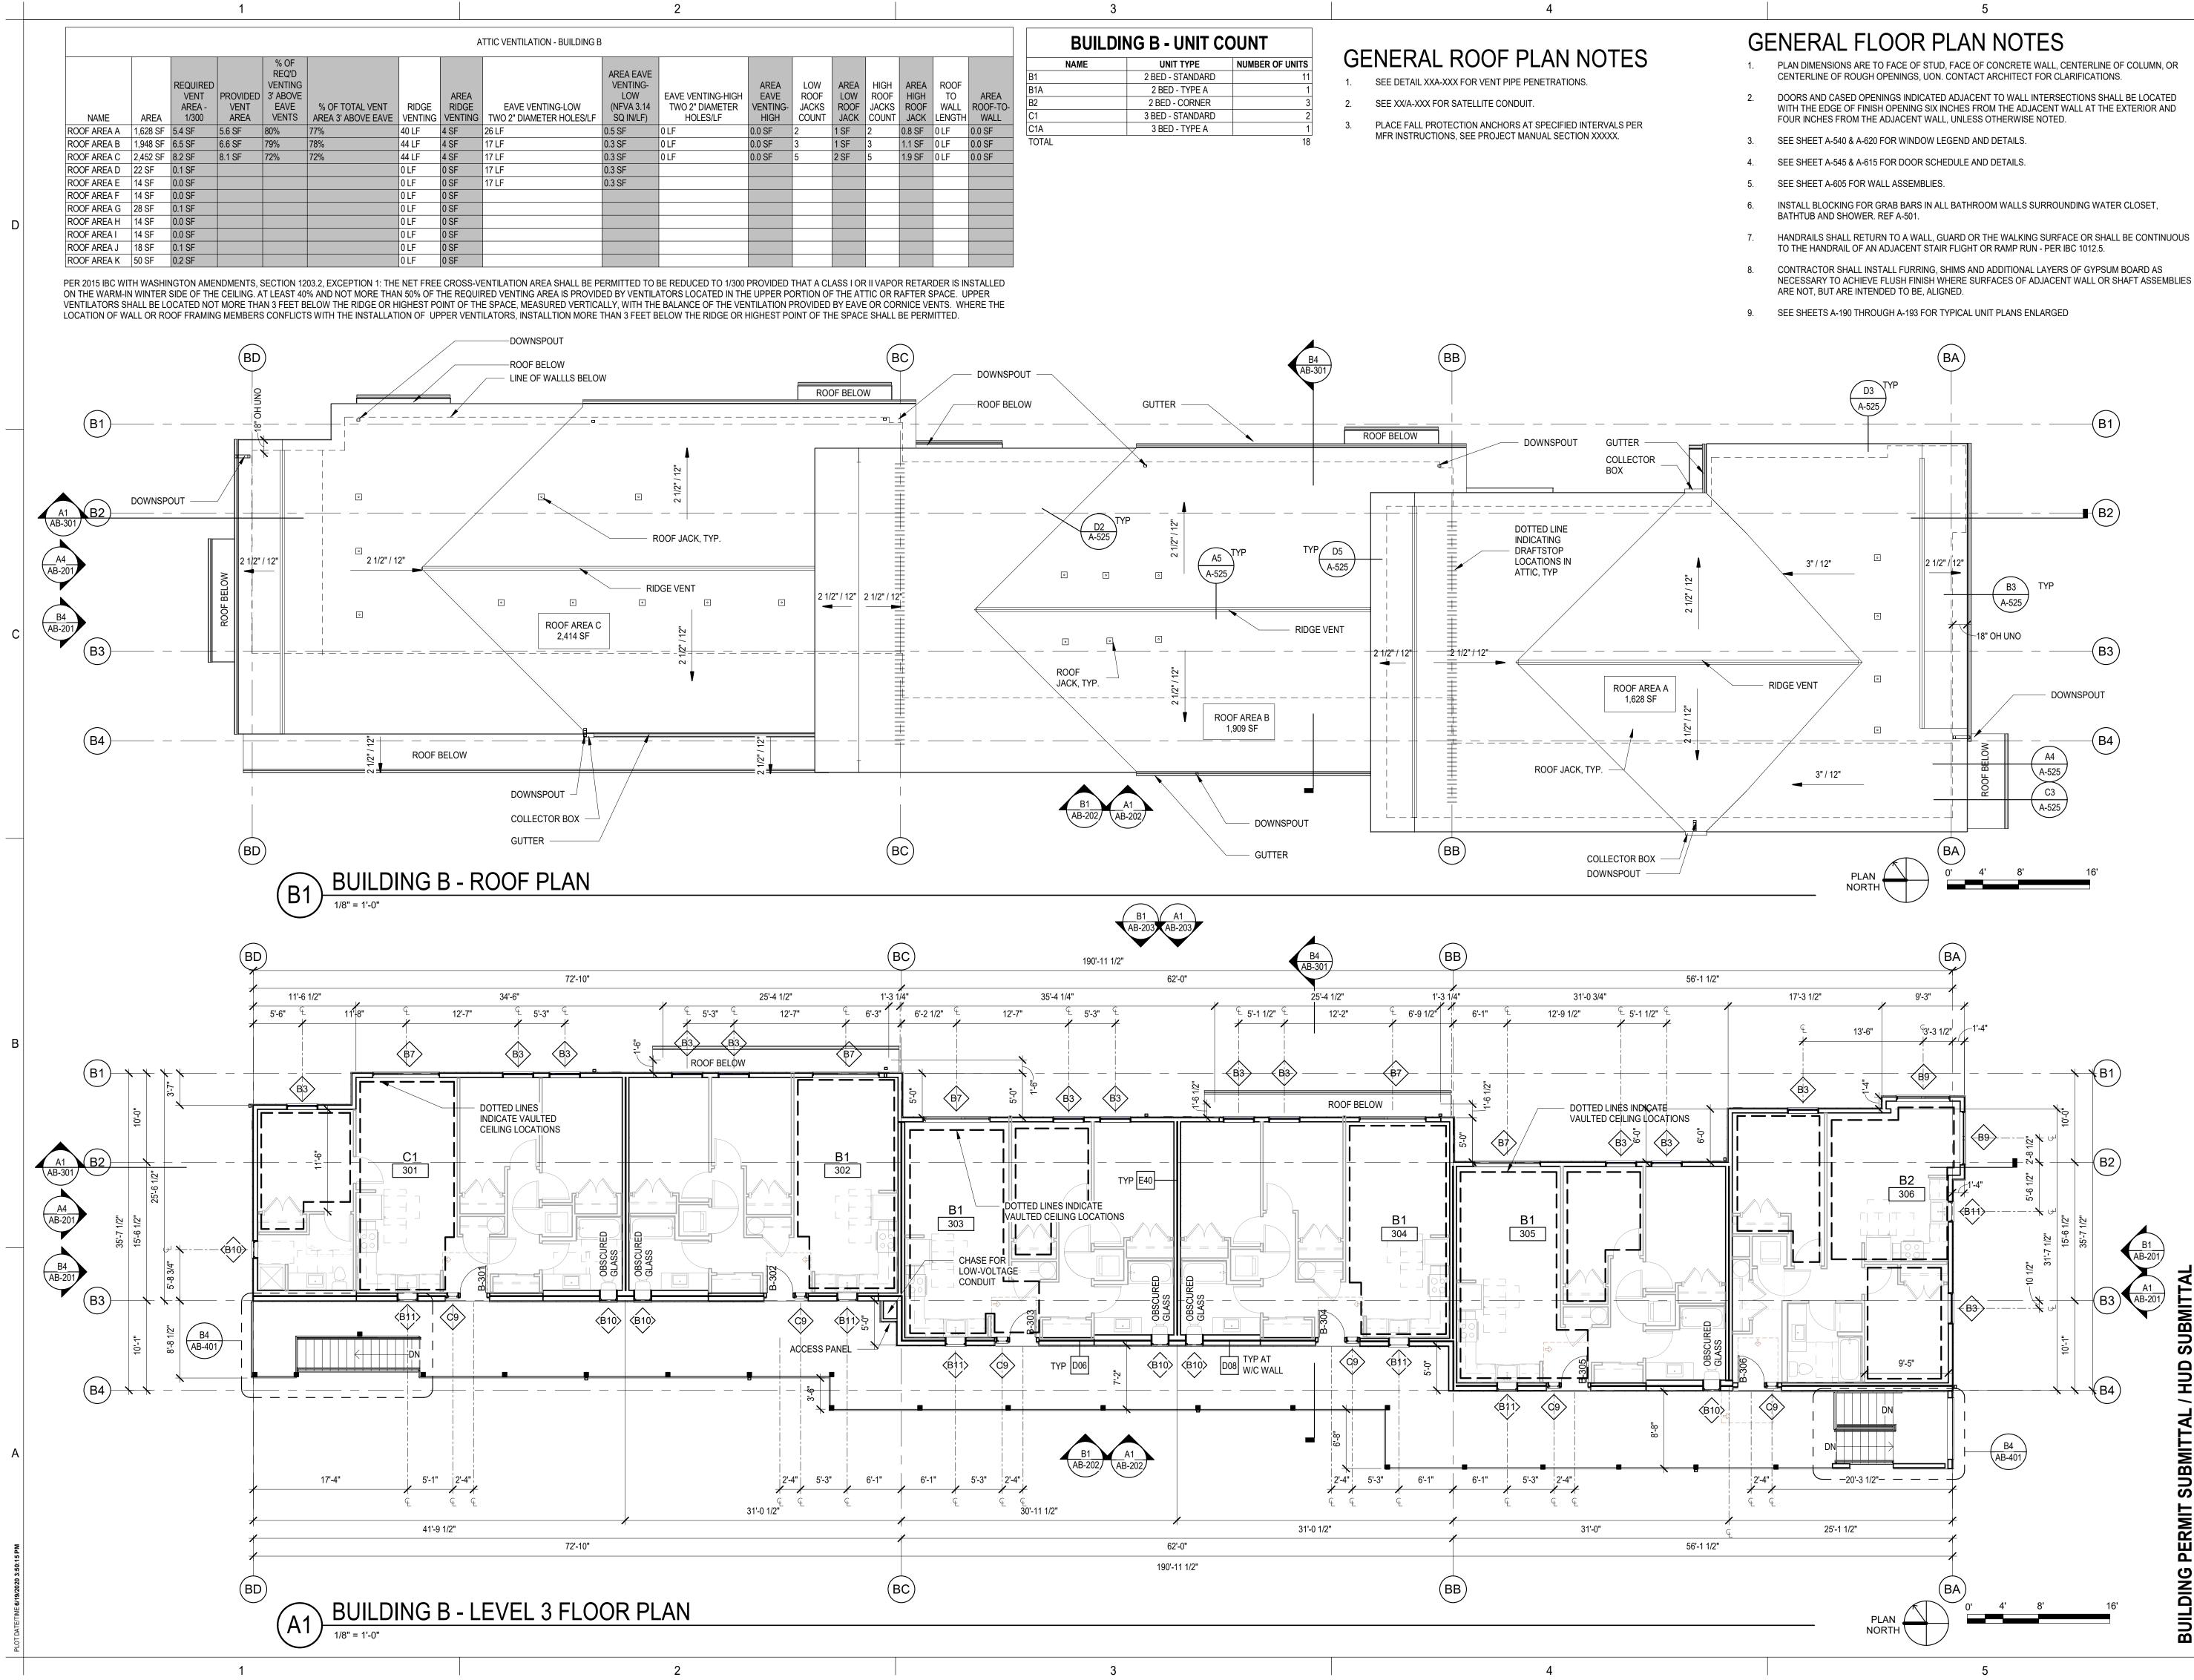
STATE OF WASHINGTON

**EHA BAKER HEIGHTS** 

SHEET NO.

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**AB-110** 



- HANDRAILS SHALL RETURN TO A WALL, GUARD OR THE WALKING SURFACE OR SHALL BE CONTINUOUS
- NECESSARY TO ACHIEVE FLUSH FINISH WHERE SURFACES OF ADJACENT WALL OR SHAFT ASSEMBLIES

848 REGISTERED ARCHITEC JONATHAN F HALL STATE OF WASHINGTO PROJECT: **EHA BAKER HEIGHTS** HOUSING AUTHORITY PROJECT ADDRESS: BUILDING A: 2710 14th STREET BUILDING B: 2715 15th STREET BUILDING C: 2815 15th STREET BUILDING D: 2810 14th STREET **EVERETT, WA 98201** OWNER: **EVERETT HOUSING AUTHORITY** 3107 COLBY AVENUE **EVERETT, WASHINGTON 98201** Date 1 Revision 1 MARK DATE DESCRIPTION REVISIONS 06/22/2020 BUILDING PERMIT SUBMITTAL HUD SUBMITTAL 04/10/2020 DESIGN DEVELOPMEN 01/07/2020 SCHEMATIC DESIGN MARK DATE DESCRIPTION **ISSUE INFORMATION** 

**ROOF PLAN** 

PROJECT NO .:

SHEET TITLE

GGLO PRINCIPAL IN CHARGE

GGLO PROJECT MANAGER

OWNER APPROVAL

SHEET NO.

**BUILDING B - LEVEL 3 &** 

**AB-111** 

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2017033

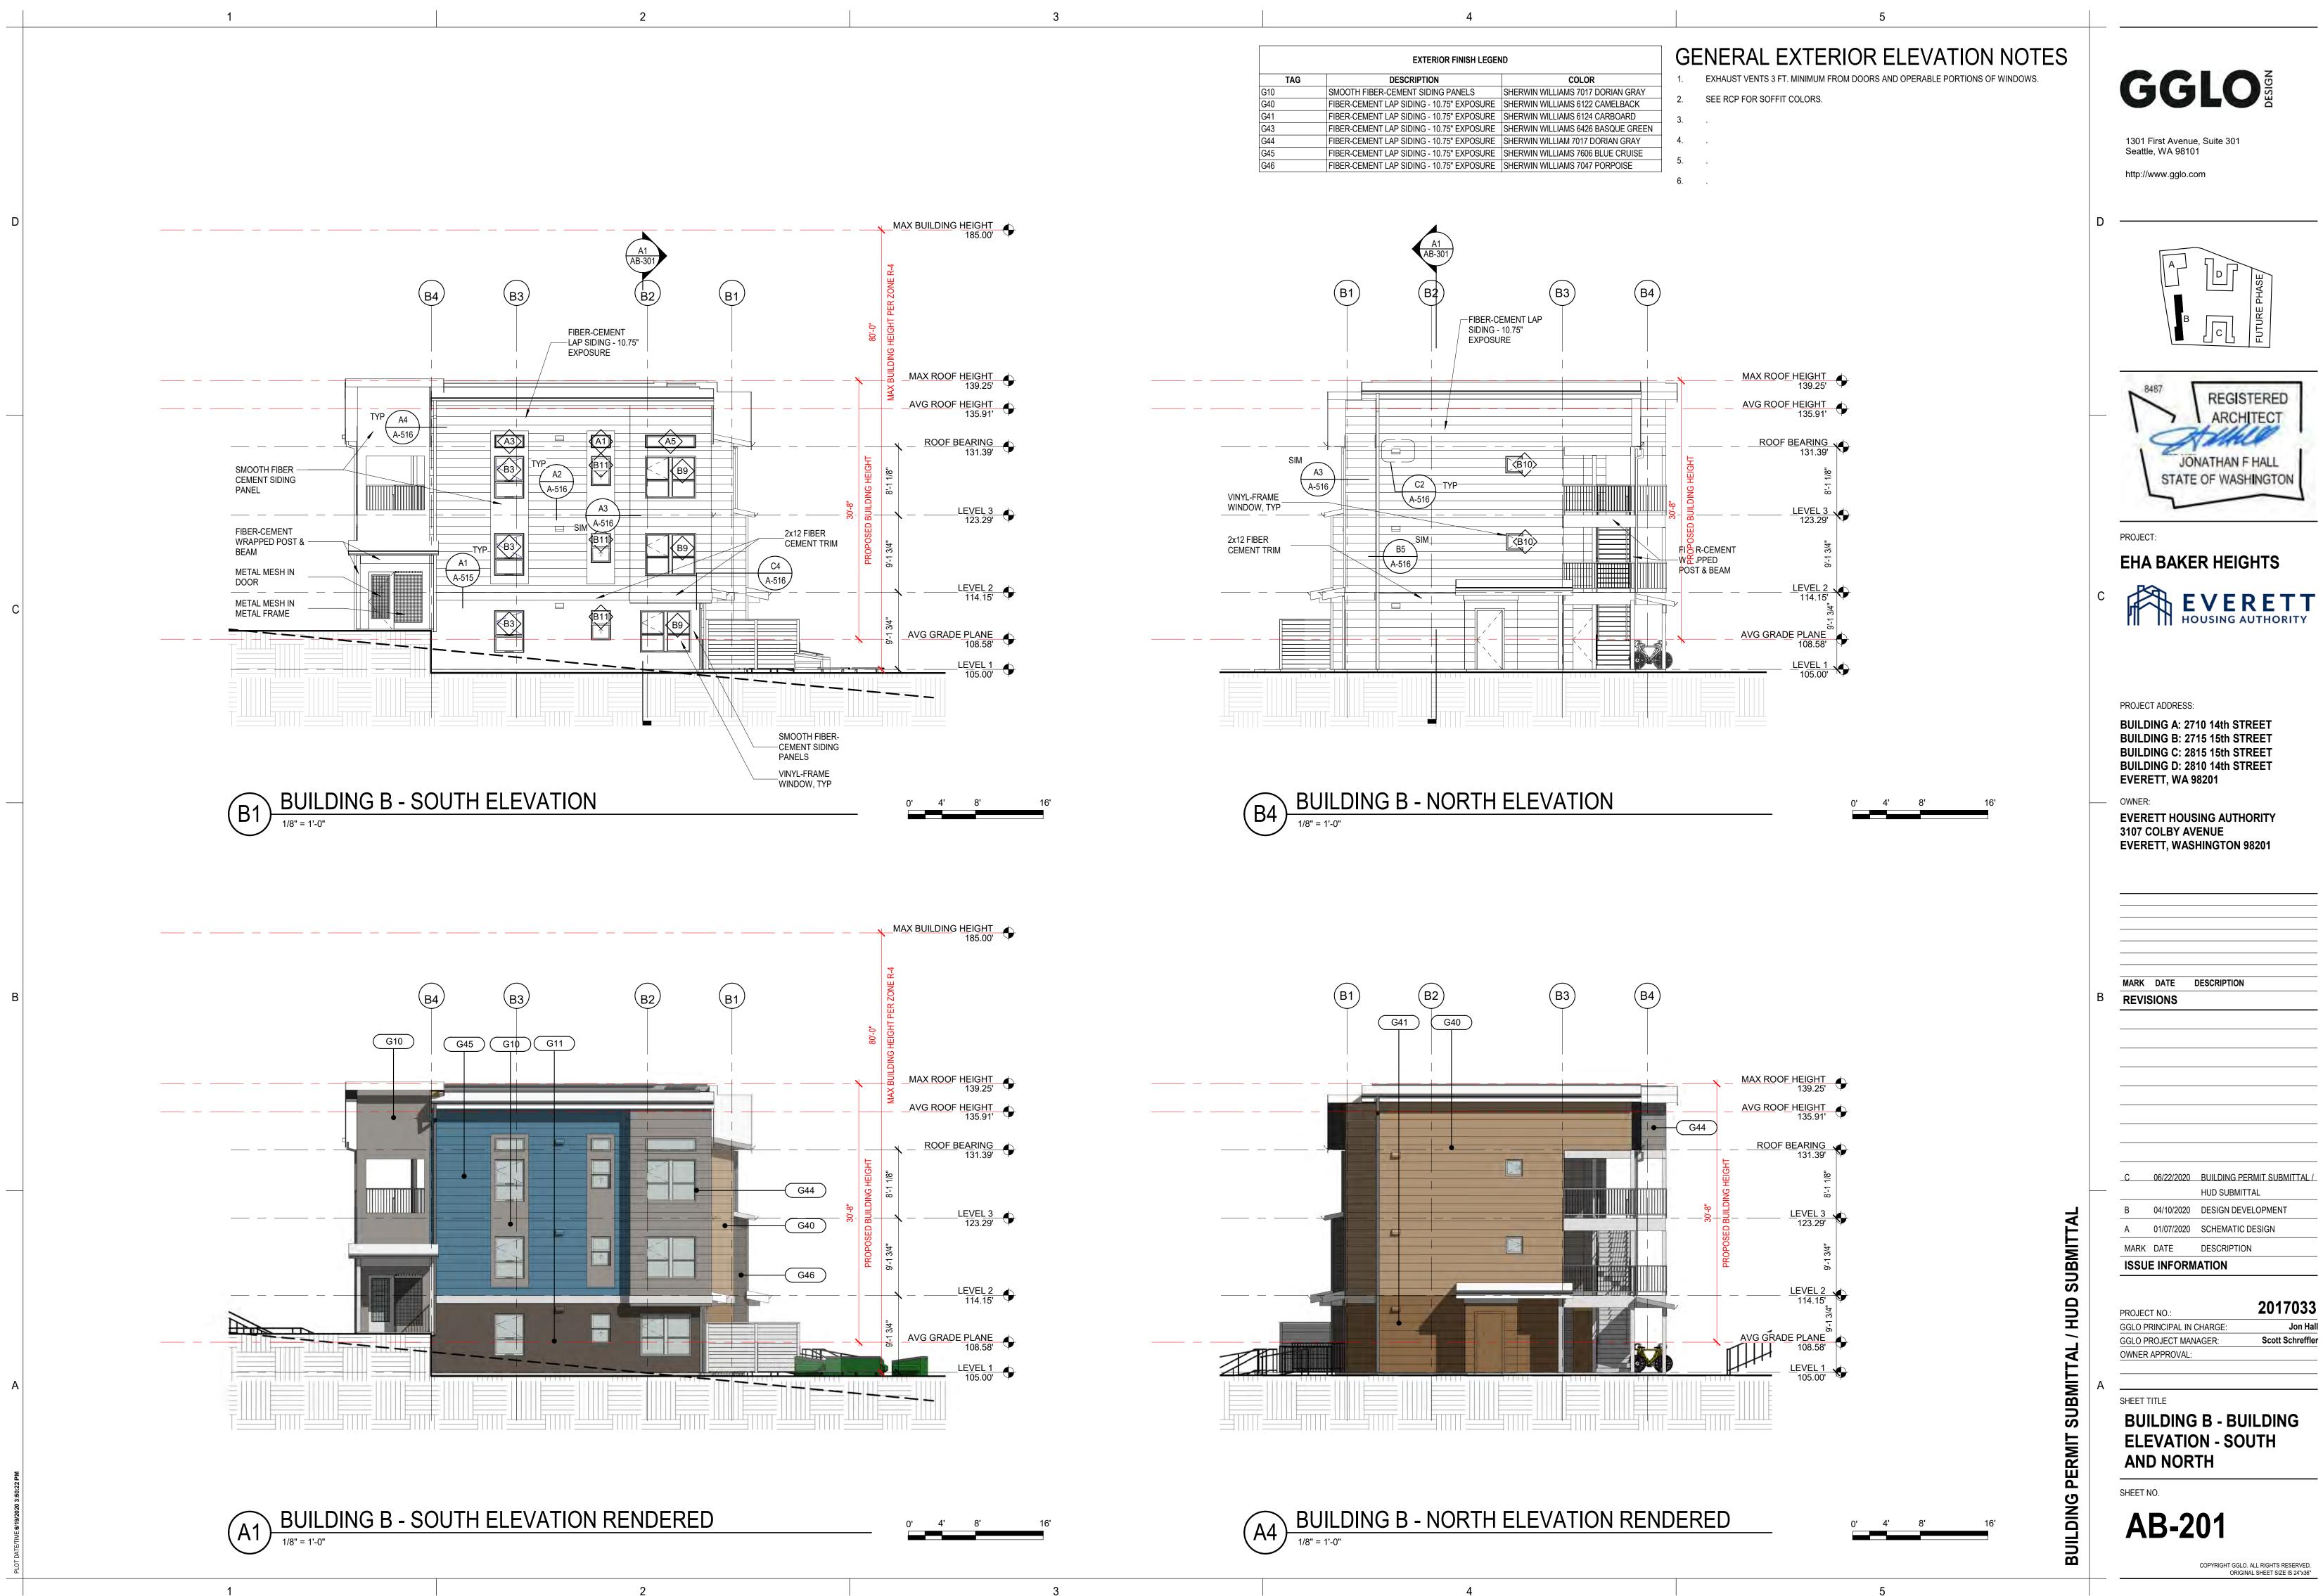
Scott Schreffler

Jon Hall

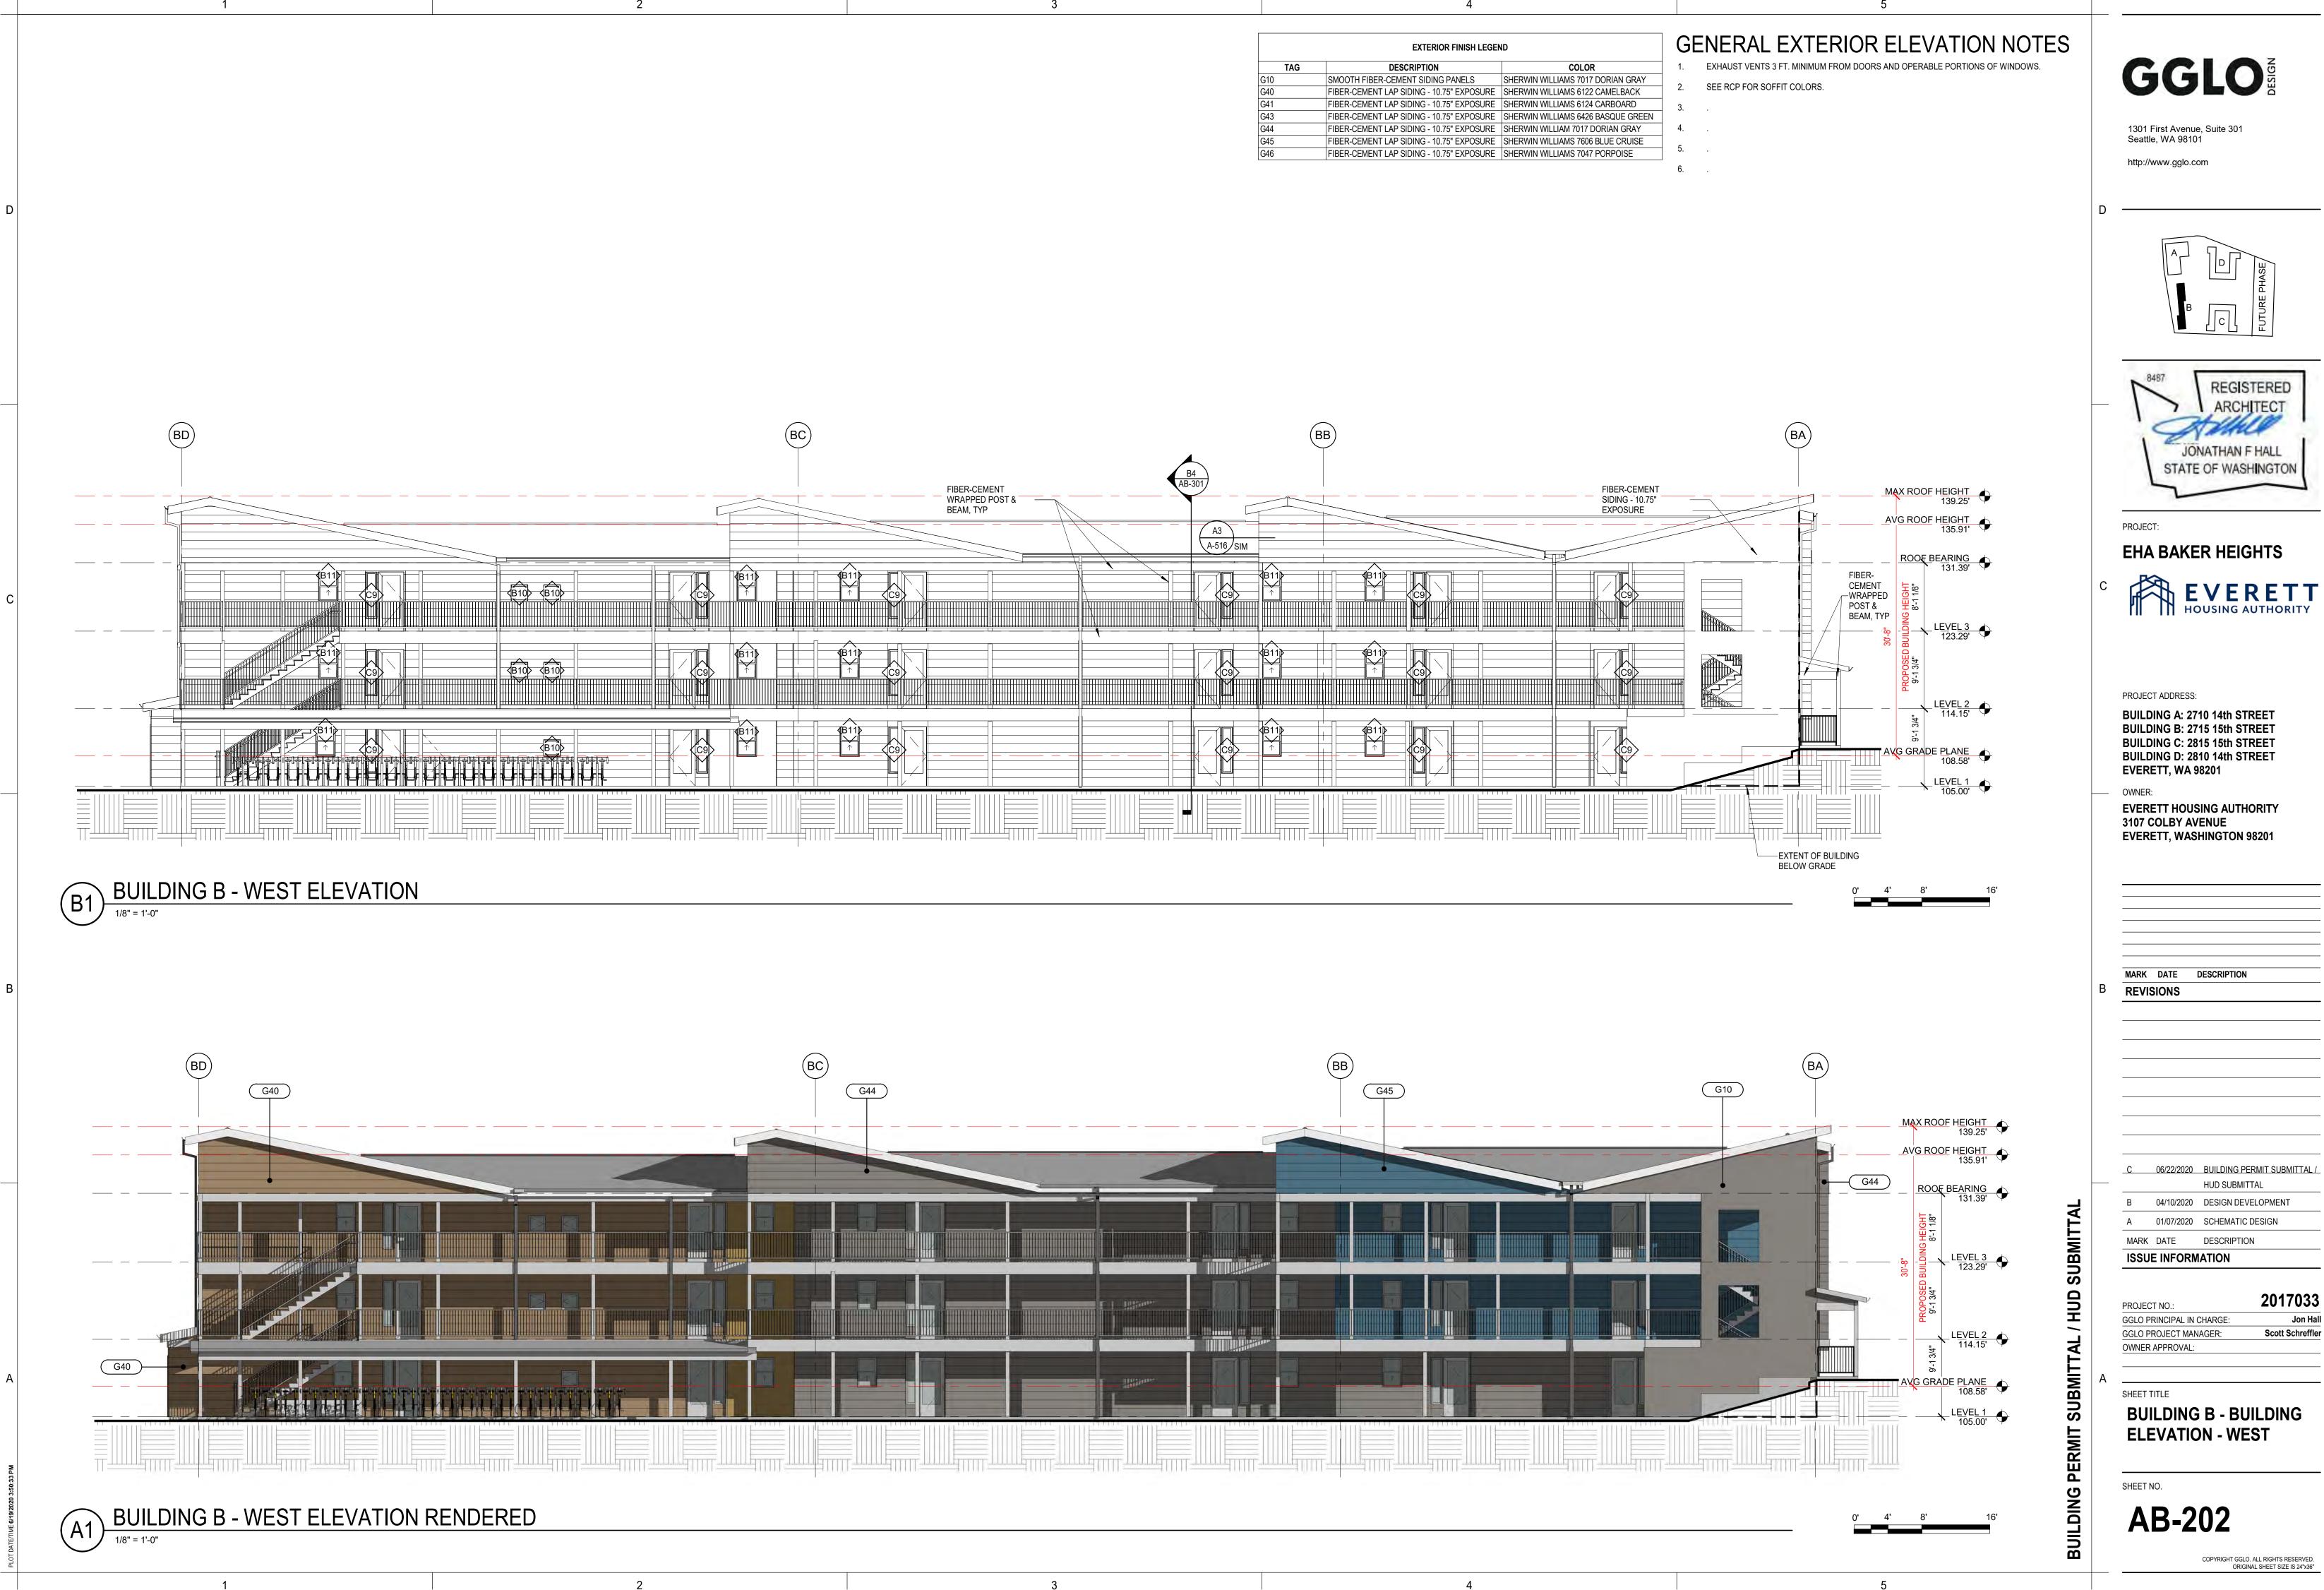


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	EXTERIOR FINISH LEGE	ND
TAG	DESCRIPTION	COLOR
G10	SMOOTH FIBER-CEMENT SIDING PANELS	SHERWIN WILLIAMS 7017 DO
G40	FIBER-CEMENT LAP SIDING - 10.75" EXPOSURE	SHERWIN WILLIAMS 6122 CA
G41	FIBER-CEMENT LAP SIDING - 10.75" EXPOSURE	SHERWIN WILLIAMS 6124 CA
G43	FIBER-CEMENT LAP SIDING - 10.75" EXPOSURE	SHERWIN WILLIAMS 6426 BA
G44	FIBER-CEMENT LAP SIDING - 10.75" EXPOSURE	SHERWIN WILLIAM 7017 DOR
G45	FIBER-CEMENT LAP SIDING - 10.75" EXPOSURE	SHERWIN WILLIAMS 7606 BLU
G46	FIBER-CEMENT LAP SIDING - 10.75" EXPOSURE	SHERWIN WILLIAMS 7047 PO



	EXTERIOR FINISH LEGE	ND
TAG	DESCRIPTION	COLOR
G10	SMOOTH FIBER-CEMENT SIDING PANELS	SHERWIN WILLIAMS 7017 DOI
G40	FIBER-CEMENT LAP SIDING - 10.75" EXPOSURE	SHERWIN WILLIAMS 6122 CAI
G41	FIBER-CEMENT LAP SIDING - 10.75" EXPOSURE	SHERWIN WILLIAMS 6124 CAR
G43	FIBER-CEMENT LAP SIDING - 10.75" EXPOSURE	SHERWIN WILLIAMS 6426 BAS
G44	FIBER-CEMENT LAP SIDING - 10.75" EXPOSURE	SHERWIN WILLIAM 7017 DOR
G45	FIBER-CEMENT LAP SIDING - 10.75" EXPOSURE	SHERWIN WILLIAMS 7606 BLU
G46	FIBER-CEMENT LAP SIDING - 10.75" EXPOSURE	SHERWIN WILLIAMS 7047 POI

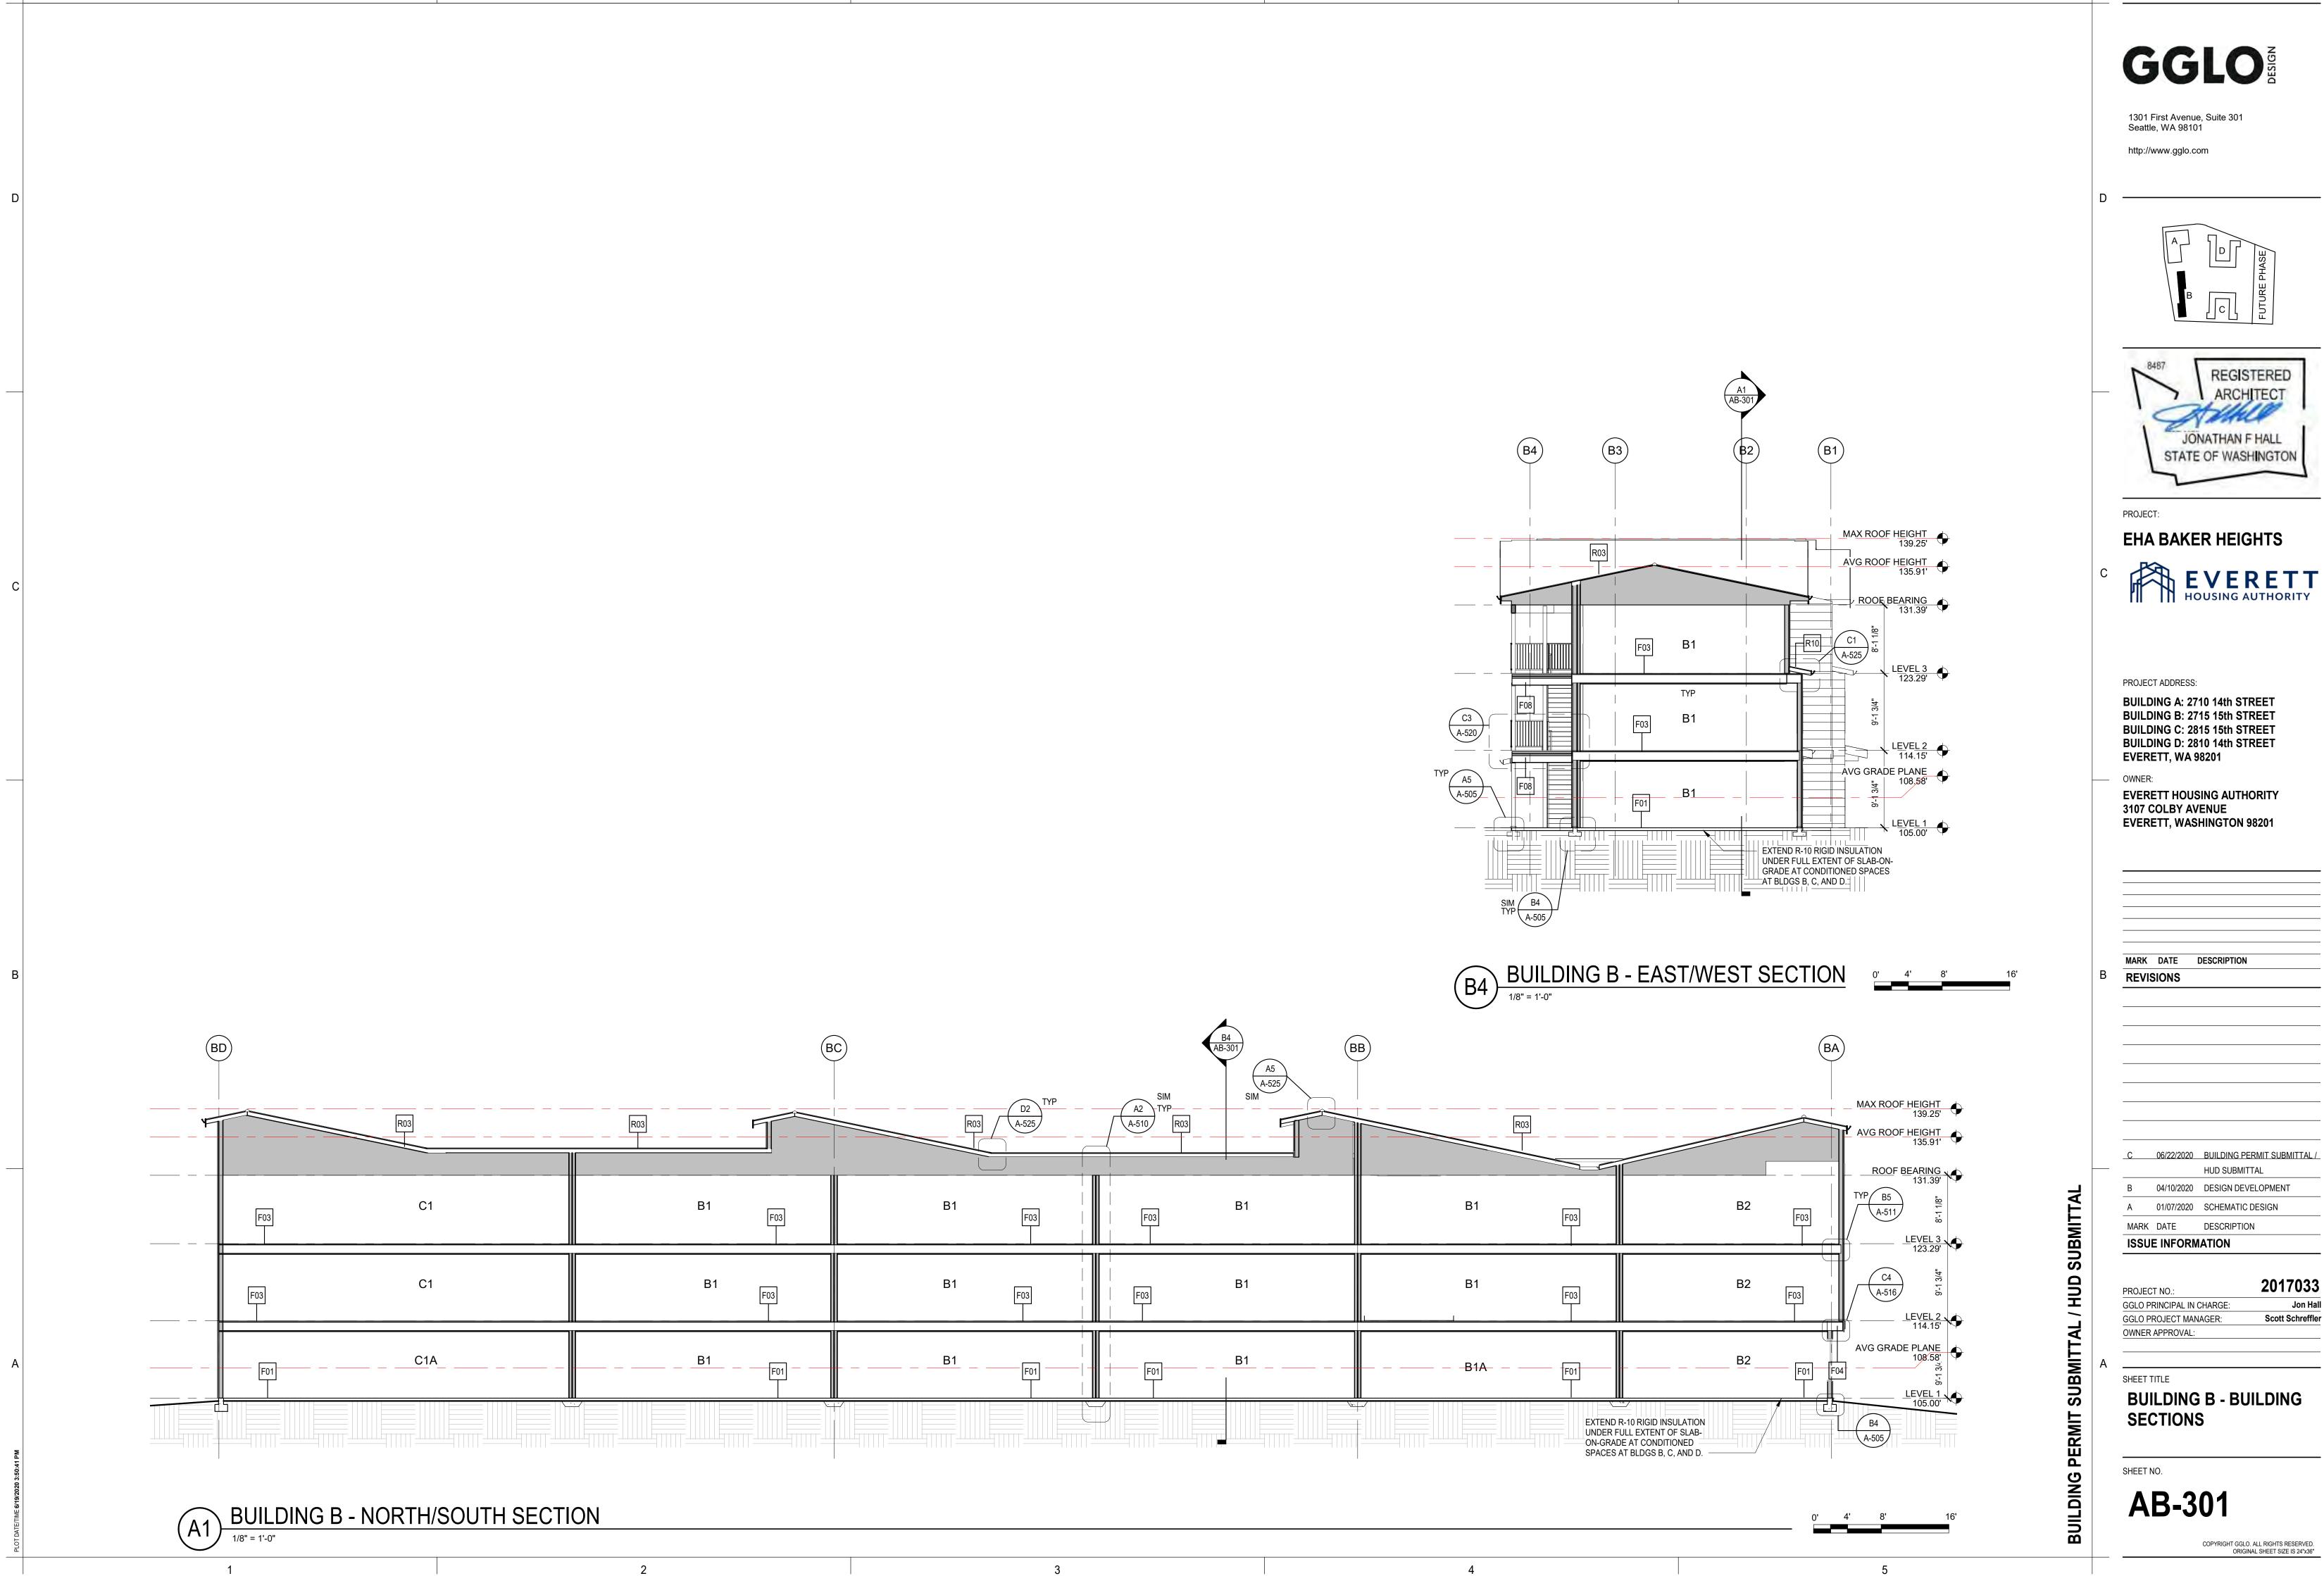
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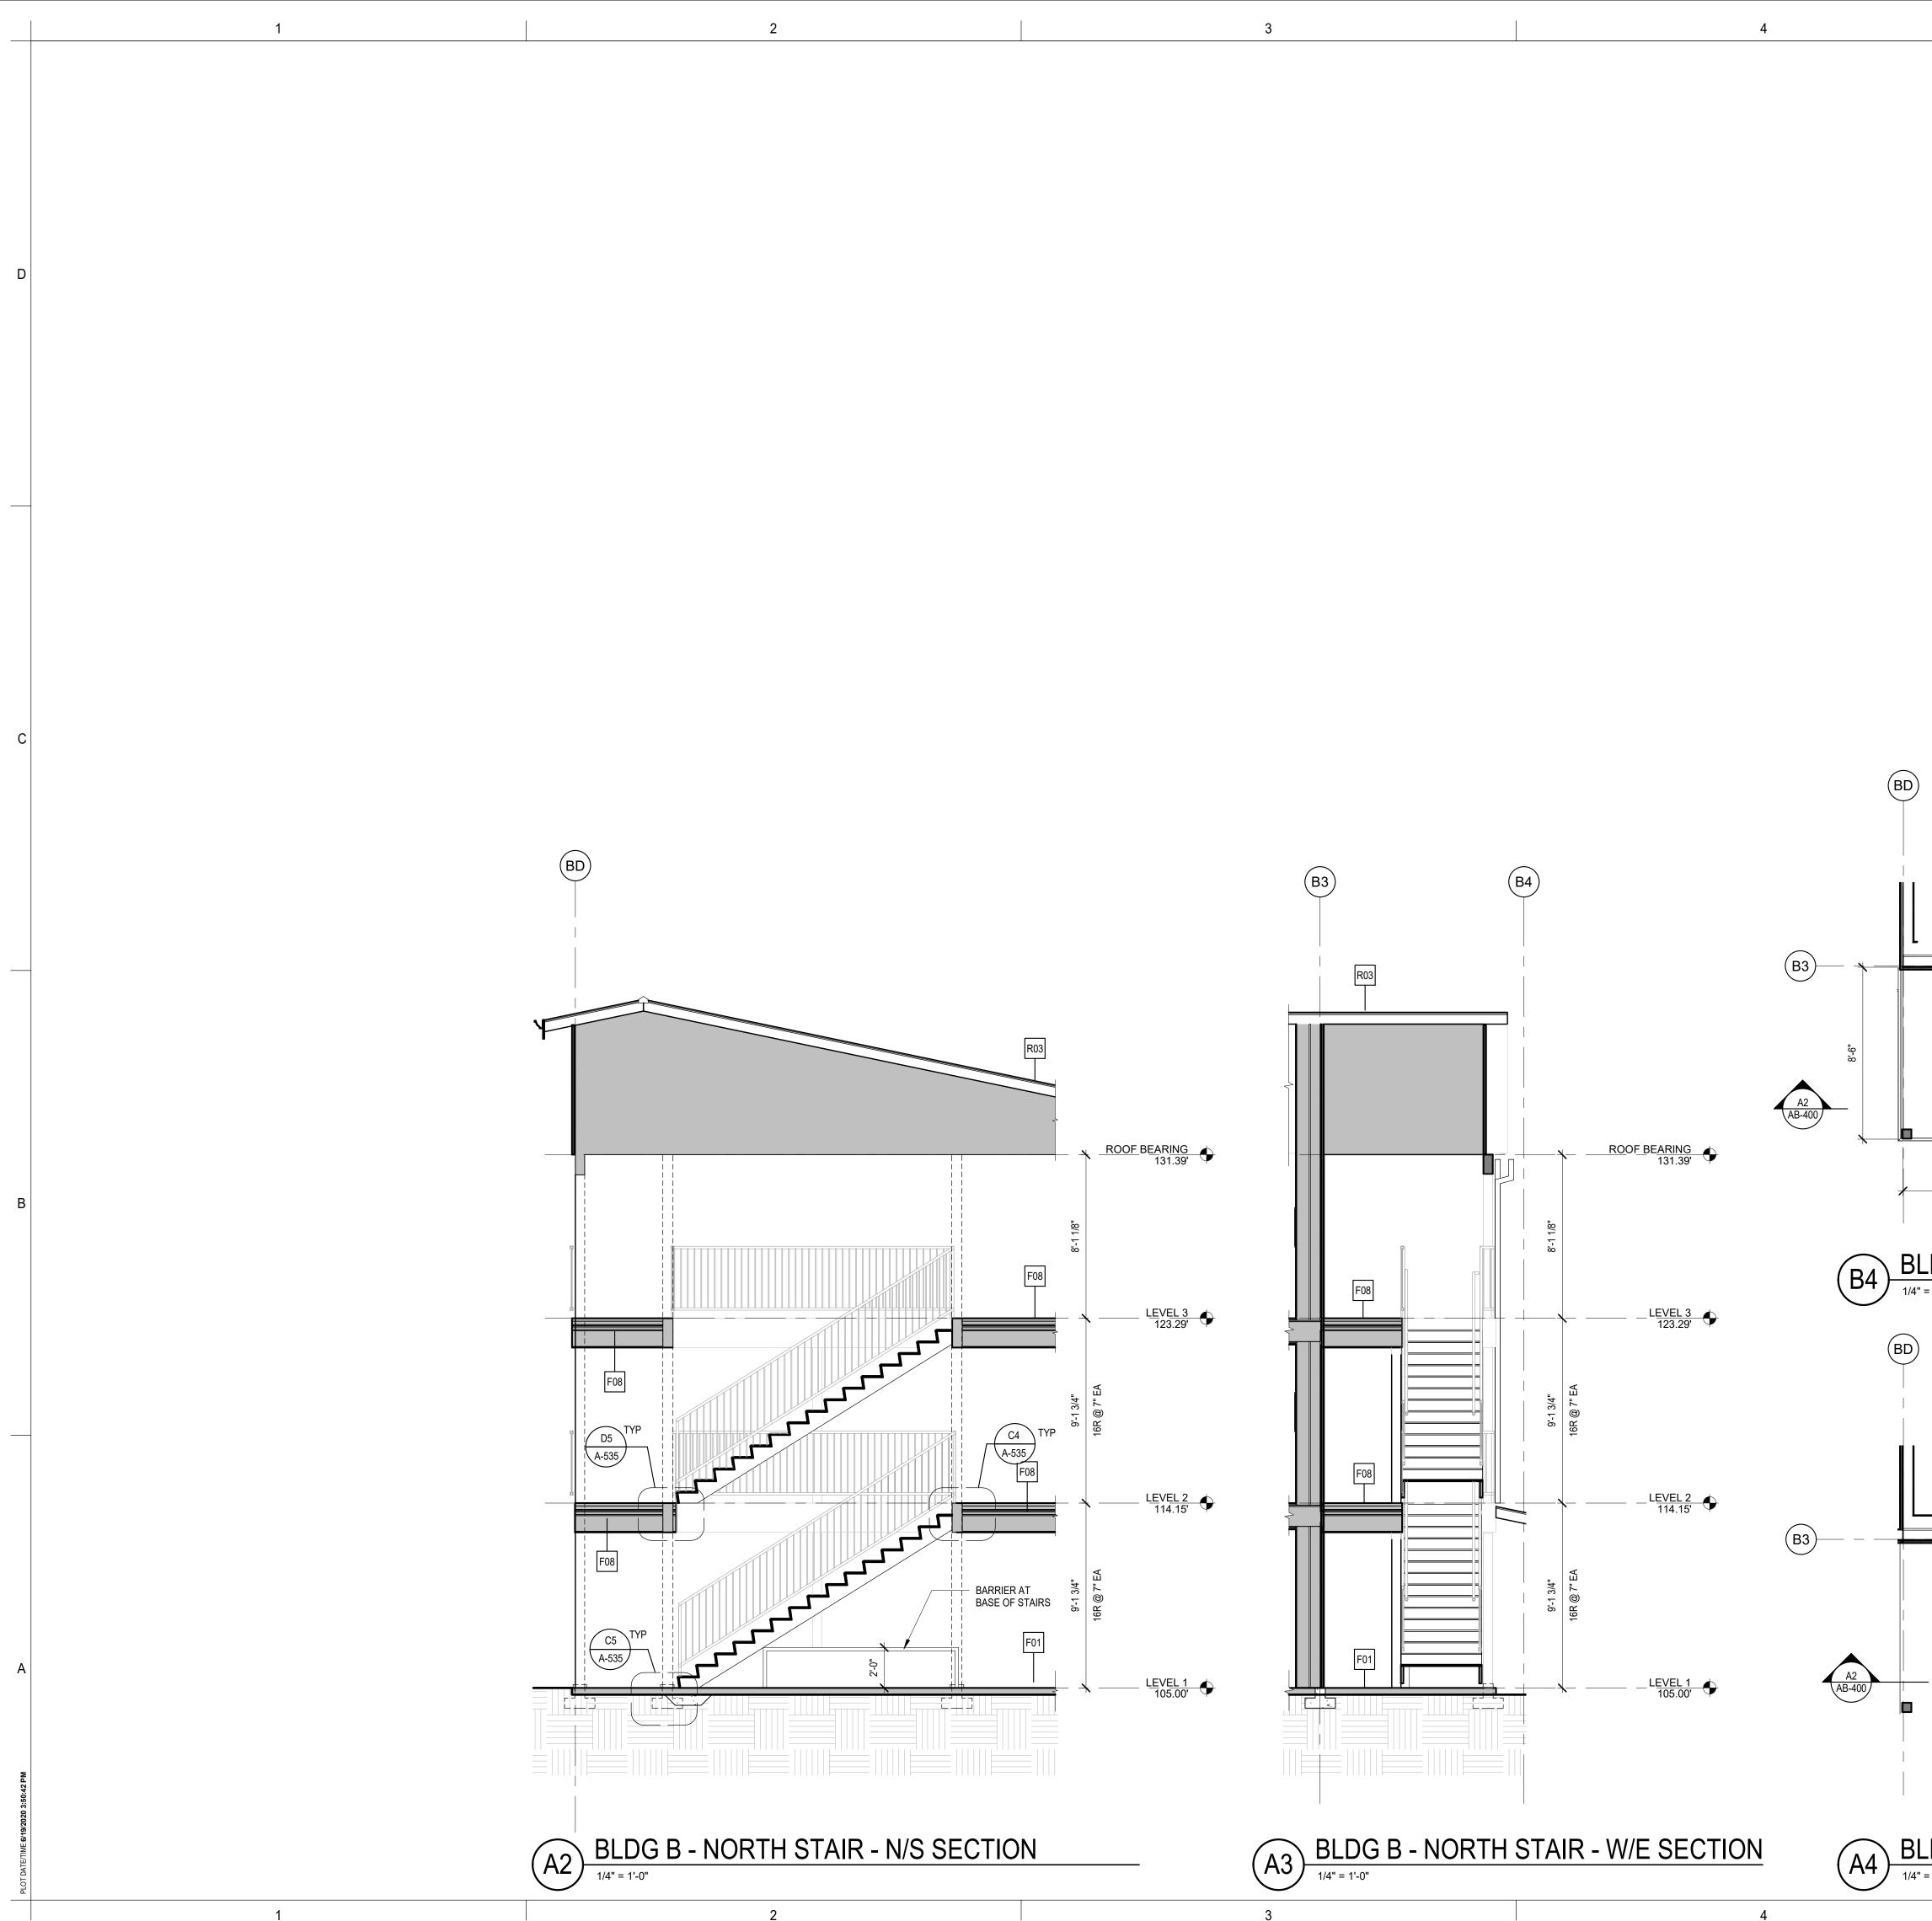
Jon Hall

Scott Schreffler



EXTERIOR FINISH LEGE	ND
DESCRIPTION	COLOR
SMOOTH FIBER-CEMENT SIDING PANELS	SHERWIN WILLIAMS 7017 DO
FIBER-CEMENT LAP SIDING - 10.75" EXPOSURE	SHERWIN WILLIAMS 6122 CA
FIBER-CEMENT LAP SIDING - 10.75" EXPOSURE	SHERWIN WILLIAMS 6124 CA
FIBER-CEMENT LAP SIDING - 10.75" EXPOSURE	SHERWIN WILLIAMS 6426 BA
FIBER-CEMENT LAP SIDING - 10.75" EXPOSURE	SHERWIN WILLIAM 7017 DOI
FIBER-CEMENT LAP SIDING - 10.75" EXPOSURE	SHERWIN WILLIAMS 7606 BL
FIBER-CEMENT LAP SIDING - 10.75" EXPOSURE	SHERWIN WILLIAMS 7047 PC
-	DESCRIPTIONSMOOTH FIBER-CEMENT SIDING PANELSFIBER-CEMENT LAP SIDING - 10.75" EXPOSUREFIBER-CEMENT LAP SIDING - 10.75" EXPOSURE



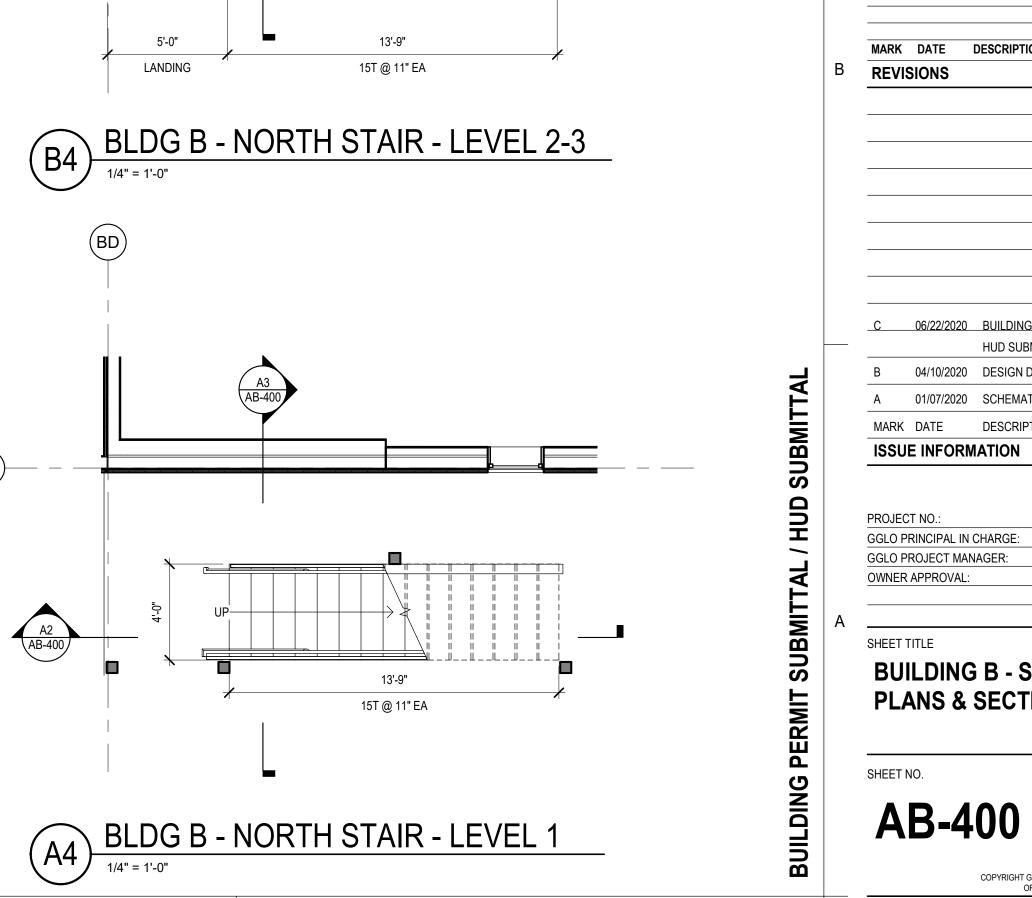


AB-40

5'-0" LANDING 1/4" = 1'-0"

### GENERAL STAIR NOTES

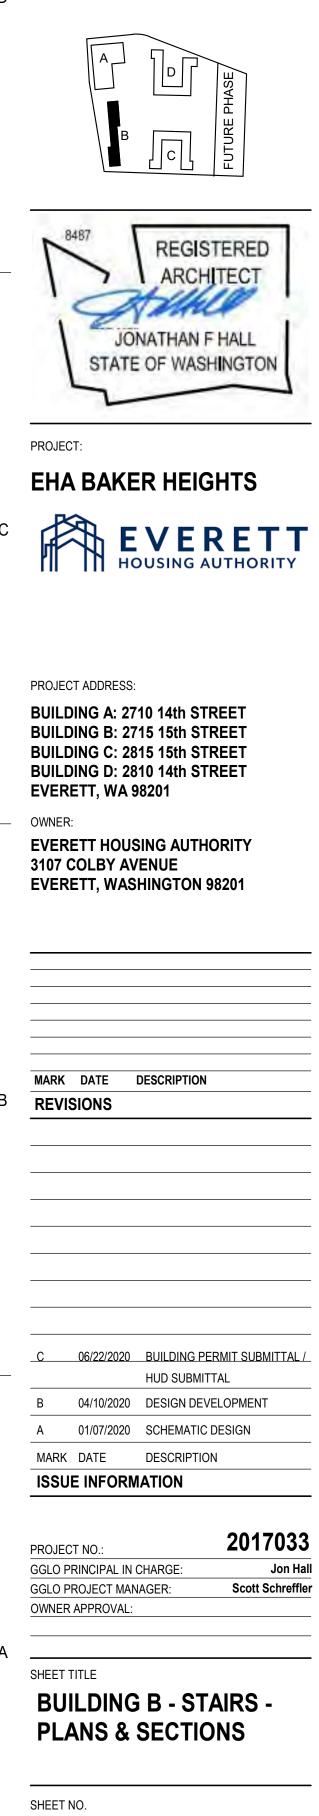
- MIN HEADROOM CLEARANCE IN STAIRS 80" MEASURED VERTICALLY FROM THE STAIR NOSING. HANDRAIL HEIGHT 34"-38", MEASURED VERTICALLY FROM THE NOSING.
- TOP HANDRAIL EXTENSIONS NON CONTINUOUS HANDRAILS SHOULD EXTEND 12"
- HORIZONTALLY BEYOND THE TOP RISER. BOTTOM HANDRAIL EXTENSIONS CONTINUE TO SLOPE FOR THE DEPTH OF ONE TREAD
- BEYOND THE BOTTOM RISER.
- TREADS AND RISERS IN MEANS OF EGRESS TREADS 11" MIN AND RISERS 7" MAX PROVIDE SIGN AT EACH LANDING OF EACH INTERIOR EXIT STAIRWAY PER IBC 1023.8 AS SHOWN IN DETAIL - / ---

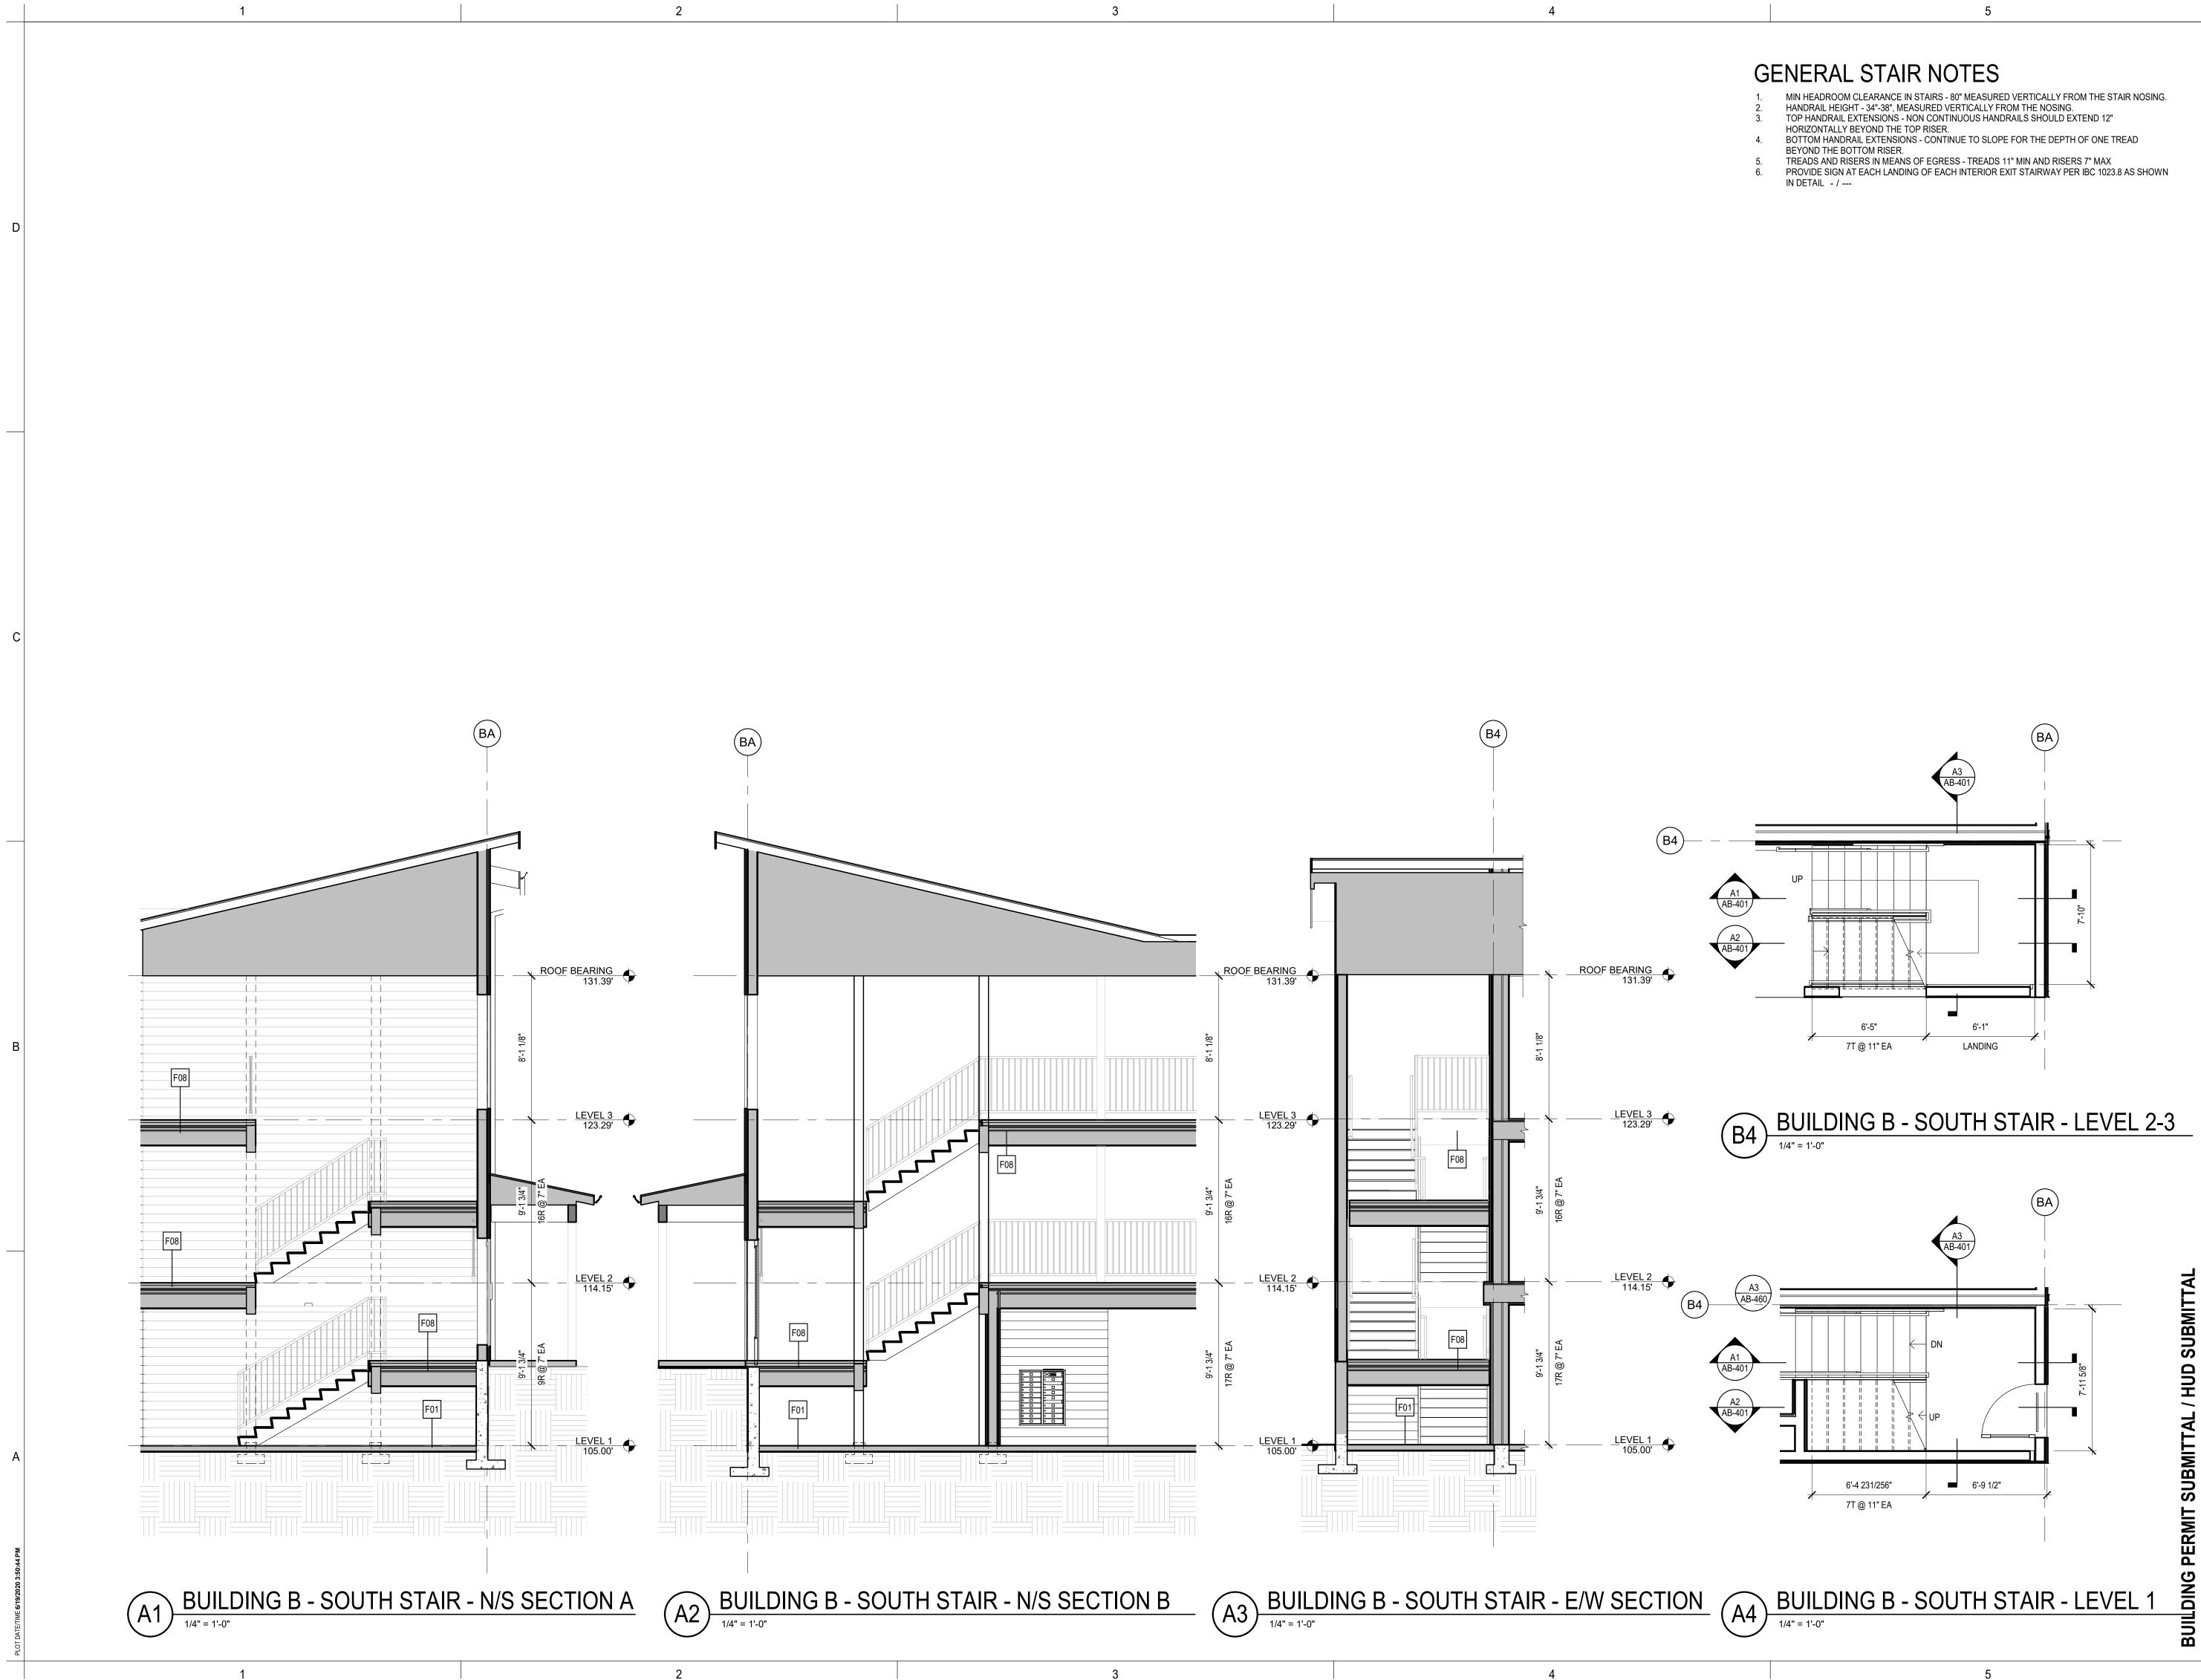


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GGLO PRINCIPAL IN CHARGE: Jor		B		FUTURE PHASE
EHA BAKER HEIGHTS	1	JOP	ARCH	F HALL
BUILDING A: 2710 14th STREET BUILDING B: 2715 15th STREET BUILDING C: 2815 15th STREET EVERETT, WA 98201 OWNER: EVERETT HOUSING AUTHORITY 3107 COLBY AVENUE EVERETT, WASHINGTON 98201 MARK DATE DESCRIPTION REVISIONS C 06/22/2020 BUILDING PERMIT SUBMITT HUD SUBMITTAL B 04/10/2020 DESIGN DEVELOPMENT A 01/07/2020 SCHEMATIC DESIGN MARK DATE DESCRIPTION ISSUE INFORMATION PROJECT NO.: 20170 GGLO PROJECT MANAGER: Scott Schr		A BAKE		
REVISIONS         REVISIONS         01/07/2020         B       04/10/2020         DESIGN DEVELOPMENT         A       01/07/2020         SCHEMATIC DESIGN         MARK       DATE         DESCRIPTION         ISSUE INFORMATION         PROJECT NO.:         Q0170         GGLO PRINCIPAL IN CHARGE:         Jor         GGLO PROJECT MANAGER:	BUILD BUILD BUILD BUILD EVERI OWNER EVERI 3107 (	DING A: 27 DING B: 27 DING C: 28 DING D: 28 ETT, WA 9 ETT HOUS COLBY AV	15 15th S 15 15th S 10 14th S 8201 SING AUTH ENUE	TREET TREET TREET HORITY
HUD SUBMITTAL         B       04/10/2020       DESIGN DEVELOPMENT         A       01/07/2020       SCHEMATIC DESIGN         MARK       DATE       DESCRIPTION         ISSUE INFORMATION         PROJECT NO.:         GGLO PRINCIPAL IN CHARGE:       Jor         GGLO PROJECT MANAGER:       Scott Schr			DESCRIPTION	
B       04/10/2020       DESIGN DEVELOPMENT         A       01/07/2020       SCHEMATIC DESIGN         MARK       DATE       DESCRIPTION         ISSUE INFORMATION       20170         GGLO PRINCIPAL IN CHARGE:       Jor         GGLO PROJECT MANAGER:       Scott Schr		06/22/2020	BUILDING F	PERMIT SUBMITT
GGLO PRINCIPAL IN CHARGE:     Jor       GGLO PROJECT MANAGER:     Scott Schr	A MARK	01/07/2020 DATE	DESIGN DE SCHEMATIO DESCRIPTIO	VELOPMENT C DESIGN
	GGLO P GGLO P	RINCIPAL IN ( ROJECT MAN		20170 Jon Scott Schre

GGLO

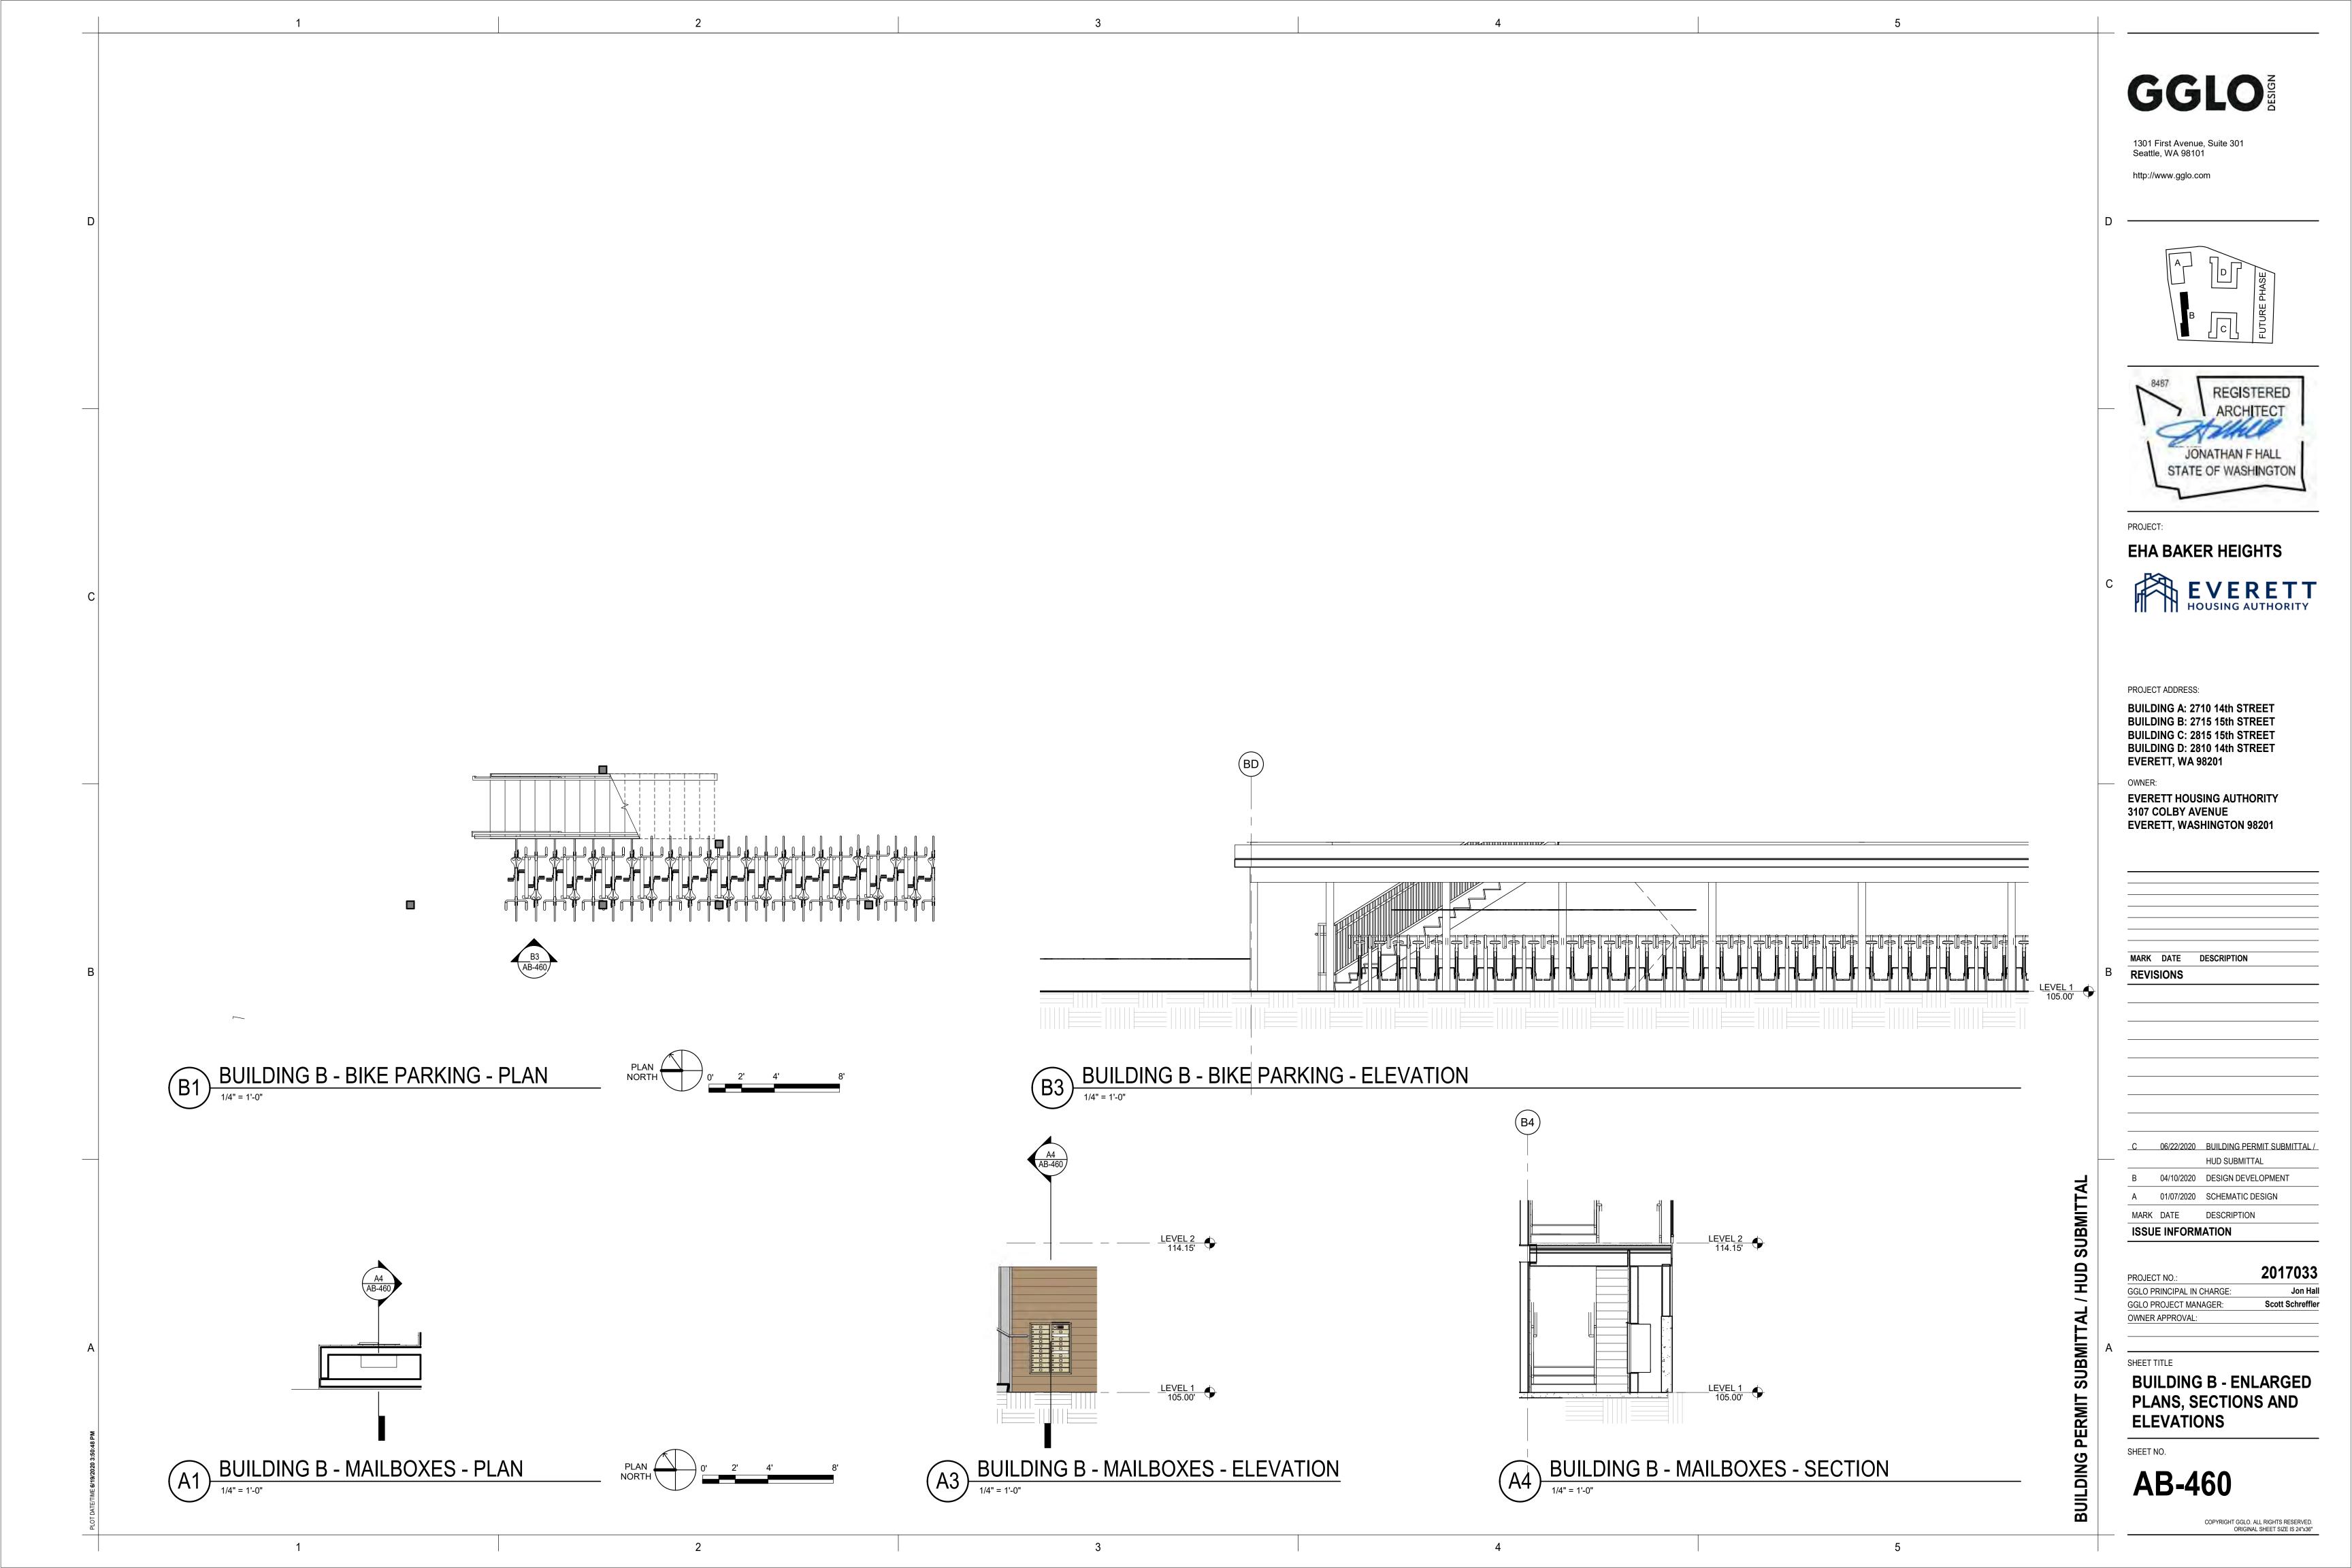
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Seattle, WA 98101

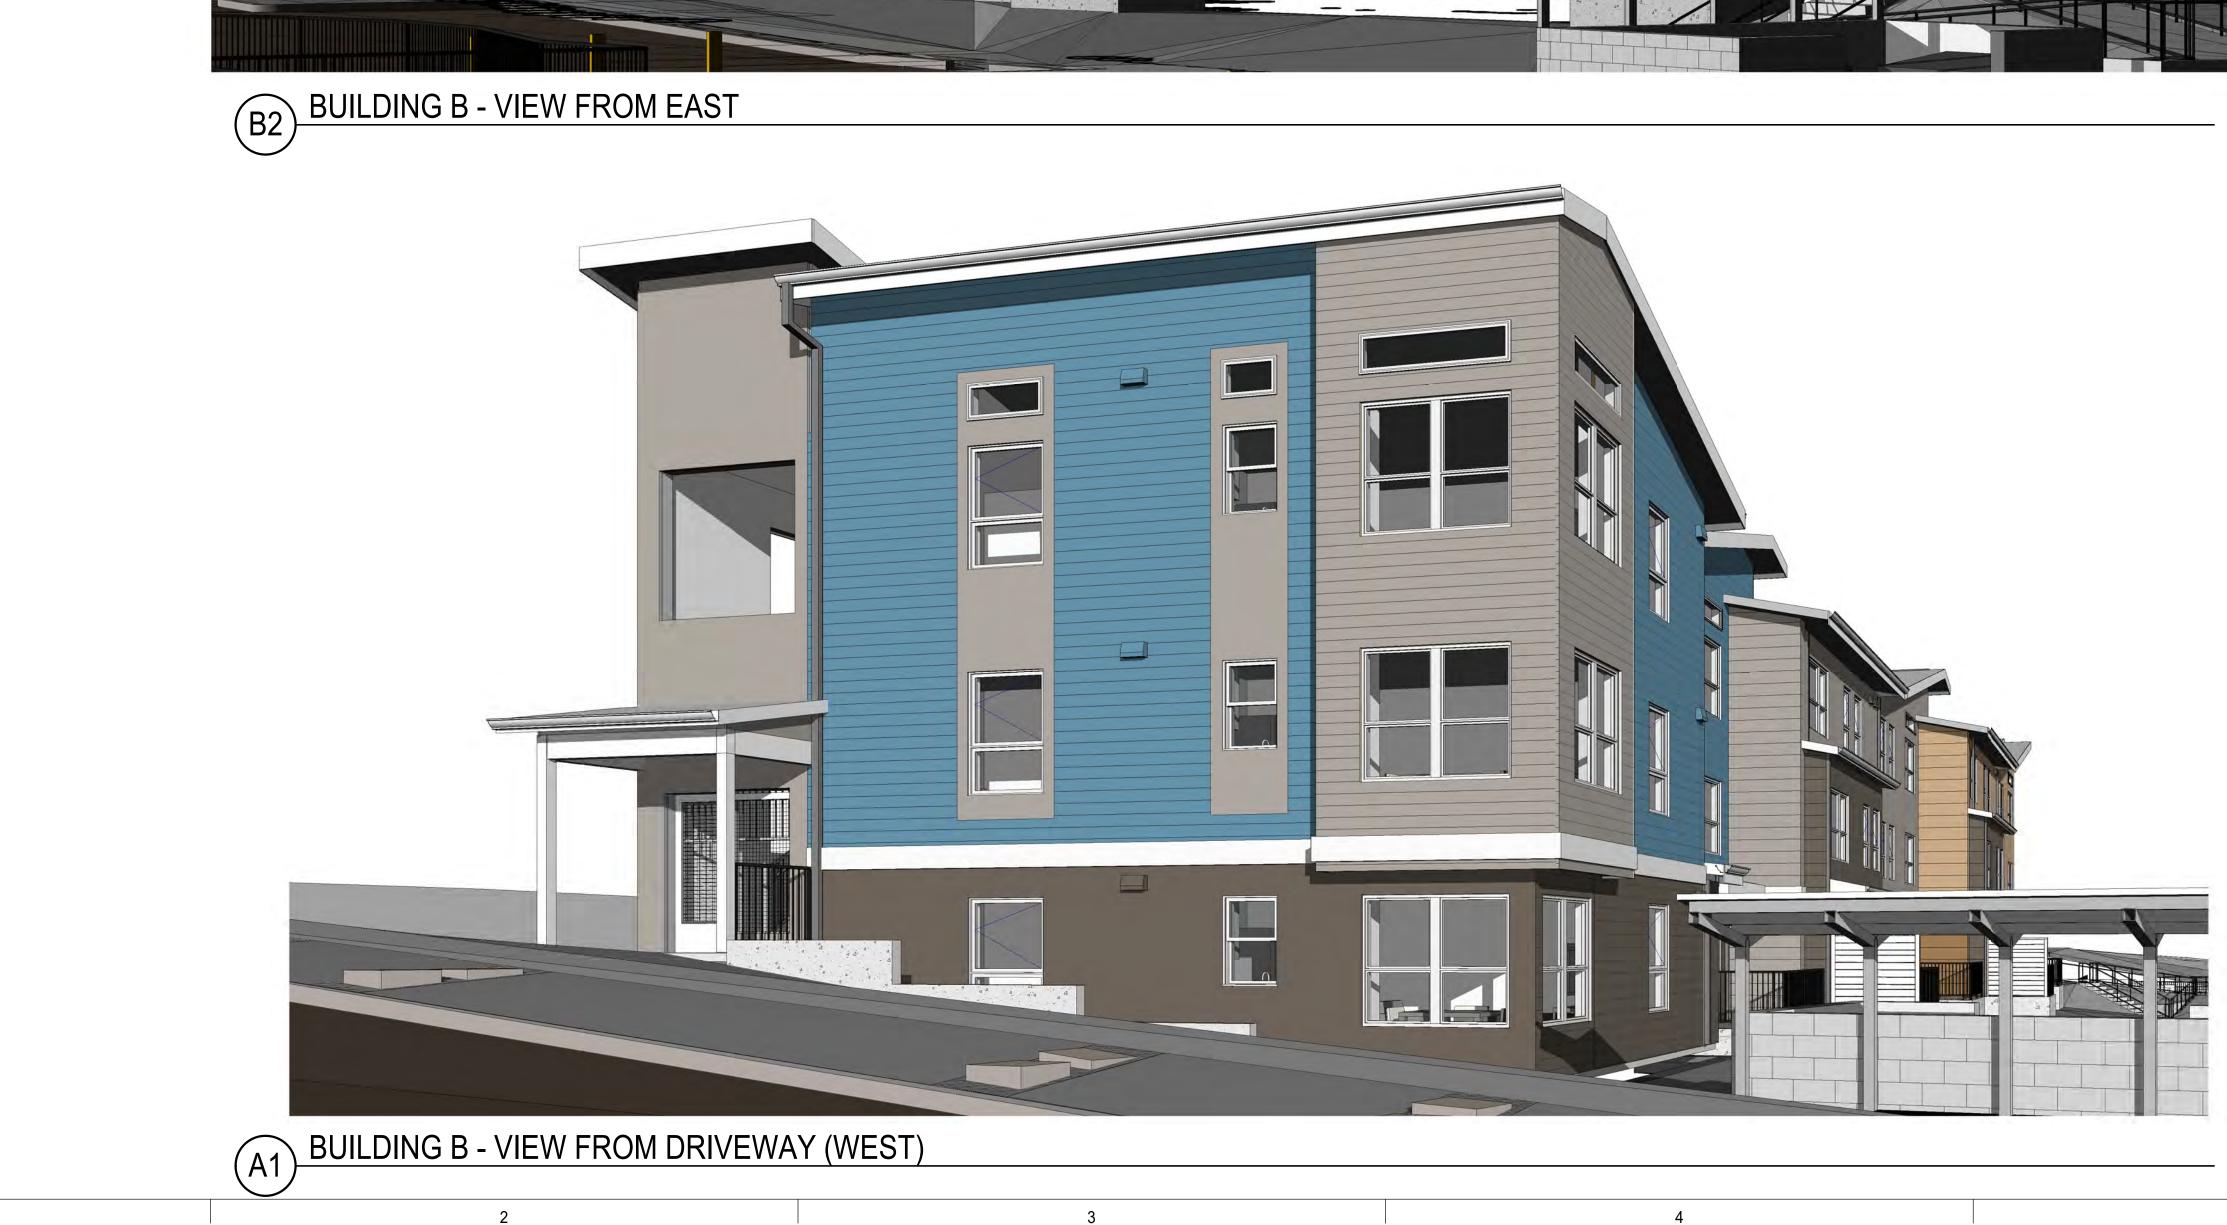
http://www.gglo.com



**AB-401** 







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FUTURE PHASE
REGISTERED ARCHITECT JONATHAN F HALL STATE OF WASHINGTON
PROJECT: EHA BAKER HEIGHTS EVERETT HOUSING AUTHORITY
PROJECT ADDRESS: BUILDING A: 2710 14th STREET BUILDING B: 2715 15th STREET BUILDING C: 2815 15th STREET BUILDING D: 2810 14th STREET EVERETT, WA 98201 OWNER: EVERETT HOUSING AUTHORITY 3107 COLBY AVENUE EVERETT, WASHINGTON 98201
MARK DATE DESCRIPTION REVISIONS
C06/22/2020BUILDING PERMIT SUBMITTAL / HUD SUBMITTALB04/10/2020DESIGN DEVELOPMENTA01/07/2020SCHEMATIC DESIGNMARKDATEDESCRIPTIONISSUE INFORMATION
PROJECT NO.: 2017033 GGLO PRINCIPAL IN CHARGE: Jon Hall GGLO PROJECT MANAGER: Scott Schreffler OWNER APPROVAL: SHEET TITLE
BUILDING B - 3D REPRESENTATIONS

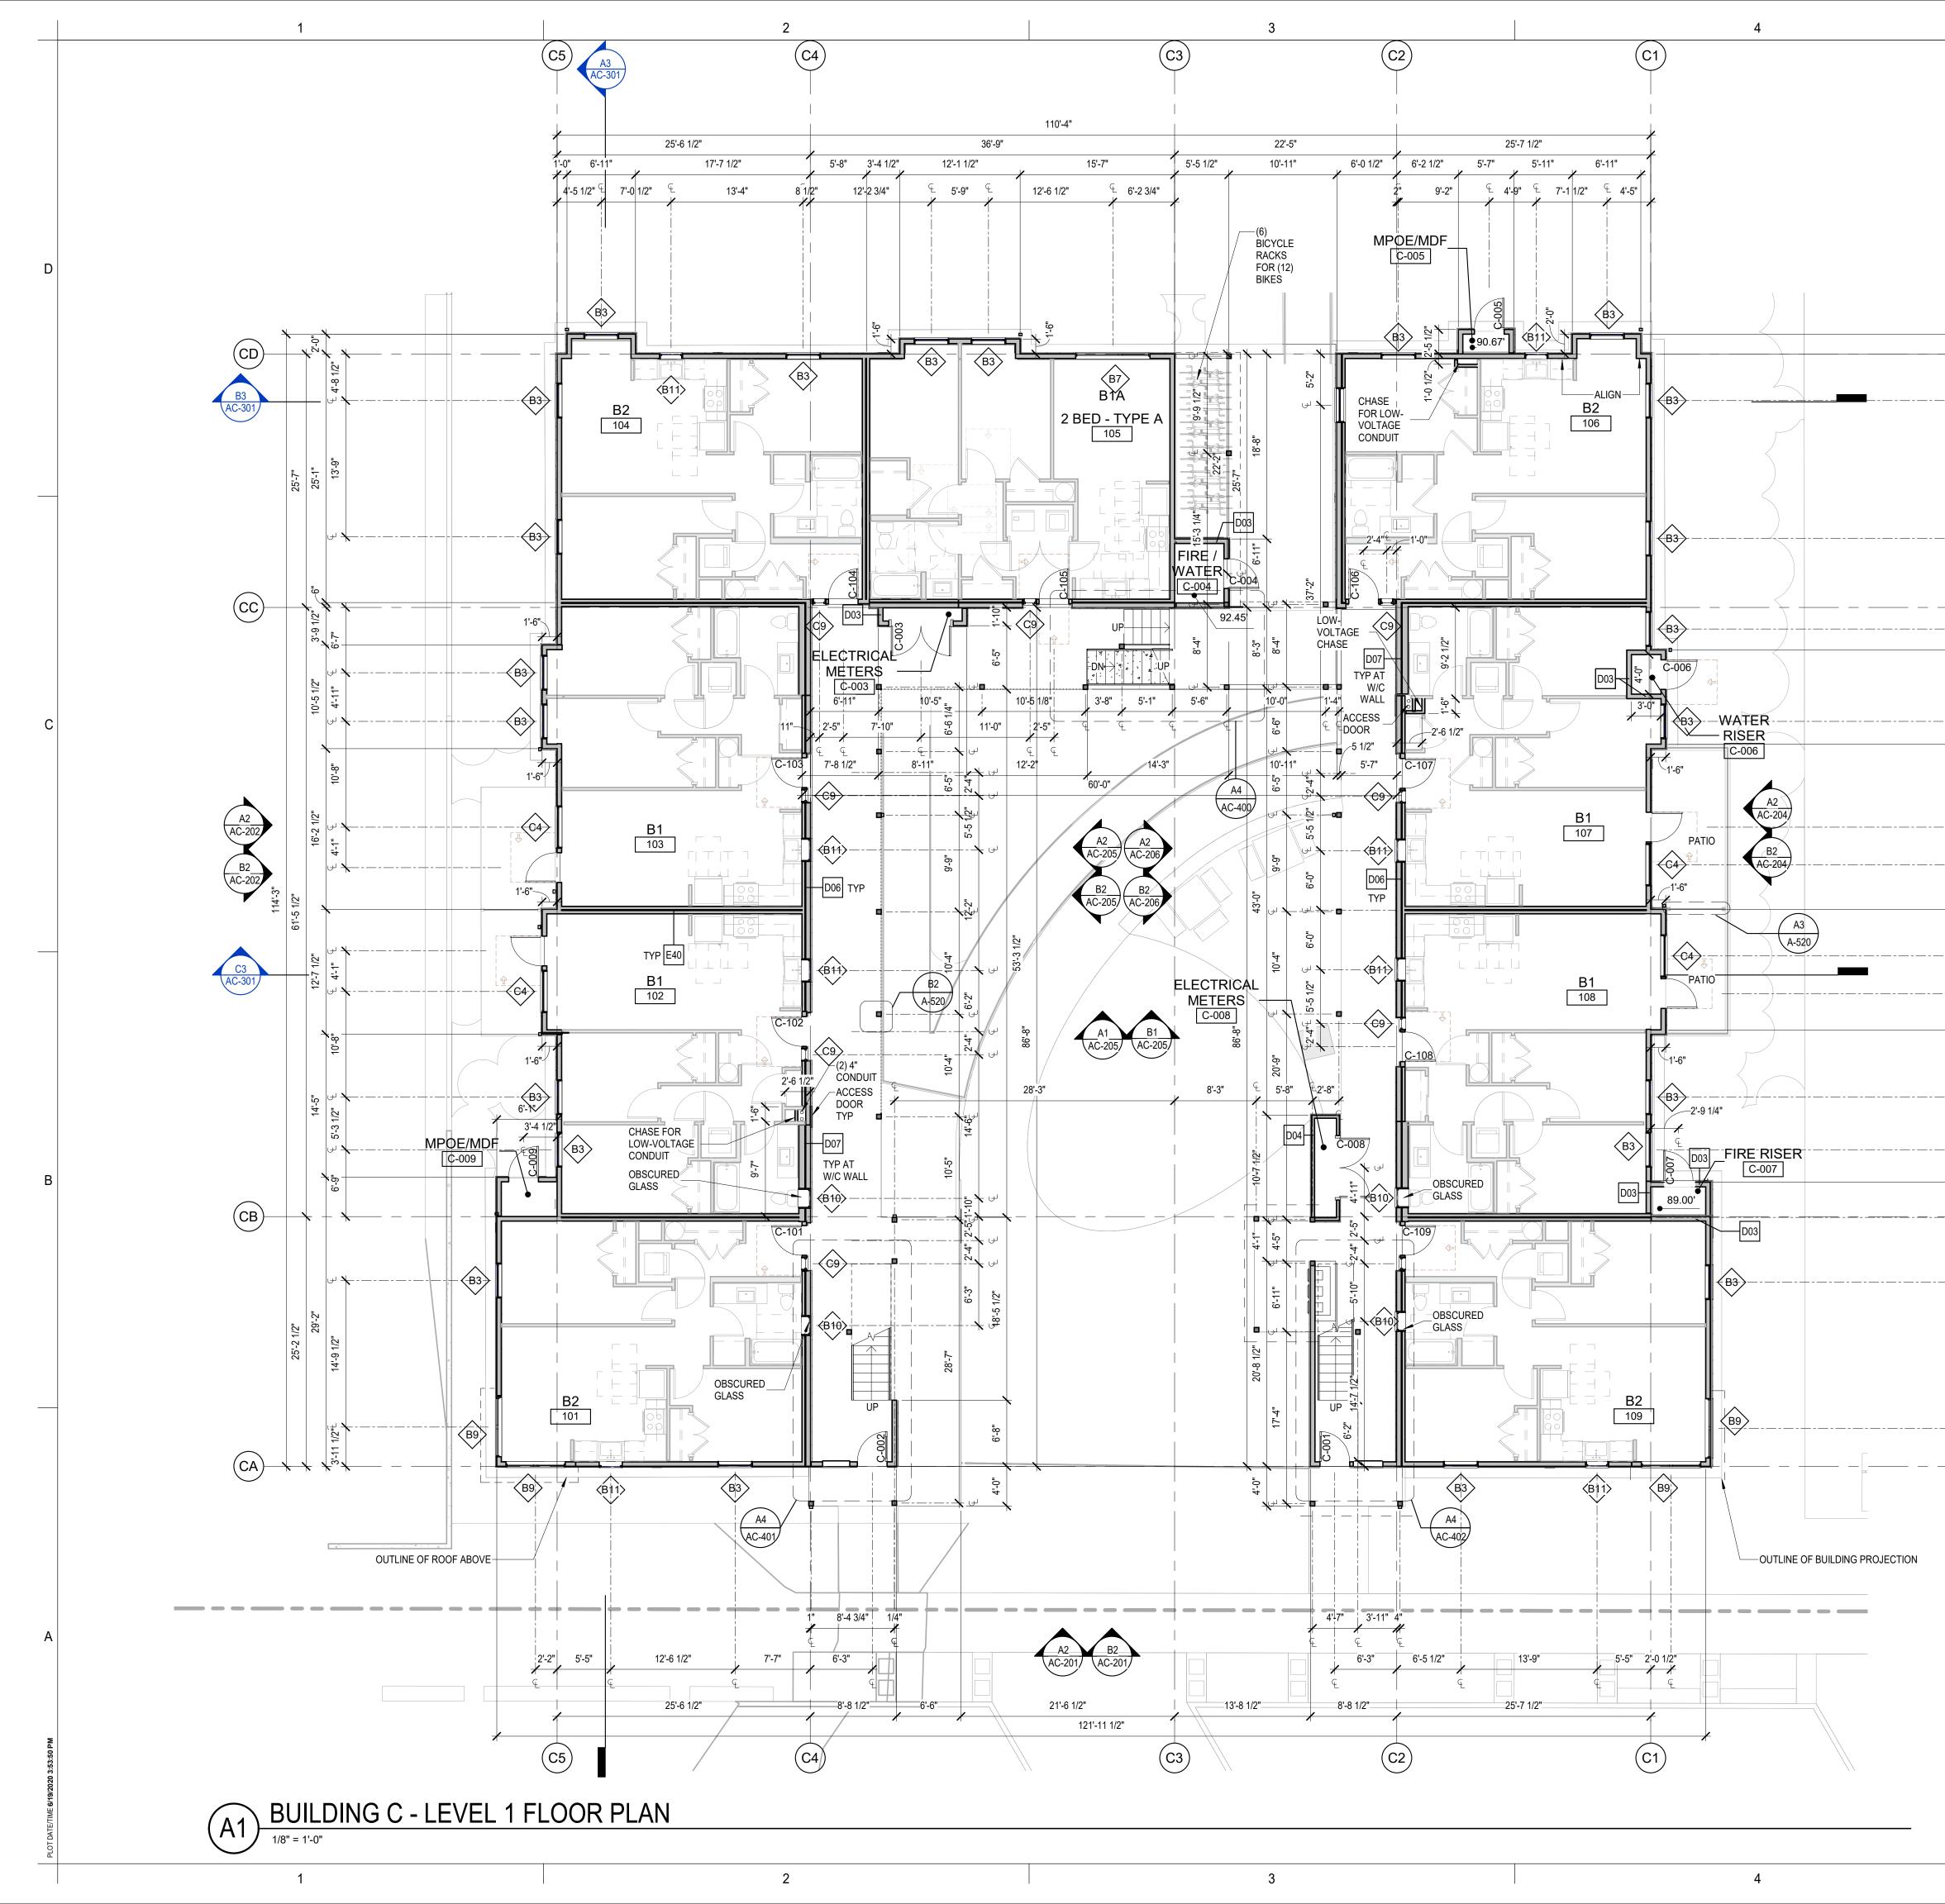
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SHEET NO.

**AB-700** 



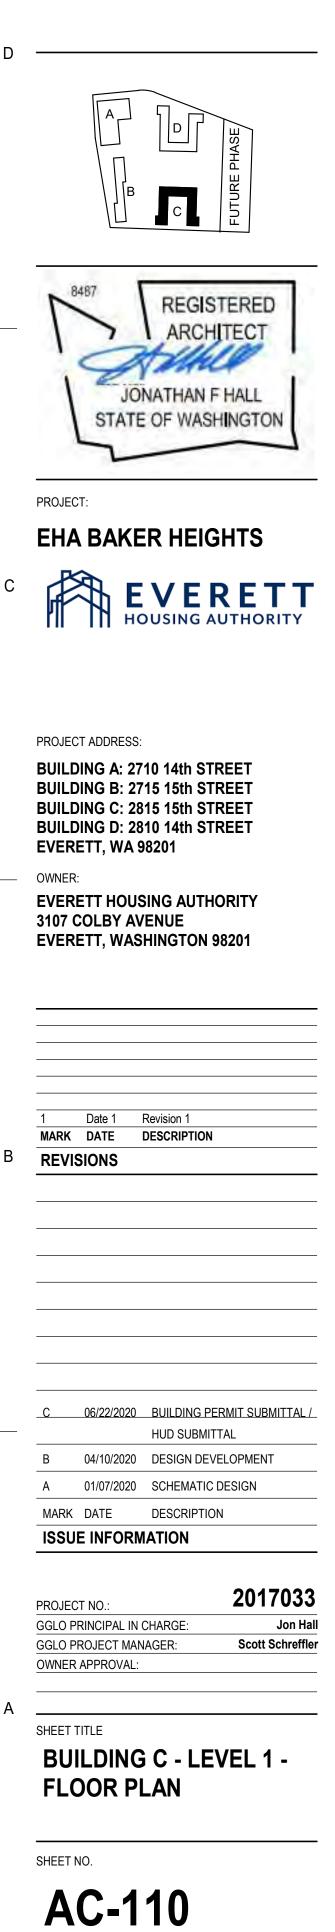
# GENERAL FLOOR PLAN NOTES

- 1. PLAN DIMENSIONS ARE TO FACE OF STUD, FACE OF CONCRETE WALL, CENTERLINE OF COLUMN, OR CENTERLINE OF ROUGH OPENINGS, UON. CONTACT ARCHITECT FOR CLARIFICATIONS.
- 2. DOORS AND CASED OPENINGS INDICATED ADJACENT TO WALL INTERSECTIONS SHALL BE LOCATED WITH THE EDGE OF FINISH OPENING SIX INCHES FROM THE ADJACENT WALL AT THE EXTERIOR AND FOUR INCHES FROM THE ADJACENT WALL.
- 3. SEE SHEET A-540 & A-620 FOR WINDOW LEGEND AND DETAILS.
- 4. SEE SHEET A-545 & A-615 FOR DOOR SCHEDULE AND DETAILS.
- 5. SEE SHEET A-605 FOR WALL ASSEMBLIES.
- INSTALL BLOCKING FOR GRAB BARS IN ALL BATHROOM WALLS SURROUNDING WATER CLOSET, BATHTUB AND SHOWER. REF A-501.
- HANDRAILS SHALL RETURN TO A WALL, GUARD OR THE WALKING SURFACE OR SHALL BE CONTINUOUS TO THE HANDRAIL OF AN ADJACENT STAIR FLIGHT OR RAMP RUN - PER IBC 1012.5.
- CONTRACTOR SHALL INSTALL FURRING, SHIMS AND ADDITIONAL LAYERS OF GYPSUM BOARD AS NECESSARY TO ACHIEVE FLUSH FINISH WHERE SURFACES OF ADJACENT WALL OR SHAFT ASSEMBLIES ARE NOT, BUT ARE INTENDED TO BE, ALIGNED.
- SEE SHEETS A-190 THROUGH A-193 FOR TYPICAL UNIT PLANS ENLARGED.

<b>BUILDING C - UNIT COUNT</b>			
NAME	UNIT TYPE	NUMBER OF UNITS	
1	2 BED - STANDARD	12	
1A	2 BED - TYPE A	1	
2	2 BED - CORNER	10	
OTAL		23	

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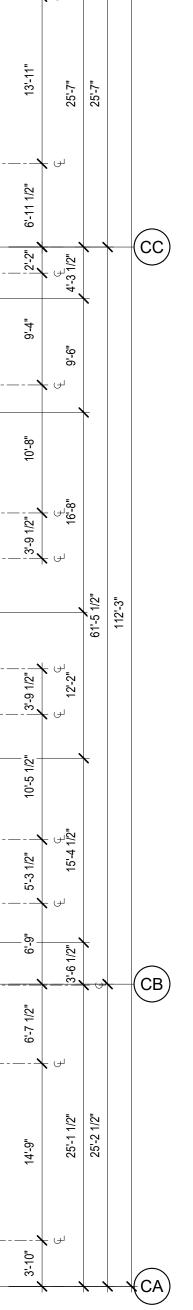


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BUILDING PERMIT SUBMITTAL / HUD SUBMI

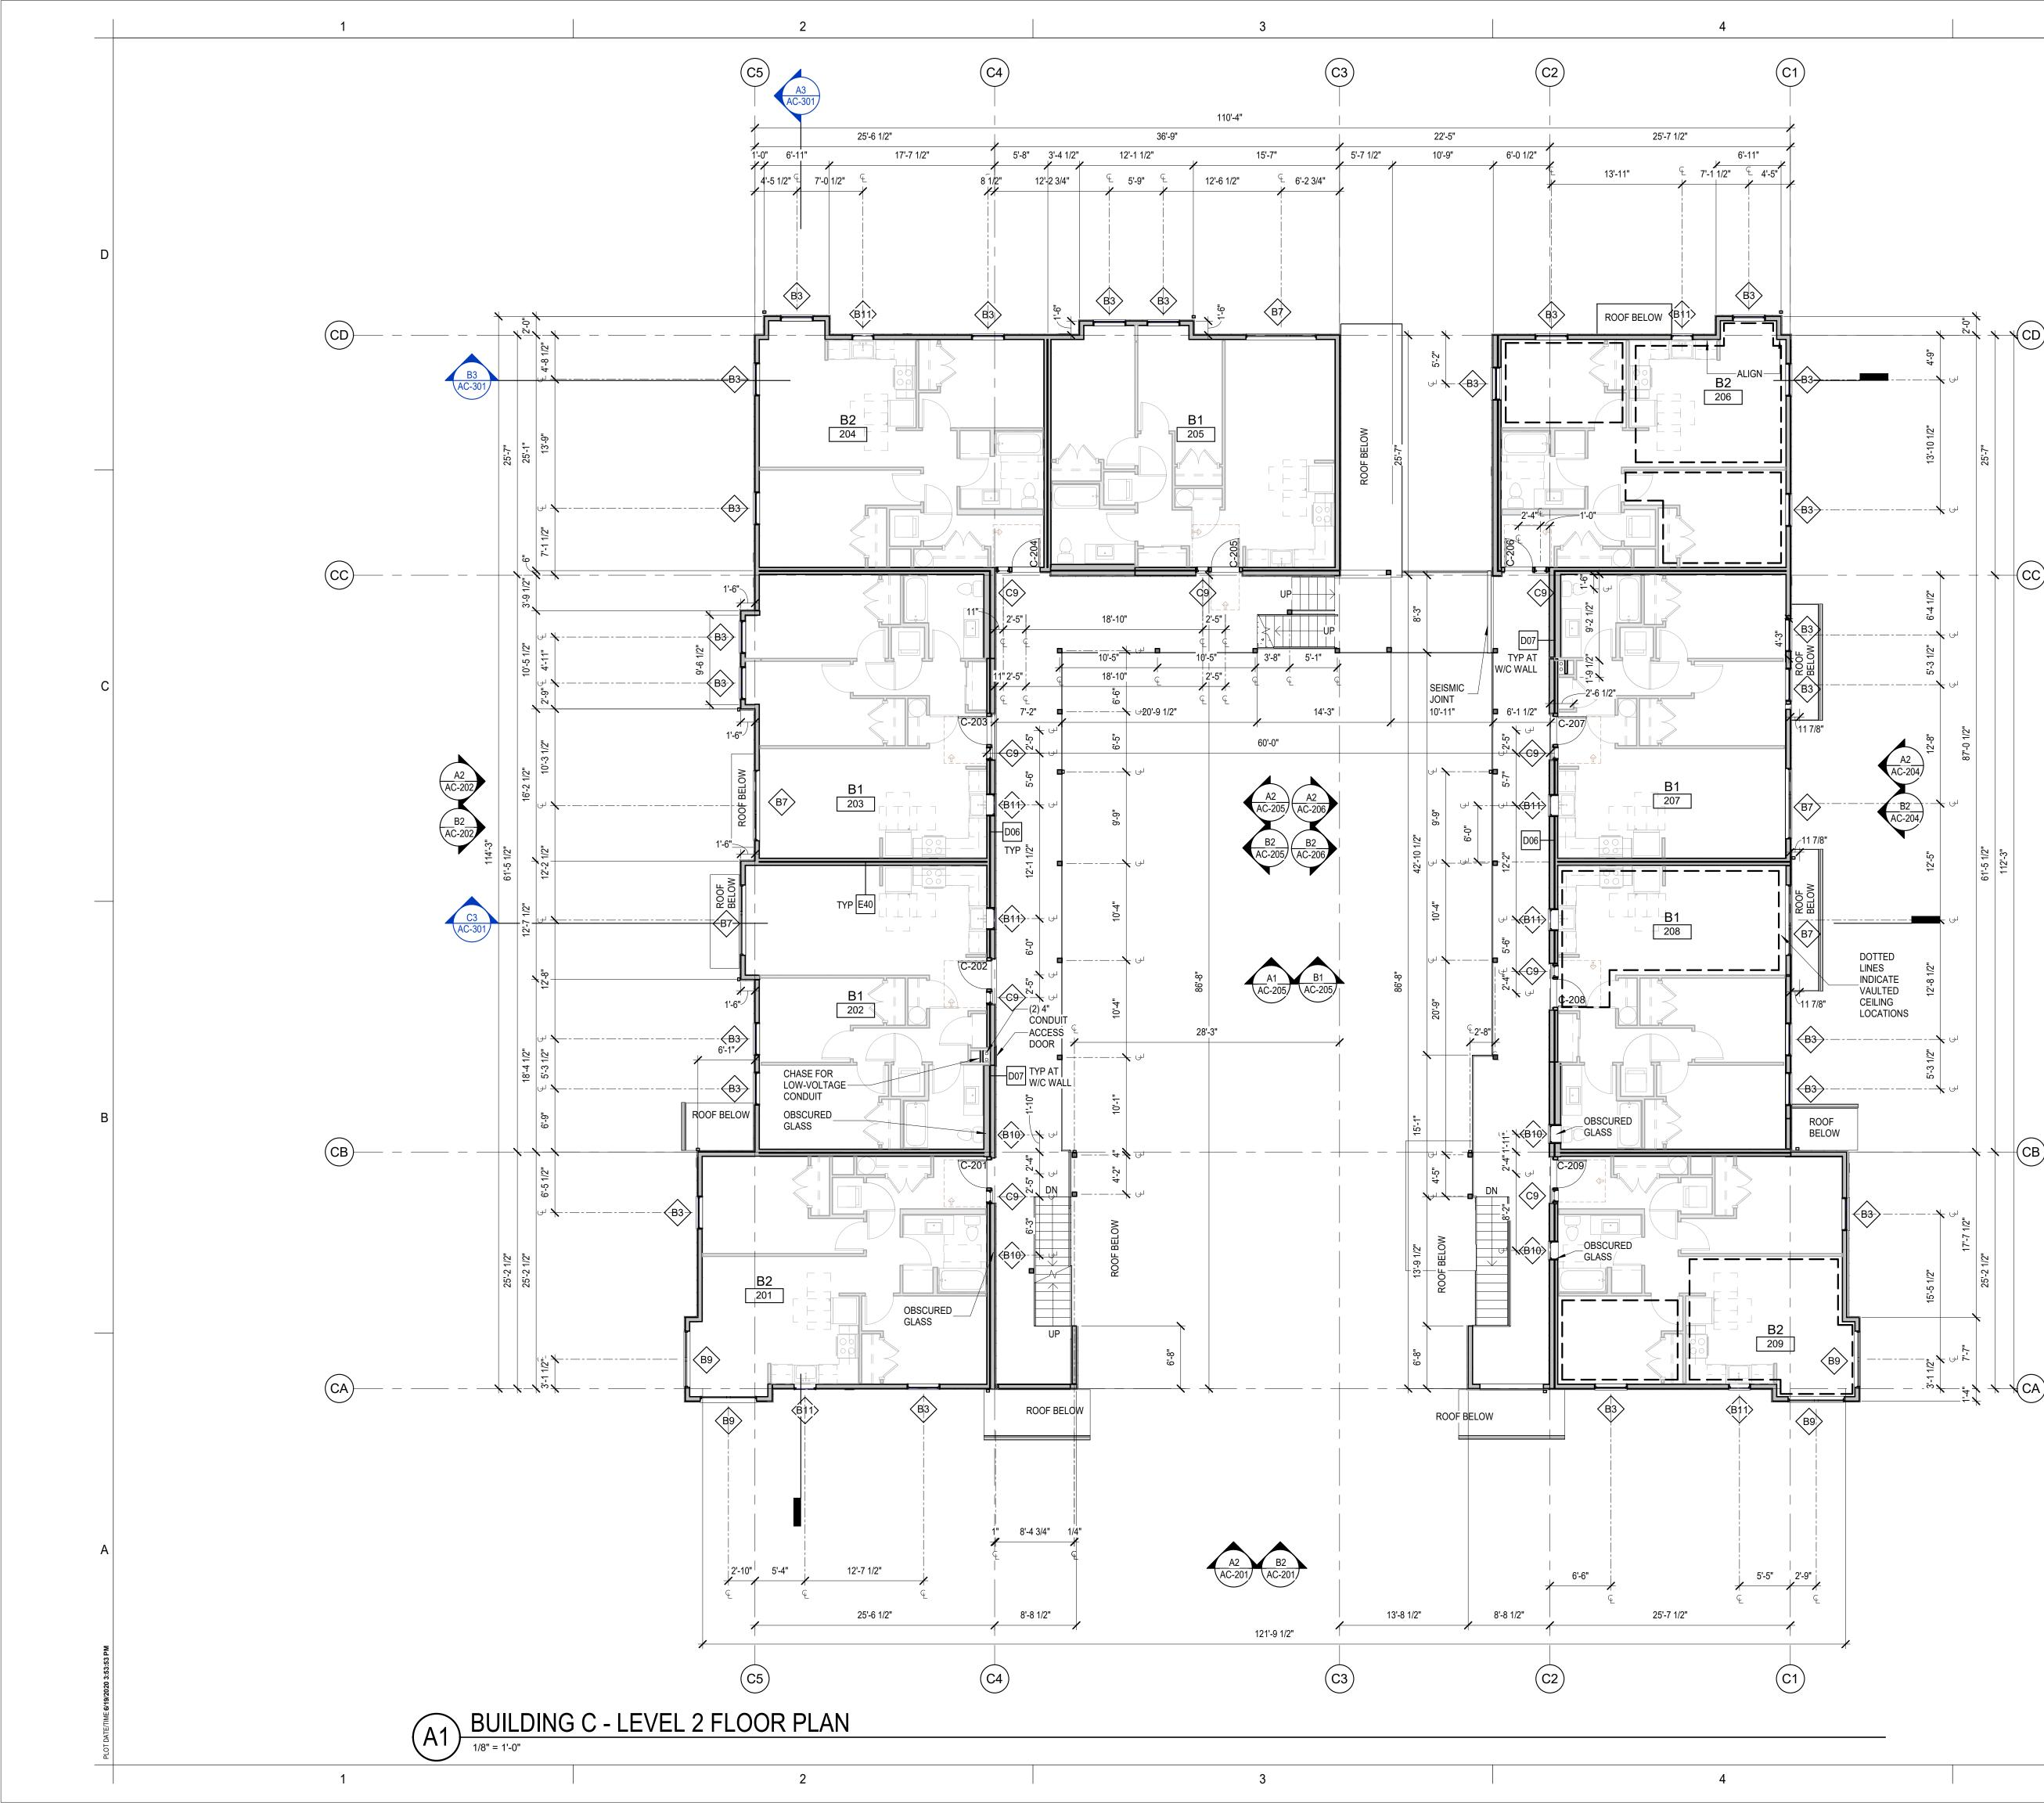
4'

PLAN NORTH



—**∜**CD)

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### GENERAL FLOOR PLAN NOTES

- 1. PLAN DIMENSIONS ARE TO FACE OF STUD, FACE OF CONCRETE WALL, CENTERLINE OF COLUMN, OR CENTERLINE OF ROUGH OPENINGS, UON. CONTACT ARCHITECT FOR CLARIFICATIONS.
- DOORS AND CASED OPENINGS INDICATED ADJACENT 2 TO WALL INTERSECTIONS SHALL BE LOCATED WITH THE EDGE OF FINISH OPENING SIX INCHES FROM THE ADJACENT WALL AT THE EXTERIOR AND FOUR INCHES FROM THE ADJACENT WALL.
- SEE SHEET A-540 & A-620 FOR WINDOW LEGEND AND 3. DETAILS.
- 4. SEE SHEET A-545 & A-615 FOR DOOR SCHEDULE AND DETAILS.
- SEE SHEET A-605 FOR WALL ASSEMBLIES.

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PLAN NORTH

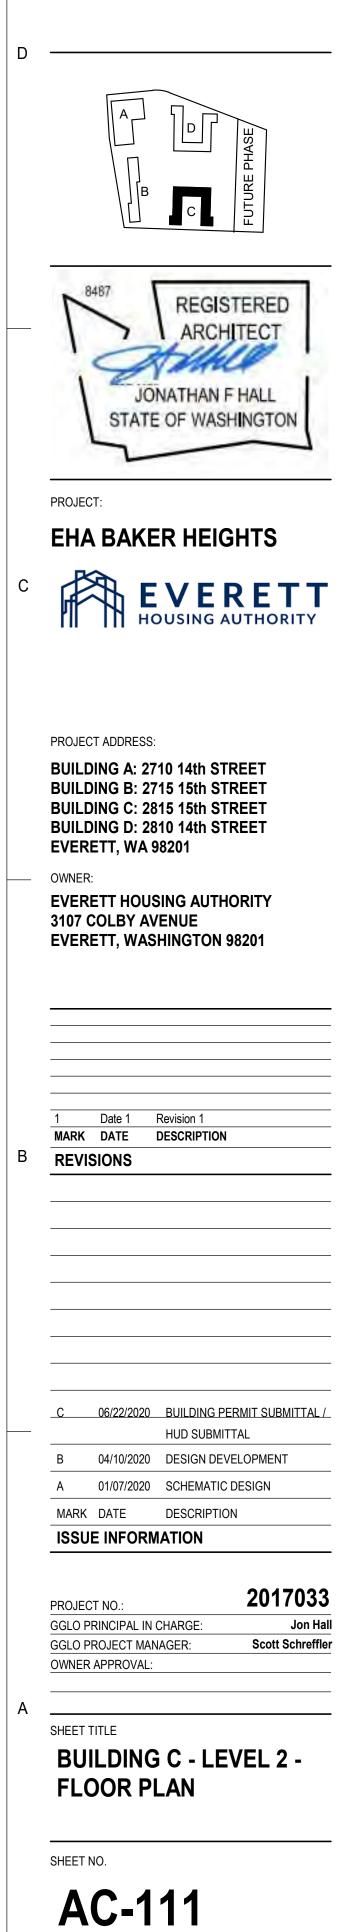
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- INSTALL BLOCKING FOR GRAB BARS IN ALL BATHROOM WALLS SURROUNDING WATER CLOSET, BATHTUB AND SHOWER. REF A-501.
- HANDRAILS SHALL RETURN TO A WALL, GUARD OR THE WALKING SURFACE OR SHALL BE CONTINUOUS TO THE HANDRAIL OF AN ADJACENT STAIR FLIGHT OR RAMP RUN - PER IBC 1012.5.
- CONTRACTOR SHALL INSTALL FURRING, SHIMS AND ADDITIONAL LAYERS OF GYPSUM BOARD AS NECESSARY TO ACHIEVE FLUSH FINISH WHERE SURFACES OF ADJACENT WALL OR SHAFT ASSEMBLIES ARE NOT, BUT ARE INTENDED TO BE, ALIGNED.
- SEE SHEETS A-190 THROUGH A-193 FOR TYPICAL UNIT PLANS ENLARGED.

<b>BUILDING C - UNIT COUNT</b>			
NAME	UNIT TYPE	NUMBER OF UNITS	
B1	2 BED - STANDARD	12	
B1A	2 BED - TYPE A	1	
B2	2 BED - CORNER	10	
TOTAL		23	

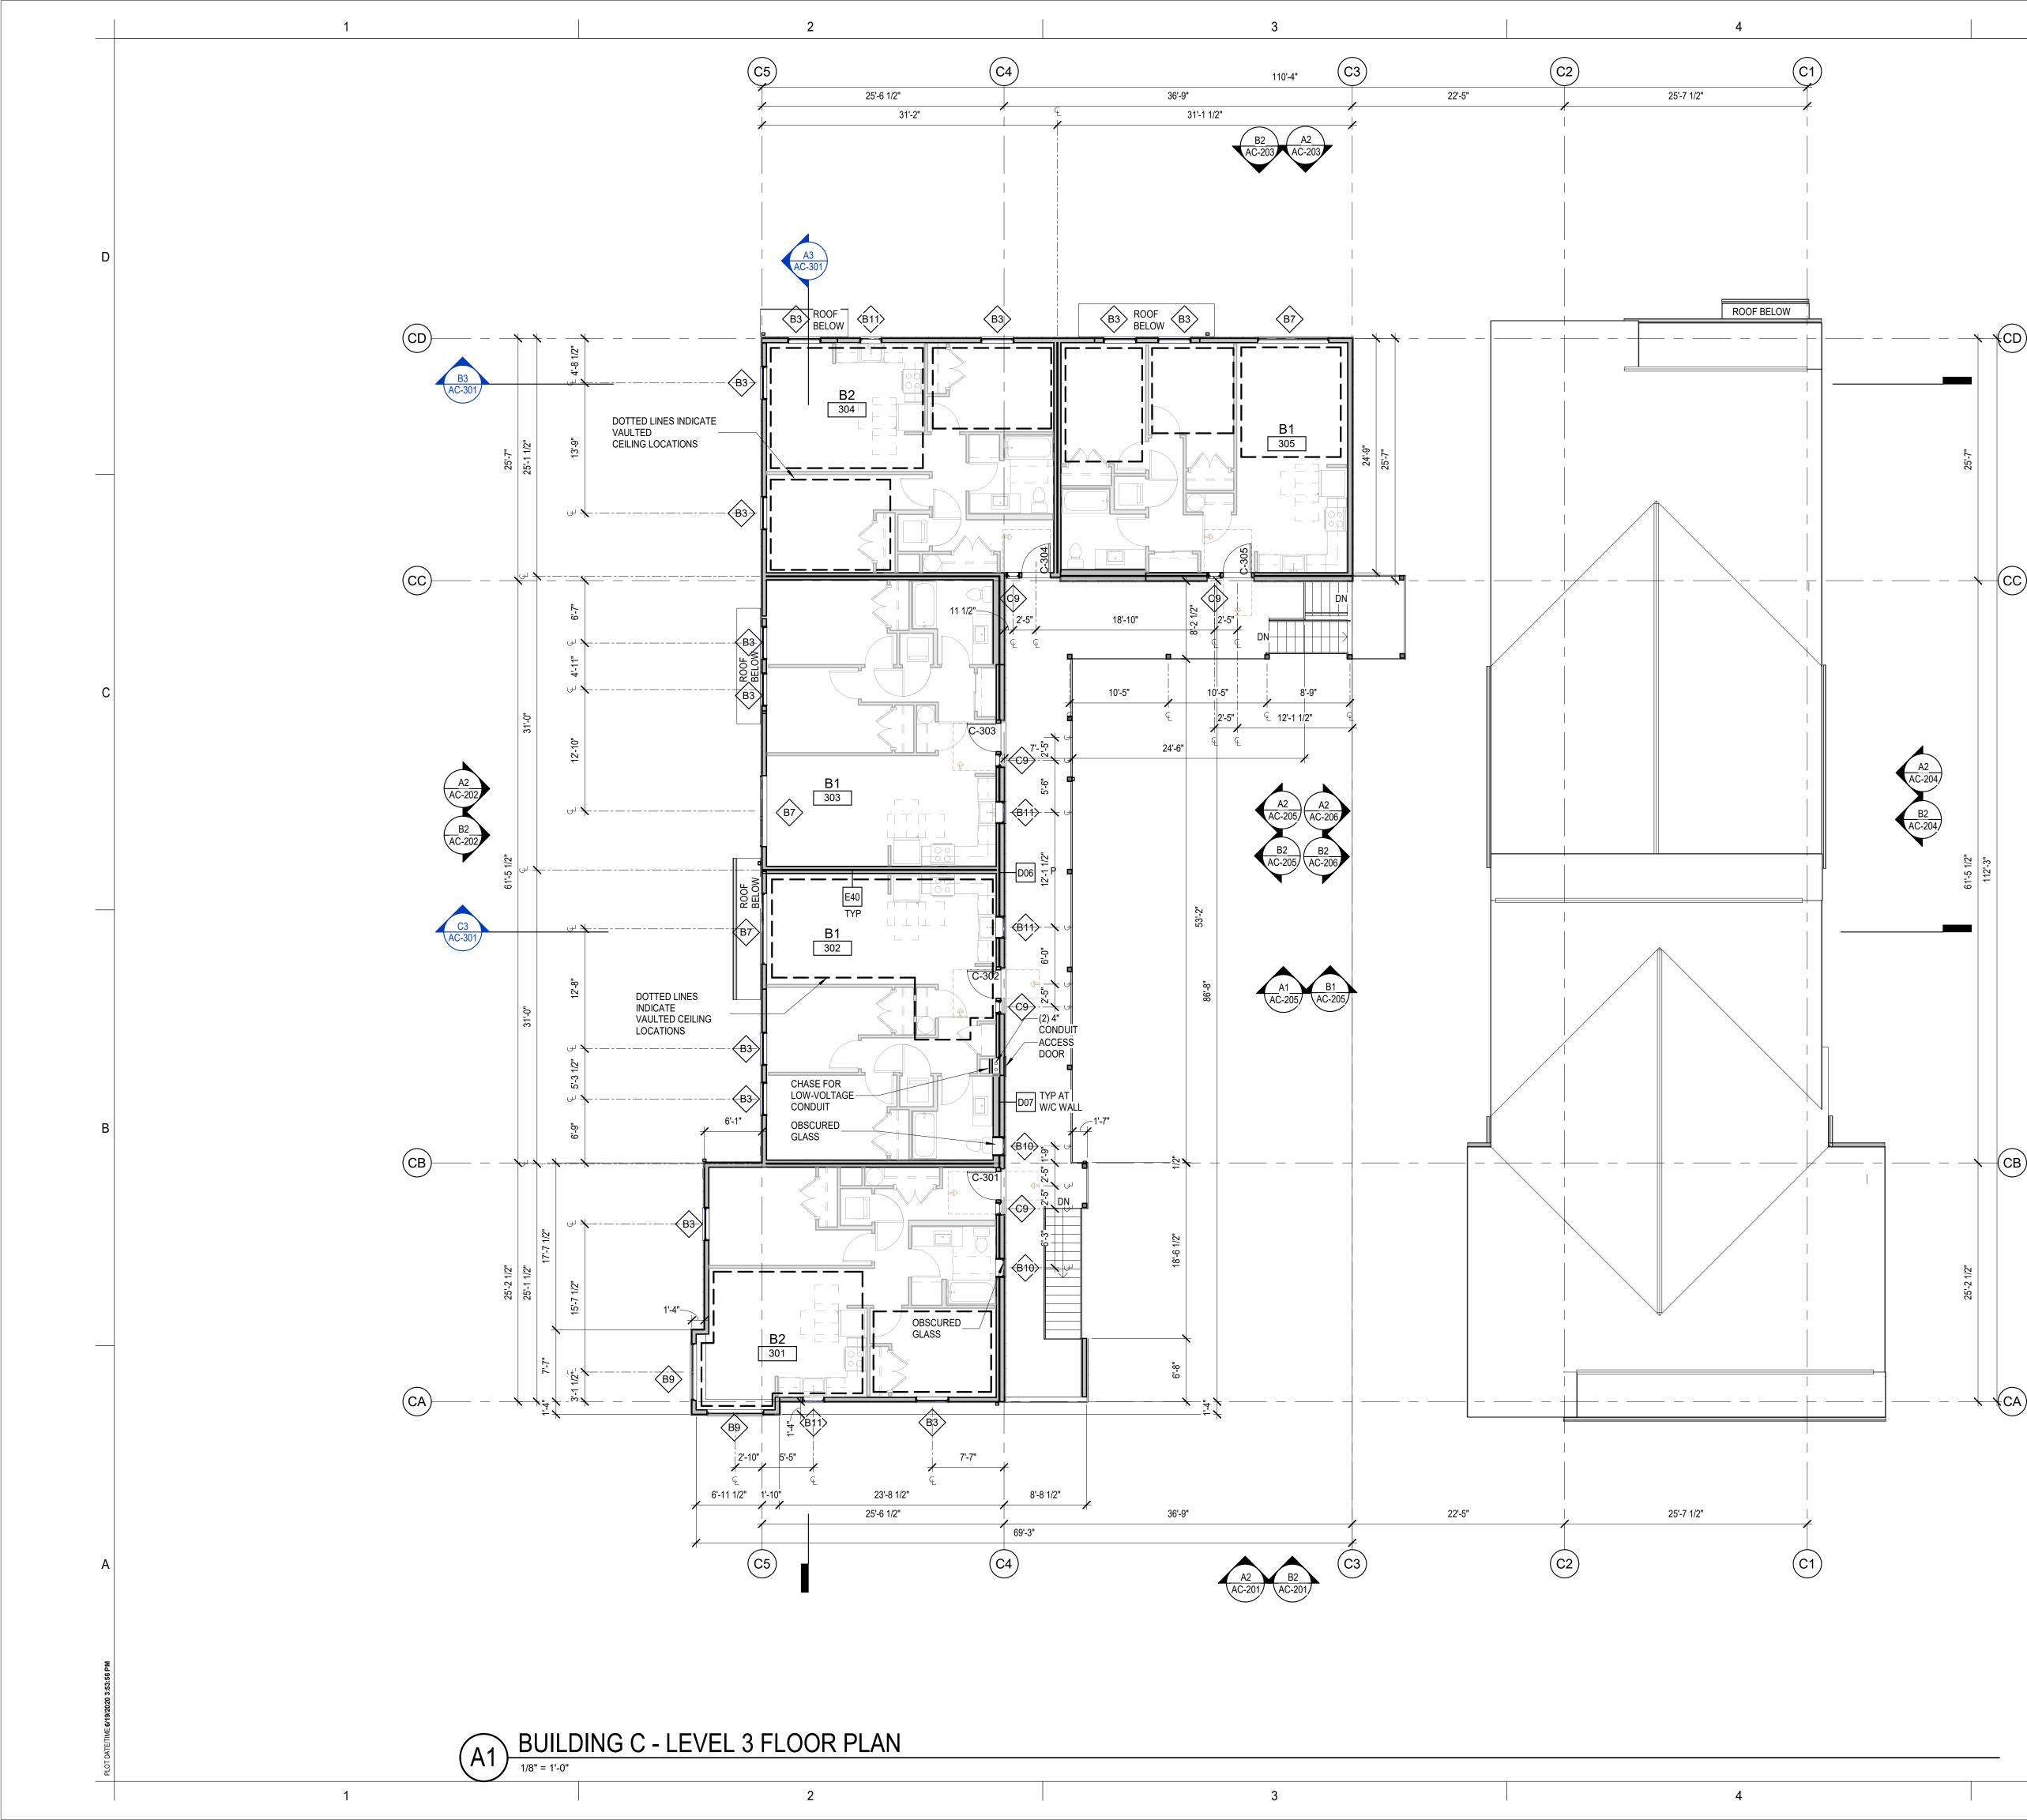
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- DOORS AND CASED OPENINGS INDICATED ADJACENT TO WALL INTERSECTIONS SHALL BE LOCATED WITH 2. THE EDGE OF FINISH OPENING SIX INCHES FROM THE ADJACENT WALL AT THE EXTERIOR AND FOUR INCHES FROM THE ADJACENT WALL.
- 3. SEE SHEET A-540 & A-620 FOR WINDOW LEGEND AND DETAILS.
- 4. SEE SHEET A-545 & A-615 FOR DOOR SCHEDULE AND DETAILS.
- 5. SEE SHEET A-605 FOR WALL ASSEMBLIES.

6.

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PLAN NORTH

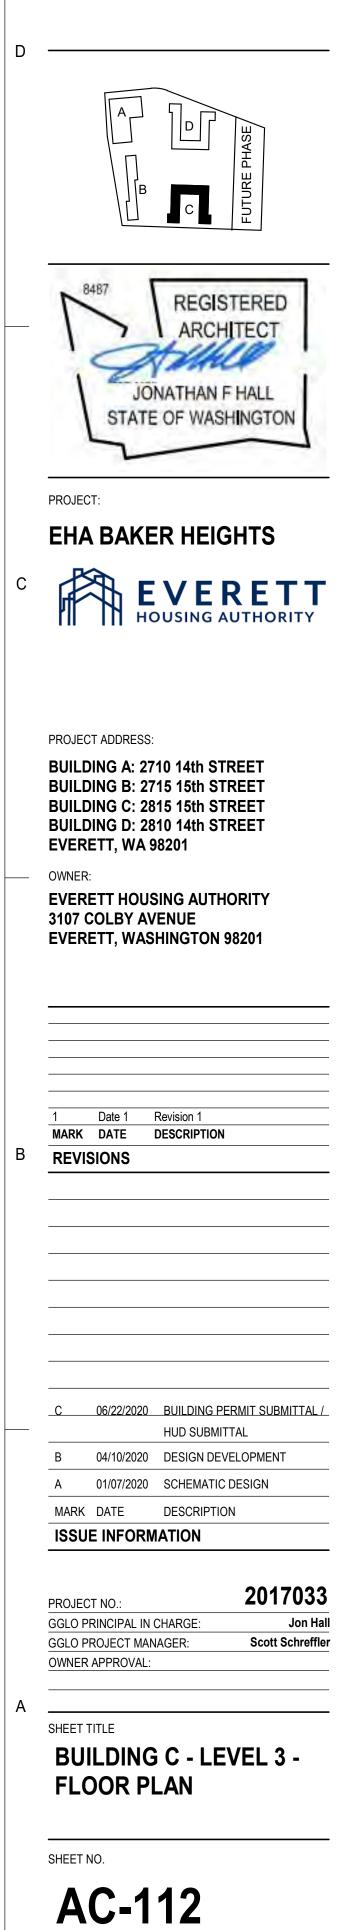
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- INSTALL BLOCKING FOR GRAB BARS IN ALL BATHROOM WALLS SURROUNDING WATER CLOSET, BATHTUB AND SHOWER. REF A-501.
- HANDRAILS SHALL RETURN TO A WALL, GUARD OR 7. THE WALKING SURFACE OR SHALL BE CONTINUOUS TO THE HANDRAIL OF AN ADJACENT STAIR FLIGHT OR RAMP RUN - PER IBC 1012.5. CONTRACTOR SHALL INSTALL FURRING, SHIMS AND 8. ADDITIONAL LAYERS OF GYPSUM BOARD AS NECESSARY TO ACHIEVE FLUSH FINISH WHERE
- SURFACES OF ADJACENT WALL OR SHAFT ASSEMBLIES ARE NOT, BUT ARE INTENDED TO BE, ALIGNED.
- 9. SEE SHEETS A-190 THROUGH A-193 FOR TYPICAL UNIT PLANS ENLARGED.

<b>BUILDING C - UNIT COUNT</b>			
NAME	UNIT TYPE	NUMBER OF UNITS	
B1	2 BED - STANDARD	12	
B1A	2 BED - TYPE A	1	
B2	2 BED - CORNER	10	
TOTAL	•	23	

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SUBMI HUD m S PER BUILDING

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REQUIRED

AREA -

2.7 SF

0.7 SF

0.1 SF

0.1 SF

0.1 SF

0.0 SF

0.1 SF

0.6 SF

0.0 SF

0.0 SF

0.0 SF

0.1 SF

0.1 SF

0.2 SF

AREA

1,975 SF 6.6 SF

1,905 SF 6.3 SF

1,795 SF 6.0 SF

2,057 SF 6.9 SF

223 SF

25 SF

17 SF

16 SF

15 SF

19 SF

190 SF

15 SF

14 SF

15 SF

18 SF

22 SF

821 SF

NAME

ROOF

AREA A

ROOF

AREA B

ROOF

AREA C ROOF

AREA D

ROOF

AREA E

ROOF

AREA F

ROOF

AREA G ROOF

AREA H

ROOF

AREA I

ROOF

AREA J

ROOF

AREA L

ROOF

AREA M ROOF

AREA K ROOF

% OF % OF

REQ'D TOTAL

89%

68%

176%

71%

40%

10%

VENTING VENT

VENT PROVIDED 3' ABOVE AREA 3'

99%

173%

82%

69%

72%

151%

VENT

1/300 AREA

3.0 SF

7.0 SF

6.9 SF

5.4 SF

6.9 SF

0.9 SF

0.3 SF

0.4 SF

0.4 SF

0.4 SF

0.4 SF

0.3 SF

0.2 SF

0.3 SF

0.2 SF

0.2 SF

0.2 SF

0.2 SF

PER 2015 IBC WITH WASHINGTON AMENDMENTS, SECTION 1203.2, EXCEPTION 1: THE NET FREE CROSS-VENTILATION AREA SHALL BE PERMITTED TO BE REDUCED TO 1/300 PROVIDED THAT A CLASS I OR II VAPOR RETARDER IS INSTALLED ON THE WARM-IN WINTER SIDE OF THE CEILING. AT LEAST 40% AND NOT MORE THAN 50% OF THE REQUIRED VENTING AREA IS PROVIDED BY VENTILATORS LOCATED IN THE UPPER PORTION OF THE ATTIC OR RAFTER SPACE. UPPER VENTILATORS SHALL BE LOCATED NOT MORE THAN 3 FEET BELOW THE RIDGE OR HIGHEST POINT OF THE SPACE, MEASURED VERTICALLY, WITH THE BALANCE OF THE VENTILATION PROVIDED BY EAVE OR CORNICE VENTS. WHERE THE LOCATION OF WALL OR ROOF FRAMING MEMBERS CONFLICTS WITH THE INSTALLATION OF UPPER VENTILATORS, INSTALLTION MORE THAN 3 FEET BELOW THE RIDGE OR HIGHEST POINT OF THE SPACE SHALL BE PERMITTED.

ATTIC VENTILATION - BUILDING C

EAVE

17 LF

18 LF

261F

18 LF

18 LF

18 LF

18 LF

17 I F

15 LF

191F

AREA

3 SF

3 SF

0 SF

EAVEABOVERIDGERIDGEDIAMETERVENTSEAVEVENTINGVENTINGHOLES/LF

30 LF

32 I F

45 I F

| 38 I F

138 LF

EAVE

0.0 SF

0 SF

2 SF

1 SF

1 SF

2 SF

0 SF

2

0.0 SF

1.9 SF

1.1 SF

0.8 SF 0 LF

1.5 SF 0 LF

0.4 SF 0 LF

0.0 SF 0 LF

AREA EAVE VENTING-

0.3 SF

0.4 SF

0.5 SF

0.5 SF

0.5 SF

0.2 SF

0.3 SF

0.4 SF

0.4 SF

0.4 SF

0.4 SF

0.3 SF

0.2 SF

0.3 SF

0.2 SF

0.2 SF

0.2 SF

0.2 SF

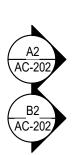
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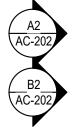
10 LF

0 LF

0 LF

0 LF

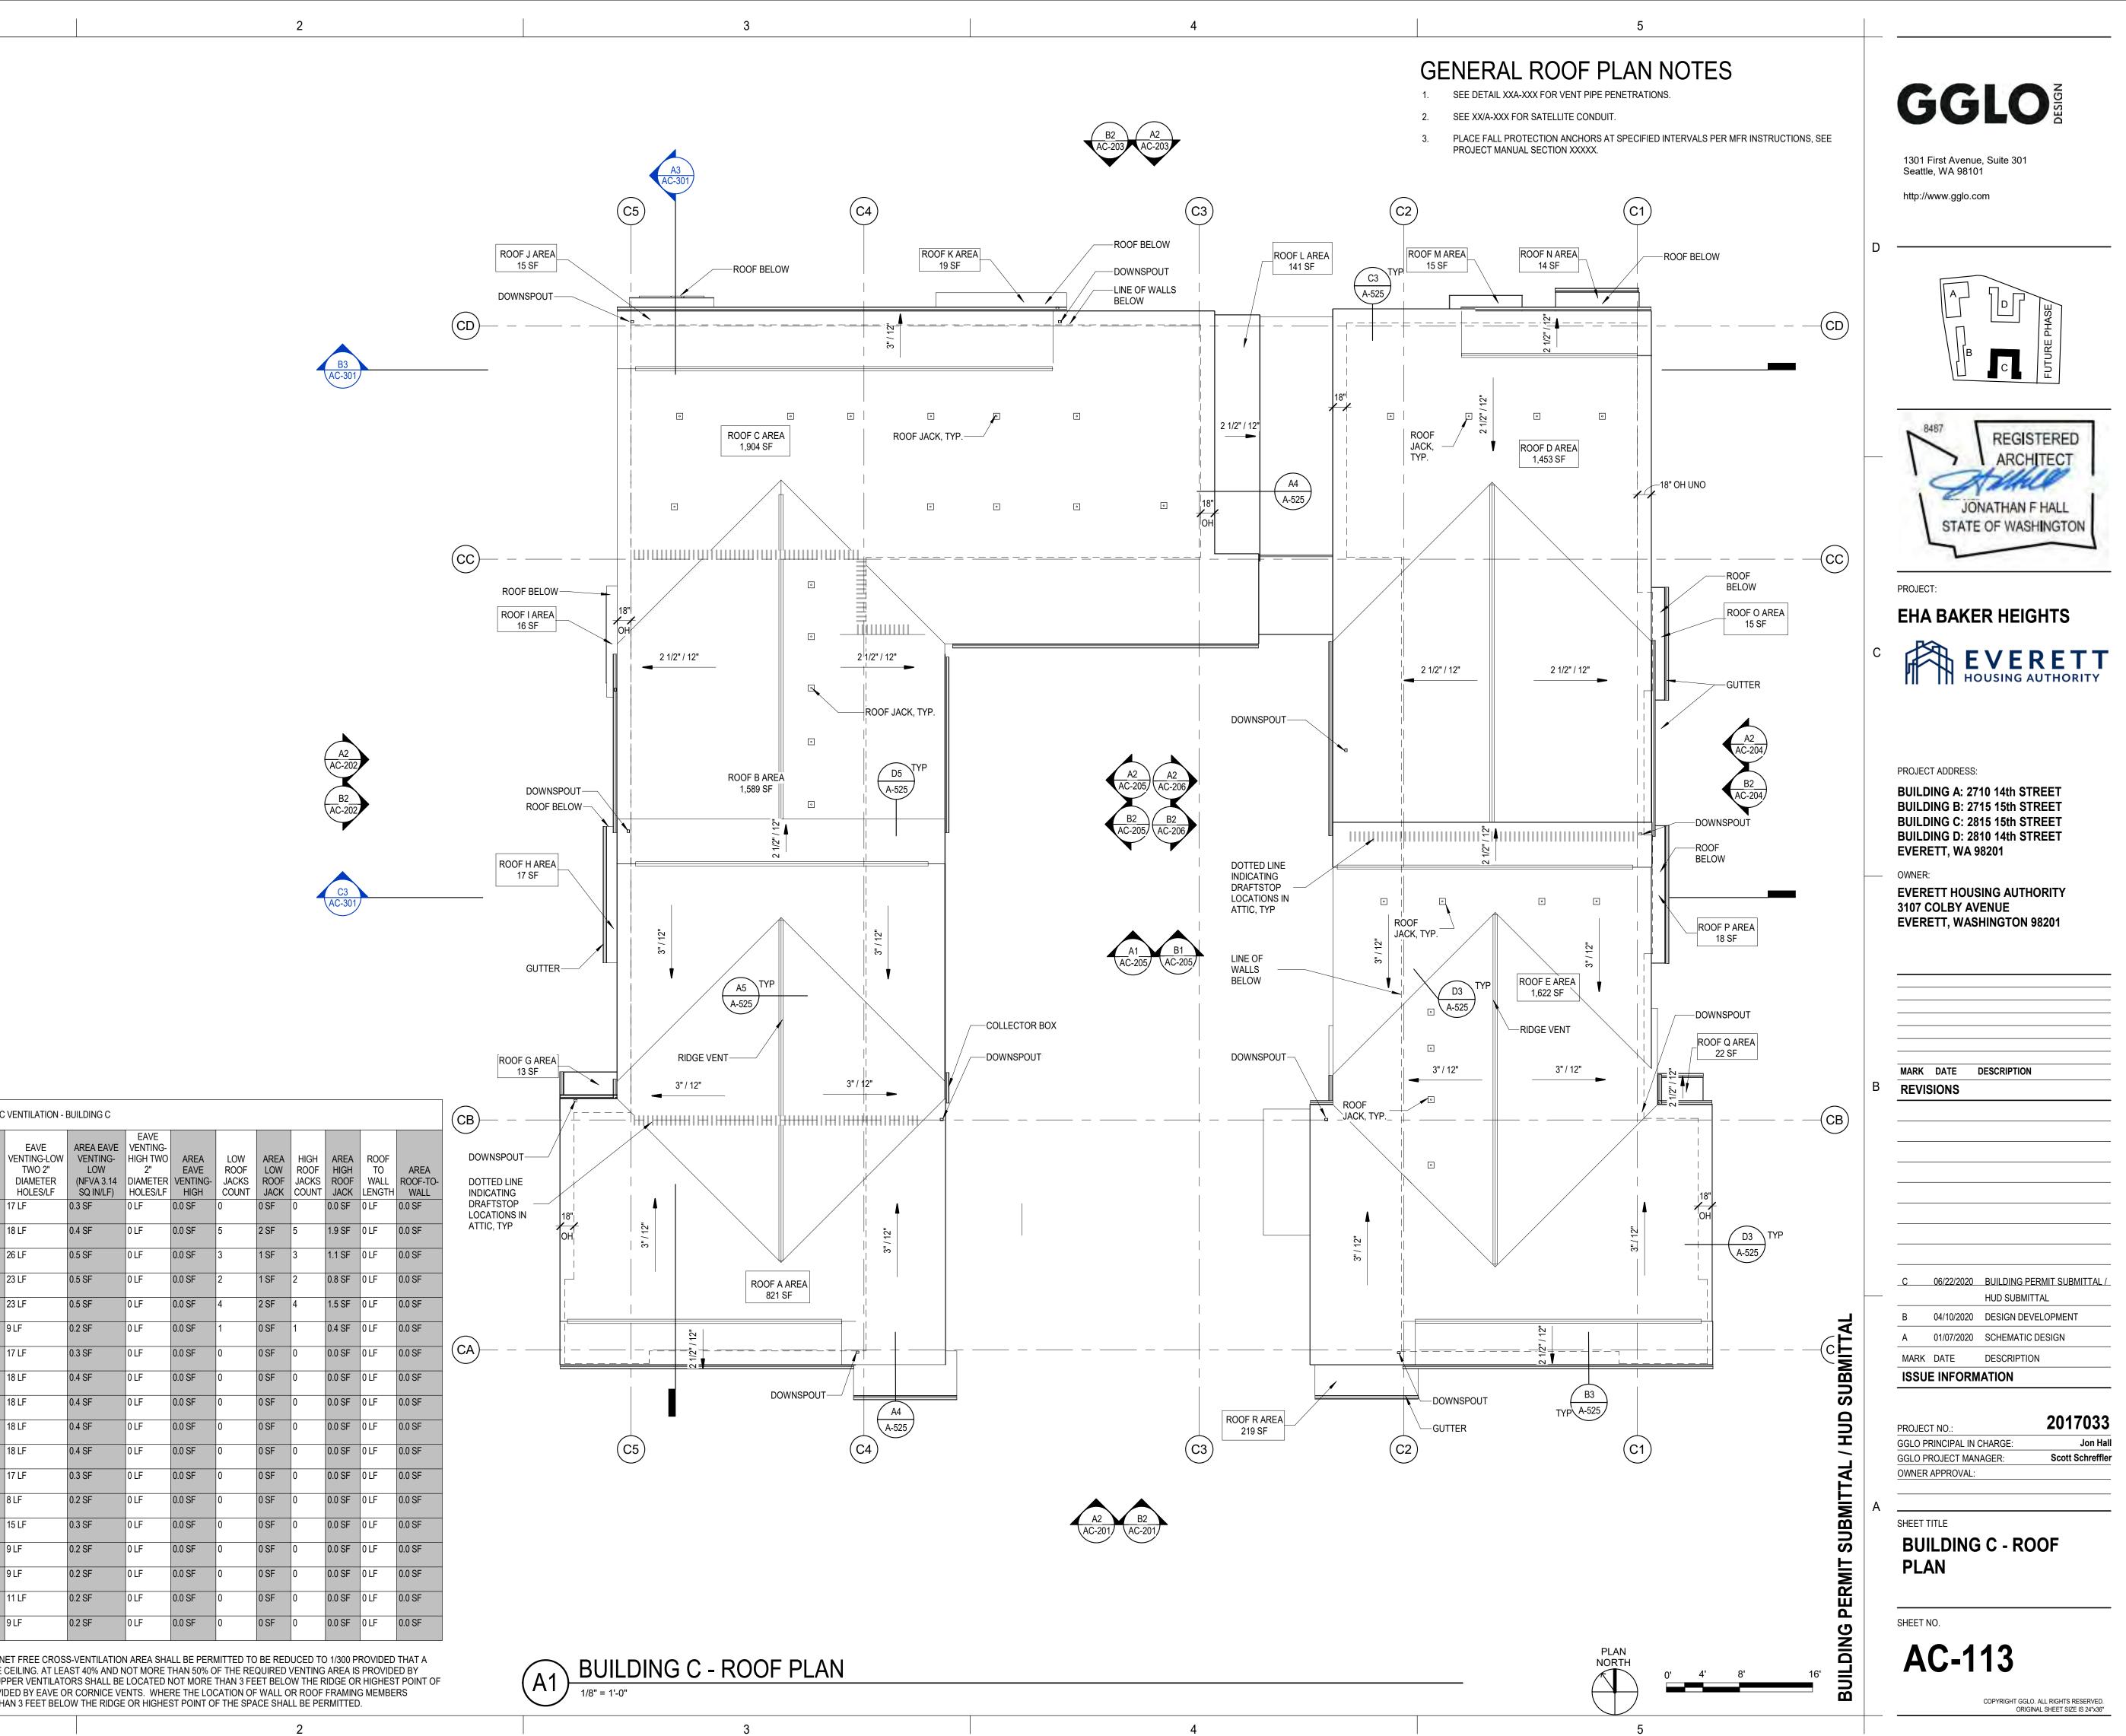


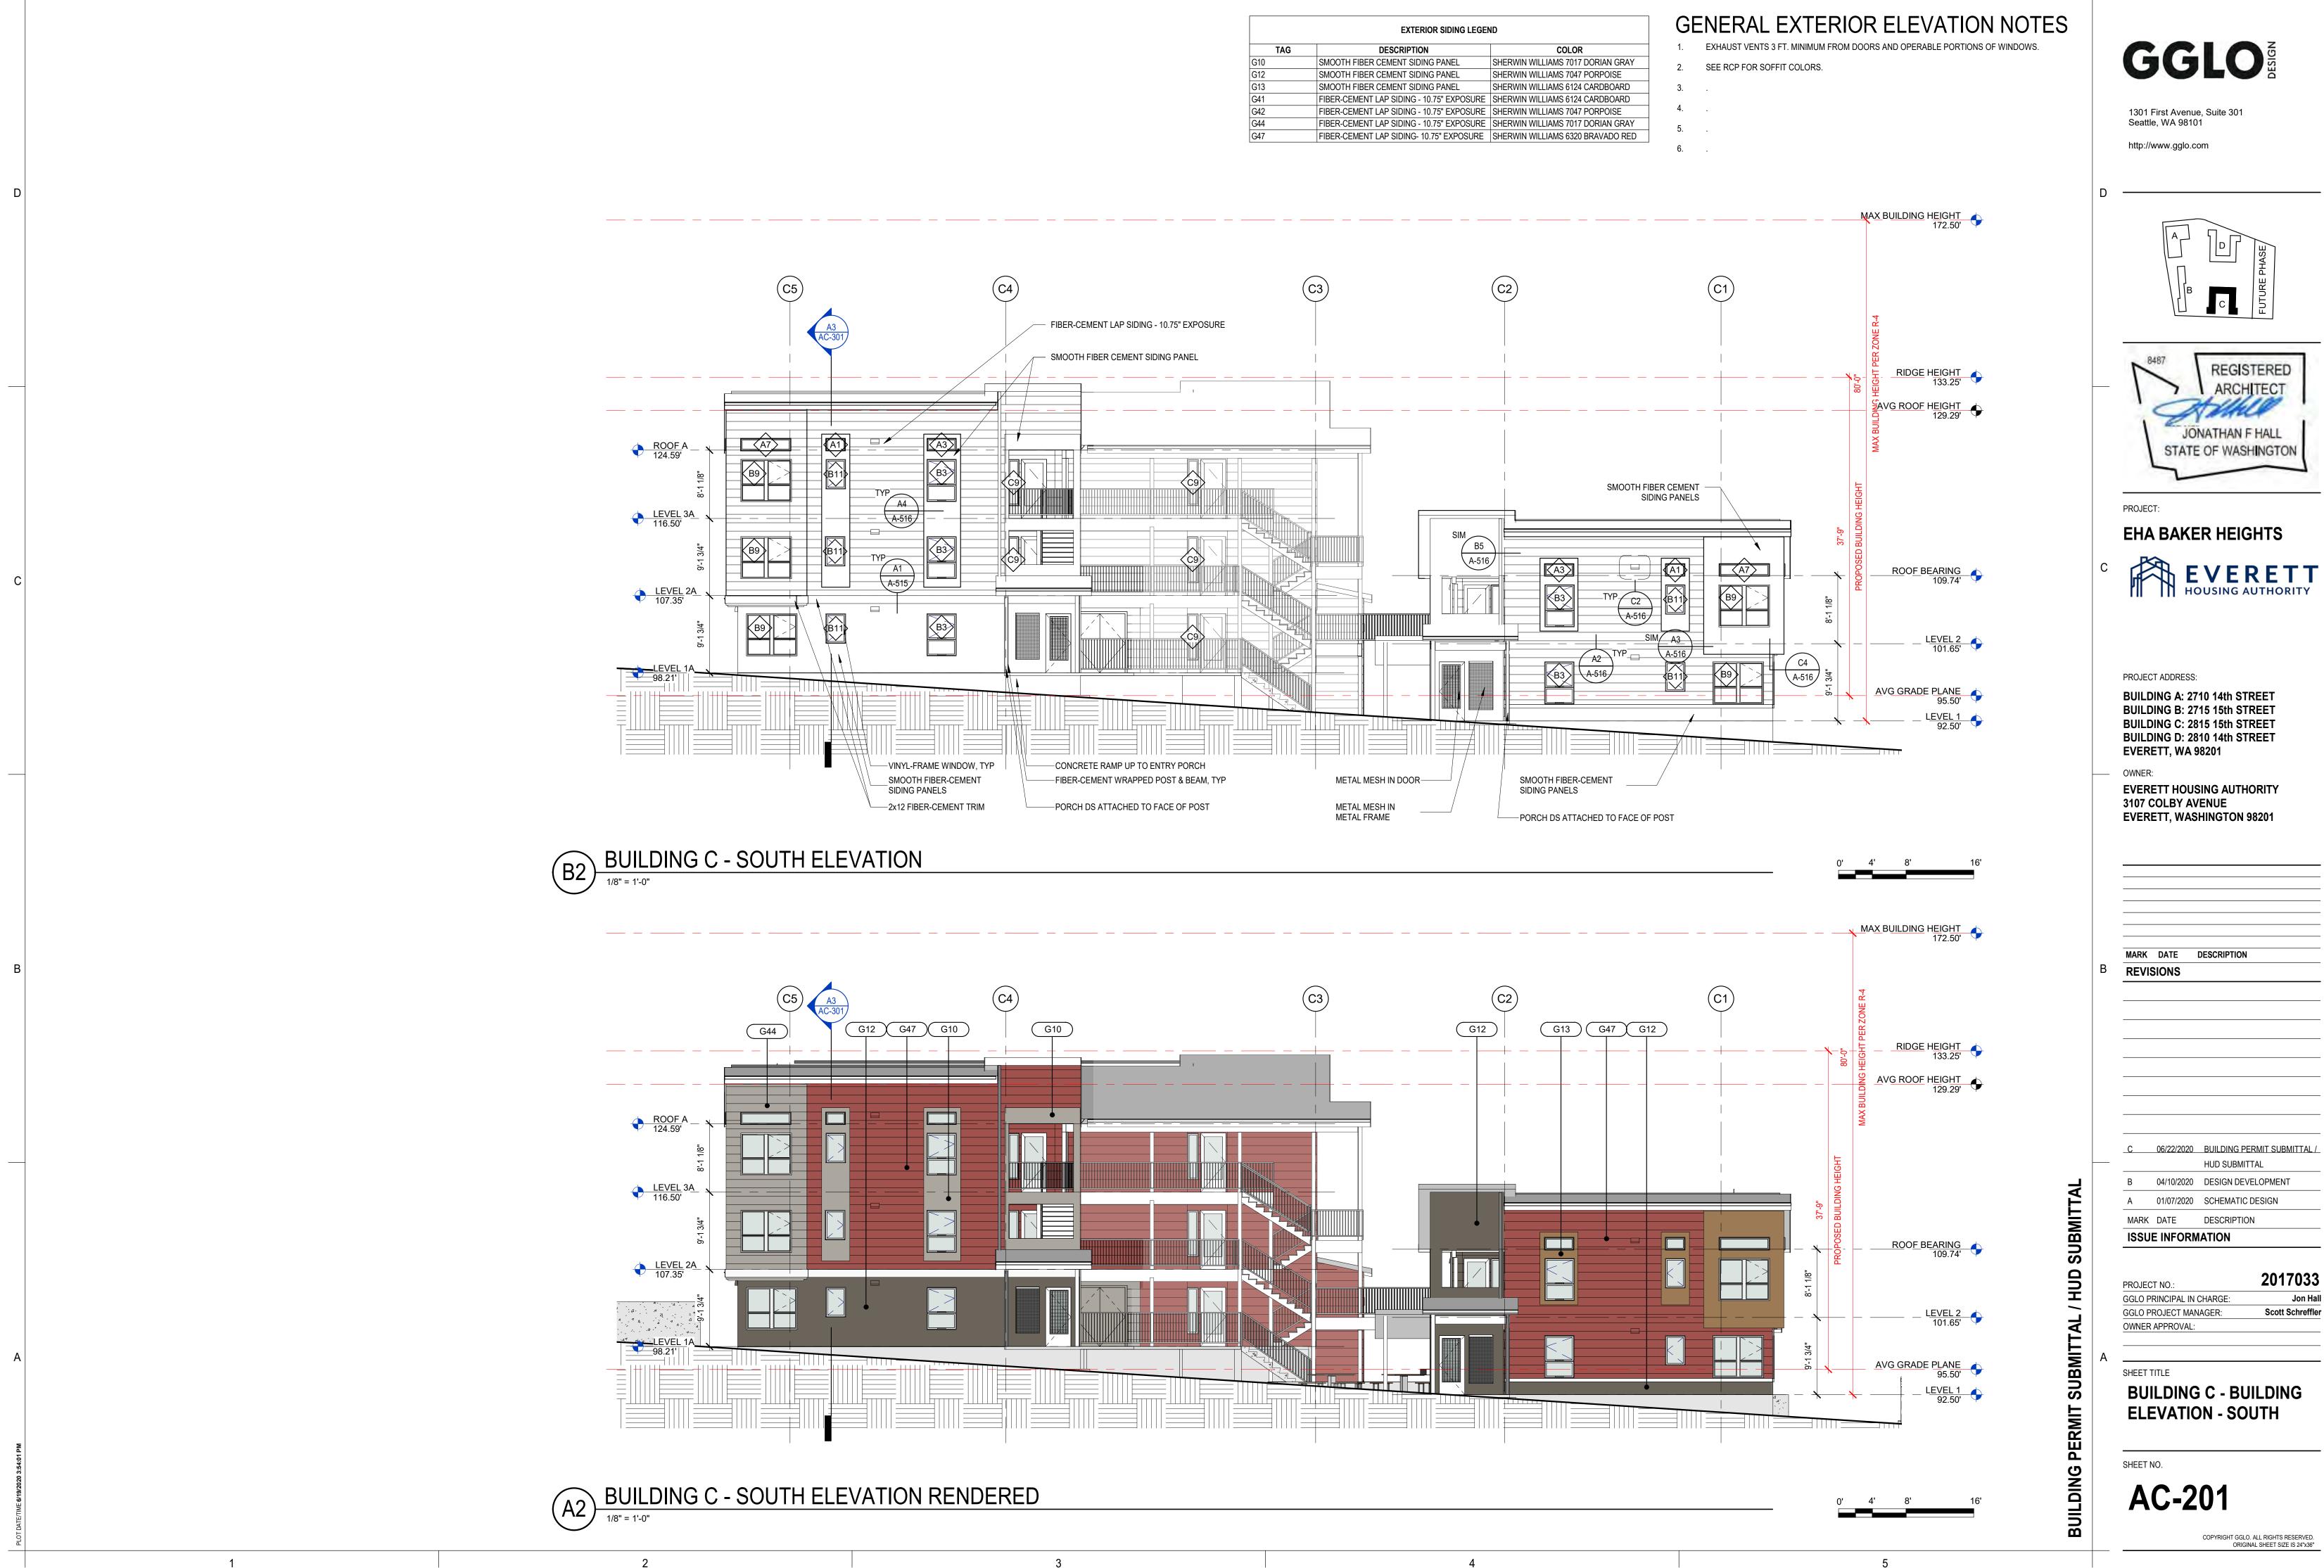




AREA N ROOF AREA O ROOF AREA P ROOF AREA Q ROOF 68 SF

AREA R

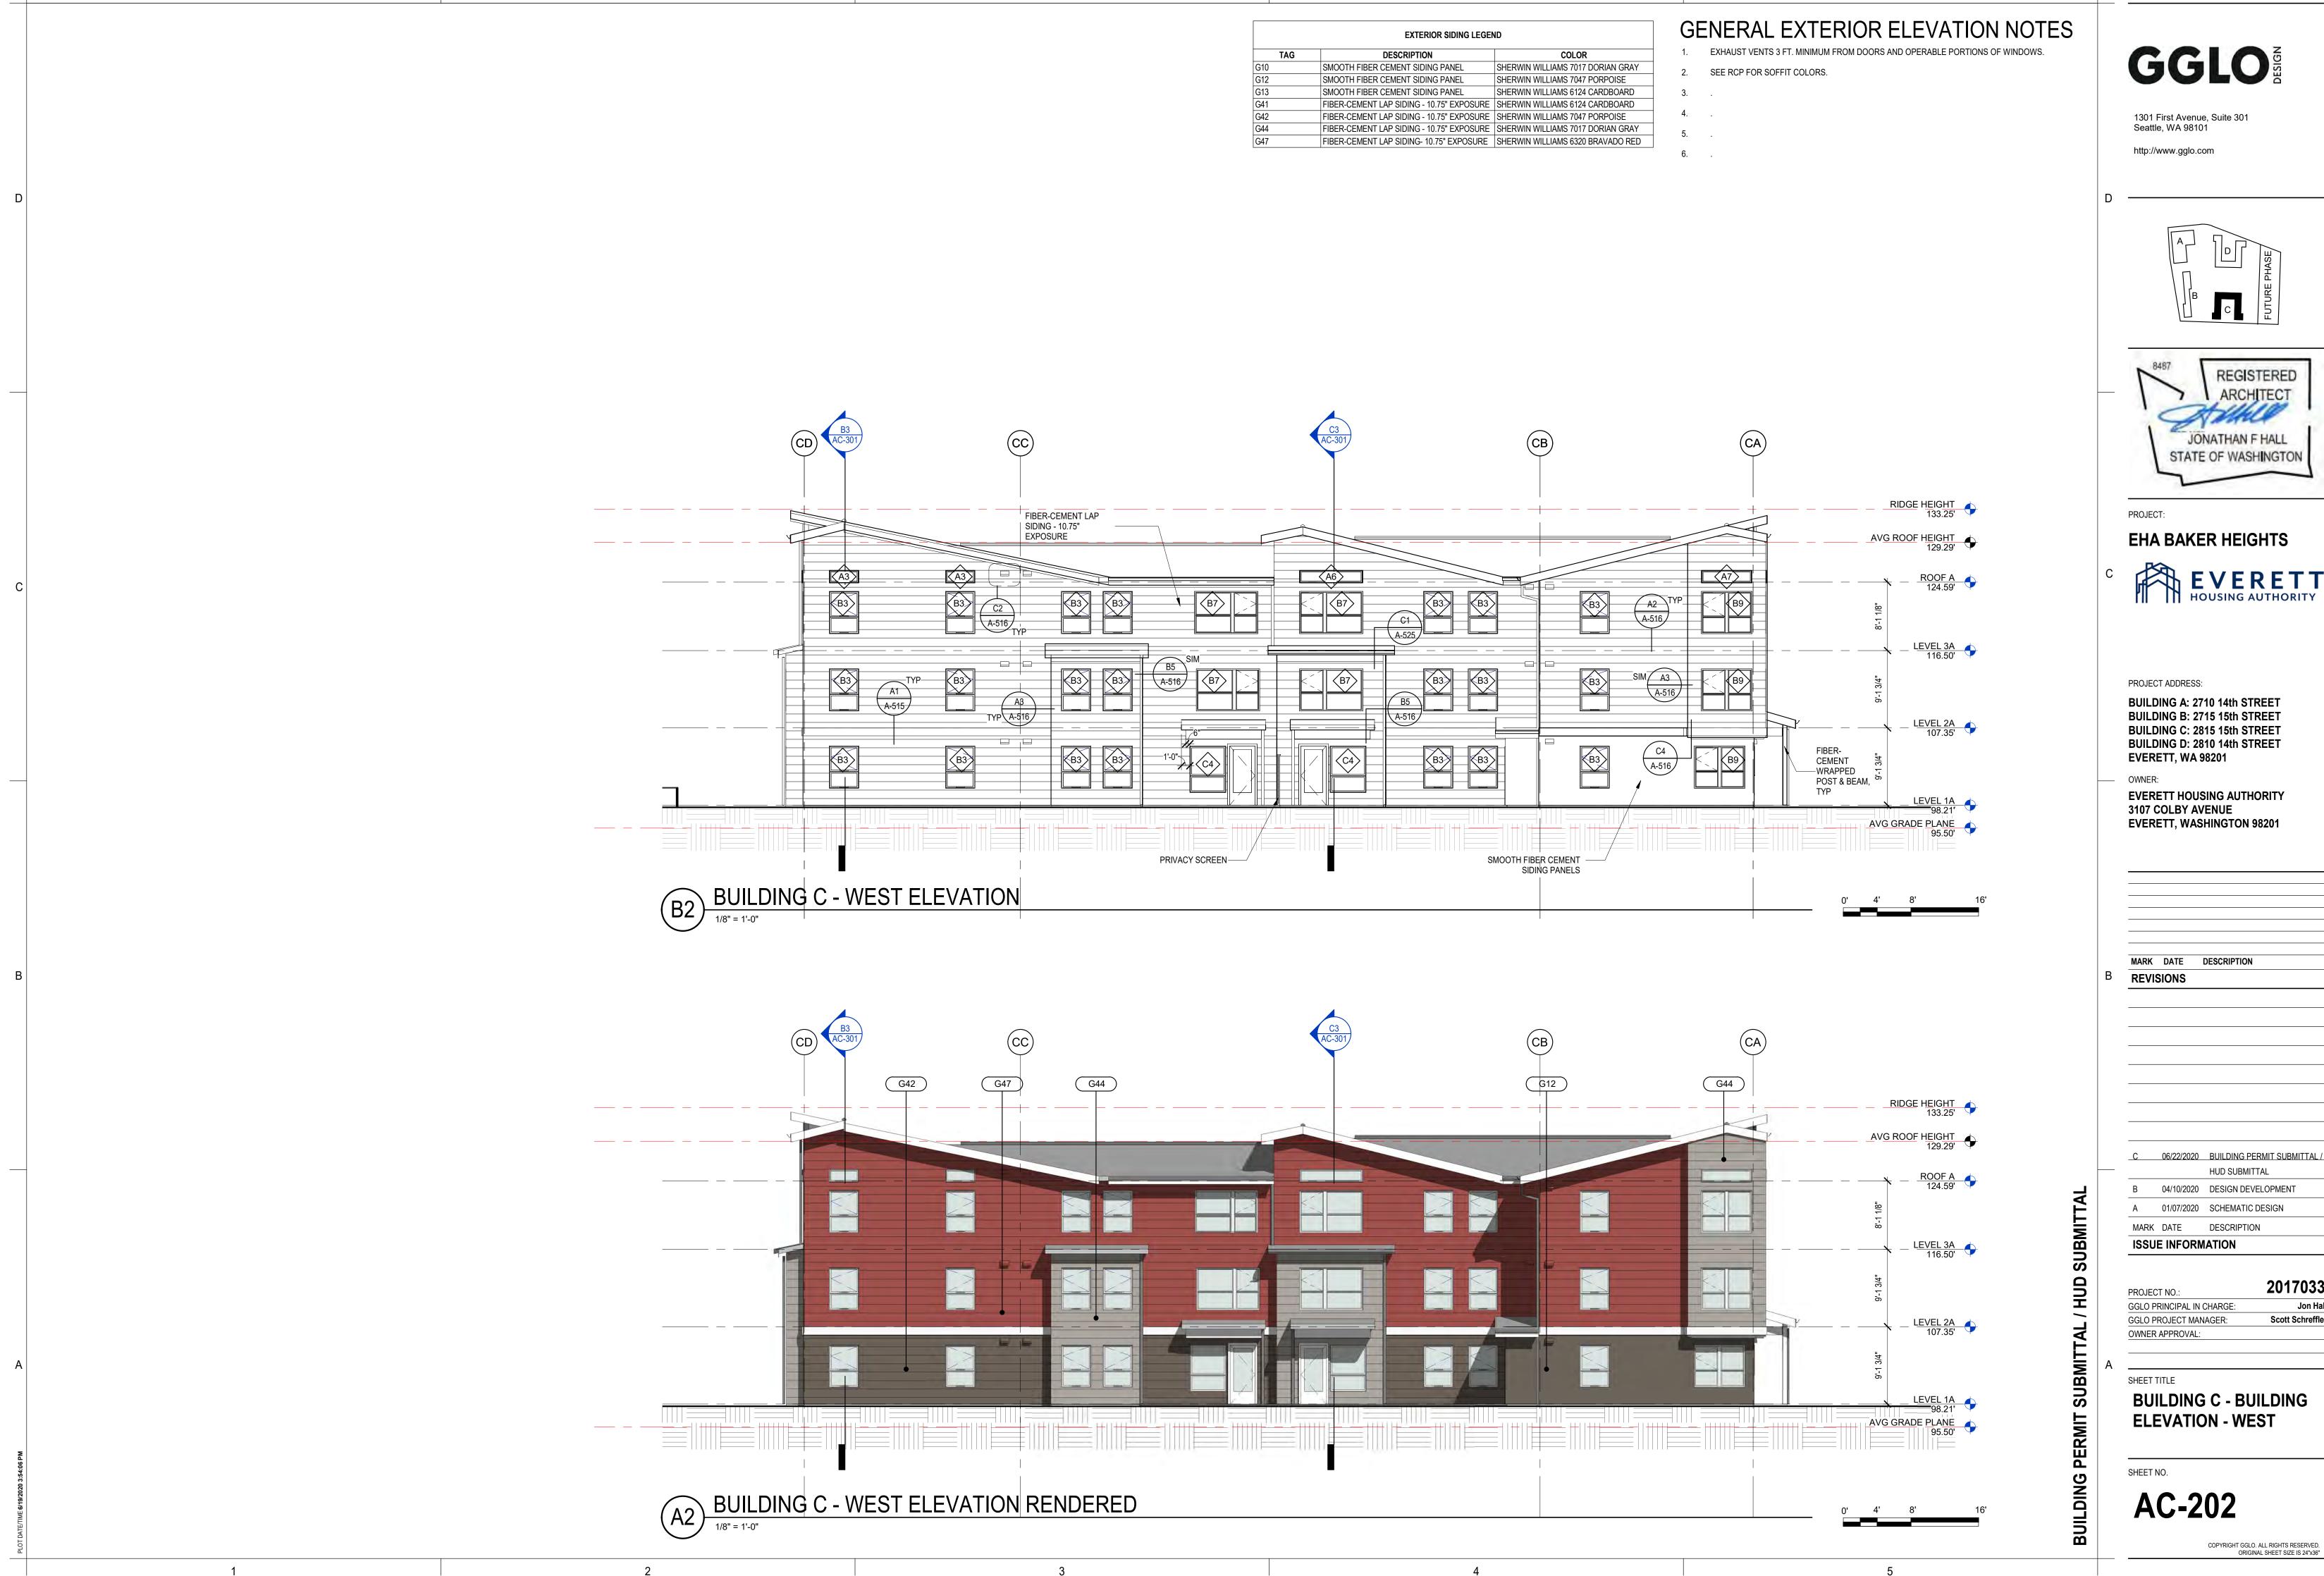




	EXTERIOR SIDING LEGEN	ND
TAG	DESCRIPTION	COLOR
	SMOOTH FIBER CEMENT SIDING PANEL	SHERWIN WILLIAMS 7017 DORIAN
	SMOOTH FIBER CEMENT SIDING PANEL	SHERWIN WILLIAMS 7047 PORPO
}	SMOOTH FIBER CEMENT SIDING PANEL	SHERWIN WILLIAMS 6124 CARDB
	FIBER-CEMENT LAP SIDING - 10.75" EXPOSURE	SHERWIN WILLIAMS 6124 CARDB
	FIBER-CEMENT LAP SIDING - 10.75" EXPOSURE	SHERWIN WILLIAMS 7047 PORPO
	FIBER-CEMENT LAP SIDING - 10.75" EXPOSURE	SHERWIN WILLIAMS 7017 DORIAN
•	FIBER-CEMENT LAP SIDING- 10.75" EXPOSURE	SHERWIN WILLIAMS 6320 BRAVA
		TAG         DESCRIPTION           SMOOTH FIBER CEMENT SIDING PANEL         SMOOTH FIBER CEMENT SIDING PANEL           SMOOTH FIBER CEMENT SIDING PANEL         SMOOTH FIBER CEMENT SIDING PANEL           FIBER-CEMENT LAP SIDING - 10.75" EXPOSURE         FIBER-CEMENT LAP SIDING - 10.75" EXPOSURE           FIBER-CEMENT LAP SIDING - 10.75" EXPOSURE         FIBER-CEMENT LAP SIDING - 10.75" EXPOSURE

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Jon Hall



	EXTERIOR SIDING LEGE	ND
TAG	DESCRIPTION	COLOR
G10	SMOOTH FIBER CEMENT SIDING PANEL	SHERWIN WILLIAMS 7017 DORIAN
G12	SMOOTH FIBER CEMENT SIDING PANEL	SHERWIN WILLIAMS 7047 PORPC
G13	SMOOTH FIBER CEMENT SIDING PANEL	SHERWIN WILLIAMS 6124 CARDB
G41	FIBER-CEMENT LAP SIDING - 10.75" EXPOSURE	SHERWIN WILLIAMS 6124 CARDB
G42	FIBER-CEMENT LAP SIDING - 10.75" EXPOSURE	SHERWIN WILLIAMS 7047 PORPC
G44	FIBER-CEMENT LAP SIDING - 10.75" EXPOSURE	SHERWIN WILLIAMS 7017 DORIAN
G47	FIBER-CEMENT LAP SIDING- 10.75" EXPOSURE	SHERWIN WILLIAMS 6320 BRAVA

Scott Schreffler

Jon Hall



	EXTERIOR SIDING LEGEND			
	TAG	DESCRIPTION	COLOR	
G10		SMOOTH FIBER CEMENT SIDING PANEL	SHERWIN WILLIAMS 7017 DORIAN	
G12		SMOOTH FIBER CEMENT SIDING PANEL	SHERWIN WILLIAMS 7047 PORPOI	
G13		SMOOTH FIBER CEMENT SIDING PANEL	SHERWIN WILLIAMS 6124 CARDBO	
G41		FIBER-CEMENT LAP SIDING - 10.75" EXPOSURE	SHERWIN WILLIAMS 6124 CARDBO	
G42		FIBER-CEMENT LAP SIDING - 10.75" EXPOSURE	SHERWIN WILLIAMS 7047 PORPOI	
G44		FIBER-CEMENT LAP SIDING - 10.75" EXPOSURE	SHERWIN WILLIAMS 7017 DORIAN	
G47		FIBER-CEMENT LAP SIDING- 10.75" EXPOSURE	SHERWIN WILLIAMS 6320 BRAVAD	
-		·	•	

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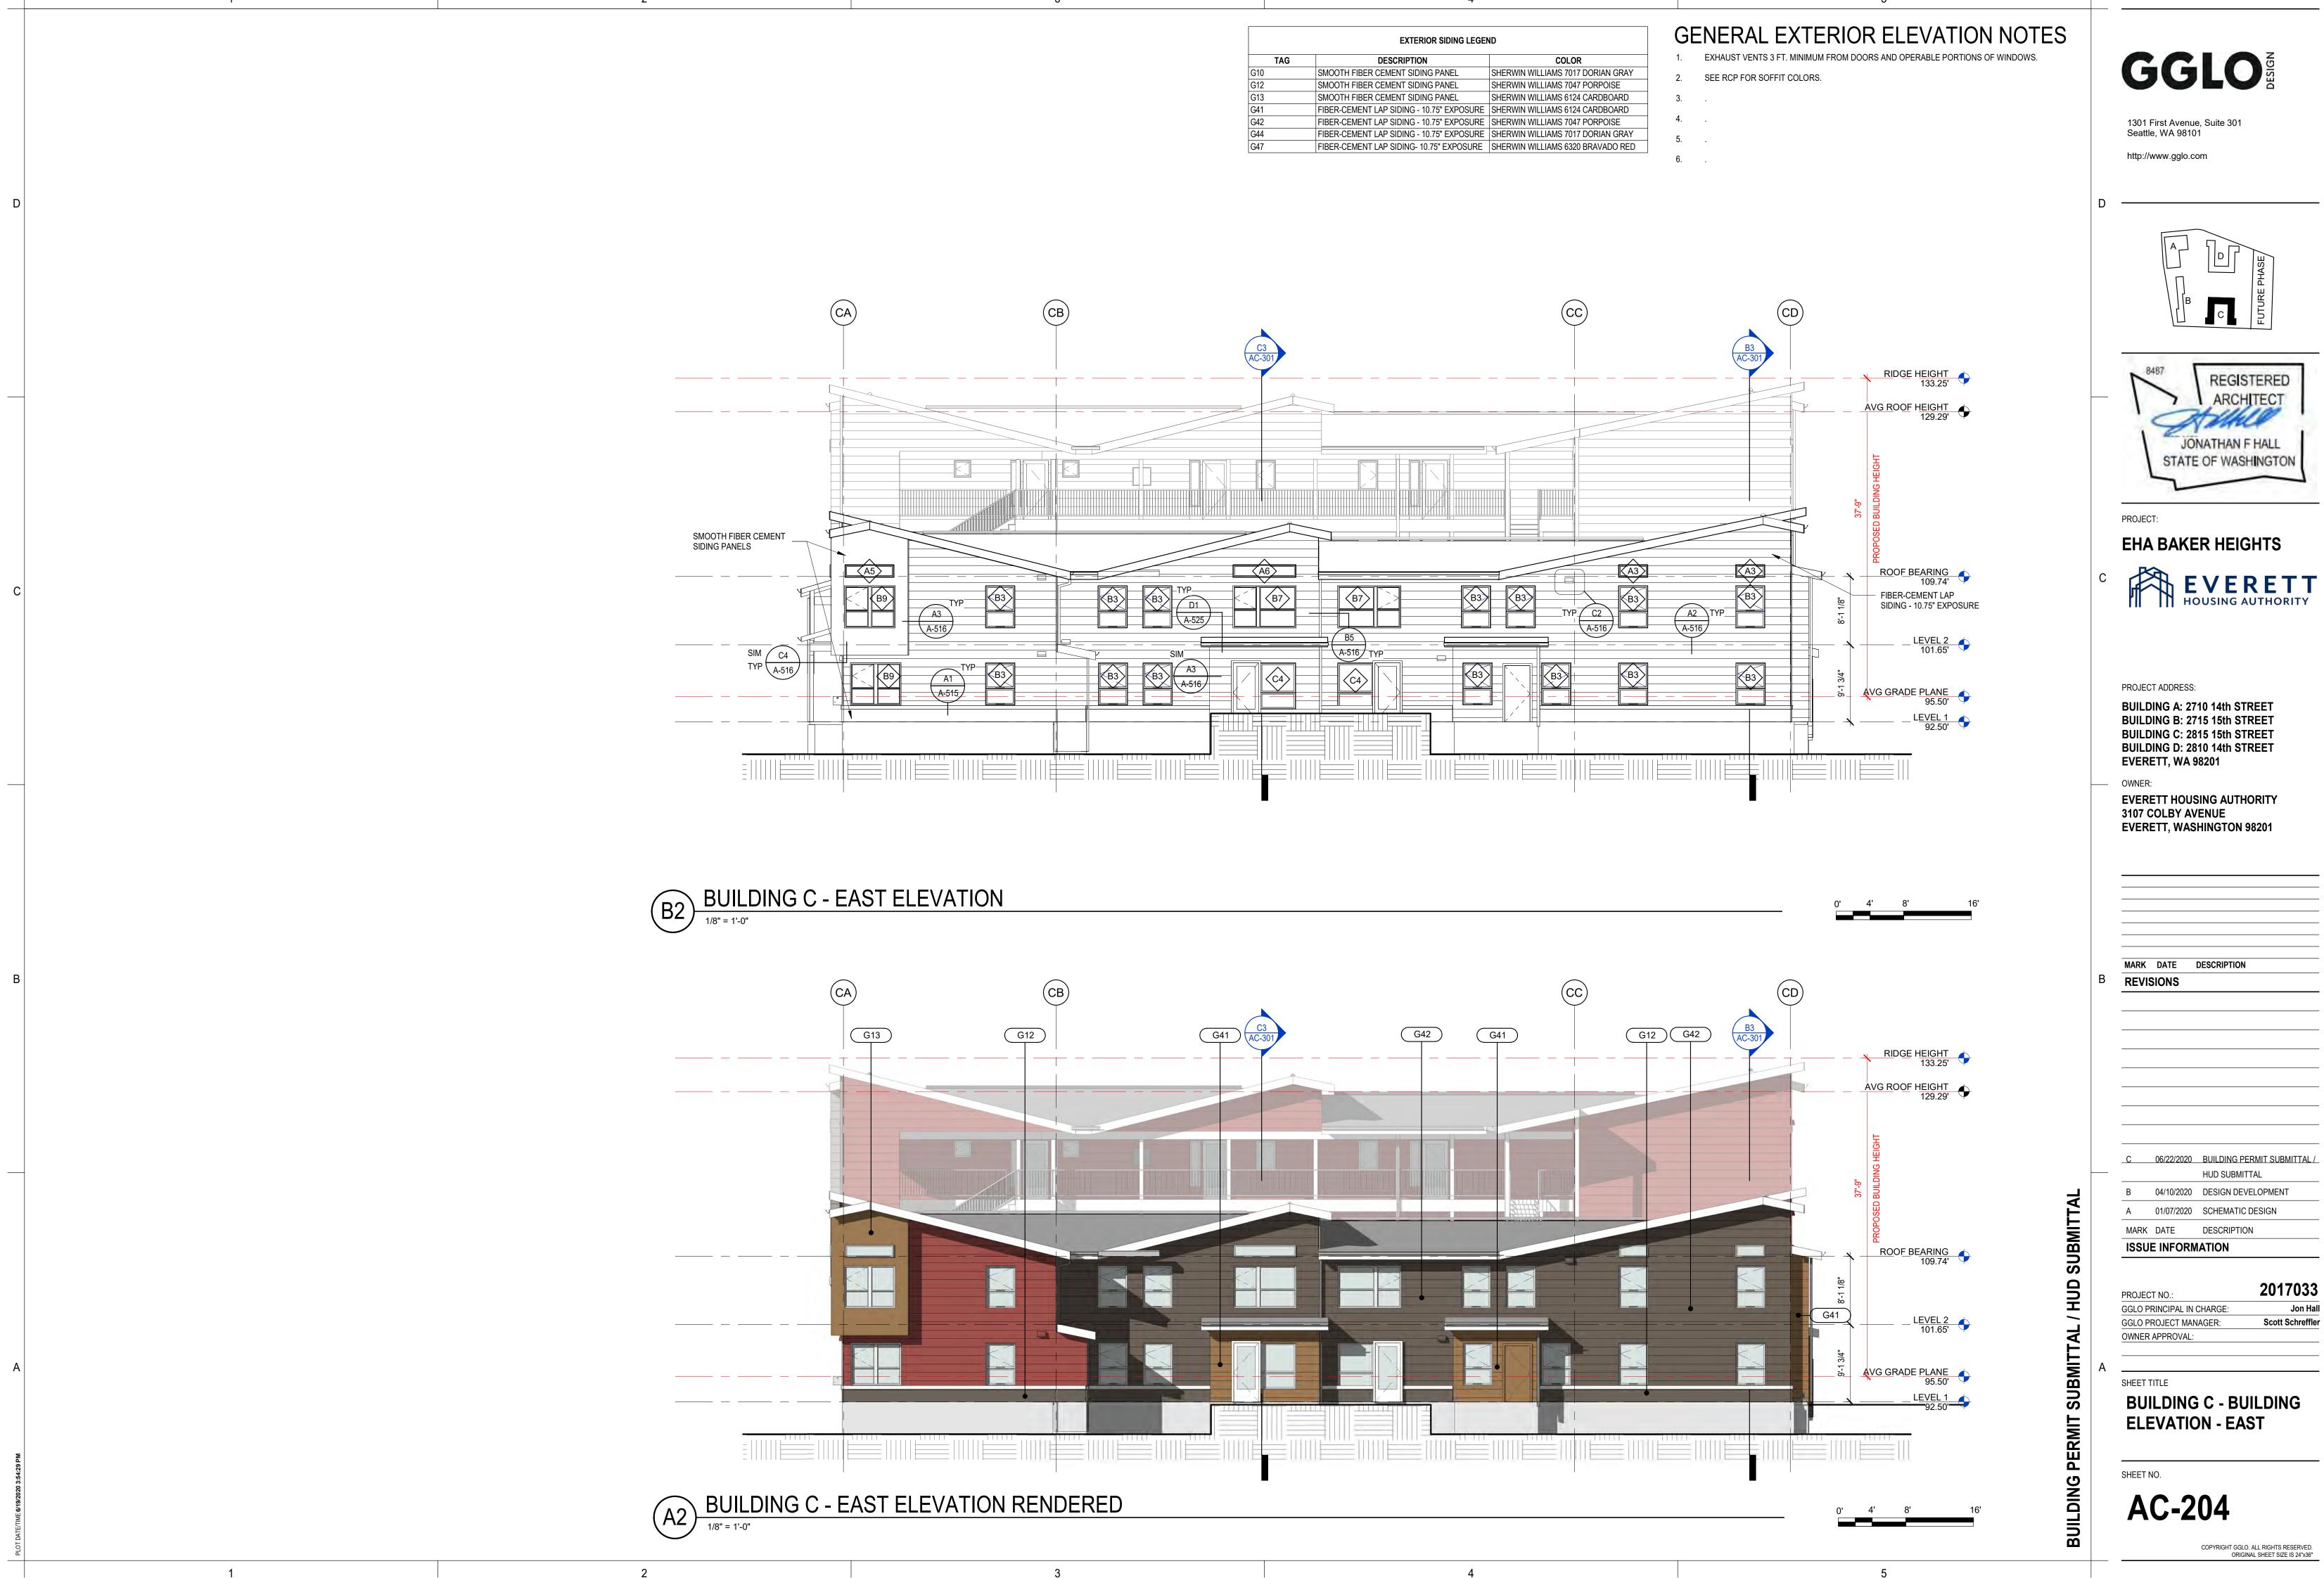
## 1301 First Avenue, Suite 301 Seattle, WA 98101 http://www.gglo.com 848 REGISTERED ARCHITECT JONATHAN F HALL STATE OF WASHINGTON PROJECT: EHA BAKER HEIGHTS **P** HOUSING AUTHORITY PROJECT ADDRESS: BUILDING A: 2710 14th STREET BUILDING B: 2715 15th STREET BUILDING C: 2815 15th STREET BUILDING D: 2810 14th STREET **EVERETT, WA 98201** OWNER: EVERETT HOUSING AUTHORITY 3107 COLBY AVENUE EVERETT, WASHINGTON 98201 MARK DATE DESCRIPTION REVISIONS C 06/22/2020 BUILDING PERMIT SUBMITTAL / HUD SUBMITTAL 04/10/2020 DESIGN DEVELOPMENT 01/07/2020 SCHEMATIC DESIGN Α MARK DATE DESCRIPTION **ISSUE INFORMATION** 2017033 PROJECT NO .: GGLO PRINCIPAL IN CHARGE: Jon Hall Scott Schreffler GGLO PROJECT MANAGER: OWNER APPROVAL SHEET TITLE **BUILDING C - BUILDING ELEVATION - NORTH**

GGLO

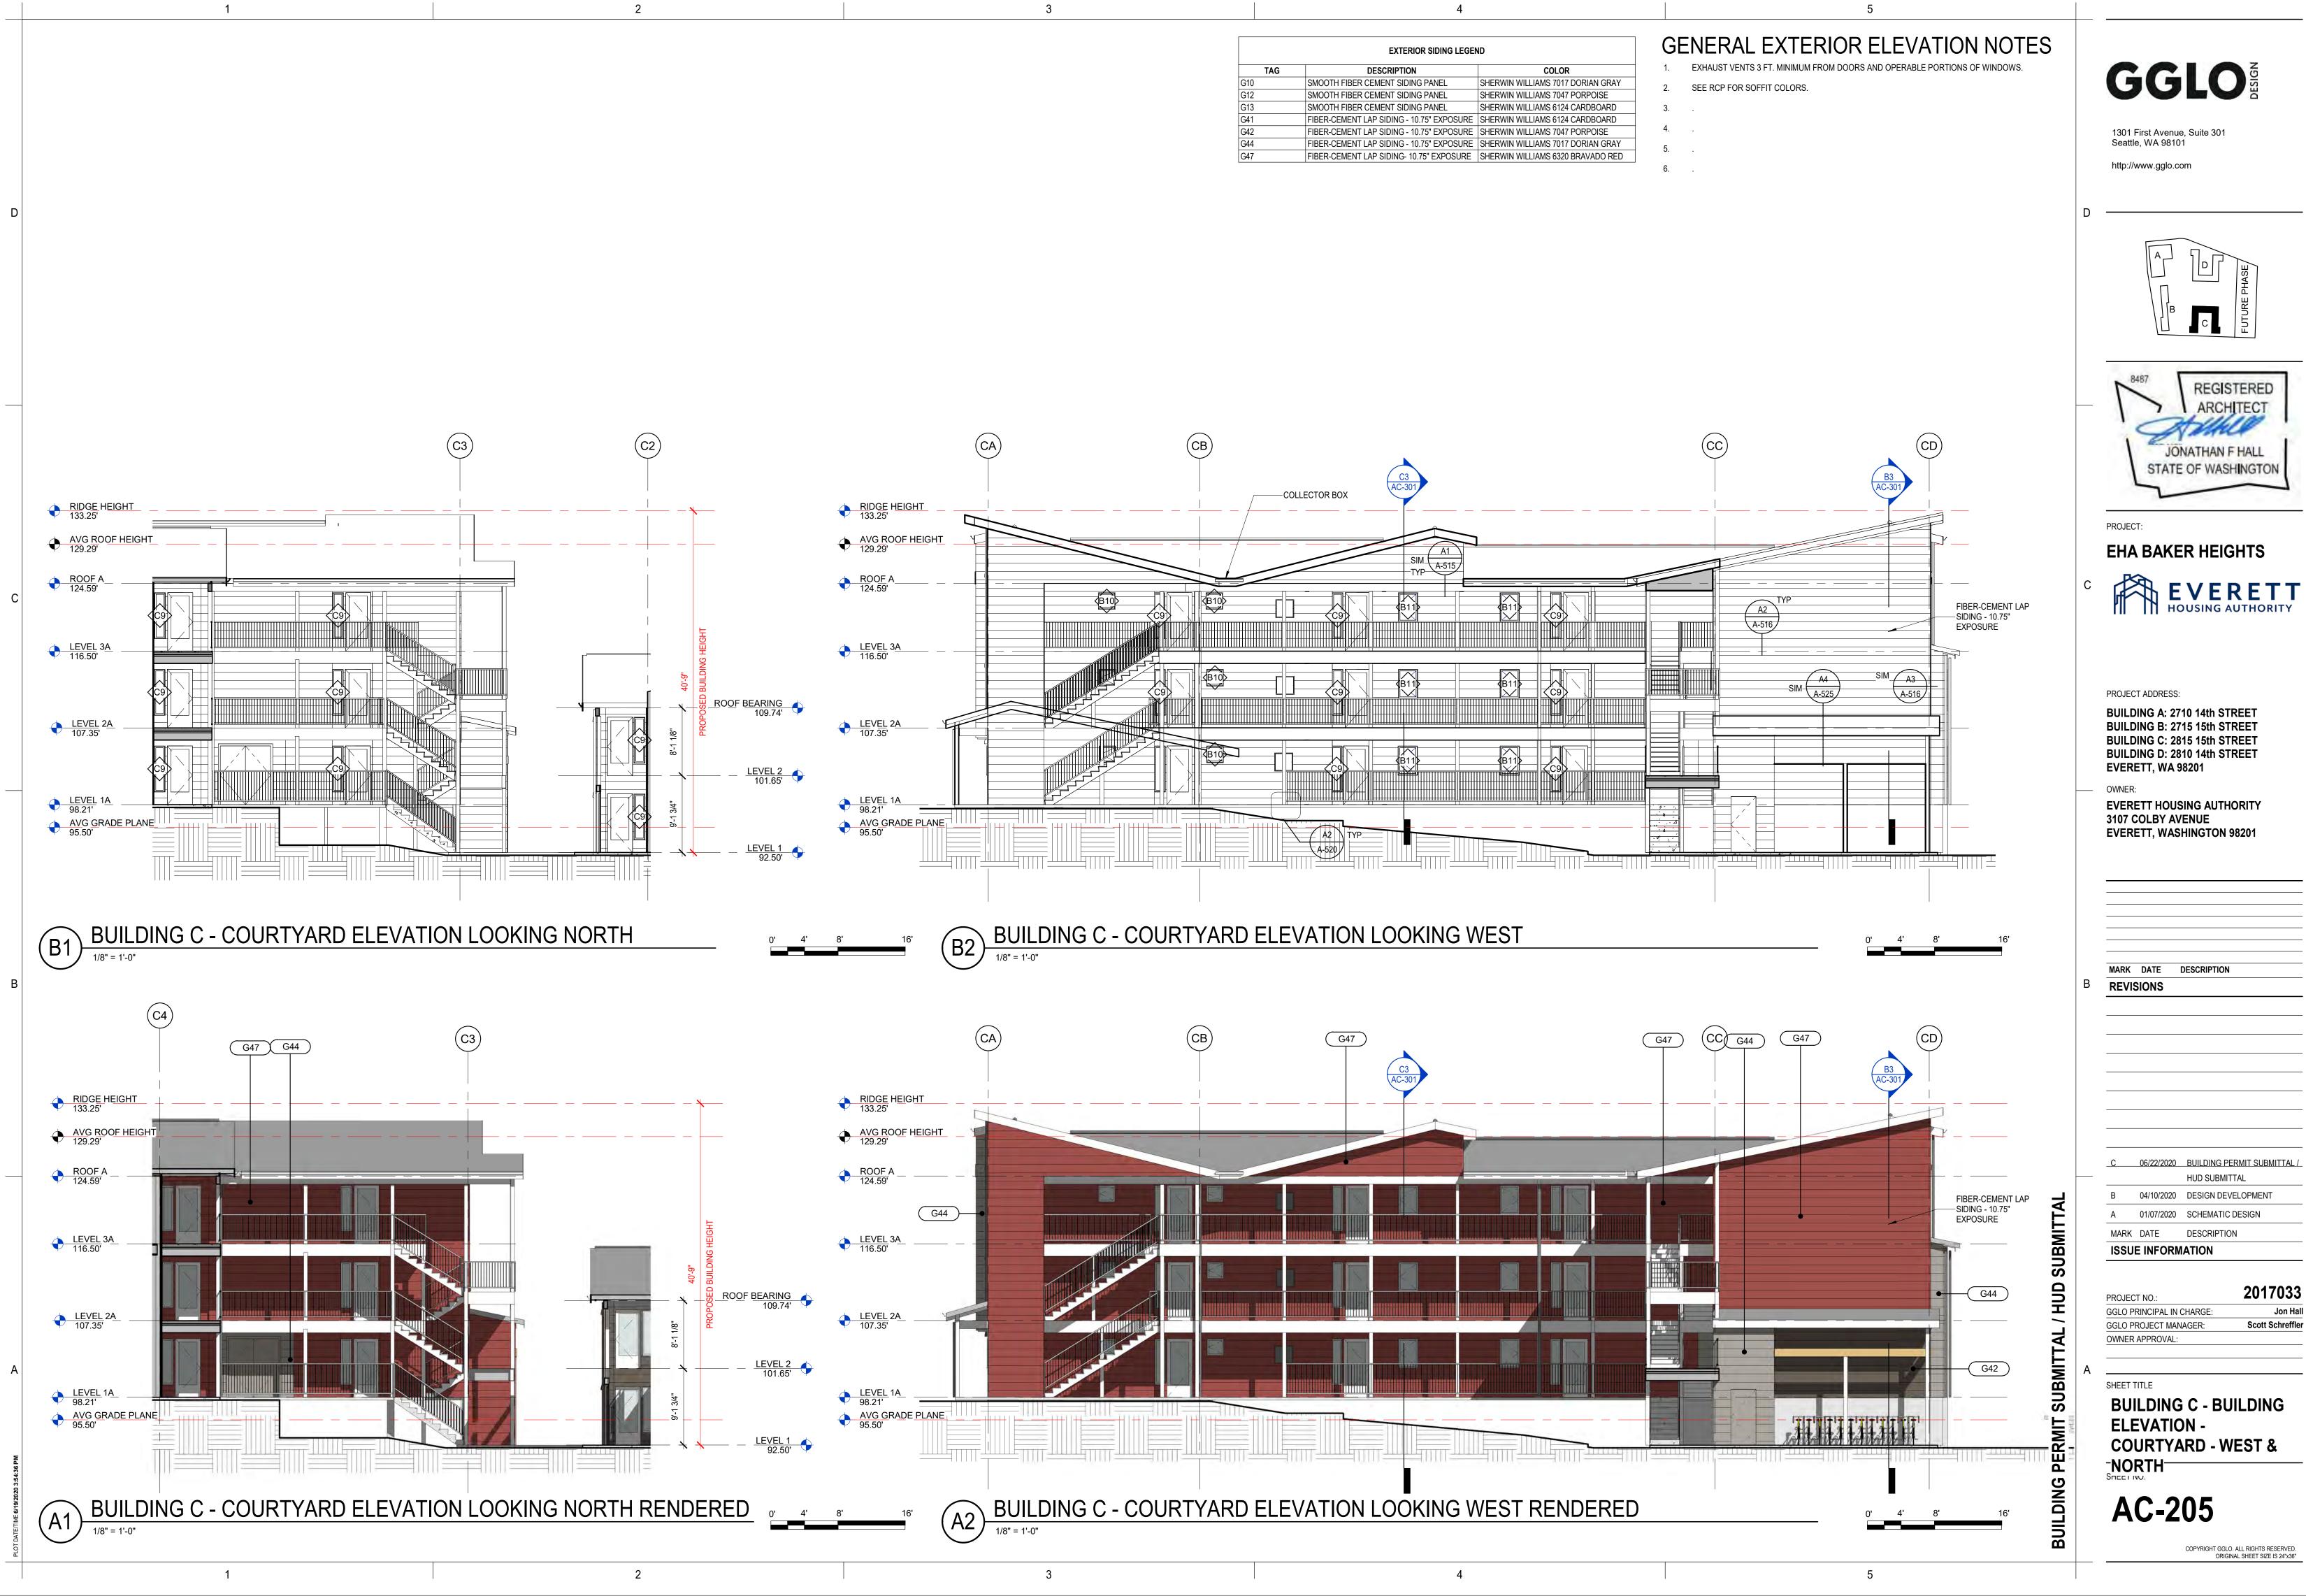
SHEET NO.

5

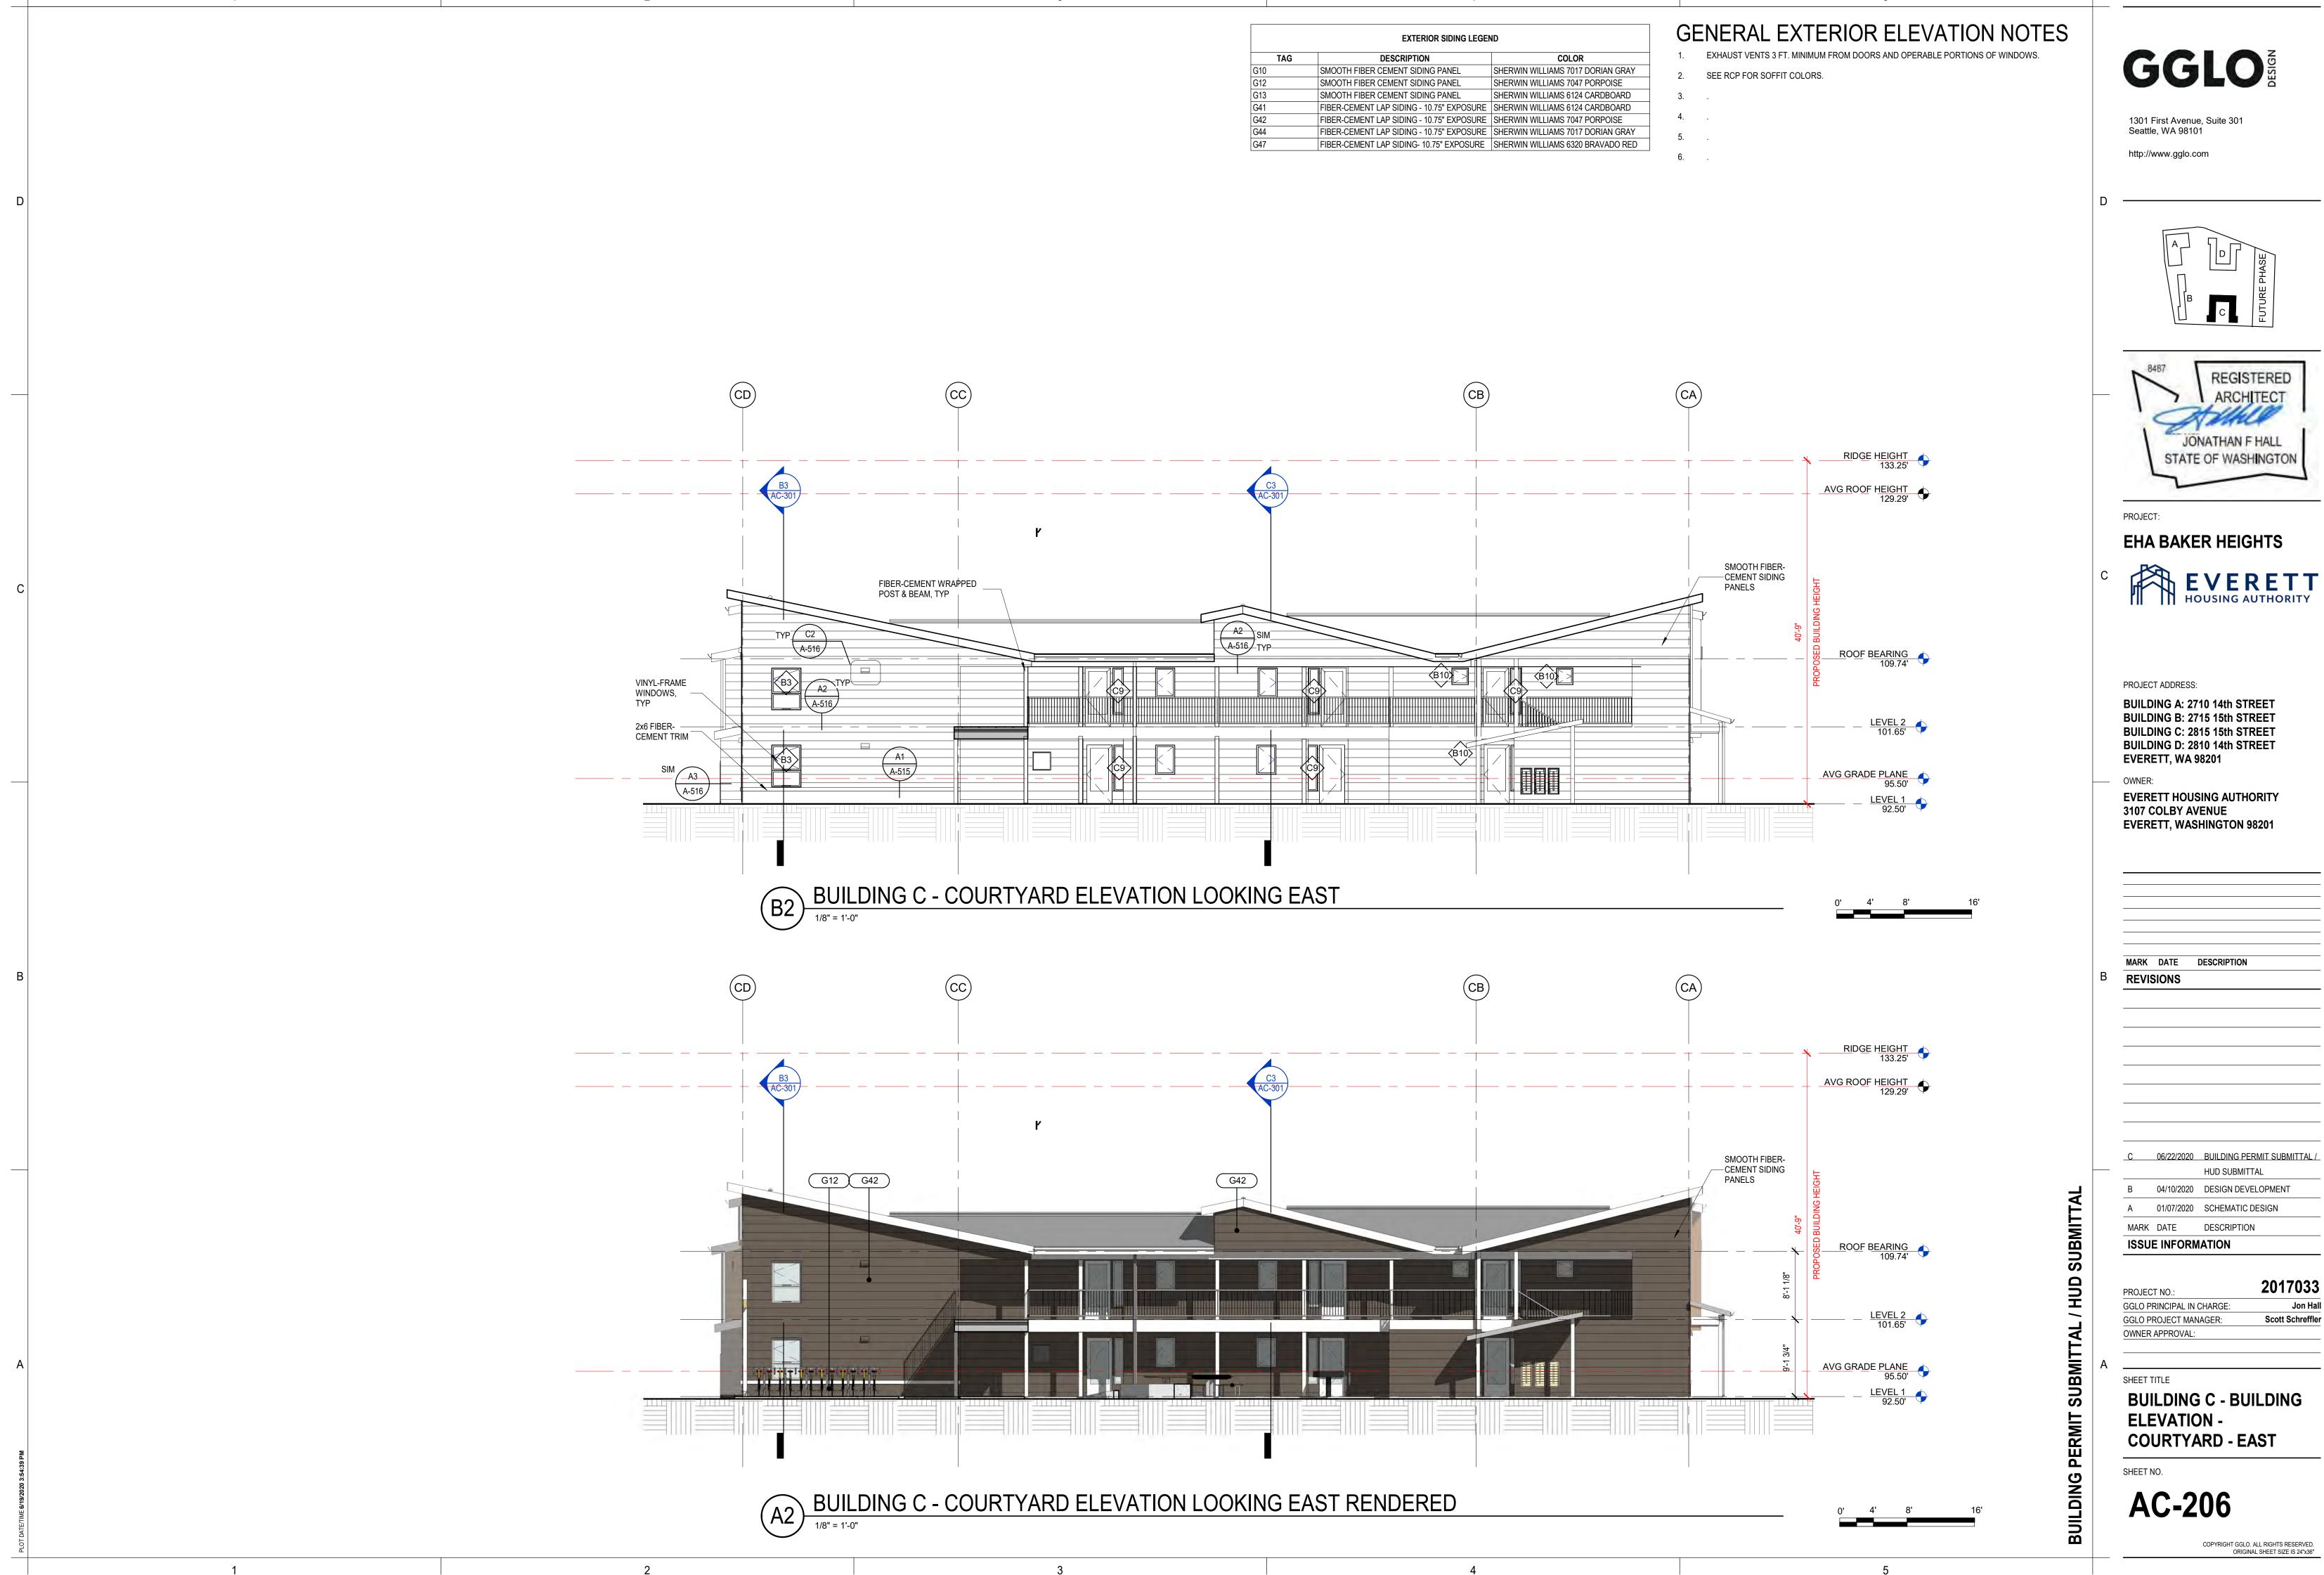
AC-203



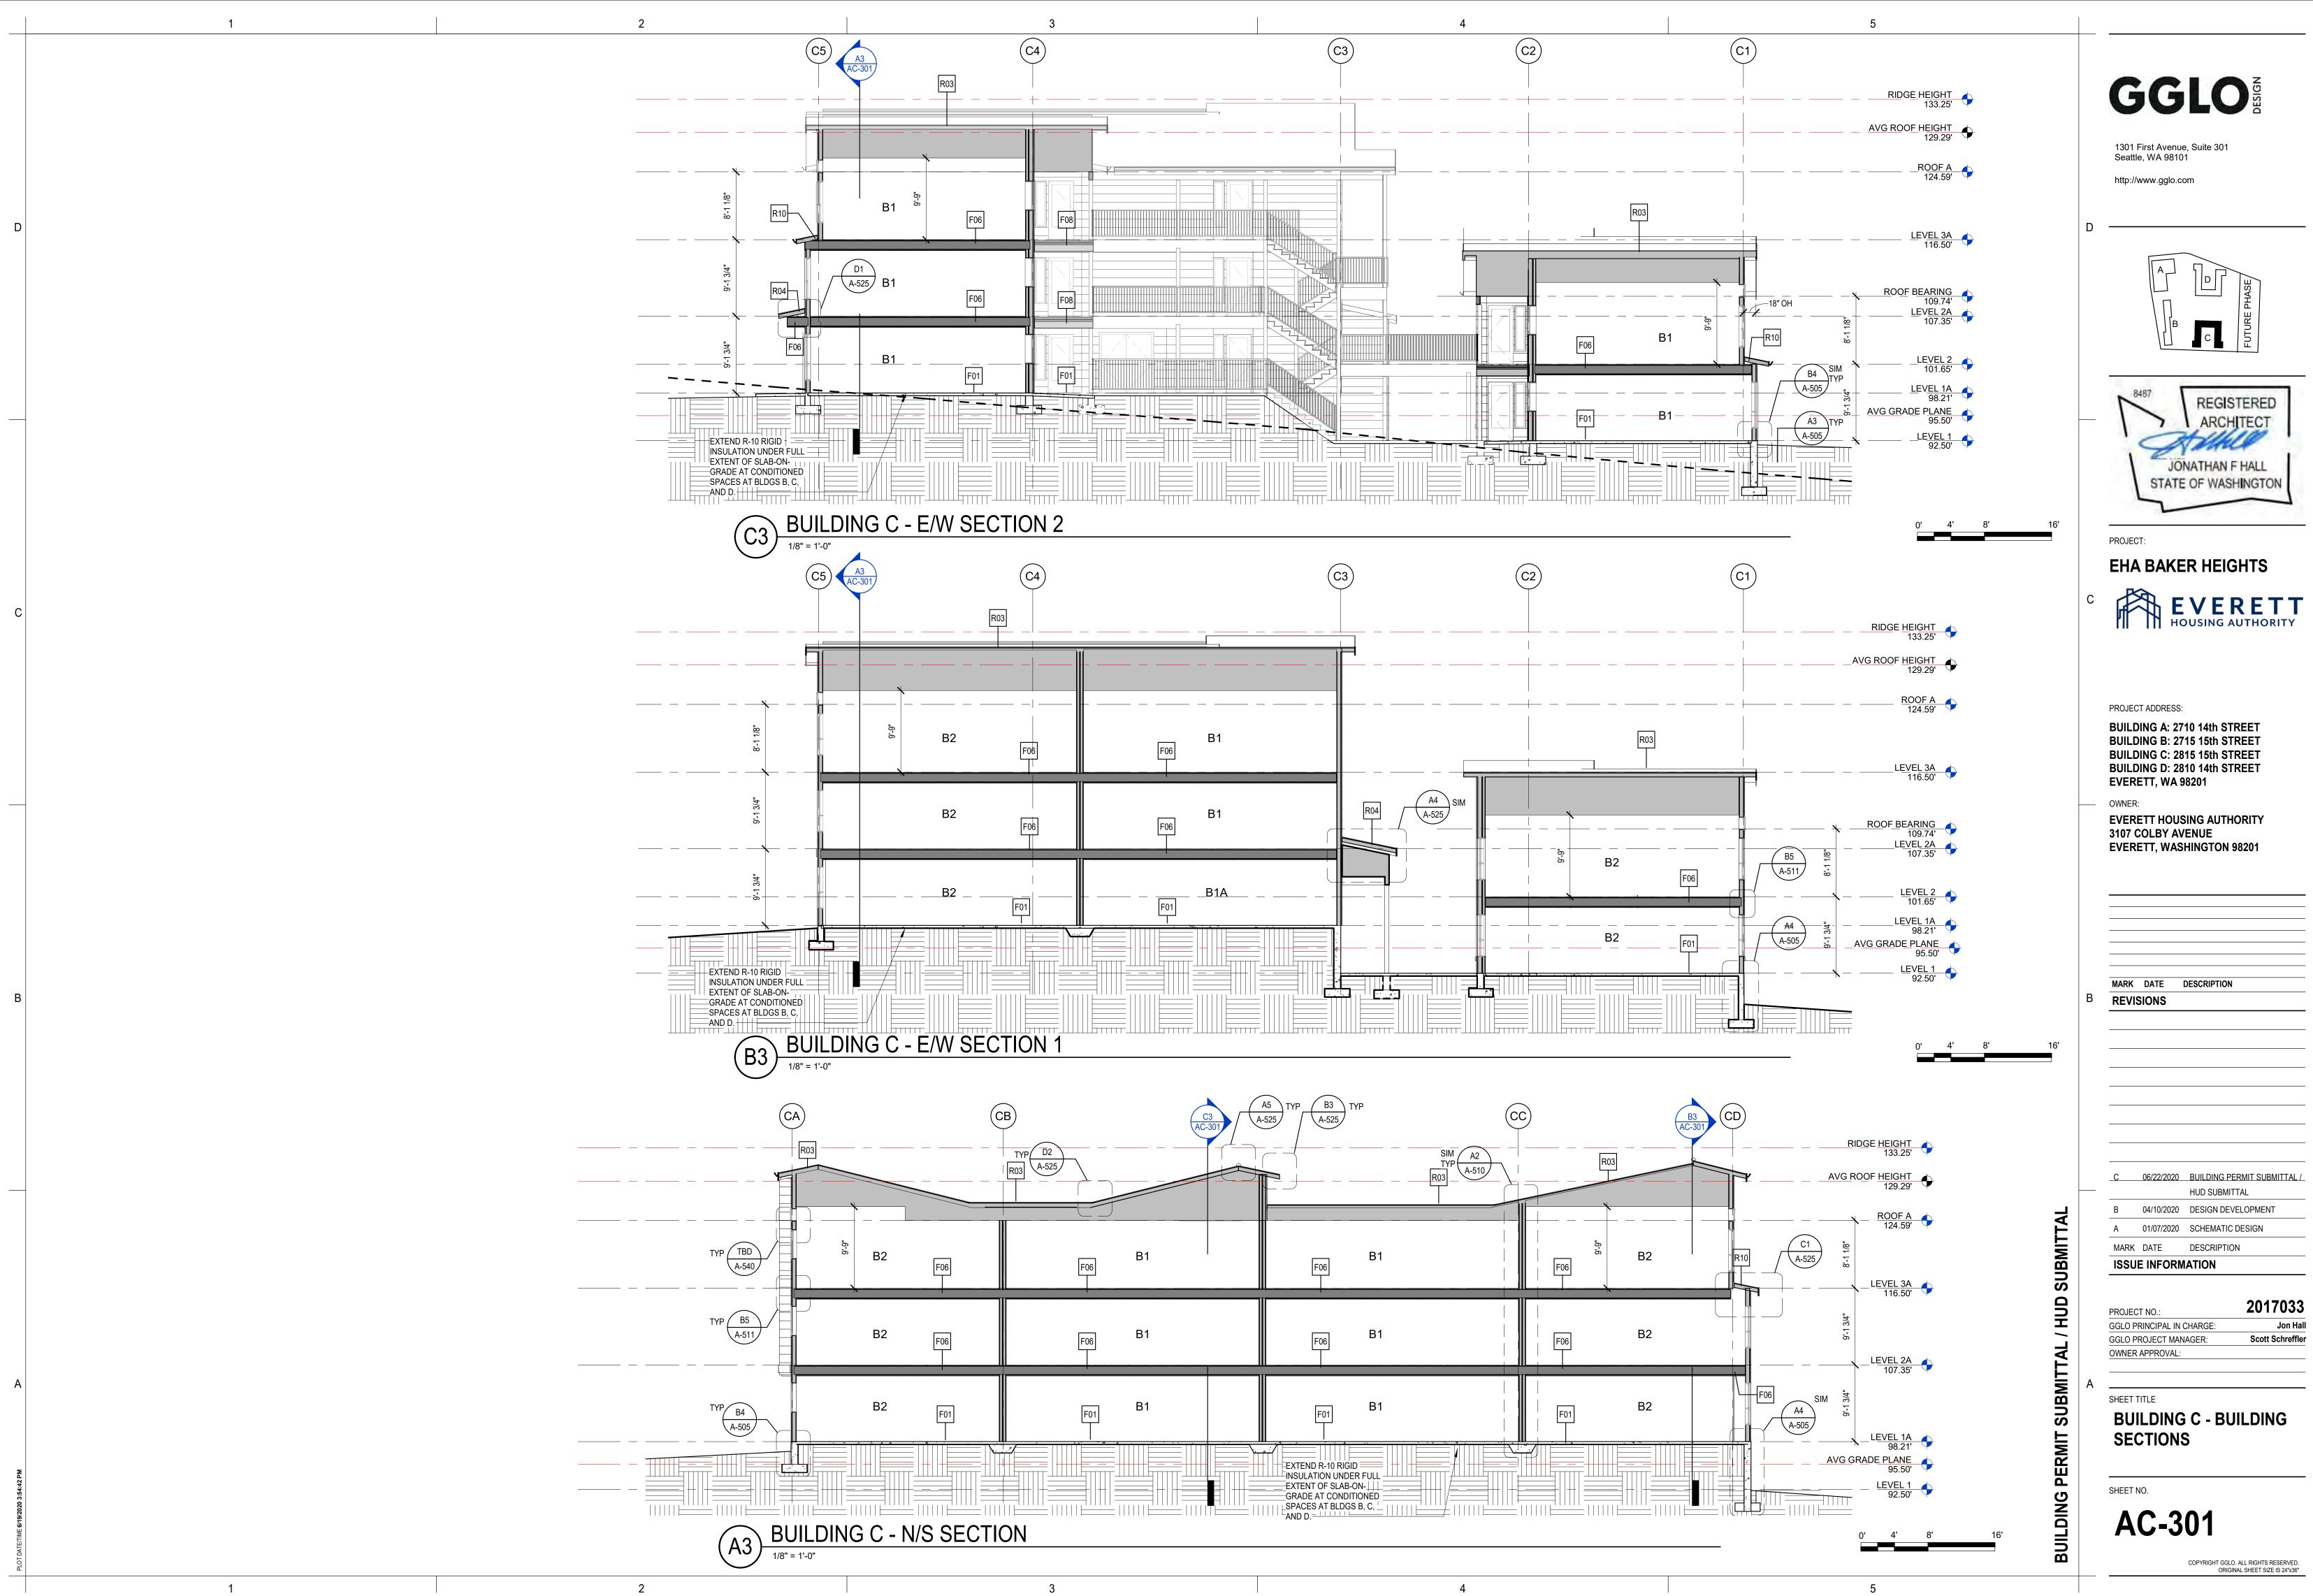
EXTERIOR SIDING LEGEND		
TAG	DESCRIPTION	COLOR
	SMOOTH FIBER CEMENT SIDING PANEL	SHERWIN WILLIAMS 7017 DORIAN
	SMOOTH FIBER CEMENT SIDING PANEL	SHERWIN WILLIAMS 7047 PORPO
	SMOOTH FIBER CEMENT SIDING PANEL	SHERWIN WILLIAMS 6124 CARDB
	FIBER-CEMENT LAP SIDING - 10.75" EXPOSURE	SHERWIN WILLIAMS 6124 CARDB
	FIBER-CEMENT LAP SIDING - 10.75" EXPOSURE	SHERWIN WILLIAMS 7047 PORPO
	FIBER-CEMENT LAP SIDING - 10.75" EXPOSURE	SHERWIN WILLIAMS 7017 DORIAN
	FIBER-CEMENT LAP SIDING- 10.75" EXPOSURE	SHERWIN WILLIAMS 6320 BRAVA
	TAG	TAGDESCRIPTIONSMOOTH FIBER CEMENT SIDING PANELSMOOTH FIBER CEMENT SIDING PANELSMOOTH FIBER CEMENT SIDING PANELFIBER-CEMENT LAP SIDING - 10.75" EXPOSUREFIBER-CEMENT LAP SIDING - 10.75" EXPOSUREFIBER-CEMENT LAP SIDING - 10.75" EXPOSURE

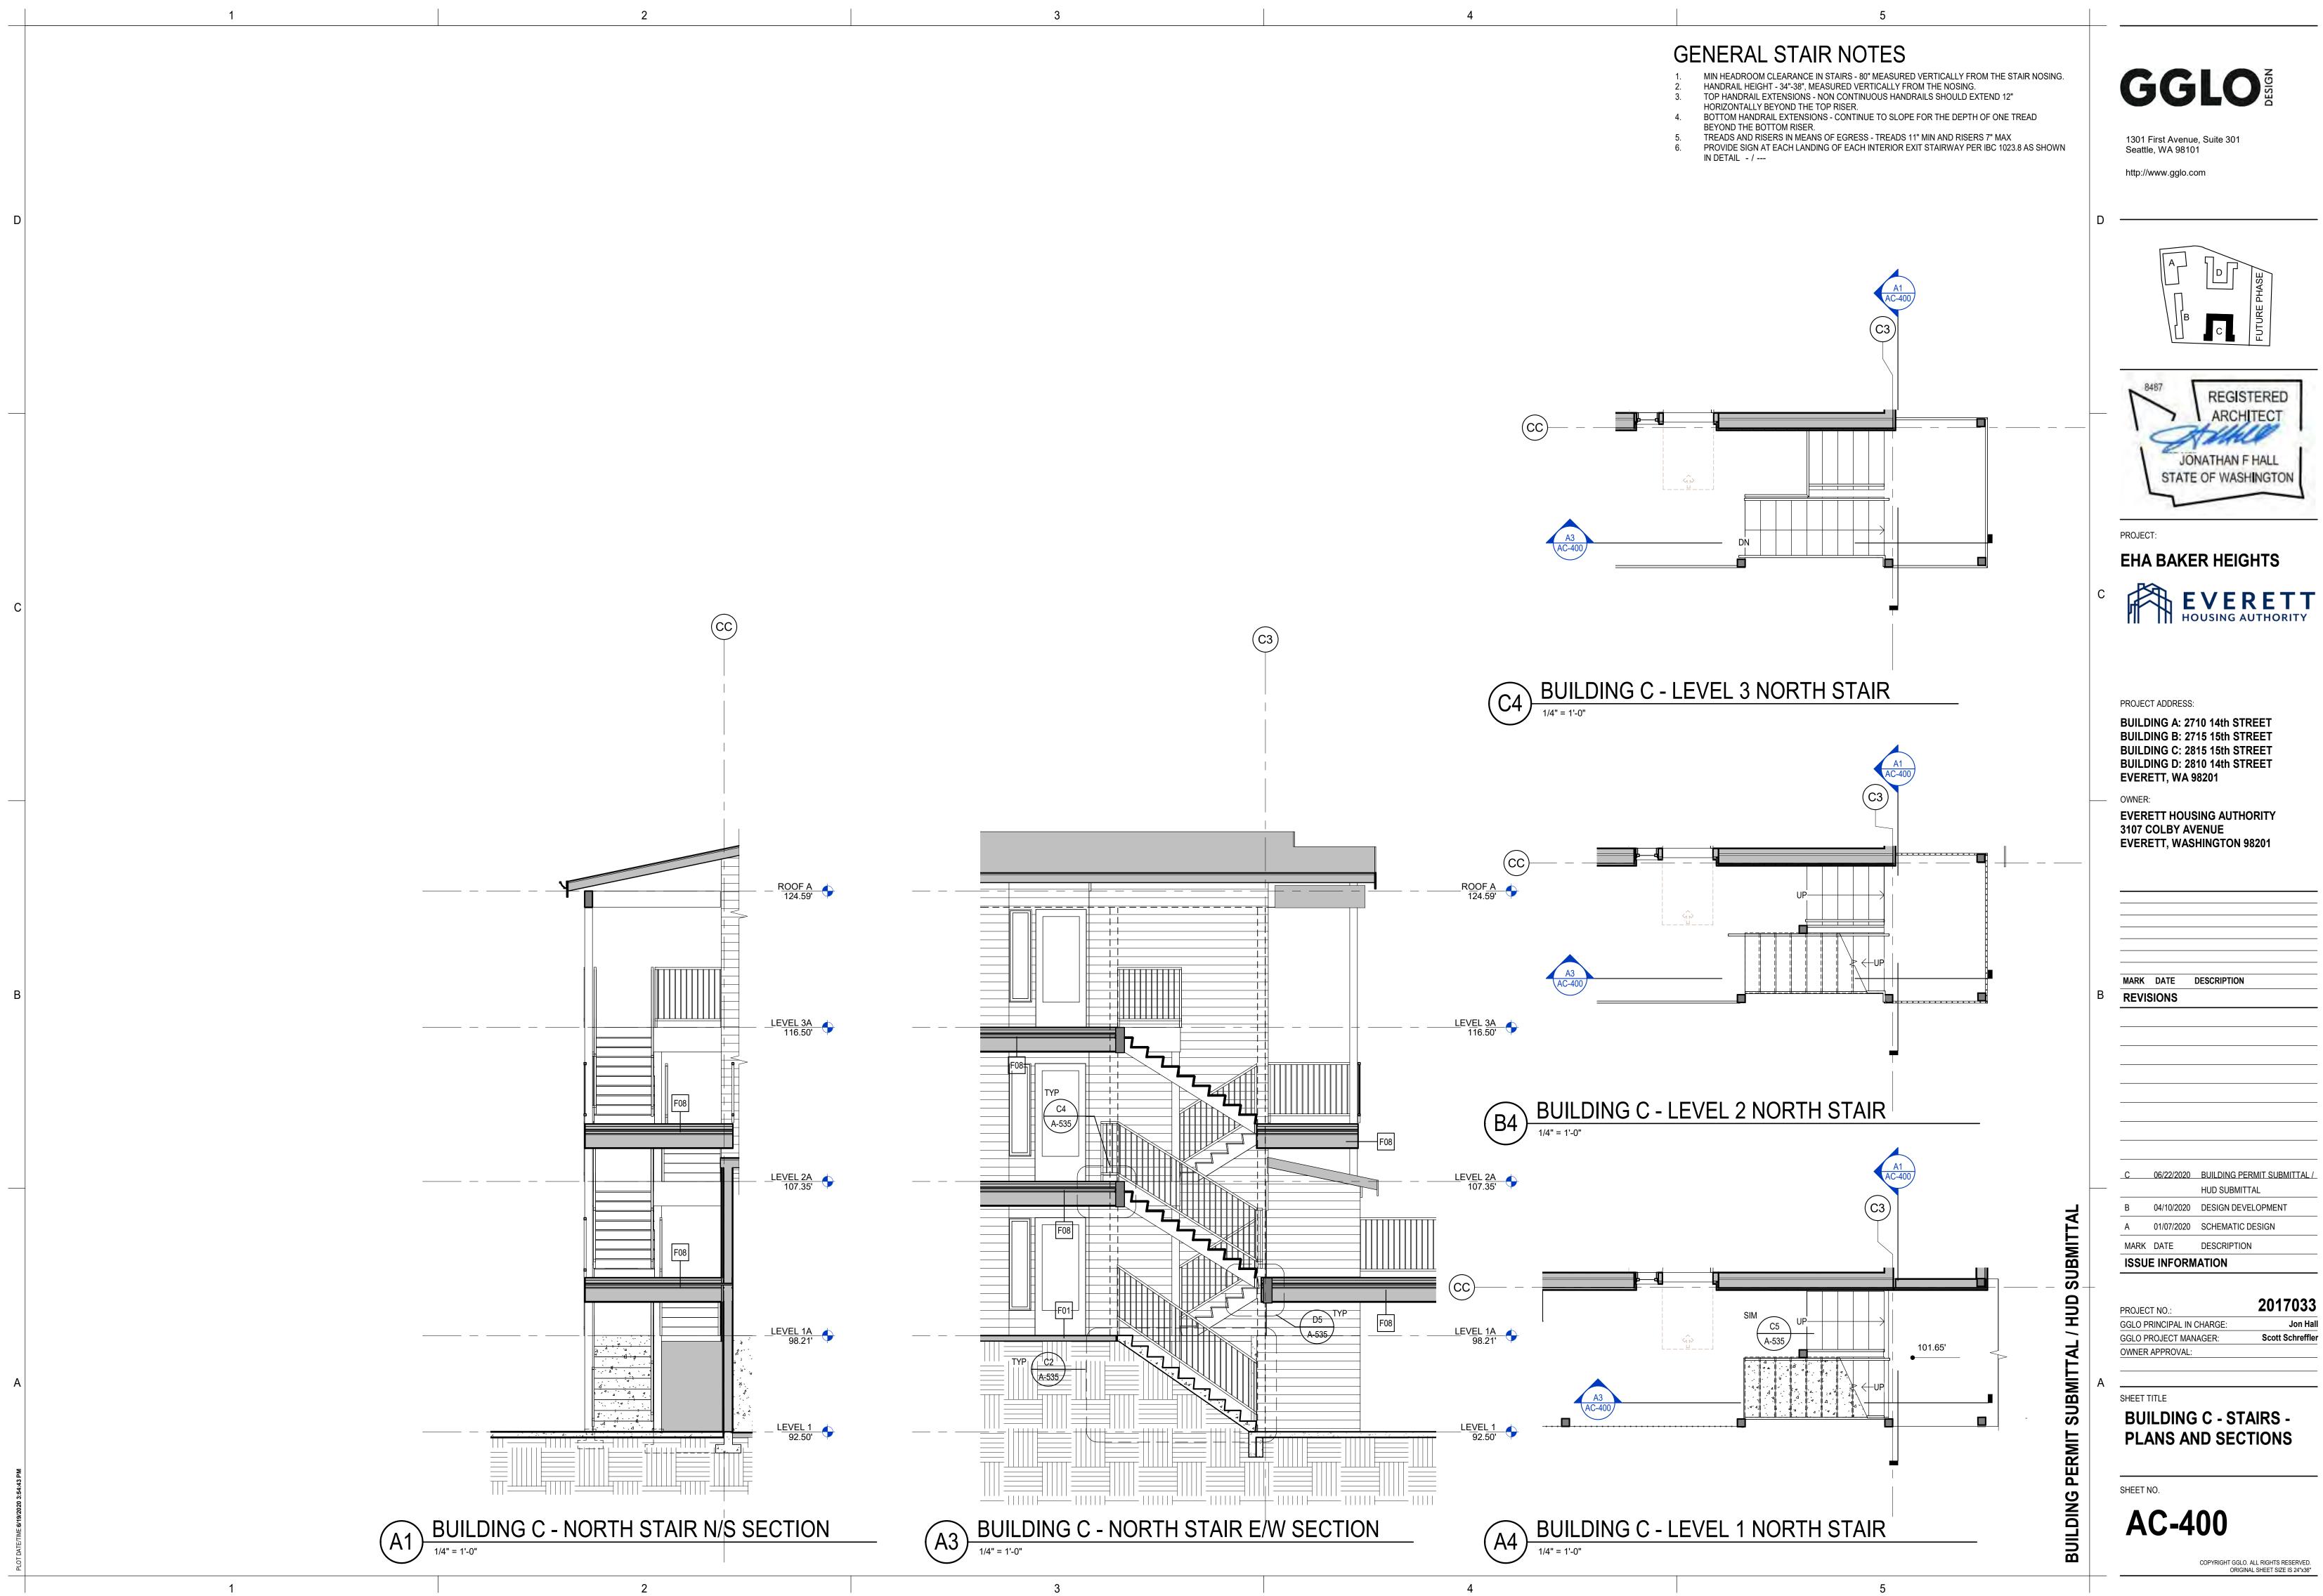


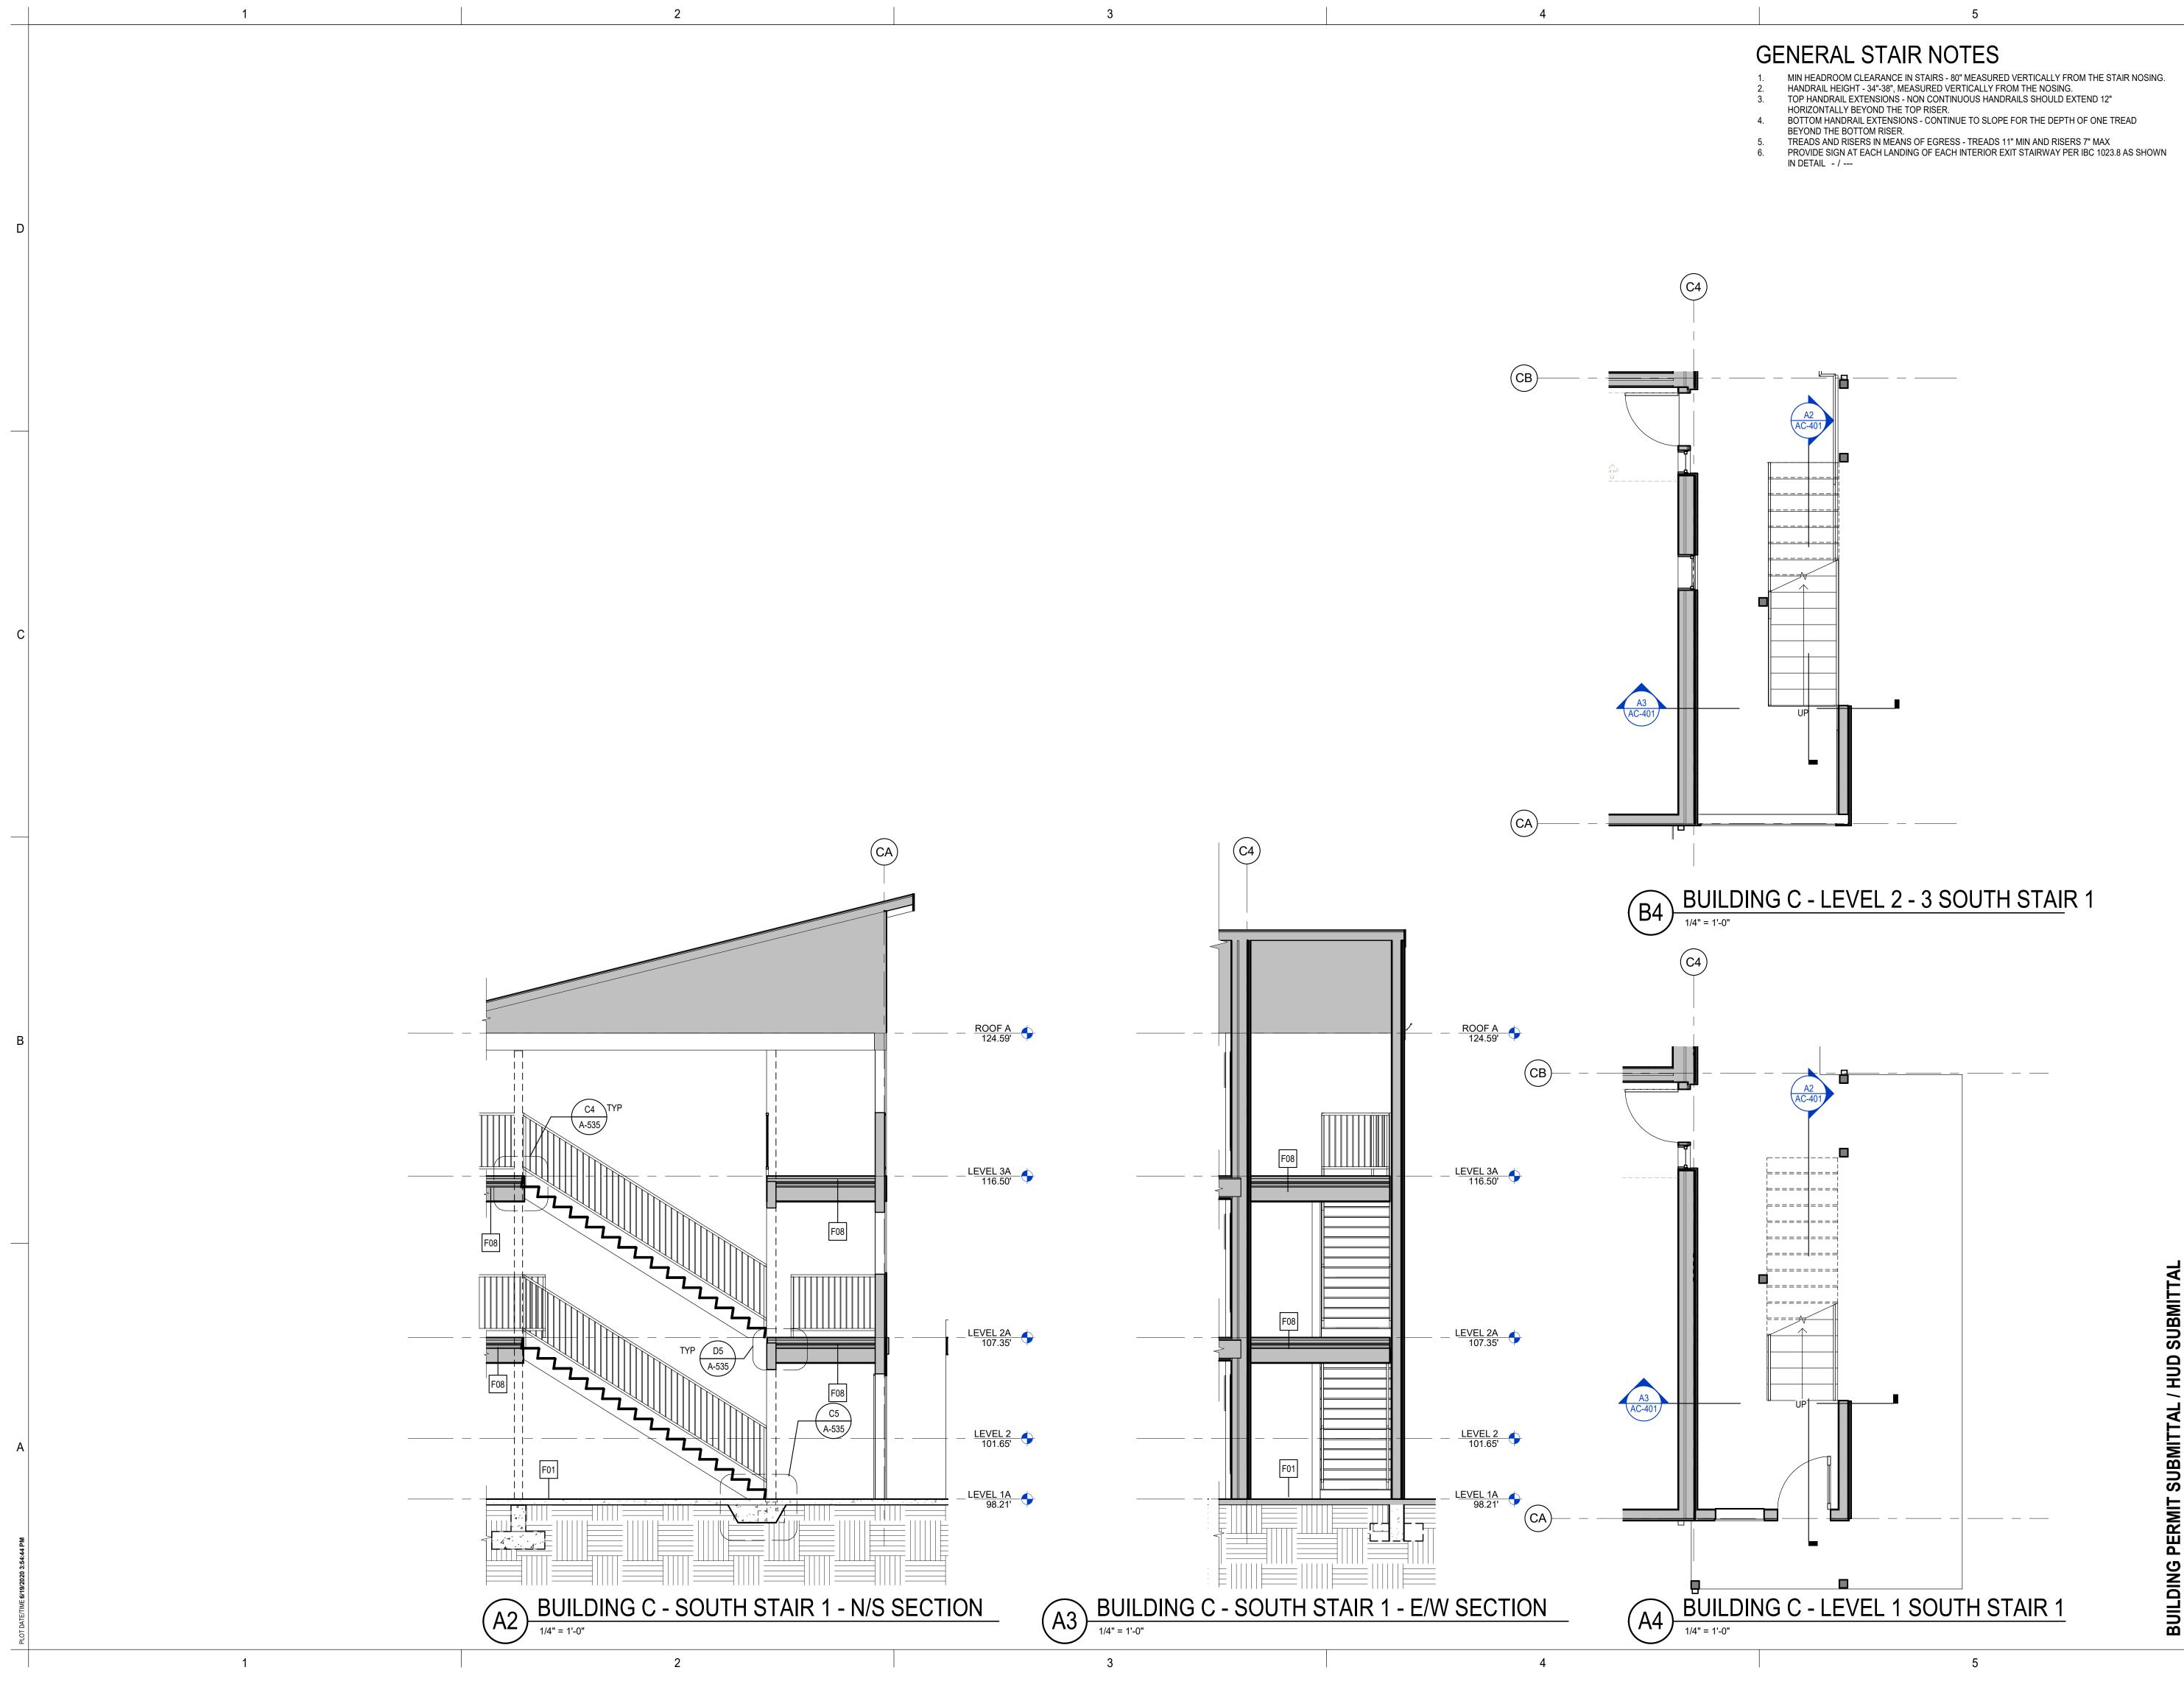
EXTERIOR SIDING LEGEND				
TAG	DESCRIPTION	COLOR		
G10	SMOOTH FIBER CEMENT SIDING PANEL	SHERWIN WILLIAMS 7017 DORIAN		
G12	SMOOTH FIBER CEMENT SIDING PANEL	SHERWIN WILLIAMS 7047 PORPO		
G13	SMOOTH FIBER CEMENT SIDING PANEL	SHERWIN WILLIAMS 6124 CARDB		
G41	FIBER-CEMENT LAP SIDING - 10.75" EXPOSURE	SHERWIN WILLIAMS 6124 CARDB		
G42	FIBER-CEMENT LAP SIDING - 10.75" EXPOSURE	SHERWIN WILLIAMS 7047 PORPO		
G44	FIBER-CEMENT LAP SIDING - 10.75" EXPOSURE	SHERWIN WILLIAMS 7017 DORIAN		
G47	FIBER-CEMENT LAP SIDING- 10.75" EXPOSURE	SHERWIN WILLIAMS 6320 BRAVA		

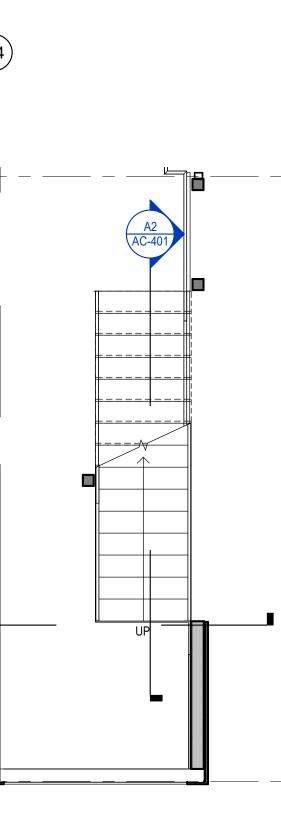


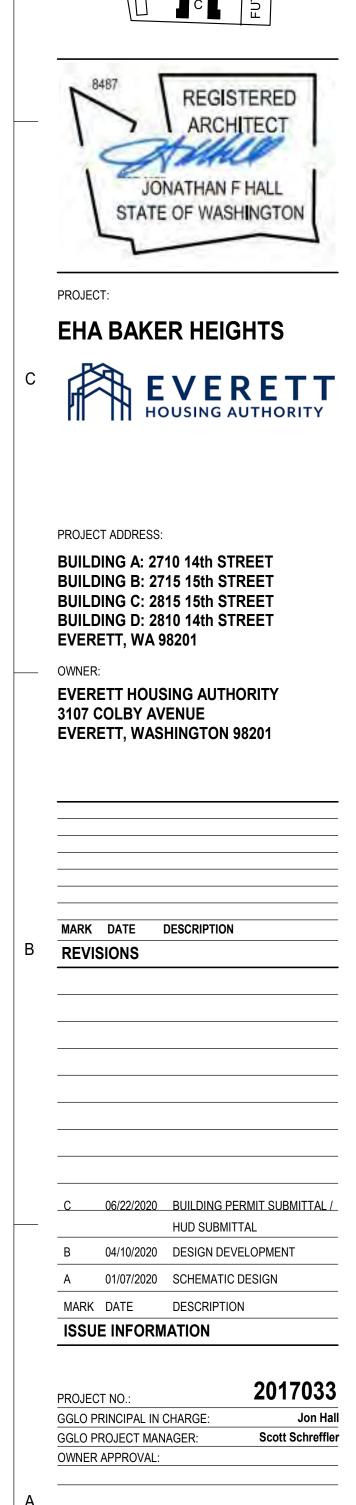
EXTERIOR SIDING LEGEND		
TAG	DESCRIPTION	COLOR
G10	SMOOTH FIBER CEMENT SIDING PANEL	SHERWIN WILLIAMS 7017 DORIAN
G12	SMOOTH FIBER CEMENT SIDING PANEL	SHERWIN WILLIAMS 7047 PORPOI
G13	SMOOTH FIBER CEMENT SIDING PANEL	SHERWIN WILLIAMS 6124 CARDBO
G41	FIBER-CEMENT LAP SIDING - 10.75" EXPOSURE	SHERWIN WILLIAMS 6124 CARDBO
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G47	FIBER-CEMENT LAP SIDING- 10.75" EXPOSURE	SHERWIN WILLIAMS 6320 BRAVAD











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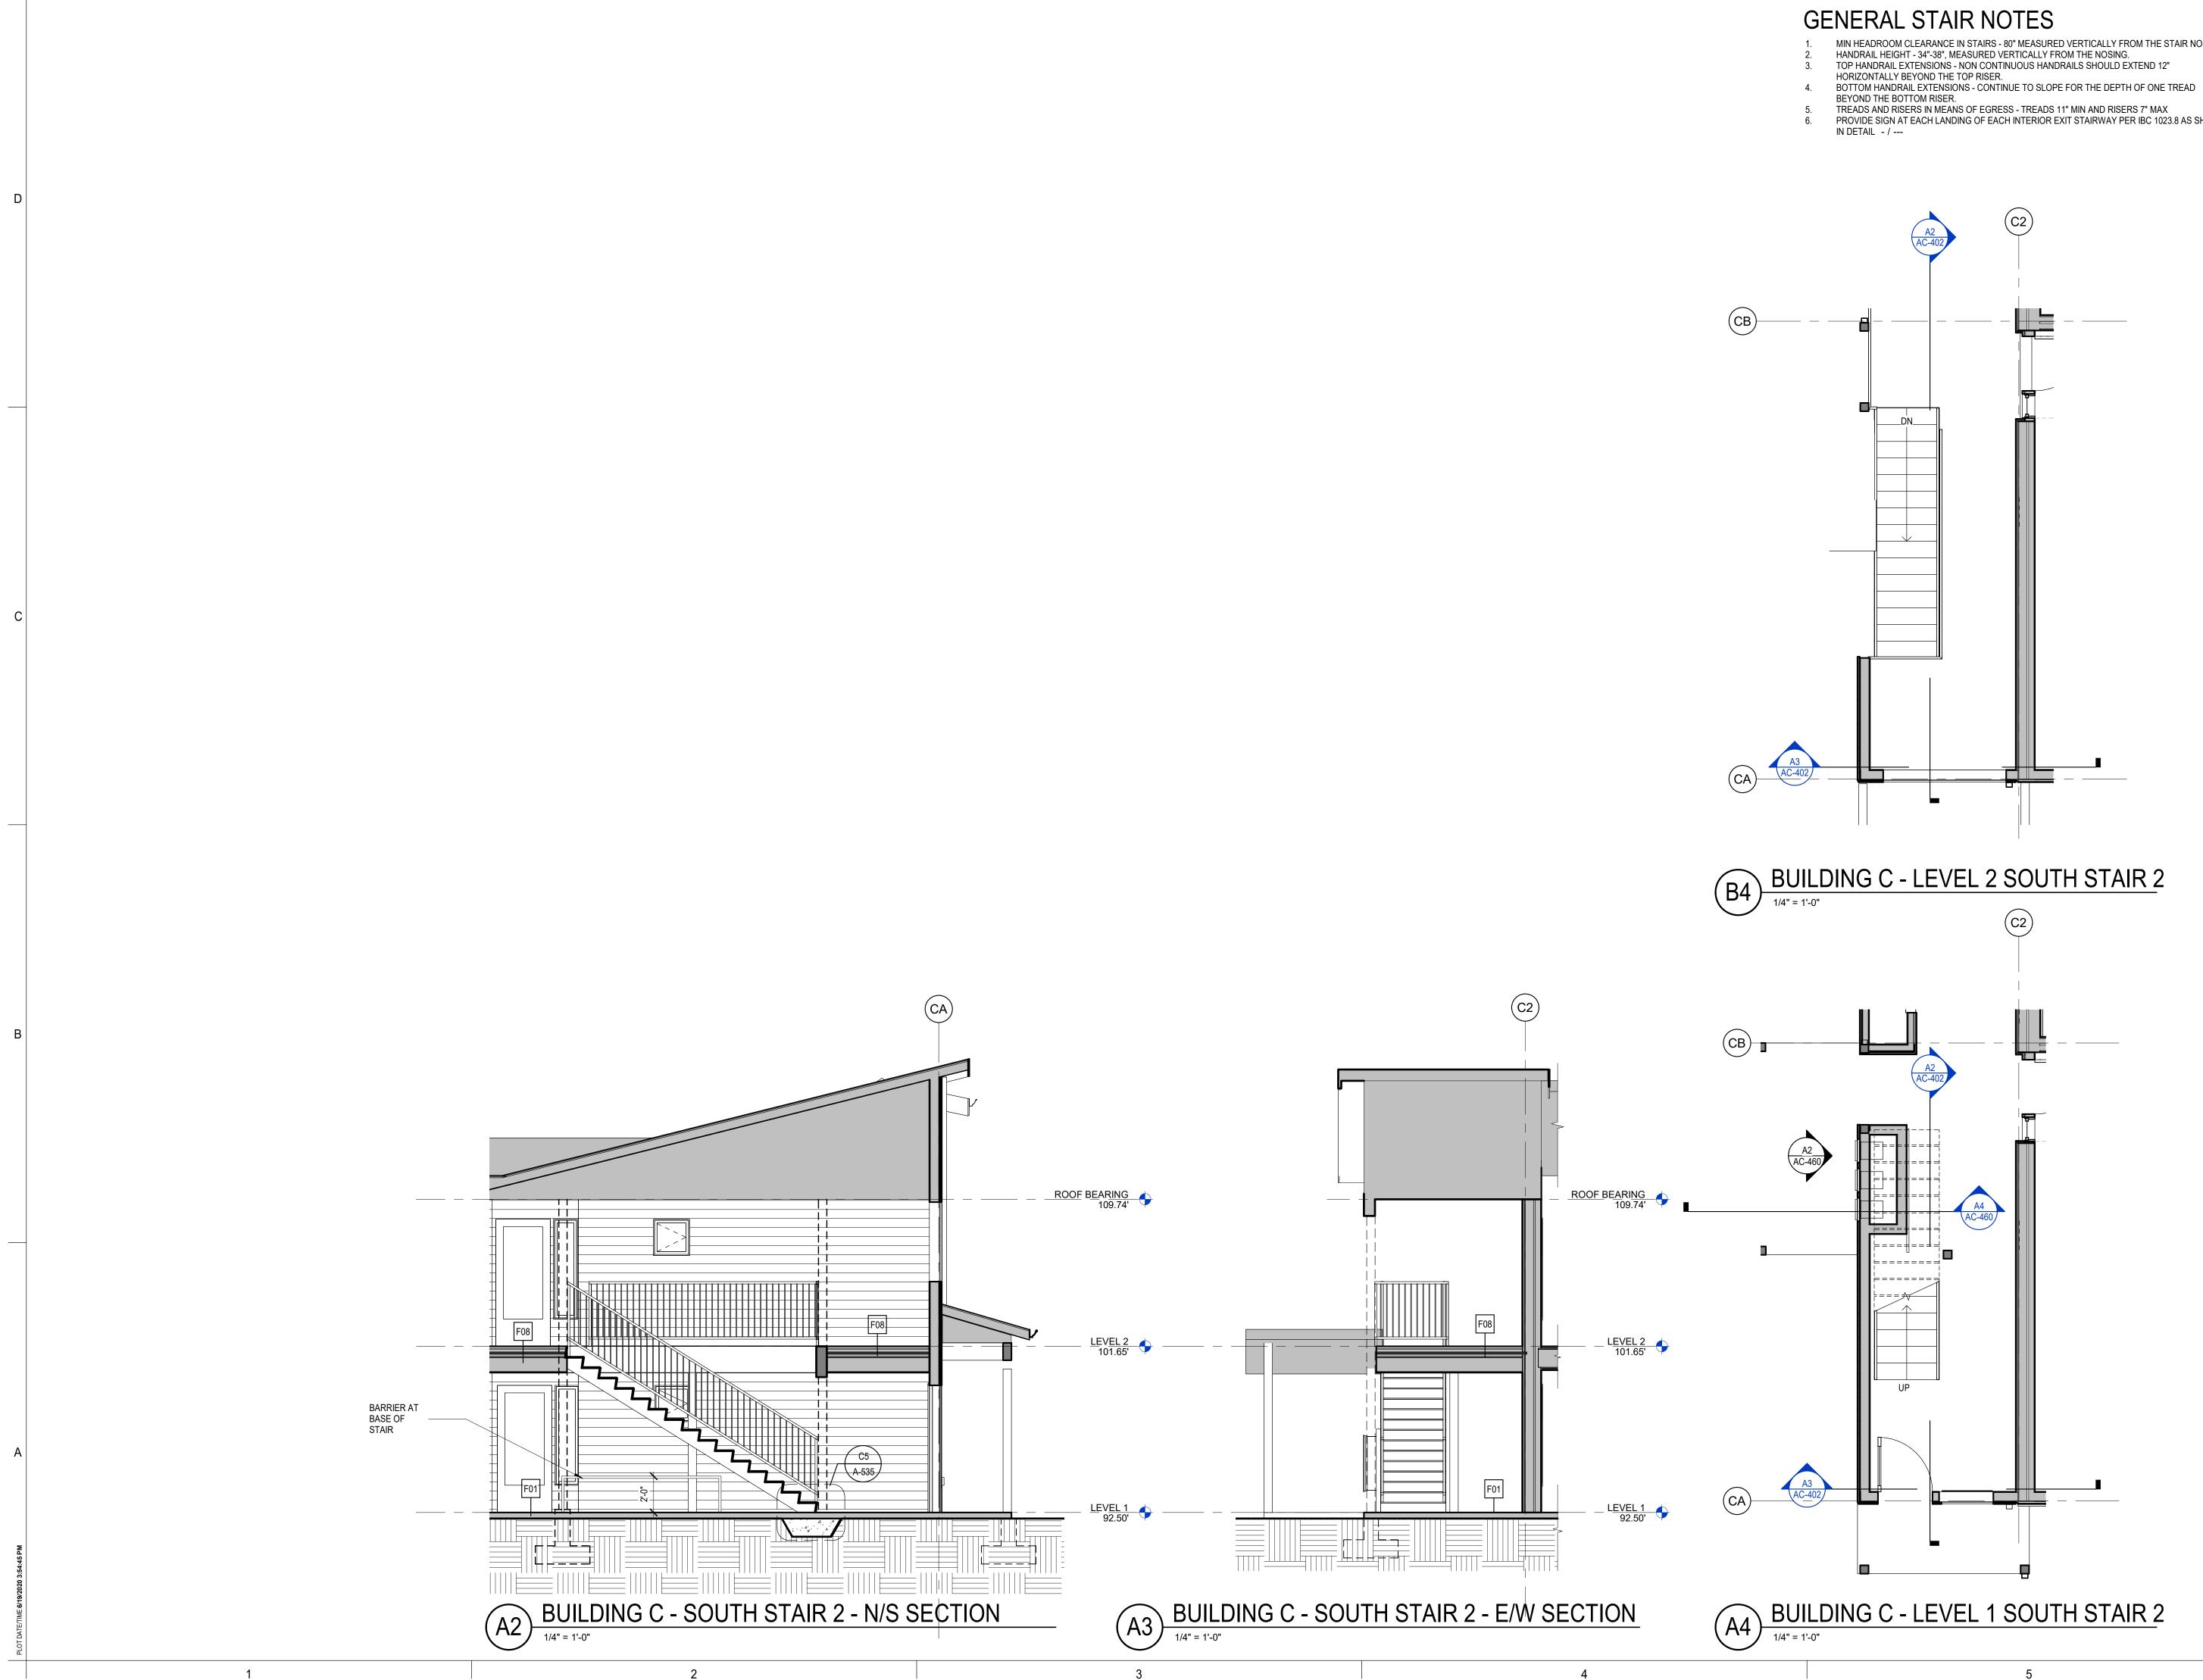
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SHEET TITLE BUILDING C - STAIRS -

SHEET NO.

PLANS AND SECTIONS

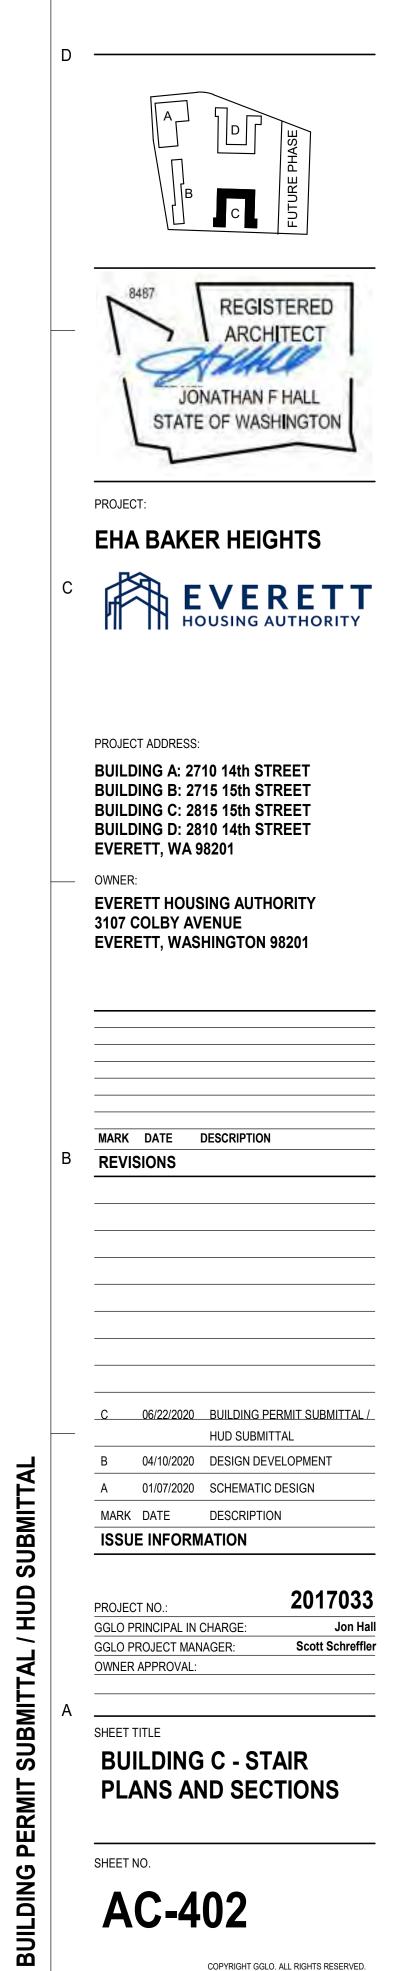
AC-401





- MIN HEADROOM CLEARANCE IN STAIRS 80" MEASURED VERTICALLY FROM THE STAIR NOSING. HANDRAIL HEIGHT 34"-38", MEASURED VERTICALLY FROM THE NOSING.

- PROVIDE SIGN AT EACH LANDING OF EACH INTERIOR EXIT STAIRWAY PER IBC 1023.8 AS SHOWN

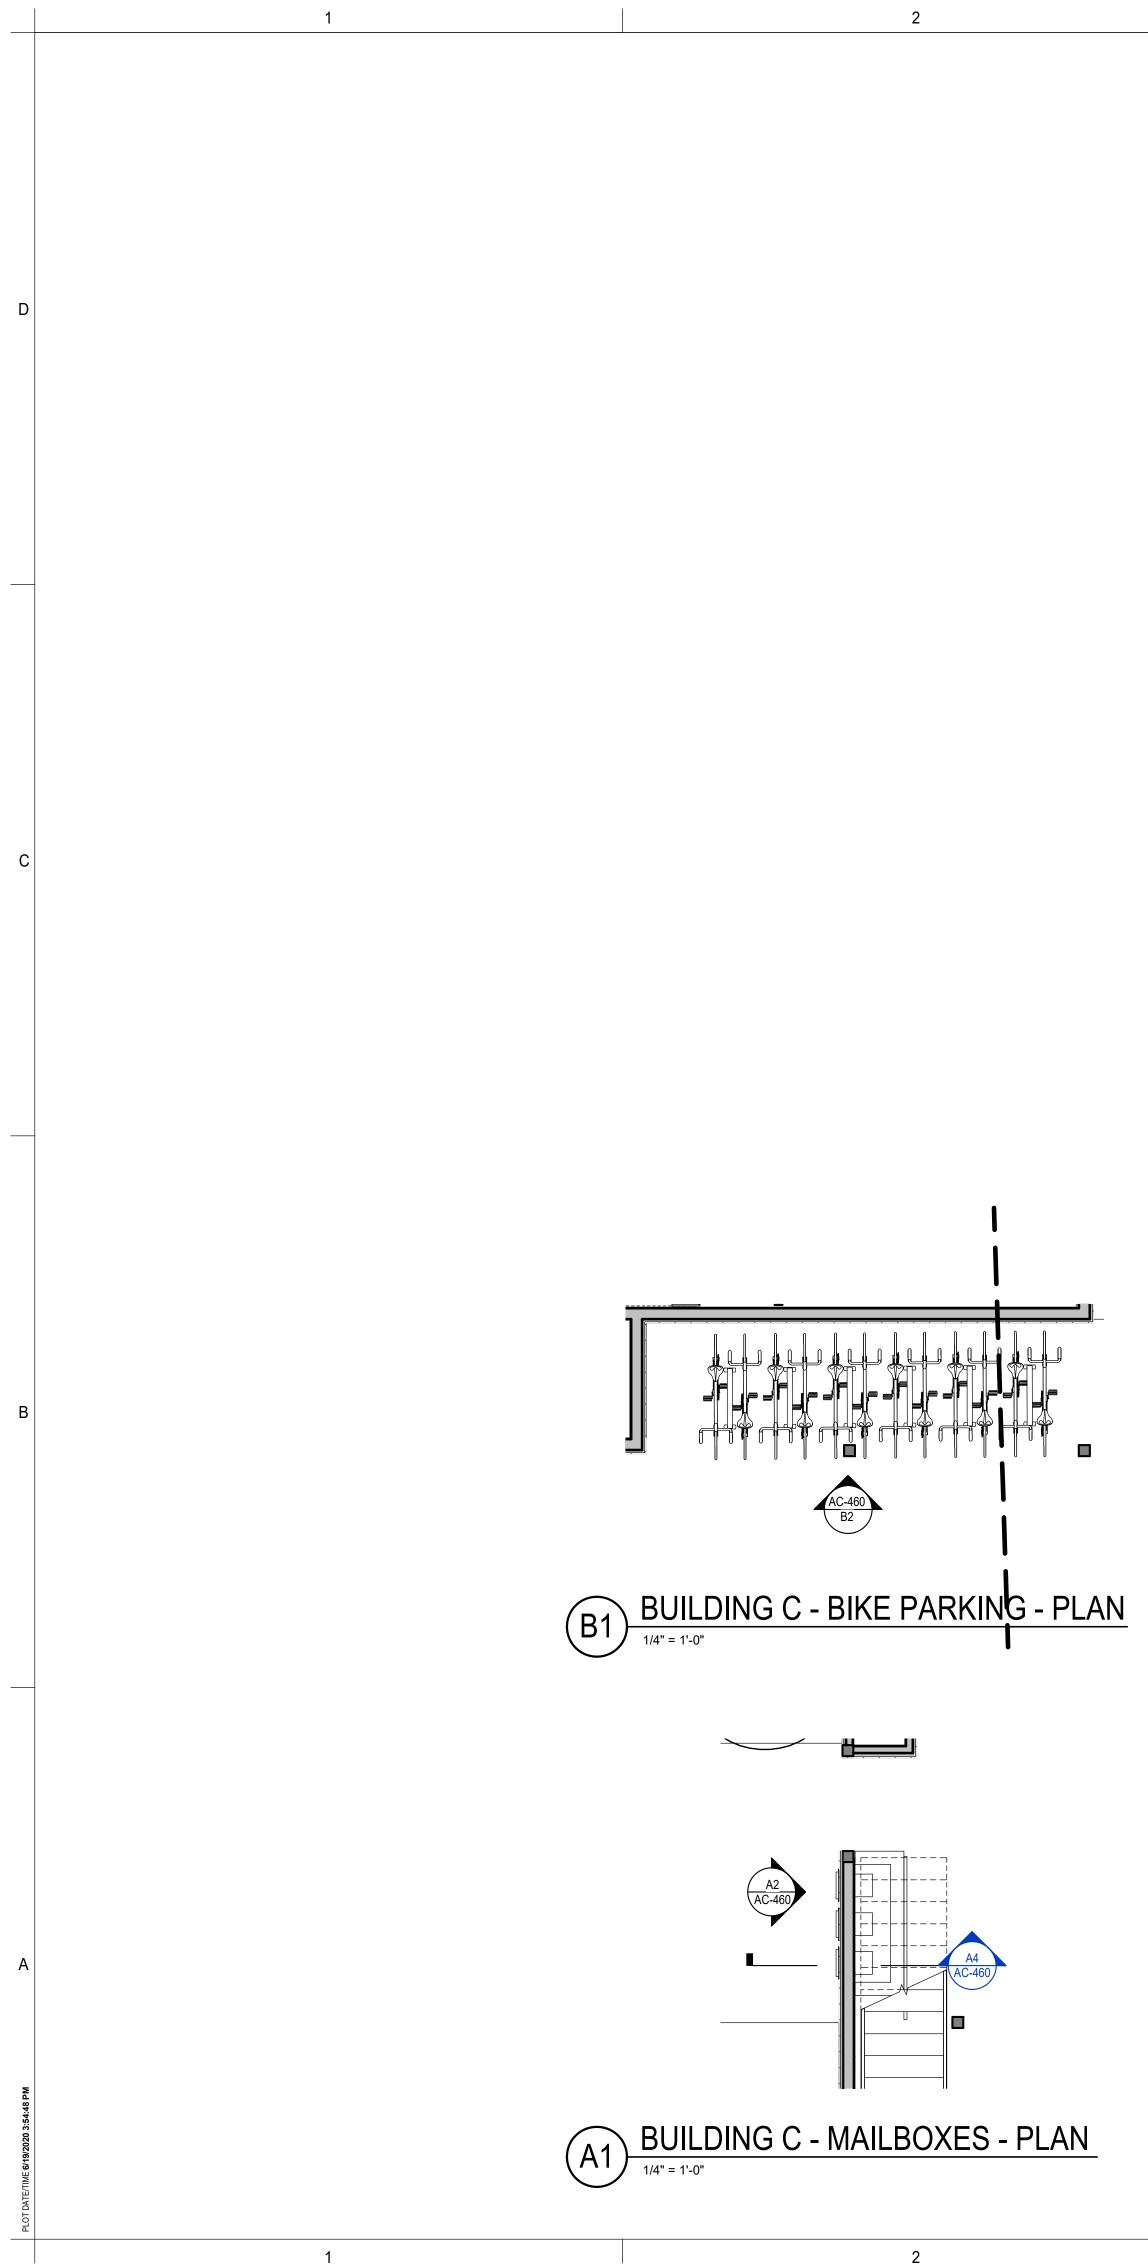


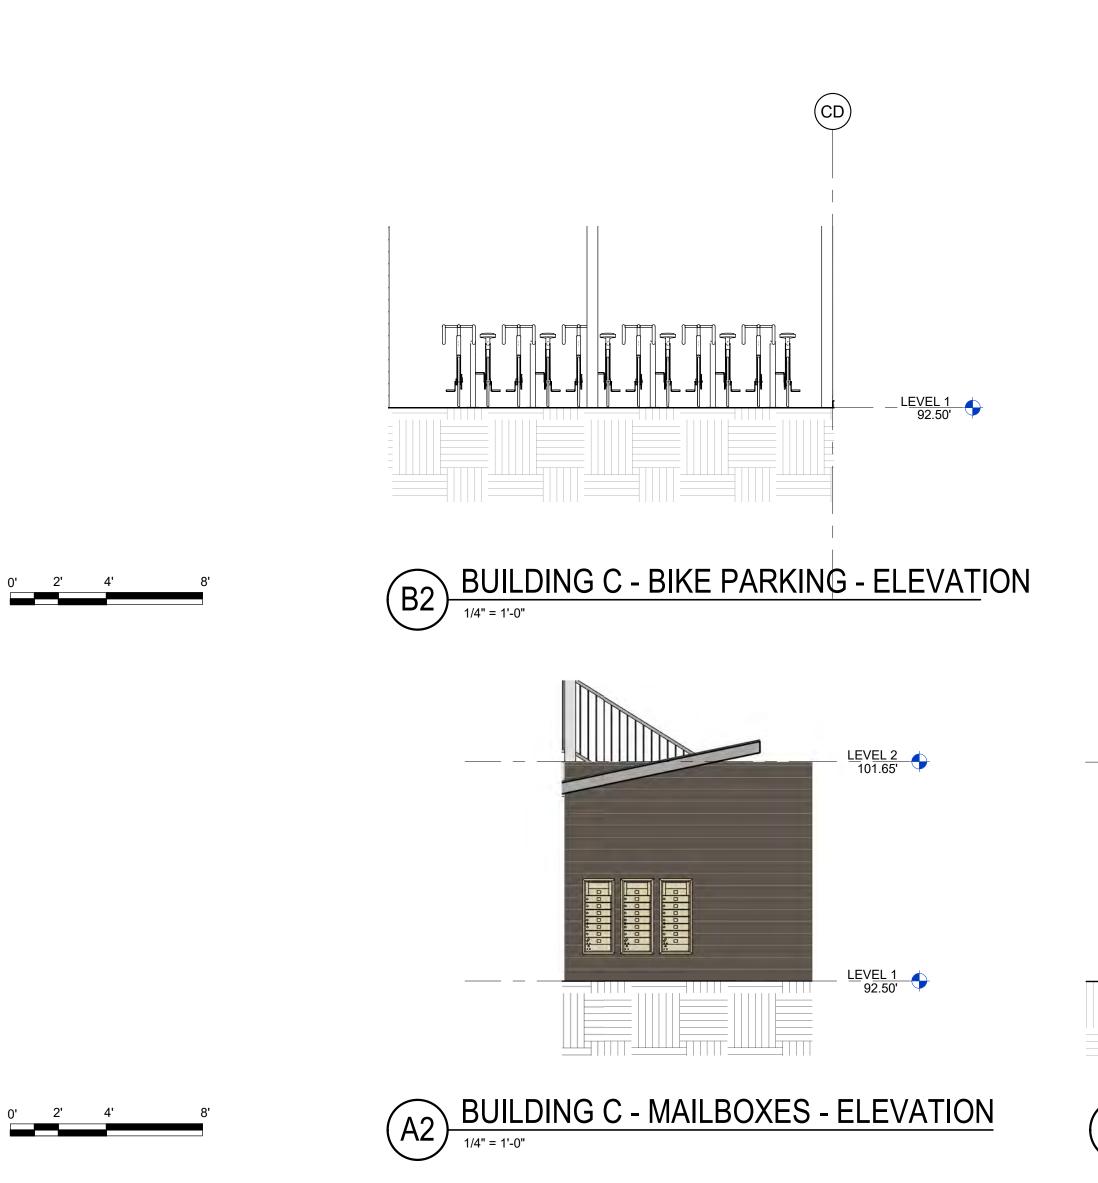
**GGLO**<sup>NO</sup>

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