PLUMBING ABBREVIATIONS

AD ACCESS DOOR

AFF ABOVE FINISHED FLOOR

AP ACCESS PANEL

BFF BELOLW FINISHED FLOOR

BFP BACK FLOW PREVENTER

BLDG BUILDING

CFF CAPPED FOR FUTURE

CLG CEILING

CONT CONTINUATION

COORD COORDINATE

CTE CONNECT TO EXISTING

CU COPPER

DC DOUBLE CONTAINED

DFU DRAINAGE FIXTURE UNIT

DIA DIAMETER

DIA DIAMETER

DIW DOWN IN WALL

DN DOWN

DS DOWNSPOUT

DW DISHWASHER
DWG DRAWING

E.C.O. EXTERIOR CLEANOUT

ENC ENCLOSURE

EXIST. EXISTING

FCO FLOOR CLEANOUT

FDC FIRE DEPARTMENT CONNECTION

GCO GROUND CLEANOUT

GD GARBAGE DISPOSER

GPM GALLONS PER MINUTE

HVAC HEATING, VENTILATING AND AIR CONDITIONING

ID INTERIOR DESIGNER

INV. INVERT ELEVATION

MAX MAXIMUM

MBH 1000 BTU/HR.

MFR MANUFACTURER

MIN MINIMUM

MTD MOUNTED

NTS NOT TO SCALE

(R) REMOVE

RD ROOF DRAIN

(REL.) RELOCATED

RM ROOM

SS STAINLESS STEEL

VBG VENT BELOW GRADE

VTR VENT THROUGH ROOF

WCO WALL CLEANOUT

WHA WATER HAMMER ARRESTOR

PLUMBING	SYSTEMS

> POINT OF CONNECTION TO EXISTING SYSTEM

				F	PLUM	BING	FIX	CTURE SCHEDULE
ITEM	DESIGNATION	MANUF / MODEL#	FINISH	æ	V	C.W.	H.W.	DESCRIPTION
<u>WC-1</u>	FLUSH VALVE TOILET (ADA COMPLIANT)	AMERICAN STANDARD / 3641.001.020	WHITE	3"	2"	1"	-	-AMERICAN STANDARD *215AA.104.020, VITREOUS CHINA, 1.28 GPF, POWERWASH RIM SCRUBS BOWL WITH EACH FLUSH, 3" FLUSH VALVE, CHROME FINISH TRIP LEVER IS SUPPLIED.
<u>UR-1</u>	URINAL (ADA COMPLIANT)	PROFLO PF1825WH		2"	1 1/2"	3/4"	ı	-PROFLO PF1825WH. VITREOUS CHINA, ADA COMPLIANT (INSTALL AT 17" A.F.F.), HIGH EFFICIENCY, 3/4" TOP SPUD, 2" REAR OUTLET, I.Ø GALLON PER FLUSH, INCLUDES HANGING WALL BRACKET AMERICAN STANDARD 6045.101.002 1.Ø GPF MANUAL URINAL FLUSH VALVE.
<u>L-1</u>	LAVATORY (UNITS/BATHING) (ADA COMPLIANT)	AMERICAN STANDARD (LUCERNE WALL MOUNTED SINK)	2" 1 1/2" WHITE Ø2Ø	1/2"	2"	1/2"	1/2"	LUCERNE WALL-MOUNT LAYATORY, VITREOUS CHINA, WALL-MOUNT CARRIER MODEL 0356.015 8" CTS WITH CONCEALED ARMS, DBL-HOLE, WHITE, OVERFLOW HOLE "SLOAN" FAUCET (MODEL SF-2150), SINGLE LEVEL HANDLE, 12 GPM, INCLUDES SOAP DISPENSER, BRASS CONSTRUCTION, SINGLE-HOLE INSTALLATION, POLISHED CHROME, PRE-ATTACHED FLEXIBLE SUPPLY LINES. POINT OF USE SHALL BE PROPERLY TEMPERED DOWN TO A MAX. OF 109 DEG. TEMPERATURE BY USE OF A PERMANENT TEMPERATURE MIXING DEVICE.
<u>IM-1</u>	ICE MAKER BOX	SIOUX CHIEF / *696		-	-	1/2"	-	-SERIES 696 OX BOX ICE MACHINE OUTLET BOX WITH WATER HAMMER ARRESTOR.
EWC-1	ELECTRIC WATER COOLER LZSTL8WSLK	ELKAY / WGB38423IN		2"	2"	1/2"	-	-TWO STATION WALL MOUNTED WATER COOLER WITH REFILLING STATION & BARRIER FREE ACCESS.
<u>5-1</u>	KIT. SINK	AMERICAN STANDARD / 228B.62522838.075		2"	1 1/2"	1/2"	1/2"	-ADA 25"X22" DROP-IN SINGLE COMPARTMENT SINK WITH FAUCET LEDGE: SINGLE HOLE. MOEN FAUCET *1594EWSRS WITH HIGH ARC SINGLE ARBOR HANDLE. SPOT RESISTANT S/S
<u>MS-1</u>	MOP SINK	MUSTEE / *63M		2"	2"	1/2"	1/2"	-MOP SERVICE BASIN. WITH THREE MOP HANDLE HANGERS, "DURAGUARD" WALL GUARDS AND 2" DRAIN SEAL. -MUSTEE *63,000A - WALLMOUNT SERVICE SINK FAUCET. TWO HANDLE, CHROME PLATED FINISH, HOSE W/HOSE HOLDER, PAIL HOOK, AND WALL BRACE.

1. COORDINATE WITH ID FOR FINISHES OF FIXTURES AND FAUCETS.
2. COORDINATE WITH ARCHITECT/ENGINEER FOR ANY DISCREPANCY PRIOR TO BIDDING.
3. ALL WALL HUNG FIXTURES SHOULD BE INSTALLED WITH FLOOR MOUNTED WALL HANGER SUPPORT.
4. COORDINATE WITH ARCHITECTURAL FOR PLUMBING FIXTURES EXACT LOCATIONS.
5. CONTRACTOR TO BE RESPONSIBLE FOR INSTALLING ALL NECESSARY AND OPTIONAL HARDWARE, FITTINGS, VALVES, MIXING VALVES, ESCUTCHEONS, MATERIALS, EQUIPMENT, ACCESSORIES, ETC. TO ASSURE SYSTEMS FUNCTION AS INTENDED BY THIS DESIGN, MANUFACTURER'S RECOMMENDATIONS AND ALL APPLICABLE CODES. FOR ANY DISCREPANCY CONSULT WITH ENGINEER PRIOR TO BIDDING, NO CHANGE ORDER SHALL BE ACCEPTED AFTER CONTRACT IS AWARDED FOR THE SPECIFIED WORK.

PLUMBING GENERAL NOTES

- FLORIDA BUILDING CODE (2017) FOR PLUMBING REFERENCE, SHALL BE THE SOURCE OF INFORMATION (CONTRACTOR SHALL COMPLY WITH ALL NOTES WHERE APPLICABLE)
- 1. CONTRACTOR SHALL BE RESPONSIBLE FOR PROVIDING ALL NECESSARY FITTINGS AS REQUIRED BY ALL APPLICABLE CODES AND GOVERNING AUTHORITIES.
- CONTRACTOR SHALL VERIFY AND CORRECT AS REQUIRED TO MEET ALL CODES AND REGULATIONS
 ANY POSSIBLE DISCREPANCIES BETWEEN TYPE AND SIZE OF CONNECTION SPECIFIED IN PLUMBING
 FIXTURE SCHEDULE AND FIXTURES ACTUALLY INSTALLED ON THE SITE. ALL DOMESTIC WATER PIPING
 TO BE LEAD FREE.
- ALL SANITARY AND WATER SUPPLY LINES SHALL BE MARKED WITH THE SEAL OF APPROVAL OF THE NATIONAL SANITATION FOUNDATION.
- 4. ALL SANITARY PIPING SHALL HAVE A MINIMUM 1/4" PER FOOT SLOPE FOR PIPE UP TO 2 1/2", 1/8" PER FOOT SLOPE PIPE 3" TO 6" AND 1/16" PER FOOT SLOPE FOR PIPING 8" OR LARGER.
- 5. VALVES AND FITTINGS SHALL BE OF THE SAME SIZE AS THE LINE ON WHICH THEY ARE LOCATED UNLESS OTHERWISE INDICATED ON DRAWINGS, INSTALL 12×12 ACCESS PANEL FOR EACH VALVE IF IT IS NOT ACCESSIBLE BY CEILING TILES.
- 6. CONTRACTOR SHALL COORDINATE ALL WORK WITH OTHER TRADES.
- T. CONTRACTOR SHALL FIELD VERIFY ALL MEASUREMENTS AND LOCATIONS OF CONNECTED SANITARY AND WASTE PIPING. NOTIFY ARCHITECT OF ANY DISCREPANCIES PRIOR TO CONSTRUCTION.
- 8. CONTRACTOR SHALL BE RESPONSIBLE FOR MAINTAINING FIRE RATING AND WEATHERPROOFING INTEGRITY OF ALL PIPING PENETRATIONS. SEE ARCHITECTURAL PLANS FOR PENETRATION DETAILS.
- 9. ALL WATER SUPPLY AND SANITARY LINES SHALL RUN AS CLOSE TO PLANS AS POSSIBLE WITH NO CHANGES IN SIZING. ROUTE ALL PIPING CONCEALED ABOVE CEILINGS, WITHIN WALLS, OR IN CHASES
- EXCEPT AS SPECIFICALLY NOTED OR IN MECHANICAL ROOMS.

 10. CONTRACTOR SHALL BE RESPONSIBLE FOR PROVIDING ALL NECESSARY SUPPORTING DEVICES FOR
- 11. INSTALL WATER HAMMER SHOCK ARRESTORS AT BATTERY OF FIXTURES, AND AT EACH FIXTURE WHERE REQUIRED. ARRESTORS SHALL BE FACTORY FABRICATED. INSTALL ARRESTORS AND SIZE PER PLUMBING: AND DRAINAGE INSTITUTE STANDARD P.D.I. WH-201. ACCEPTABLE MANUFACTURERS: SIOUX CHIEF, ZURN, JOSAM AND JAY R. SMITH.
- 12. AIR CHAMBERS SHALL NOT BE CONSIDERED EQUAL TO WATER HAMMER ARRESTORS.
- 13. CONTRACTOR SHALL GIVE 12 HOURS NOTICE TO APPLICABLE UTILITY COMPANY PRIOR TO PERFORMING WORK INVOLVING UTILITIES.

ALL FIXTURES INCLUDED IN CONTRACT, OR HEREIN SPECIFIED OR OTHERWISE.

- 14. PROVIDE ACCESS PANELS TO ALL VALVES AND CLEANOUTS WITHIN CHASES OR ABOVE NON-ACCESSIBLE CEILINGS. REFER TO ARCHITECTURAL DRAWINGS FOR CEILING TYPES.
- 15. REFER TO ARCHITECTURAL DRAWINGS FOR EXACT PLUMBING FIXTURE LOCATIONS, MOUNTING HEIGHTS AND DIMENSIONS.
- 16. CONTRACTOR SHALL INSTALL DIELECTRIC UNIONS AT CONNECTIONS OF DISSIMILAR METALS.
- 17. CONTRACTOR SHALL ROUGH-IN ALL WASTES AND SUPPLIES TO SPECIAL EQUIPMENT ACCORDING TO MANUFACTURERS SHOP DRAWINGS AND MAKE FINAL CONNECTIONS. ALL SUPPLIES SHALL BE VALVED. INSTALL BACK FLOW PREVENTERS WHERE REQUIRED BY CODE.
- 18. CONTRACTOR SHALL SUBMIT SHOP DRAWINGS (INCLUDING PIPE ROUTING AND EQUIPMENT LOCATION)
 TO ARCHITECT/ENGINEER FOR REVIEW PER PROJECT SPECIFICATIONS.
- 19. MOUNT THE FLUSH HANDLES ON THE WATER CLOSETS IN THE ACCESSIBLE TOILET ROOMS TOWARD THE WIDE SIDE OF THE ROOM.
- 20. REFER TO SPECIFICATIONS FOR ALL PIPING MATERIALS AND INSULATION REQUIREMENTS.
- 21. DRAWINGS, SPECIFICATIONS AND THE FLORIDA BUILDING CODE ARE PART OF THE DESIGN SET. IF THERE IS ANY CONFLICT OR DISCREPANCY BETWEEN THEM, THE MORE STRICT RULE SHALL BE ENFORCED. REQUESTS FOR INFORMATION MAY BE SUBMITTED TO THE ENGINEER FOR CLARIFICATIONS PRIOR TO BIDDING AS PER PROJECT SPECIFICATIONS.
- 22. USE 1/4 TURN VALVES AT ALL PLUMBING FIXTURES AND FAUCET SUPPLY WATER LINE.
- 23. PROVIDE 1/2"CW SUPPLY WITH ANGLE STOP AND FLEXIBLE SUPPLY TO REFRIGERATOR(S) WITH ICE MAKERS, AT HEIGHT REQUIRED BY MANUFACTURER OF EQUIPMENT INSTALLED.
- 24. SEAL AND PROTECT ALL FLOOR PENETRATIONS.
- 25. CONNECT ALL CONDENSATE TO STORM DRAIN OR LANDSCAPE, UNLESS NOTED OTHERWISE.
- 26. INSTALL WATER PRESSURE REDUCING VALVE AT THE OUTLET OF EACH COLD WATER BRANCH OR RISER SUPPLIED BY DOMESTIC WATER PUMP. WATER PRESSURE REDUCING VALVE SHALL BE "WATTS" MODEL * LF25AVB-23 OR EQUAL, SEE DRAWINGS FOR SIZE. IT IS RECOMMENDED THAT A VELOCITY BETWEEN 5 AND 8 FEET PER SECOND BE MAINTAINED.
- 27. THE CONTRACTOR IS EXPECTED TO ORDER ALL MATERIALS IN SUFFICIENT TIME TO AVOID DELAYING THE COMPLETION OF THE PROJECT. DELAY IN DELIVERIES WILL NOT BE CONSIDERED A JUSTIFIABLE REASON FOR SUBMISSION OF SUBSTITUTE MATERIALS.
- 28. COORDINATE WITH INTERIOR DESIGN FOR FINISHES OF FIXTURES AND FAUCETS.

INDEX OF PLUMBING DRAWINGS

PIØI PARTIAL FIRST FLOOR PLUMBING PLAN P5ØI PARTIAL ISOMETRIC PLUMBING DIAGRAMS

PDIØI PARITAL FIRST FLOOR PLUMBING DEMOLITION PLAN


POOI GENERAL PLUMBING INFORMATION

P601 PLUMBING DETAILS

- 29. COORDINATE ANY DISCREPANCIES WITH ARCHITECT/ENGINEER PRIOR TO BIDDING.
- 30. ALL WALL HUNG FIXTURES SHOULD BE INSTALLED WITH FLOOR MOUNTED WALL HANGER SUPPORT.

 31. PROVIDE WITH ALL NECESSARY AND OPTIONAL HARDWARE, FITTINGS, ESCUTCHEONS, ETC. TO ASSURE
- SYSTEMS WORK PROPERLY. COORDINATE ANY DISCREPANCIES WITH ENGINEER PRIOR TO BIDDING.
 NO CHANGE ORDER SHALL BE ACCEPTED AFTER CONTRACT IS AWARDED FOR THE SPECIFIED WORK.

 34. HOT WATER PIPING SHALL BE INSULATED WITH I" OF INSULATION HAVING CONDUCTIVITY NOT

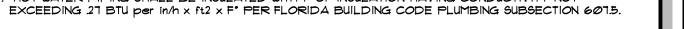

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DATE: ISSUED FOR:

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PROJECT NO: 19079.00


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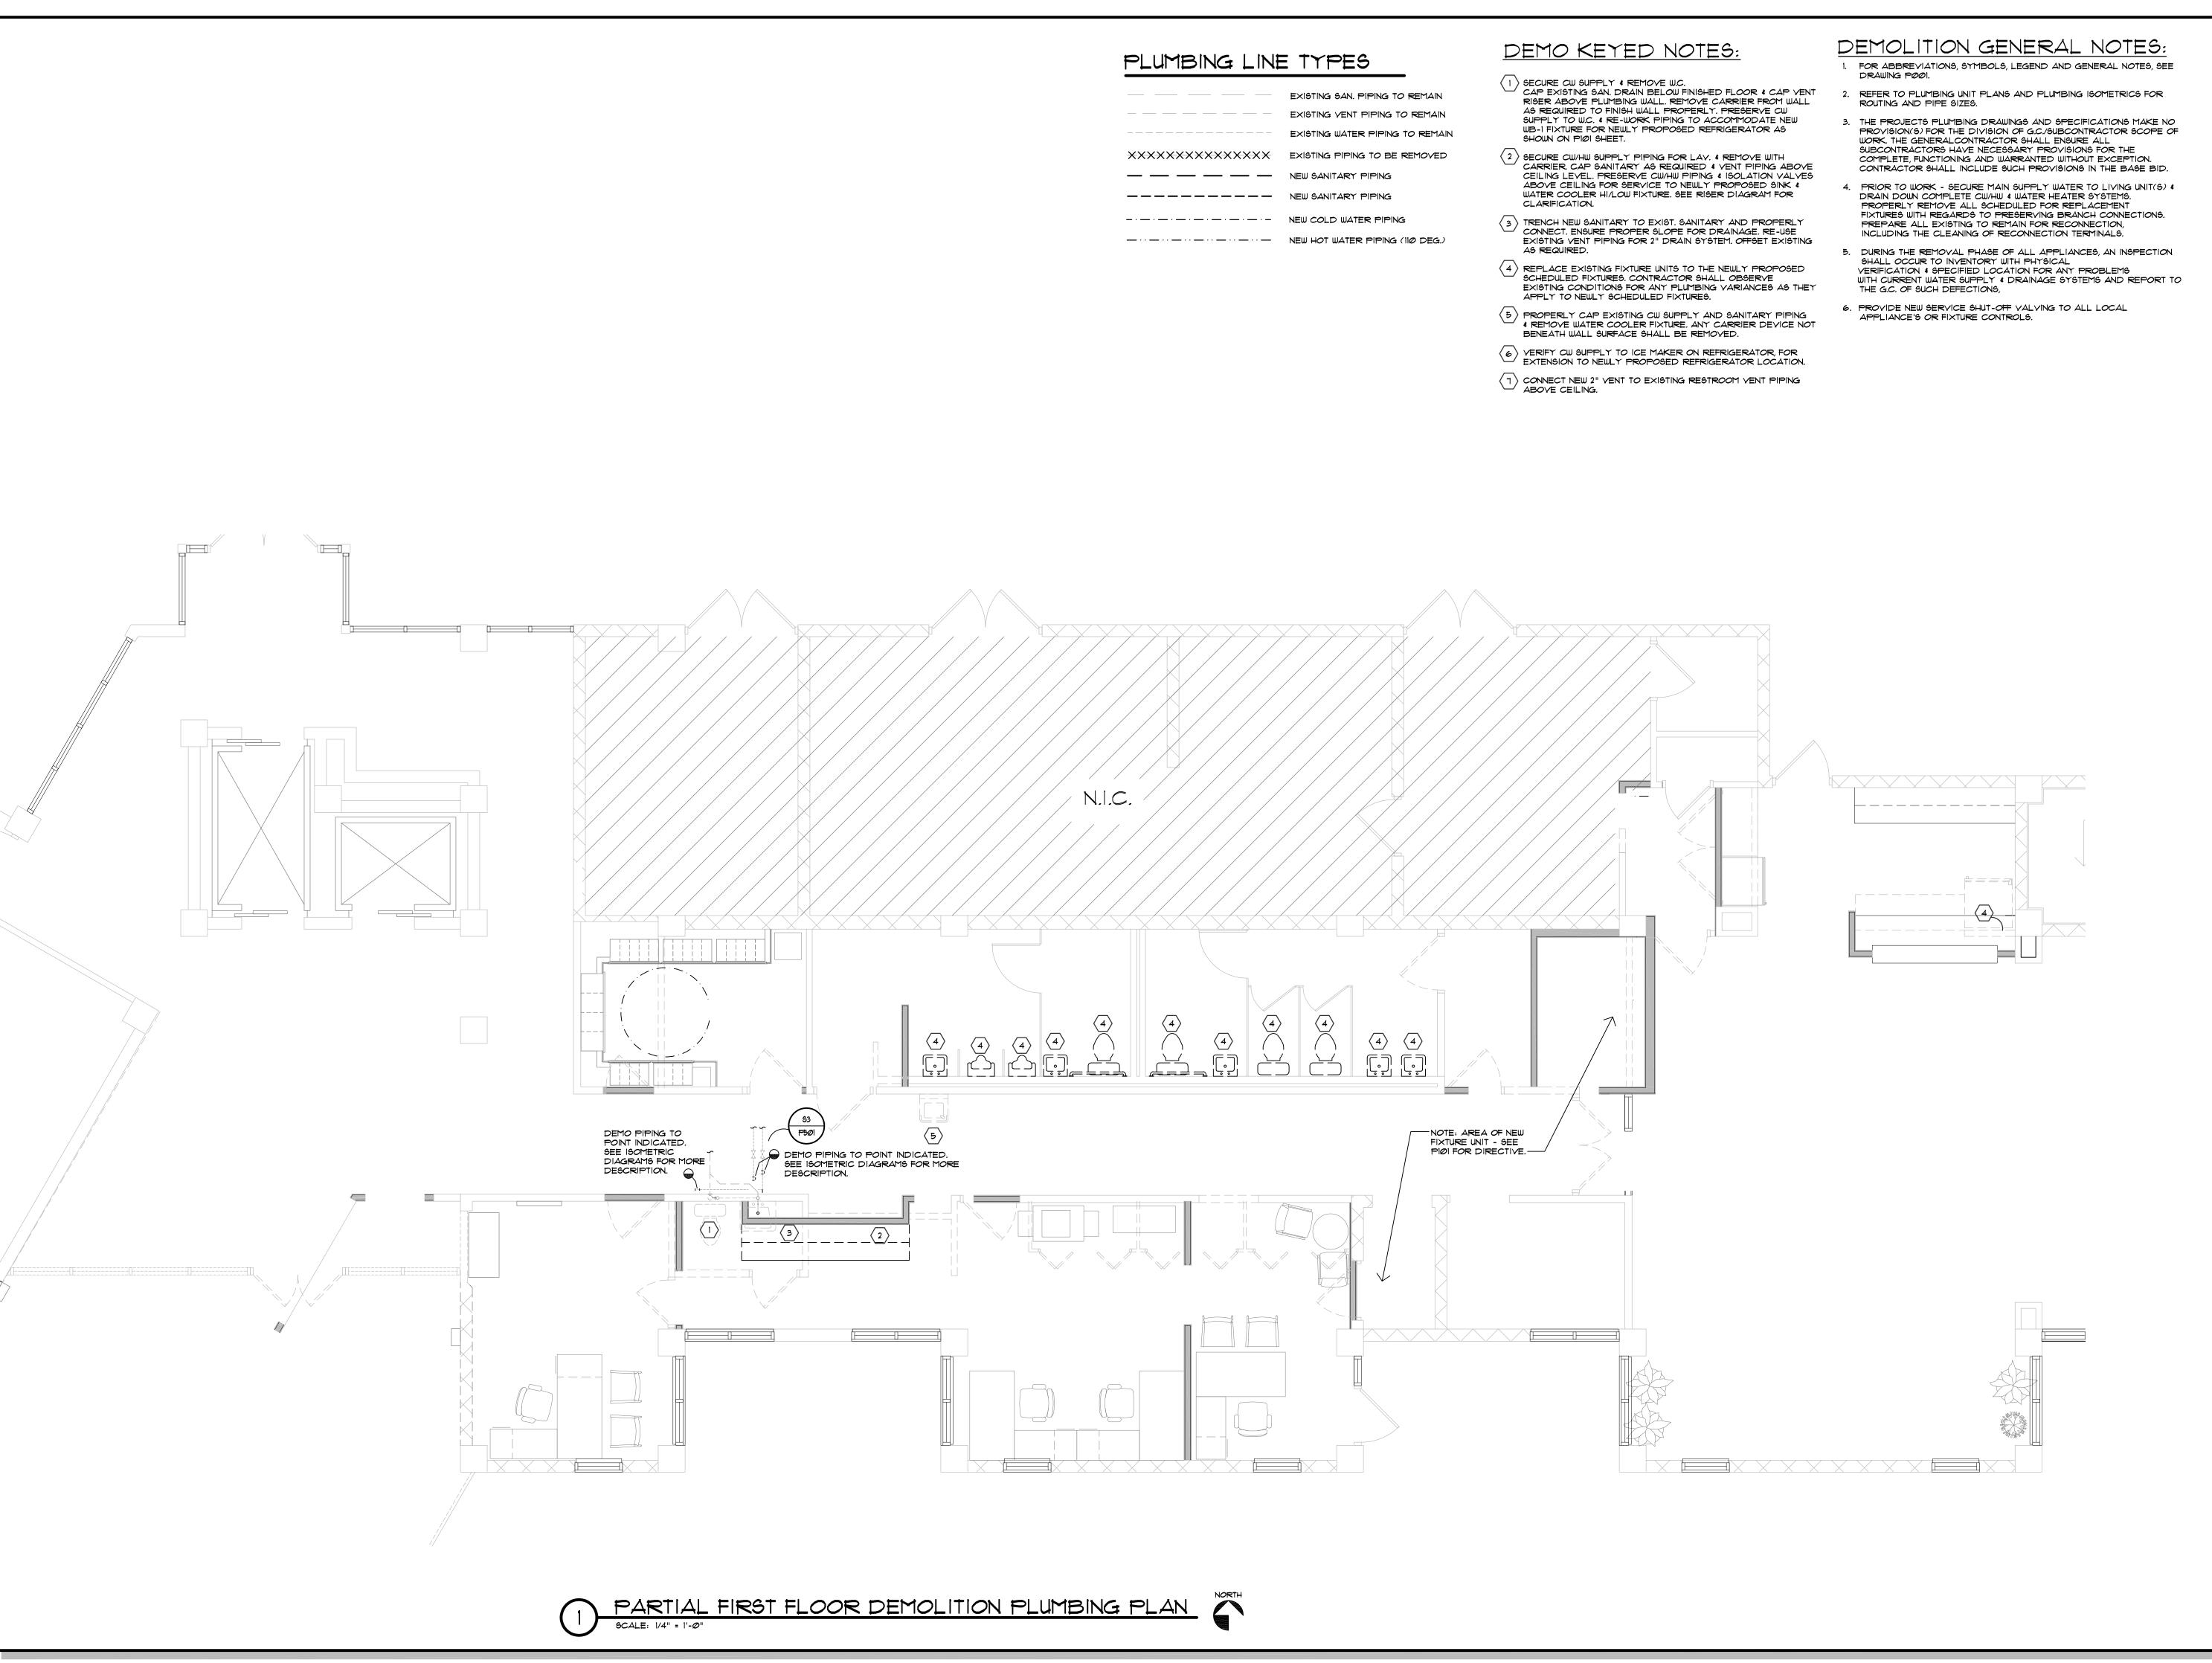
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CHECKED BY: GMC

DATE: 05-15-20

SCALE: NOT TO SCALE



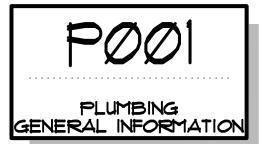

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DARBEE TOWERS
RENOVATION

100 E DRUID ROAD

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NO:	DATE:	DESCRIPTION

PROJECT NO:	19079.00
DRAWN BY:	TLJ
PROJECT MANAGER:	R W
CHECKED BY:	GMC
DATE:	05-15-20
SCALE:	1/4" = 1'-@"

INSTALLATION KEY NOTES: PROPERLY FIT & CONNECT NEW LAVATORY (L-1) TO EXISTING WATER SUPPLY(S) AND DRAIN CONNECTION WITH 1. FOR ABBREVIATIONS, SYMBOLS, LEGEND, AND GENERAL NOTES, PLUMBING LINE TYPES REFER TO SHEET MOOI. NEW ISOLATION VALVES. COORDINATE EQUIPMENT INSTALLATION AND LOCATION WITH MANUFACTURER REQUIREMENTS PRIOR TO BIDDING AND PROPERLY FIT & CONNECT NEW FIXTURE TO EXISTING CW WATER SUPPLY WITH NEW ISOLATION VALVE AND PROVIDE A NEW OUTLET SEAL FOR NEWLY SCHEDULES WATER CLOSET EXISTING SAN. PIPING TO REMAIN CONSTRUCTION. EXISTING VENT PIPING TO REMAIN 3. THE PROJECTS MECHANICAL DRAWINGS AND SPECIFICATIONS MAKE NO PROVISION(S) FOR THE DIVISION OF PROPERLY INSTALL NEW URINAL (UR-1) WITH NEW FLUSH VALVE WITH CONNECTION TO EXISTING CW. ______ EXISTING WATER PIPING TO REMAIN GC/SUNCONTRACTOR WORK SCOPE(S). THE GENERAL CONTRACTOR WORN SCOPE(S): THE GENERAL CONTRACTOR SHALL ENSURE ALL HIS/HER SUBCONTRACTORS HAVE NECESSARY PROVISIONS FOR THE COMPLETE, FUNCTIONING AND WARRANTED WITHOUT EXCEPTION. PLUMB LEVEL, SUPPORT AND ANCHOR. PROVIDE NEW 1/2" CW SUPPLY PIPING TO NEWLY SCHEDULED DRINK STATION. PROVIDE 1/2" CW PIPING THROUGH WALL TO NEW BRANCH PIPING AT SINK NEW SANITARY VENT PIPING CONTRACTOR SHALL INCLUDE SUCH PROVISIONS IN HIS/HER OPPOSITE SIDE OF WALL - SEE ISOMETRICS. 4. GENERAL CONTRACTOR AND HIS/HER SUB-CONTRACTOR(S) SHALL CAREFULLY COORDINATE ALL SPRINKLER LINE PROVIDE NEW 1/2" CW SUPPLY PIPING TO NEWLY SCHEDULED WALL BOX FROM EXISTING CW SUPPLY $\cdots \cdots \cdots \cdots \cdots \cdots \cdots$ NEW HOT WATER PIPING (110 DEG.) INSTALLATIONS WITH THE PROJECTS MECHANICAL AND PLUMBING SYSTEMS PRIOR TO INSTALLATIONS. SPRINKLER LINES TO BE DETERMINED TO BE IN CONFLICT WITH THE AT THE DEMOLITION OF RESTROOM, CONNECT DOWNSTREAM OF LOCAL ISOLATION VALVES - SEE ISOMETRICS. PROJECTS MECHANICAL DRAWINGS WILL BE REQUIRED TO BE RELOCATED AT NO ADDITIONAL COST TO THE OWNER OR PROVIDE NEW 1/2" CW/HW PIPING DOWNSTREAM OF LOCAL EXISTING ISOLATION VALVES SERVING DEMOLITION OF ARCHITECT, WITHOUT EXCEPTION. RESTROOM, FOR NEW SINK (S-1) TO NEWLY PROPOSED KITCHENETTE LOCATION - SEE ISO PLAN. 1) INSTALL KITCHENETTE SINK PROPERLY & CONNECT EXISTING CW/HW SUPPLY AND DRAIN PIPING TO EXISTING SANITARY. $\langle s \rangle$ connect New 2" vent to nearest vent system. 9 NEW 3" SANITARY TO WC-1, NEW 2" SANITARY TO LAVATORY AND NEW 2" VENT FOR NEW TOILET ROOM. CONNECTIONS ON SANITARY & WATER SHALL BE TO THE EXISTING, FIELD EXISTING SANITARY LATERAL PRIOR TO TRENCHING. NEW 3" SANITARY TO MOP SINK, AND NEW 2" VENT TO EXISTING COLLECTION (MANIFOLD) TO EXISTING V.T.R. FIELD DETERMINE BEST ROUTING & FIELD VERIFY SANITARY LATERAL PRIOR TO TRENCHING. — 1/2" CW/HW DOWN FROM CEILING IN WALL. ₩3 P5ØI 1/2" CW/HW ABOYE CEILING TO KITCHEN SINK — 1/2" CW/HW DOWN FROM CEILING IN WALL. PARTIAL FIRST FLOOR PLUMBING PLAN SCALE: 1/4" = 1'-0"

GENERAL NOTES:



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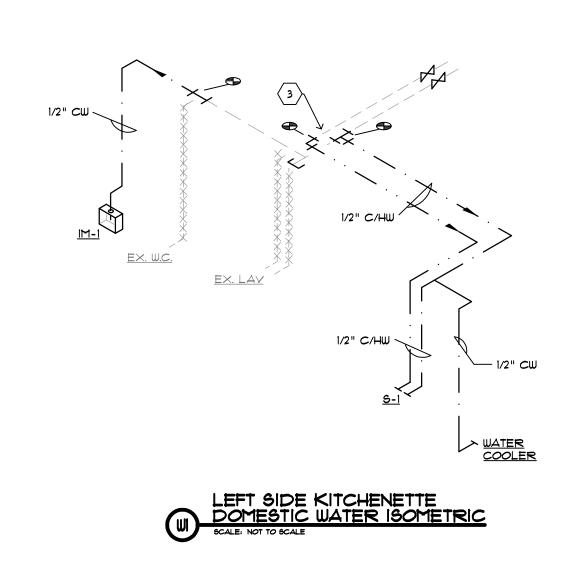
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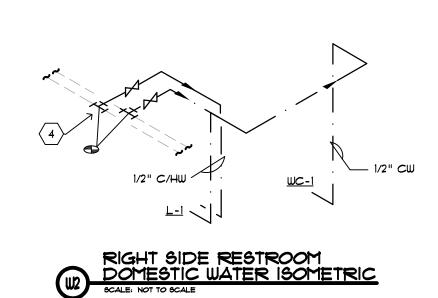
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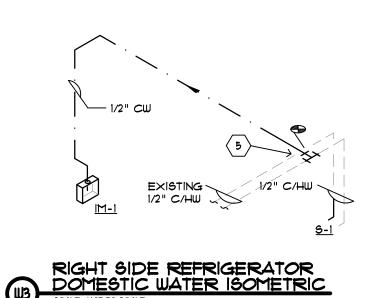
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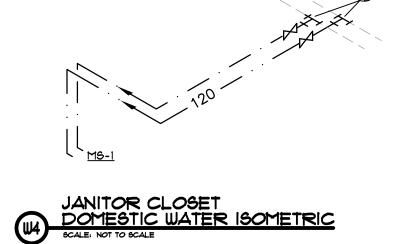
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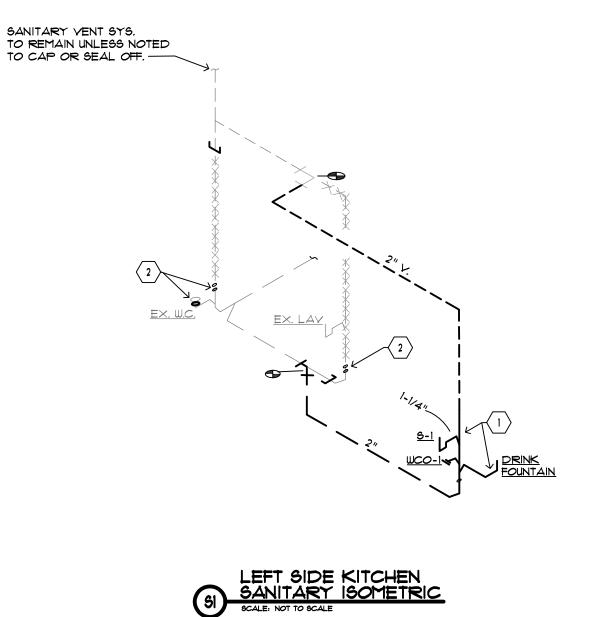














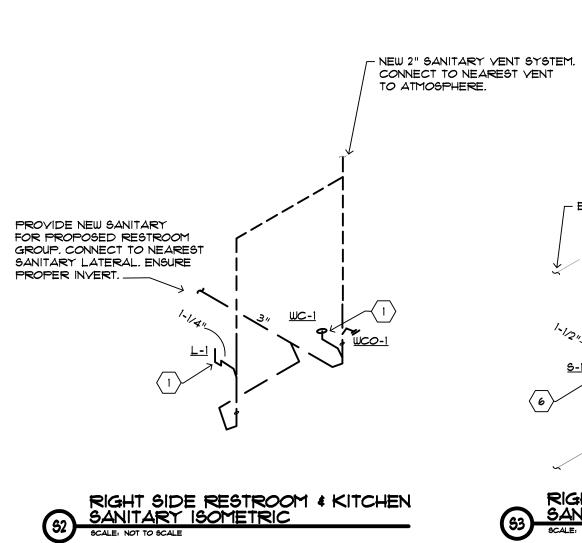

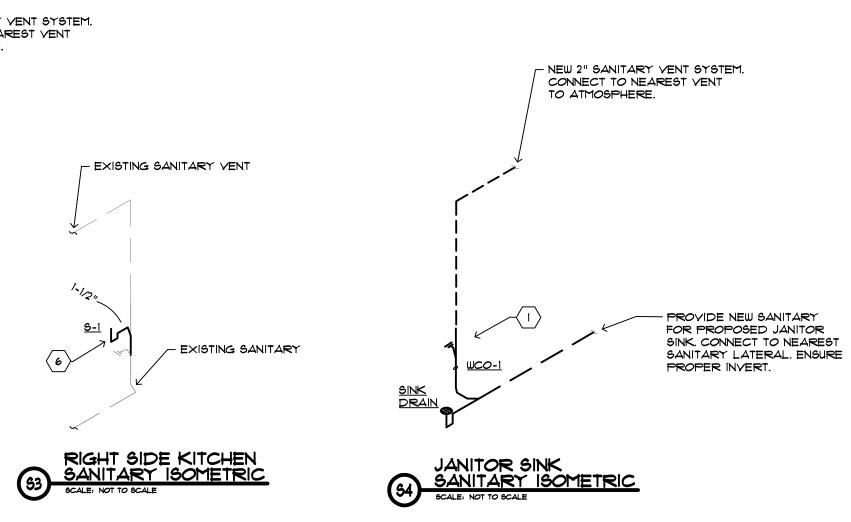

GENERAL NOTES:

- FOR ABBREVIATION, SYMBOLS, LEGEND AND GENERAL NOTES SEE DRAWING POOL
- 2. PIPING TO RUN IN CEILING SPACE FOR DOMESTIC WATER AND CONCEALED SANITARY VENTS.

KEY NOTES:

- NEW FIXTURE AS SCHEDULE PROVIDE NEW SANITARY & WATER SUPPLY PIPING.
- 2 PROPERLY DECOMMISSION EXISTING SANITARY FLOOR CONNECTION TO PERMANENTLY REMOVED WATER CLOSET
- 3 NEW WATER 1/2" CW/HW SUPPLY CONNECTION TO EXISTING CW/HW SUPPLY SERVICE TO REMOVED RESTROOM GROUP.
- ANEW WATER 1/2" CW/HW SUPPLY CONNECTION TO EXISTING CW/HW SUPPLY. FIELD VERIFY PROPER SUPPLY MAIN. PROVIDE NEW ISOLATION VALVES FOR FOR NEW BRANCH PIPING.
- PROPERLY CONNECT 1/2" CW PIPING FROM (WB-1) TO EXISTING CW SUPPLY.
- 6 FIT, ANCHOR AND CONNECT ALL PLUMBING TO NEWLY PROPOSED (5-1) AT KITCHEN (RIGHT SIDE) PLAN VIEW.

PLUMBING LINE TYPES

	EXISTING SAN. PIPING TO REMAIN
	EXISTING VENT PIPING TO REMAIN
	EXISTING WATER PIPING TO REMAIN
***	EXISTING PIPING TO BE REMOVED
	NEW SANITARY PIPING
	NEW COLD WATER PIPING
_ · · ·	NEW COLD WATER PIPING
<u> </u>	NEW HOT WATER PIPING (110 DEG.)



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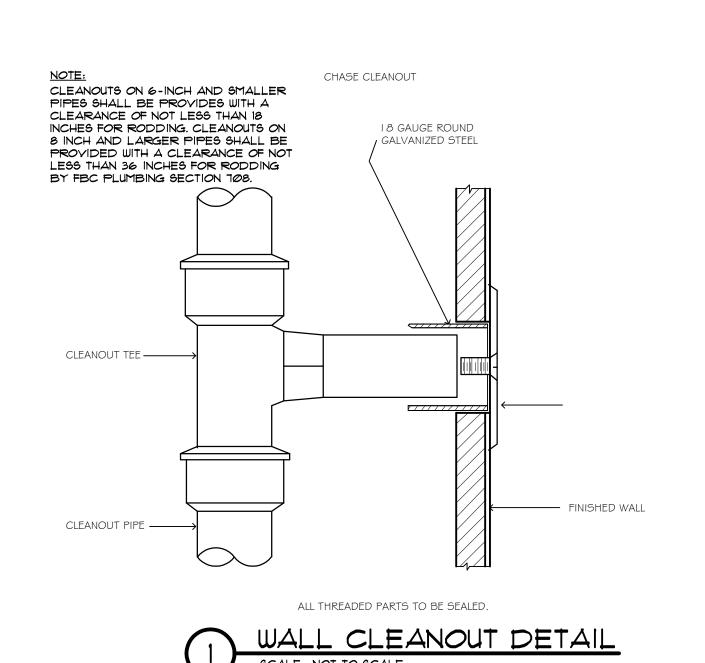
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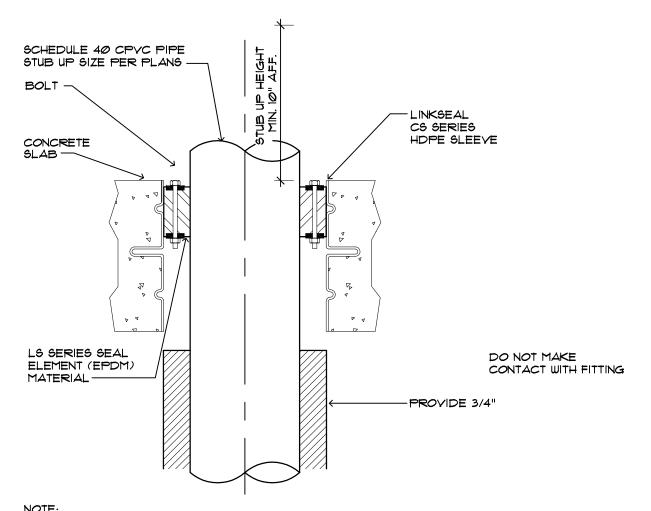
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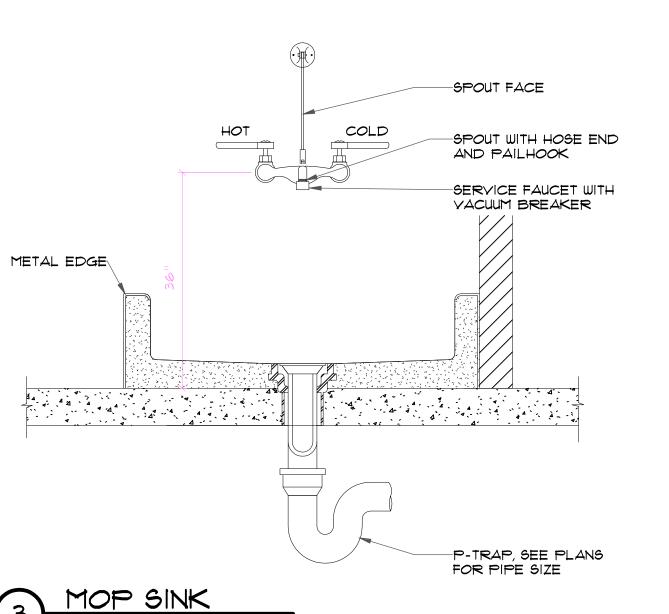
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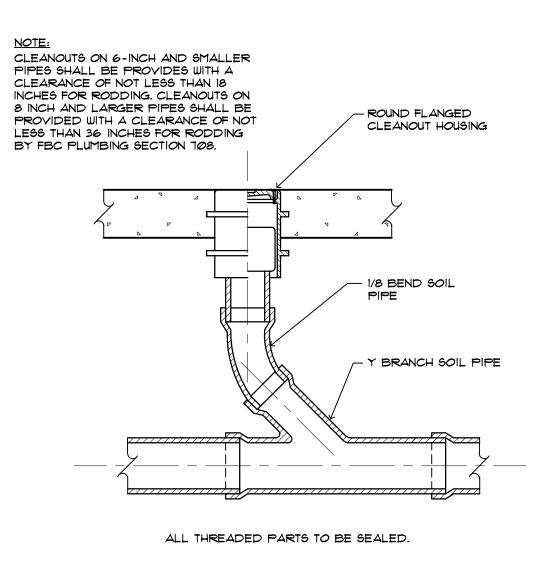
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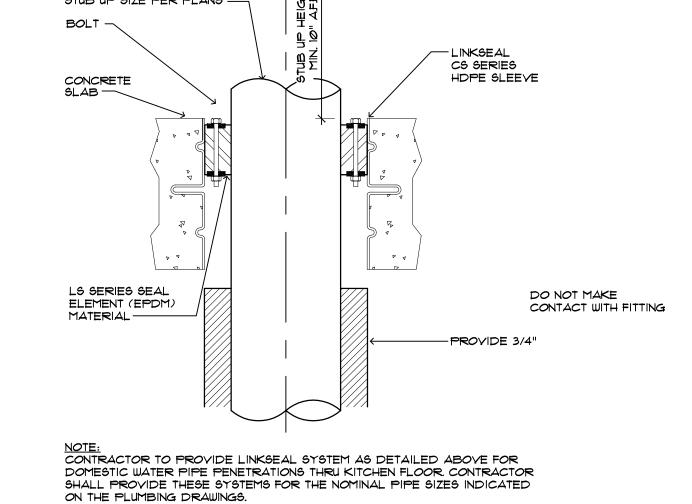
















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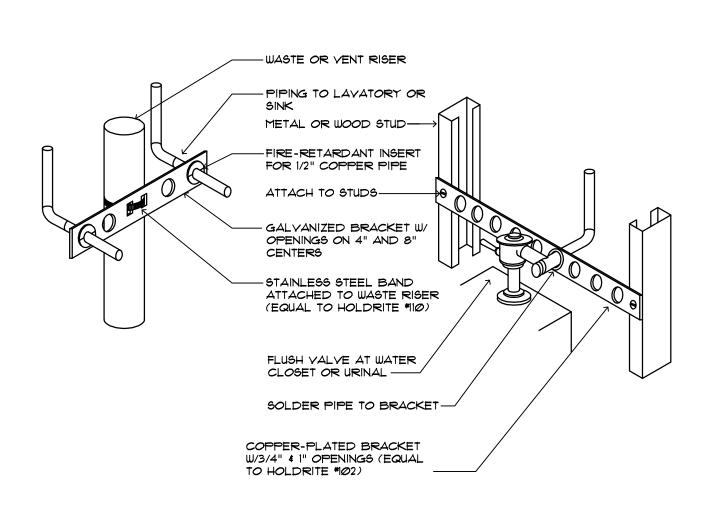


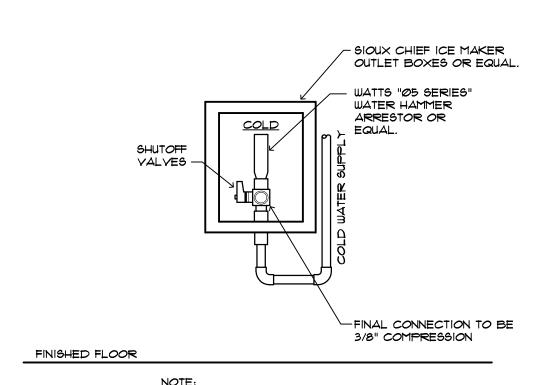NOTE: CONTRACTOR MAY SUBSTITUTE CONNECTION BOX W/ W.H.A. LOCATED IN RECESS.






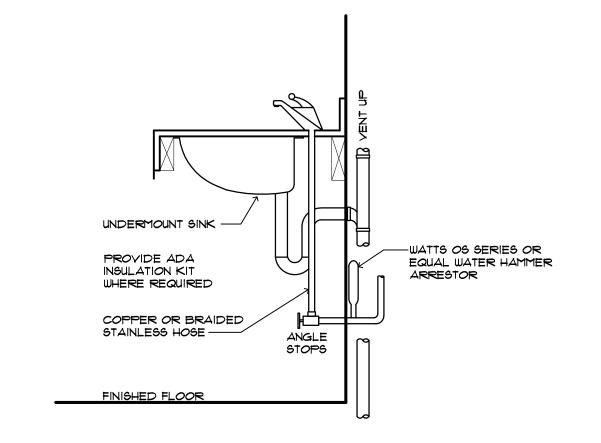






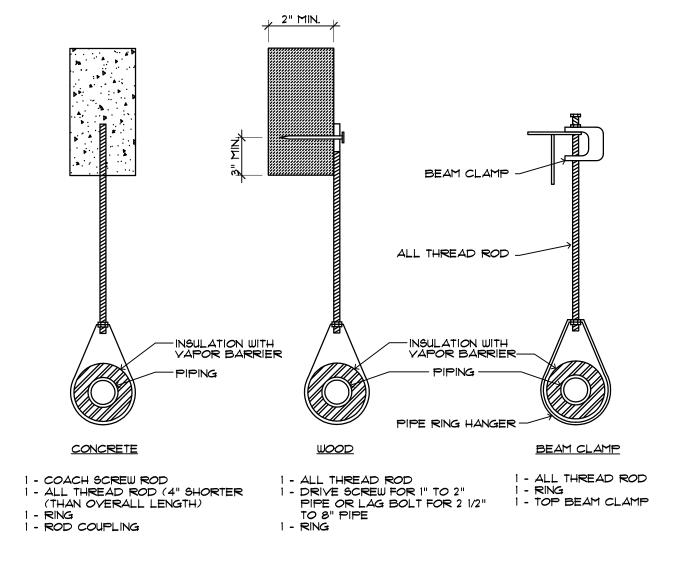



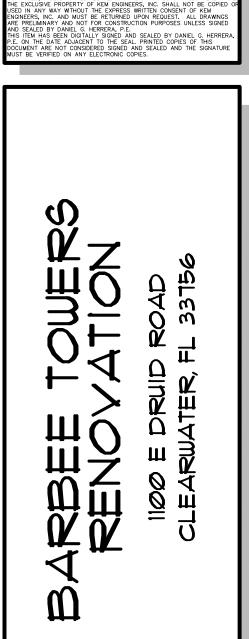

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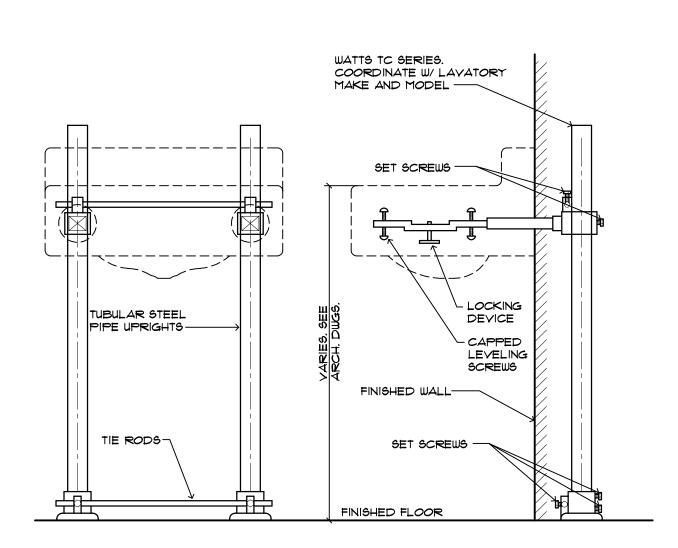
Gregory M. Clements, P.E. State of Florida 67375

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Ø5-15-2¢	CONSTR	RUCTION DOCUMENTS
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PROJECT NO:	is@is@@
DRAWN BY:	TĻJ
PROJECT MANAGER:	RW
CHECKED BY:	GMC
DATE:	<i>0</i> 5-15-20
SCALE: NO	T TO SCALE








		METALLIPIPE
		PLASTIC
		INSULATE

FIRESTOP DETAILS

TYPE OF PIPE 2 HR CONCRETE FLOORS & WALLS <u>HR GYPSUM WALLS</u> METALLIC PIPE CAJIØ64 (4") WL1097 (8") PLASTIC PIPE CAJ2069 (10") WL2*0*63 (4") INSULATED METALLIC PIPE CAJ5121 (4") WL5Ø81 (4")


CONCRETE

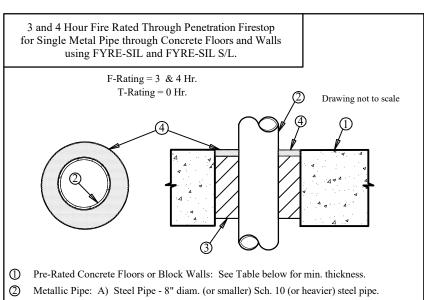

B) Iron Pipe - 8" diam. (or smaller) cast or ductile iron pipe. C) Conduit - 4" diam. (or smaller) EMT or 6" diam.(or smaller) steel conduit. D) Copper Tubing - 4" diam. (or smaller) Type L (or heavier) copper tubing. E) Copper Pipe - 4" diam. (or smaller) Regular (or heavier) copper pipe.

3 Packing Material - See Table below for the mineral wool insulation requirements. FYRE-SIL or FYRE-SIL S/L (Floors Only) - Min. 1/2" thickness of sealant applied within annulus flush with top of floor surface or with both sides of wall assembly.

UL/cUL System No. CA	J 1064		
Project:	tested in accordan • ASTM E814 (U	acts used above have been ace with the following: JL1479) Standard Test Method netration Firestopping.	This information is intended for engineering purposes only and is based on internal and third party testing which we believe to be accurate. The user of this information must determine the suitability of the design to the application and the product to local building codes. Tremoe shall not be liable for dam-
Installer:	Date: 11/01/00	Drawing: TR-1064	ages, direct or consequential, resulting from use of this material or design. Tremco shall
	Date: 11/01/00	Drawing. TR-1004	

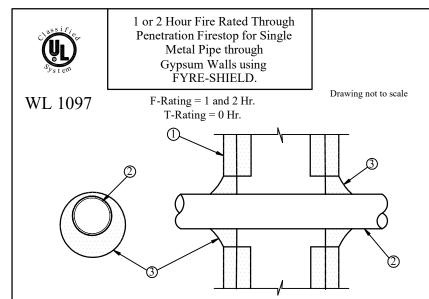


GYPSUM

① Pre-Rated Gypsum Wallboard/Stud Wall Assembly ② Metallic Pipe - A) Steel Pipe - 8" diam. (or smaller) Sch. 40 (or heavier) steel pipe. B) Iron Pipe - 8" diam. (or smaller) cast or ductile iron pipe.

C) Conduit - 4" diam. (or smaller) EMT or rigid steel conduit. D) Copper Tubing - 4" diam. (or smaller) Type L (or heavier) copper tubing. E) Copper Pipe - 4" diam. (or smaller) Regular (or heavier) copper pipe.

The annular space shall be min. 1/4" to max. 5/8" within the firestop system. 3 FYRE-SHIELD - Min. 1/2" thickness of sealant applied within opening. Additional sealant to be installed such that a min. 1/4" crown is formed around the penetrating item.

tion:	tested in accordance • ASTM E814 (UL1	with the following: 479) Standard Test Method ration Firestopping.	The above described assembly has been tested and is based on both past and antici- pated performance criteria. Tremeo shall no be liable for any damages, direct or con-
ller:	Date: 4/23/97	Drawing: TW-1097	sequential, resulting from use of this materia or design. Tremco shall only be responsible
ature: ———	Approved by:	J. Pitcole	for replacing material found to be defective.

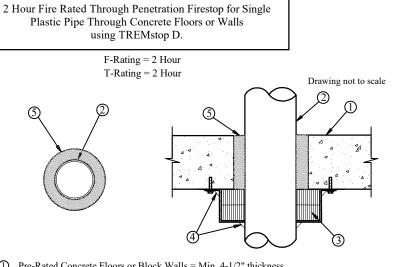


① Pre-Rated Concrete Floors or Block Walls = Min. 4-1/2" thickness 2 Plastic Pipe - 10" diam. (or smaller) Sch. 40 PVC pipe for use in closed or open piping systems. A max. annular space of 5/8" is required for 10" pipes. The annular space range for 6" pipes is min. 1/2" to max. 4-1/8". (3) TREMstop D- Properly sized firestop device consisting of intumescent wrap strips. Wrap device around pipe penetration and secure using attached hose clamp. Mechanically fasten flush to underside of floor or both sides

of wall assembly. TREMstop Acrylic or TREMstop IA - Min. 1/4" bead of sealant applied at the interface of the concrete slab and steel collar, and at the interface of the steel collar and pipe.

Mortar - Min. 4-1/2" thickness of mortar or hydraulic cement applied within annulus, flush with both surfaces of floor or wall assembly.

UL/cUL System No. CAJ 2	2069	•	
Project: Location:	tested in accordar • ASTM E814 (U	ucts used above have been nee with the following: UL1479) Standard Test Method enetration Firestopping.	This information is intended for engineering purposes only and is based on internal and third party testing which we believe to be accurate. The user of this information must determine the suitability of the design to the application and the product to local building codes. Trenco shall not be liable for dam-
Installer:	Date: 11/02/00	Drawing: TR-2069	ages, direct or consequential, resulting from use of this material or design. Tremco shall
Signature: —	Approved by:	J. Pitcole	only be responsible for replacing material found to be defective.

2 Hour Fire Rated Through Penetration Firestop for Single Plastic Pipe through Gypsum Walls using TREMstop D. F-Rating = 2 Hr. T-Rating = 1 Hr.

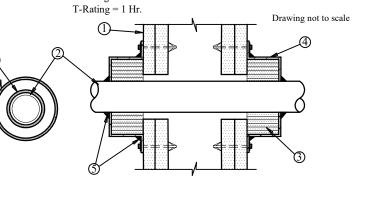

② Plastic Pipe - Nom. 4" diam. (or smaller) Sch. 40 PVC pipe for use in closed or open piping systems. See table below for required annular space. 3 TREMstop WS - Intumescent wrap strips, continuously wrapped around outer circumference of the pipe. See table below for min. wraps required.
 Pipe Diam. in.
 Annular Space in.
 Min. No. of Wrap Strip Lavers


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TREMstop MCR - Prefabricated steel collar wrapped over the wrap strips (Item 3) and mechanically fastened to both sides of wall assembly. TREMstop IA or TREMstop Acrylic (Optional) - Min. 1/4" bead of sealant applied at the wallboard/device and device/pipe interfaces.

NOTE: TREMstop D can be used in place of TREMstop WS and TREMstop MCR. UL/cUL SystemNo. WL 2063

UL/cUL SystemNo. WL 2	2063	
Project: Location:	tested in accordar • ASTM E814 (U	ucts used above have been nee with the following: JL1479) Standard Test Meth- enetration Firestopping.
Installer:	Date: 4/16/01	Drawing: TW-2063
Signature:	Approved by:	J. Pitcole

D Pre-Rated Gypsum Wallboard/Stud Wall Assembly

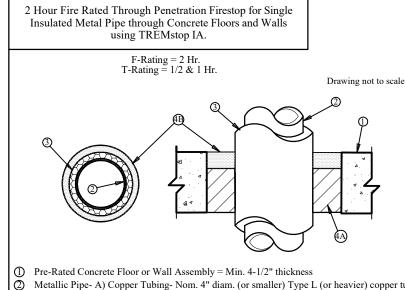

Metallic Pipe- A) Copper Tubing- Nom. 4" diam. (or smaller) Type L (or heavier) copper tubing. B) Copper Pipe - Nom. 4" diam. (or smaller) Regular (or heavier) copper pipe. C) Steel Pipe- Nom. 4" diam. (or smaller) Sch. 10 (or heavier) steel pipe. D) Iron Pipe - Nom. 4" diam. (or smaller) cast iron pipe. 3 Pipe Covering - Fiberglass insulation, see table below for thickness and annular space.
 Pipe Covering Thickness, in.
 Annular Space in.
 Packing Material Thickness, in.
 Min. Sealant Thickness, in.
 F-Rating Hr.
 T-Rating Hr.


 1
 1/2 to 1
 0
 1
 2
 1/2

 1
 1/2 to 1-1/2
 3-1/2
 1
 2
 1/2

Packing Material - Mineral wool insulation (min. 4.0 pcf) firmly packed into opening to the minimum required thickness in the table above. TREMstop IA- Min. thickness of sealant as specified in table above, applied within opening flush with top surface of floor or both surfaces of wall.

UL/cUL Syste	m No. CAJ 5121		
Project:Location:	tested in accordar • ASTM E814 (I	ucts used above have been nee with the following: JL1479) Standard Test Method enetration Firestopping.	This information is intended for engineering purposes only and is based on internal and third party testing which we believe to be accurate. The user of this information must determine the suitability of the design to the application and the product to local building codes. Trence shall not be liable for dam-
Installer:	Date: 04/12/00	Drawing: TR-5121	ages, direct or consequential, resulting from use of this material or design. Tremco shall
Signature:	A 1 h	D. C Id.	only be responsible for replacing material

and 2 Hour Fire Rated Through Penetration Firestop for Single Insulated Metal Pipe through Gypsum Walls using TREMstop IA.

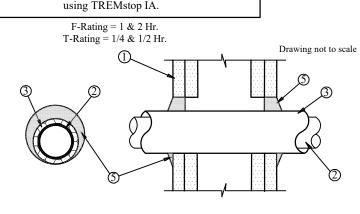

① Pre-Rated Gypsum Wallboard/Stud Wall Assembly ② Metallic Pipe - A) Steel Pipe - 4" diam. (or smaller) Sch. 10 (or heavier) steel pipe. B) Iron Pipe- 4" diam. (or smaller) cast or ductile iron pipe. C) Copper Tubing - 4" diam. (or smaller) Type L (or heavier) copper tubing. D) Copper Pipe - 4" diam. (or smaller) Regular (or heavier) copper pipe. ③ Pipe Covering - Nom. 3/4" thick (or less) AB/PVC flexible foam insulation.

The annular space shall be min. 0" to max. 3/8". Packing Material (Optional, Not Shown)- Foam backer rod firmly packed into opening.

TREMstop IA - For 2 Hr. Walls: Min. 1" thickness of sealant applied within annulus. For 1 Hr. Walls: Min. 1/2" thickness of sealant applied within annulus. Sealant applied flush with both sides of wall assembly, and an additional 1/2" crown is formed around the penetrating item.

UL/cUL System No. WL 5081

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(727) 894-4668 PROFESSIONAL SEAL

Gregory M. Clements, P.E. State of Florida 67375

ISSUED DATE: ISSUED FOR: 05-15-20 CONSTRUCTION DOCUMENTS

	REVISIONS			
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PROJECT NO: 19079.00 DRAWN BY: PROJECT MANAGER: CHECKED BY: DATE: 05-15-20 NOT TO SCALE

PLUMBING DETAILS