
$\frac{\text{MECHANICAL DEMOLITION PLAN}}{1/8" = 1'-0"}$

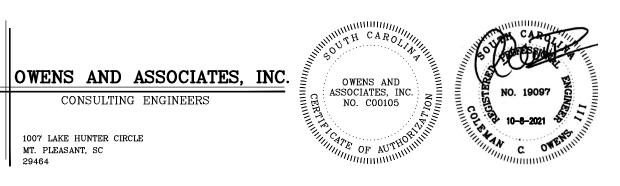

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Boiler Replacement
2106 MT. PLEASANT ST.

PROJECT NUMBER:
2119
ISSUE DATE:
10/8/2021
DRAWN BY: MWK
CHECKED BY: CCOIII

CONSTRUCTION DOCUMENTS

Revision Schedule

Description Date

MECHANICAL DEMOLITION PLA

 $O\frac{\text{MECHANICAL PLAN}}{1/8"} = 1'-0"$

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Joseph Floyd Manor Boiler Replacement 2106 MT. PLEASANT ST. CHARLESTON, SC 29403


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MECHANICAL PLAN



GENERAL MEP NOTES

- 1. CONTRACTOR IS RESPONSIBLE FOR VISITING THE SITE TO INVESTIGATE EXISTING CONDITIONS PRIOR TO BID. FAILURE VISIT THE SITE AND TO PROPERLY IDENTIFY SCOPE OF WORK WILL NOT CONSTITUTE A CHANGE IN PRICE AFTER BID.
- 2. THE CONTRACTOR SHALL REMOVE AND PROPERLY DISPOSE OF ALL BOILERS, PIPE, INSULATION AND APPURTENANCES SCHEDULED TO BE DEMOLISHED OFF
- 3. ELECTRICAL WORK ASSOCIATED WITH POWER WIRING FOR THE NEW BOILER (CB-1) SHALL BE PERFORMED IN ACCORDANCE WITH THE NATIONAL ELECTIRCAL CODE (NEC). ALL POWER WIRING SHALL BE INSTALLED WITHIN GALVANIZED EMT WITH THWN/THHN WIRE. ELECTRICAL CONTRACTOR SHALL PROVIDE NEW 20 AMP, 3 POLE BREAKER IN EXISTING PANEL"PA". MATCH EXISTING MANUFACTURER. PROVIDE NEW HEAVY DUTY 3-POLE FUSED DISCONNECT FOR BOILER AS SHOWN ON PLAN. FUSE BOILER PER THE MANUFACTURERS MOCP REQUIREMENTS. ALL ELECTRICAL WORK ASSOCIATED WITH STANDBY HOT WATER PUMP HWP-2 SHALL BE PERFORMED BY THE OWNER.
- 4. ALL HORIZONTAL HOT WATER PIPING SHALL BE FITTED WITH ECCENTRIC REDUCERS ORIENTED WITH FLAT SURFACE UP. VERTICAL PIPING SHALL BE REDUCED WITH CONCENTRIC REDUCERS.
- REFER TO SPECIFICATION FOR PIPE PAINTING AND INSPECTION REQUIREMENTS. 6. ALL STEEL PIPING IN MECHANICAL ROOM SHALL BE FREE FROM RUST AND CORROSION PRIOR TO INSTALLATION. PIPING THAT IS CORRODED INTERNALLY OR
- EXTERNALLY IS NOT ACCEPTABLE. 7. AFTER PIPE FLUSHING IS COMPLETE AND CONTRACTOR HAS DEMONSTRATED THAT THE SYSTEM IS FILLED WITH CLEAN AND CLEAR WATER, THE CONTRACTOR SHALL BE RESPONSIBLE FOR THE TREATMENT OF THE SYSTEM THRU THE FIRST YEAR WARRANTY. AFTER THE FIRST YEAR, THE OWNER IS RESPONSIBLE FOR MAINTENANCE OF THE WATER TREATMENT. AFTER FLUSHING IS COMPLETE AND THE CONTRACTOR SHALL PULL WATER TESTS AND DEMONSTRATE A CLEAN SYSTEM TO THE OWNER AND ENGINEER PRIOR TO ADDING WATER TREATMENT
- CHEMICALS. 8. AFTER INSTALLATION OF NEW BOILER, MECHANICAL CONTRACTOR SHALL BLEED AIR OUT OF SYSTEM ON TOP FLOOR FAN COIL UNITS. CONTRACTOR SHALL ENSURE ALL ENTRAINED AIR IN REMOVED FROM THE SYSTEM PRIOR TO PROJECT COMPLETION AND VERIFY PROPER OPERATION OF HEATING SYSTEM.

GATE VALVE	
SIGHT GLASS	
FUNNEL @ 48" AFF	PRESS. GAUGE & COCK
PRESSURE RATED POT FEEDER	
1/2 MAIN PIPE SIZE	
3/4" HOSE COCK	SYSTEM MAIN
CHEMICAL FEI	EDER DETAIL

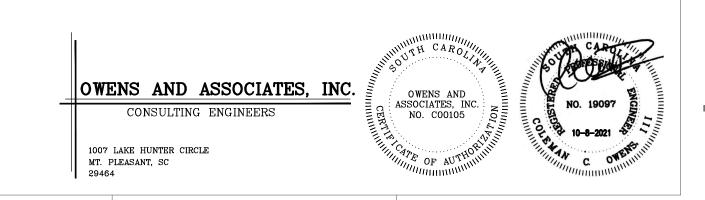NO SCALE

DESIGN CONDITIONS								
	COOLING	HEATING						
OUTSIDE	95F DB,80F WB	27F DB						
INSIDE	78F DB,65F WB	72F DB						

SY	MBOL SCHEDULE						
SYMBOL	DESCRIPTION						
T	THERMOSTAT WITH LOCK COVER						
H	HUMIDISTAT WITH LOCK COVER						
<u> </u>	CO2 SENSOR WITH LOCK COVER						
(AP)	BI-POLAR IONIZATION UNIT						
(SD)	DUCT MOUNTED SMOKE DAMPER						
00	DUCT SMOKE DETECTOR-SEE FIRE ALARM PLAN						
lacksquare	EXHAUST FAN						
TR GR/EX GR	TRANSFER GRILLE / EXHAUST GRILLE						
\exists	AIR TURNING VANE						
 > s	SPLITTER DAMPER						
FD/-	FIRE DAMPER / HOUR RATING						
SD	SMOKE DAMPER						
FSD	COMBINATION FIRE/SMOKE DAMPER						
	INDICATION OF ROOF MOUNTED EQUIPMENT						
<u></u>	MANUAL DAMPER (O.B.M.D.)						
────	GATE VALVE						
	GLOBE VALVE						
	FLOW STATION						
- N-	CHECK VALVE						
	STRAINER						
─- -	UNION/FLANGE						
O L	PRESSURE GAUGE WITH PETCOCK						
	THERMOMETER						
─ Ō─	CIRCUIT SETTER						
<u> </u>	PRESSURE REDUCING VALVE						
6	PRESSURE RELIEF VALVE						
Ŷ	MANUAL AIR VENT						
	FLEXIBLE CONNECTION						

CONDENSING WATER BOILER SCHEDULE													
HTR. NO.	MODEL NO.	GALLONS	MOUNTING	VOLTAGE	PHASE	моср	LABEL	GAS	GPM	BTU INPUT	BTU OUTPUT	DELTA P FT H20	DELTA T *F
CB-1	FCB4000	201	CONC. PAD	208	THREE	20	ASME	NATURAL	300	3,999,000	3,843,000	10'	20°

BOILER SHALL BE LOCHINVAR CREST-HELLCAT OR PRIOR APROVED EQUAL AND MEET ANSI STANDARD Z21.13, THERMAL COMBUSTION EFFICIENCIES AND BE AHRI CERTIFIED.

BOILER SHALL BE CSD-1 /FM/GAPS AND CALIFORNIA CODE COMPLIANT.

BOILER HEAT EXCHANGER SHALL BE STAINLESS STEEL, CONDENSING, FIRE TUBE DESIGN PROVIDED WITH OPTIONAL 150 PSI ASME PRESSURE RELIEF VALVE.

BOILER VOLUME SHALL BE 201 GALLONS MINIMUM. BOILER SHALL BE PROVIDED WITH 20:1 TURNDOWN MINIMUM.

BOILER SHALL BE PROVIDED WITH HELLCAT COMBUSTION TECHNOLOGY FOR FEEDFORWARD, FEEDBACK, COMMISSION TRIM AND LEARNED TRIM 02 SENSOR.

BOILER SHALL BE PROVIDED WITH INTEGRAL CASCADE SEQUENCING WITH BACNET MSTP INTERFACE, EFFICIENCY OPTIMIZATION AND CASCADE REDUNDANCY. BOILER SHALL BE PROVIDED WITH

TOUCHSCREEN USER INTERFACE TO MANUALLY CONTROL ALL BOILER FUNCTIONS FROM USER INTERFACE AND CAPABLE OF WIFI AND ETHERNET CONNECTION FOR REMOTE MONITORING AND CONTROL. PROVIDE BOILER WITH CONDENSATE NEUTRALIZATION KIT.

PRESSURE VESSEL AND HEAT EXCHANGER SHALL BE PROVIDED WITH FACTORY LIFETIME THERMAL SHOCK WARRANTY AND 5 YEAR PARTS AND LABOR WARRANTY FOR ENTIRE UNIT.

11. BOILER SHALL BE STARTED UP BY FACTORY TRAINED PERSONNEL. FULL VERIFICATION OF BOILER FUNCTIONS SHALL BE WITNESSED BY OWNER DURING OWNERS TRAINING. 12. BOILER PIPING SHALL BE PRIMARY FLOW/CONSTANT VOLUME. SEE PLANS FOR PIPING ARRANGEMENT.

13. BOILER SHALL BE PROVIDED WITH FACTORY 208V/3ø TO 120V/1ø ELECTRICAL TRANSFORMER.
14. BOILER SHALL BE PROVIDED WITH FACTORY INSTALLED FAILURE (ANY FAILURE) ALARM.

	PUMP SCHEDULE										
SYMBOL	SERVICE	TYPE PUMP	PUMP EFF. %	GPM	TOTAL HEAD FT. OF WTR.	HP	RPM	VOLTS	PH	HZ	REMARKS
HWP-2	STANDBY HW	CENTRIFUGAL	71.2	300	105	15	1750	480	3	60	SERIES 1510, 3G 10.75" IMPELLER

1. BASIS OF DESIGN IS ITT BELL & GOSSETT. ANY REQUIREMENTS ELECTRICAL OR OTHERWISE TO FURNISH ALTERNATE APPROVED EQUIPMENT ARE THE RESPONSIBILITY OF THIS CONTRACTOR.

2. HWP-2 IS FOR STANDBY EMERGENCY USE. ELECTRICAL WIRING TO NEW PUMP SHALL BE BY THE OWNER. MECHANICAL CONTRACTOR SHALL PIPE PUMP AND ACCESSORIES COMPLETE AS SHOWN. PROVIDE VFD FOR STANDBY PUMP WITH HOA CONTROL. VFD SHALL BE AS MANUFACTURED BY ABB OR DANFOSS WITH INTEGRAL CIRCUIT BREAKER. PUMP MOTOR SHALL BE INVERTER RATED.

5PSI TO 14" PRESSURE REGULATOR RATED FOR 4,000,000 BTUH.-0-30" W.C. PRESSURE NOTE: ALL ABOVE GRADE EXTERIOR GAS PIPING SHALL BE SCH. 40, GALVANIZED. **BOILER** SEE PLANS FOR SIZE ---2" COLD WATER SUPPLY HOT WATER BOILER MAKEUP CONNECTION —6", MIN FLEX HOSE (RATED FOR NATURAL) CONCRETE PAD PIPE UNION -BALL TYPE TEST COCKS BALL VALVE WATTS #909-QT-FDA-S-FDA, 2"-BRONZE STRAINER DRIP LEG

 $\not\leftarrow$ 2" from domestic water booster pump system

BOILER GAS PIPING DETAIL **FLOOR** NO SCALE -FLANGE -ANCHOR BOLTS


REDUCED PRESSURE BACKFLOW PREVENTER DETAIL

AIR GAP FITTING, —PIPE TO FLOOR DRAIN


NO SCALE

BALL VALVES -

STAND-

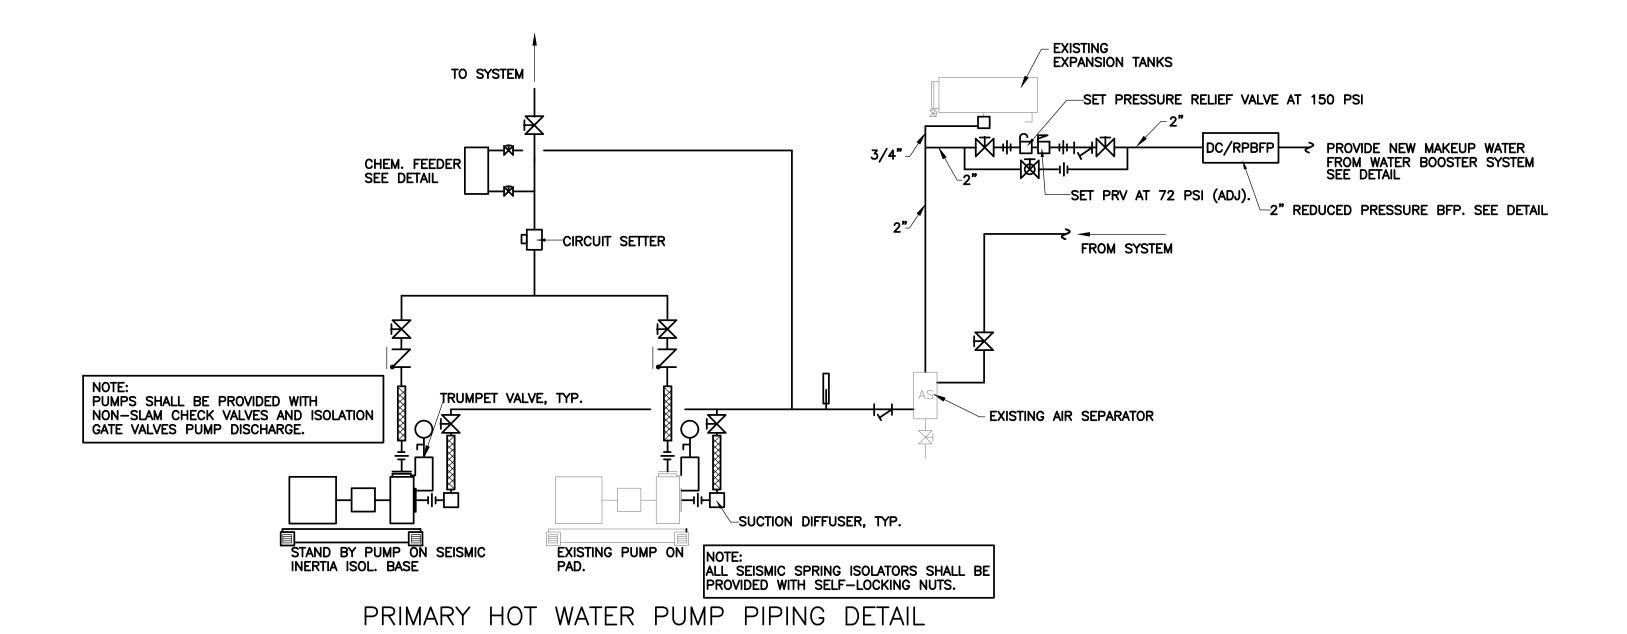


NO SCALE

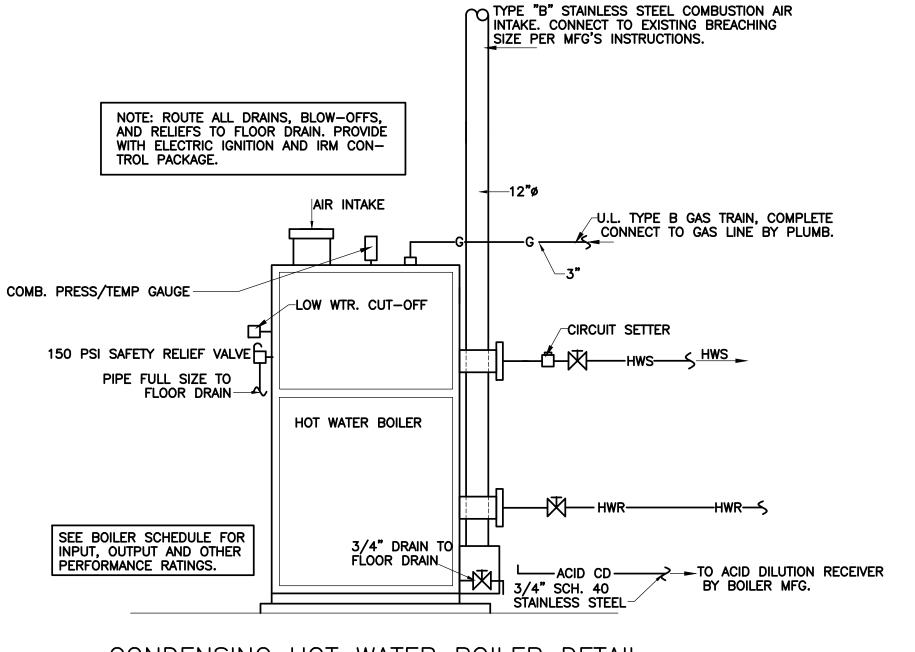

CONDENSING HOT WATER BOILER DETAIL NO SCALE

OWENS AND ASSOCIATES, INC. OWENS AND ASSOCIATES, IN CONSULTING ENGINEERS 1007 LAKE HUNTER CIRCLE MT. PLEASANT, SC

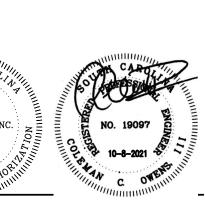



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AND DETAILS