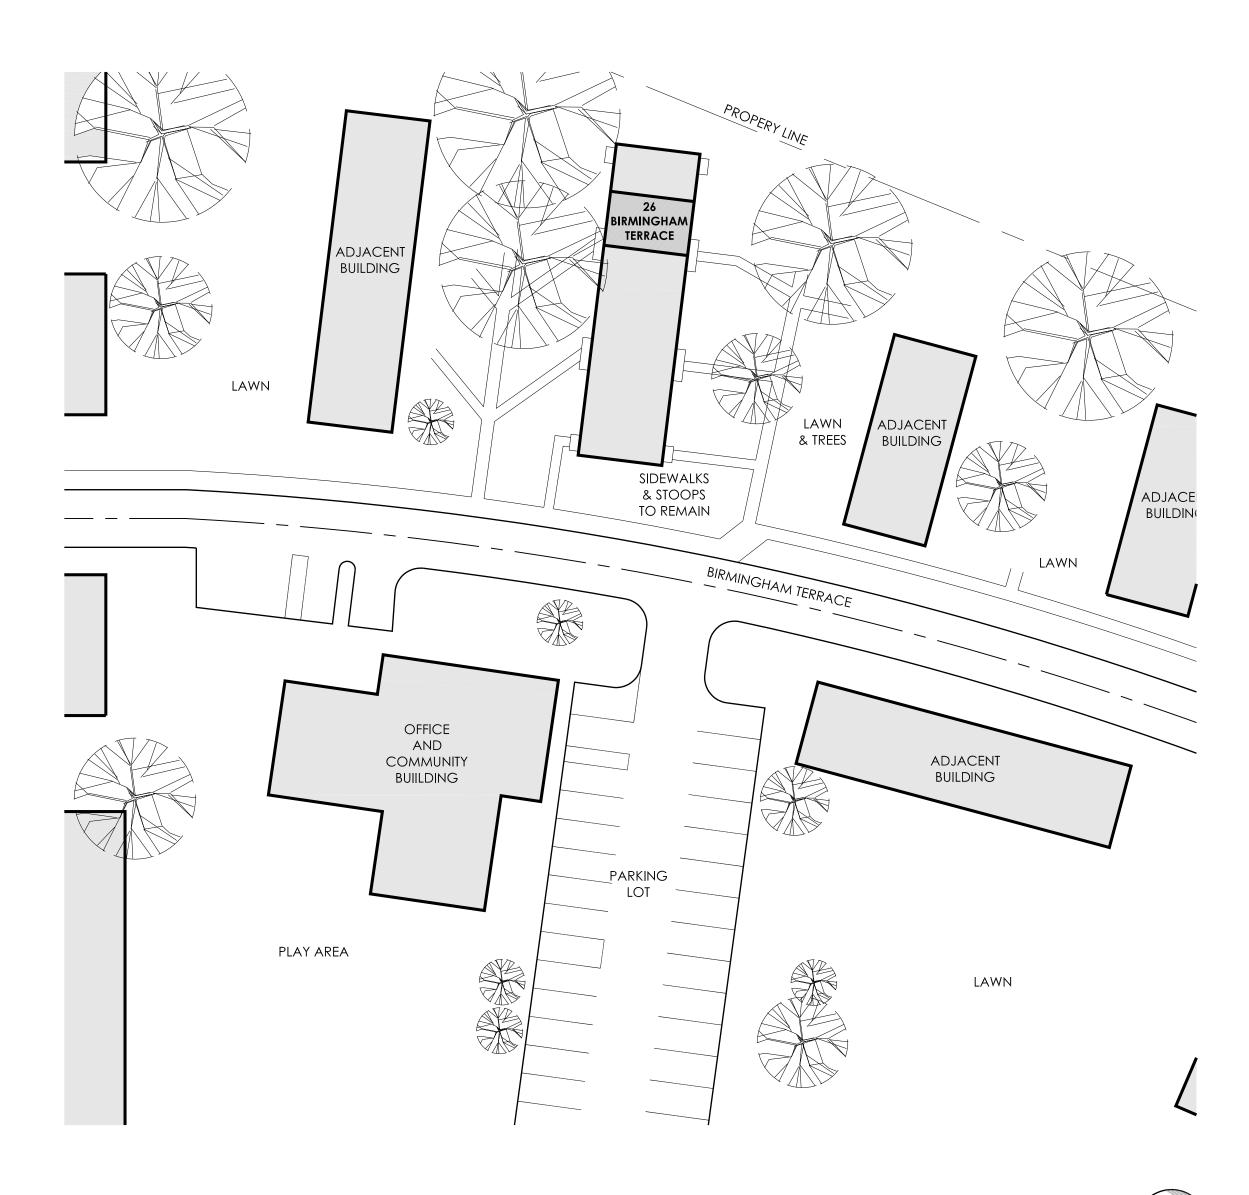
26 BIRMINGHAM TERRACE, TOLEDO, OH 43605


INDEX OF DRAWINGS

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155/F	ARCHITECTURAL
□ □ □ ■ T1.0	TITLE SHEET
□ □ □ ■ D2.0	DEMO PLAN AND NOTES
□ □ □ ■ D2.1	EXISTING PHOTOS
□ □ □ ■ A2.0	FLOOR PLANS AND NOTES
□ □ □ ■ A3.0	REFLECTED CEILING PLAN
□ □ □ ■ A8.0	INTERIOR ELEVATIONS & FINISH SCHEDULE
□ □ □ ■ A9.0	DOOR SCHEDULE AND DETAILS
□ □ □ ■ P1.0	PLUMBING SCHEDULES AND DETAILS
□ □ □ ■ P2.0	PLUMBING FLOOR PLANS
□ □ □ ■ M1.0	HVAC SCHEDULES AND DETAILS
□ □ □ ■ M2.0	HVAC FLOOR PLANS
□ □ □ ■ E1.0	ELECTRICAL SCHEDULES AND SPECIFICATION

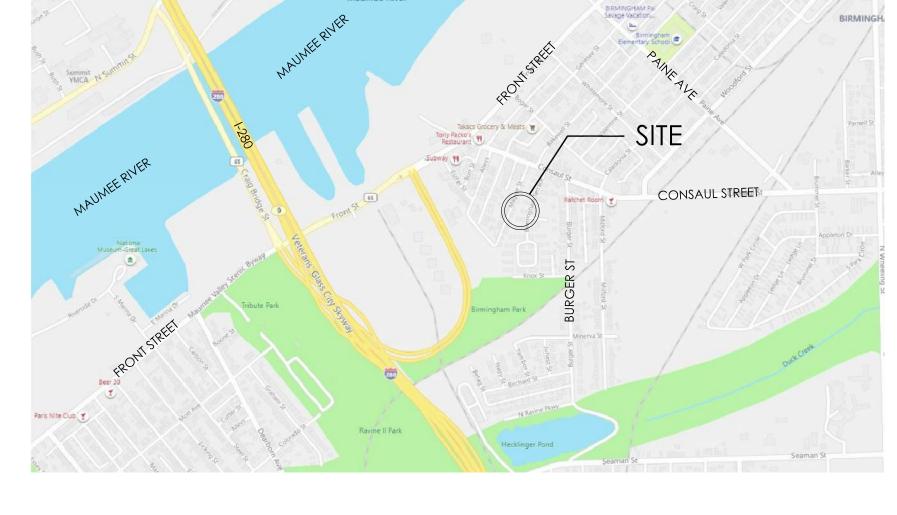ELECTRICAL FLOOR PLANS









CODE REVIEW

BUILDING OFFICIAL JURISDICTION:

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0 = 3

PROJECT DESCRIPTION:	PROJECT SCOPE OF WORK INVOLV RENOVATIONS/REPAIR DUE TO FIRE EXISTING UNIT IN A MULTI-FAMILY TW SCOPE OF WORK INVOLVES A CON REPLACEMENT OF FINISHES, FIXTURE OF THE SIX (6) UNITS IN THE BUILDING	AND SMOKE DAMAGE OF ONE VO STORY APARTMENT BUILDING. MPLETE INTERIOR GUT WITH S AND SYSTEMS THROUGHOUT ONE (1)				
PROJECT ADDRESS:	26 BIRMINGHAM TERRACE 2100 CONSAUL TERRACE TOLEDO, OHIO 43605	(SPECIFIC UNIT ADDRESS) (OVERALL PROPERTY ADDRESS)				
OBC-CHAPTER 3, USE AND OCCUPANCY: SECTION 310.5:	RESIDENTIAL GROUP R-3 EXISTING STRUCTURE; INDEPENDENT EXITS					

2019 OHIO RESIDENTIAL CODE

GENERAL BUILDING INFORMATION CONSTRUCTION TYPE 5B FOUNDATION

FIRST FLOOR SECOND FLOOR

CONCRETE SLAB ON GRADE STRUCTURAL CONCRETE SLAB GWB/PLASTER ON WOOD/METAL STUD

CMU FOUNDATION WALLS ON CONCRETE FOOTINGS

AREA (26 BIRMINGHAM TERRACE)

EXTERIOR BEARING WALLS

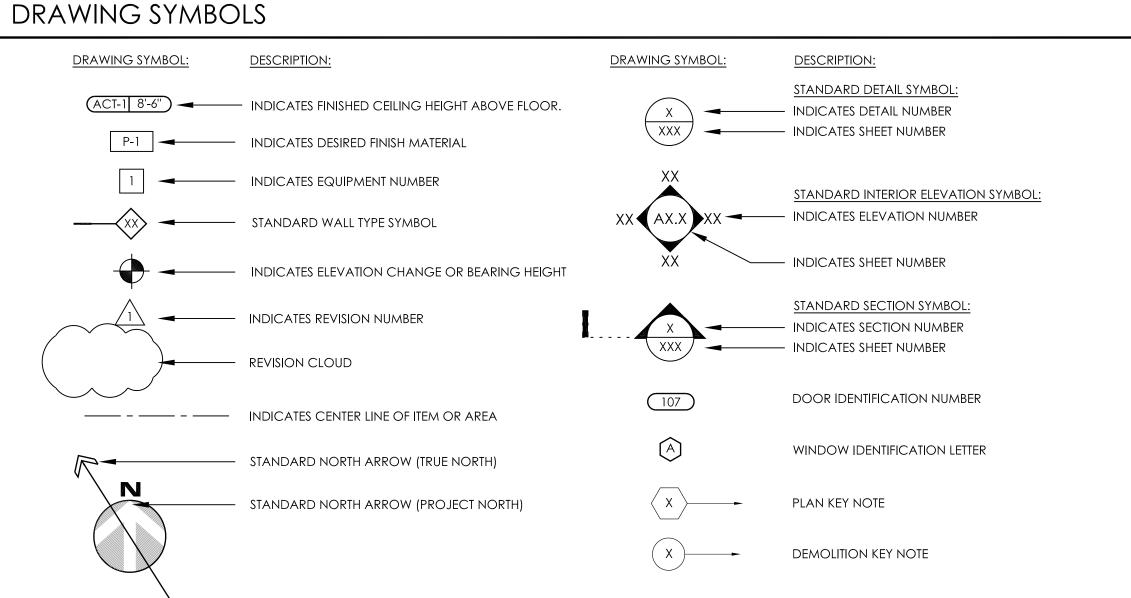
INTERIOR PARTITIONS

ROOF STRUCTURE

BRICK VENEER OR VINYL SIDING ON CMU WALLS STRUCTURAL CONCRETE SLAB (WOOD TRUSSES ADDED ON TOP OF CONCRETE SLAB IN 1986 FOR SLOPE & APPEARANCE)


785 SQUARE FEET - AREA OF WORK BEDROOMS

SITE PLAN





ABBREVIATIONS

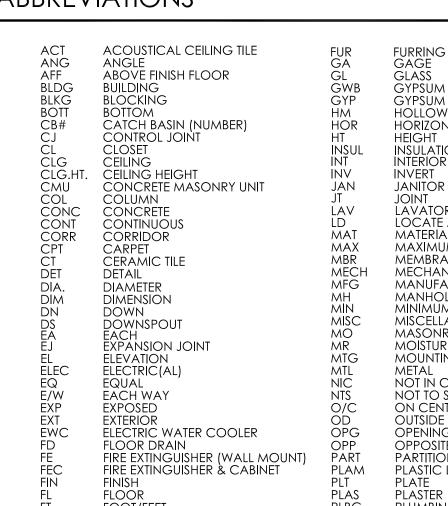

GYPSUM WALL BOARD LAVATORY LOCATE AS DIRECTED MANUFACTURER MISCELLANEOUS MASONRY OPENING MOISTURE RESISTANT MOUNTING NOT IN CONTRACT NOT TO SCALE ON CENTER OUTSIDE DIAMETER OPPOSITE
PARTITION
PLASTIC LAMINATE

RETURN AIR
RADIUS
RESILIENT BASE
ROOF DRAIN
REFERENCE
REINFORCING (MENT)
REQUIRED REVISION ROOM SCH SCHEDULE
SCONC SEALED CONCRETE
SIM SIMILAR
SN SIGNAGE
SPECS SPECIFICATIONS
SQ SQUARE
SC STAINLESS STEEL STANDARD TELEPHONE
TOP OF MASONRY
TOP OF STEEL
TOP OF WALL TELEVISION TYPICAL UNLESS NOTED OTHERWISE VINYL COMPOSITION TILE VERTICAL VANDAL RESISTANT WOOD WATERPROOFING WEIGHT WELDED WIRE FABRIC WITH

WITHOUT

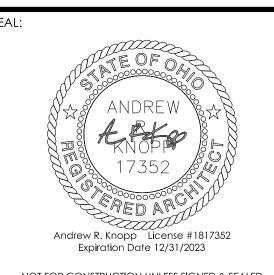
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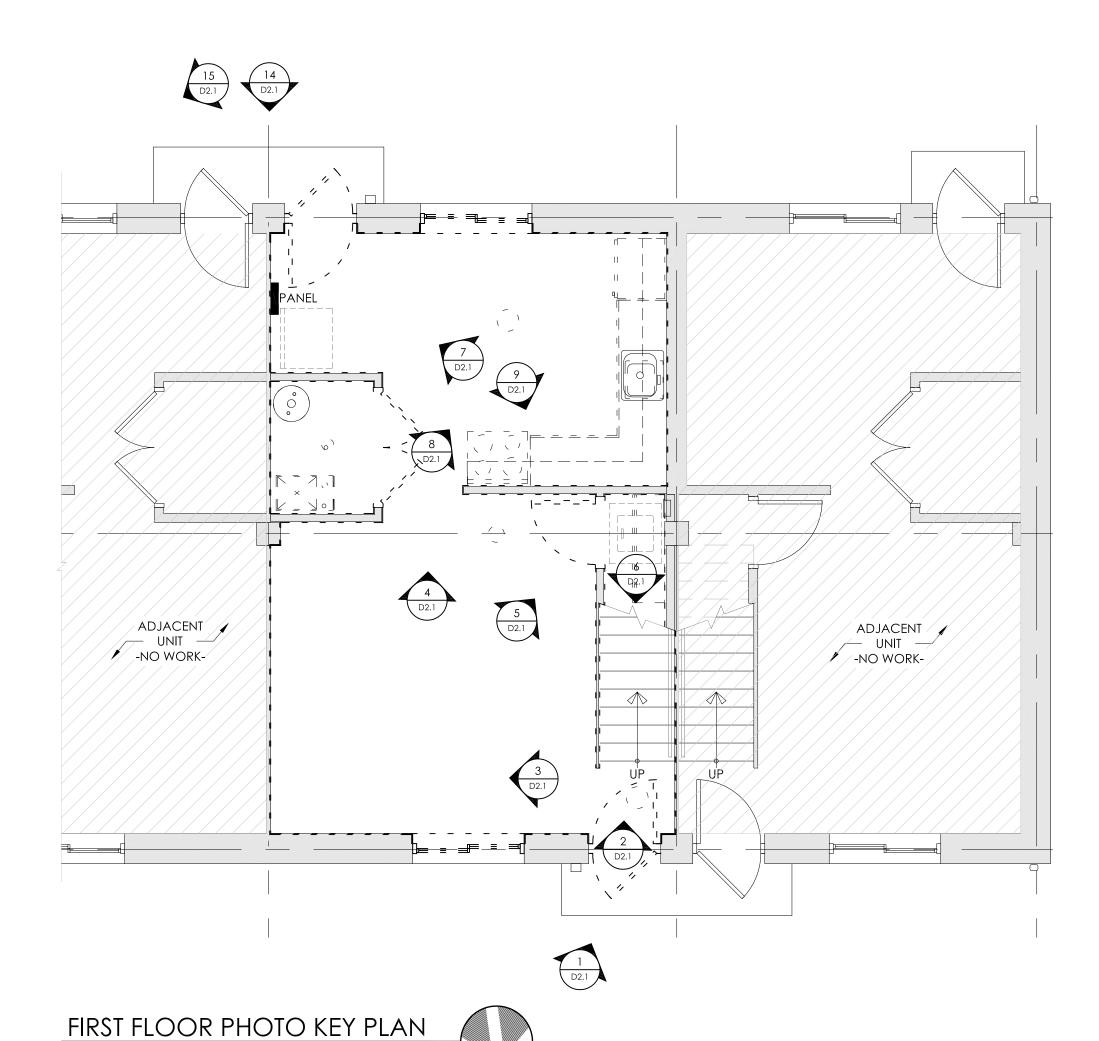
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GENERAL DEMOLITION NOTES

- 1. THE STRUCTURAL INTEGRITY OF THE BUILDINGS SHALL BE MAINTAINED DURING THE ENTIRE PROJECT. PROVIDE ANY & ALL SHORING AS REQUIRED.
- 2. THE SITE SHALL BE KEPT CLEAN AND CLEAR OF MISCELLANEOUS CONSTRUCTION DEBRIS AT THE END OF EACH WORKING DAY.
- 3. CONTRACTOR SHALL PROVIDE TEMPORARY BARRIERS/ENCLOSURES AT THE LIMITS OF CONSTRUCTION TO ASSURE PUBLIC SAFETY DURING CONSTRUCTION.
- 4. CONTRACTOR TO COORDINATE WHETHER DEMOLITION MATERIAL IS TO BE DISPOSED OR TO BE TURNED OVER TO OWNER. IF DEMOLITION MATERIAL IS TO BE DISPOSED, ALL DEMOLITION MATERIAL SHALL BE DISPOSED OF LEGALLY, OFF SITE.
- 5. NEW GWB AND PLASTER SURFACES TO MEET FLUSH WITH EXISTING GWB OR PLASTER SURFACES. AREAS BETWEEN NEW AND EXISTING SHALL BE VISIBLY UNNOTICEABLE. MATCH EXISTING SURFACE TEXTURES. SQUARE UP EXISTING DRYWALL EDGES AS NECESSARY.
- 6. ONCE MATERIALS HAVE BEEN REMOVED AS NOTED, COVER ALL EXISTING TO REMAIN SURFACES, SMOKE DAMAGED STUDS/FRAMING AND SHEATHING/DECKING, INCLUDING TRUSSES, RAFTERS AND CEILING JOISTS WITH SHELLAC BASED ZINSSER B-I-N 2 WHITE SEALANT TO PERMANENTLY SEAL ANY RESIDUAL SMOKE ODOR.
- 7. REFER TO SPEC. SECTION 02 82 00 FOR LOCATIONS OF THE ASBESTOS CONTAINING MATERIALS TO BE REMOVED OR ENCAPSULATED IN ACCORDANCE TO THE SPECIFICATIONS AND ALL APPLICABLE EPA AND OSHA WORK PRACTICES.
- 8. ADJACENT UNITS ARE OCCUPIED. MAINTAIN SYSTEMS AND COMPONENTS OF ADJACENT UNITS IN THEIR ENTIRETY.
- 9. CONTRACTOR TO REMOVE LOOSE CONTENTS FROM PAST TENANT. ABATEMENT CONTRACTOR TO REMOVE CONTAMINATED LOOSE CONTENTS.

DEMOLITION LEGEND

- - - - - ITEM OR AREA TO BE REMOVED AS SHOWN AND NOTED.

DASHED OUTLINE ON EXISTING WALL INDICATES REMOVAL OF GWB ON ONE OR BOTH SIDES. FRAMING TO REMAIN U.N.O. REMOVE BATT INSULLATION IN EXISTING EXTERIOR WALLS OR DEMISING WALLS.

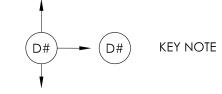


PHOTO LOCATION TAG

DEMOLITION KEYED NOTES

- TYP.

 D1

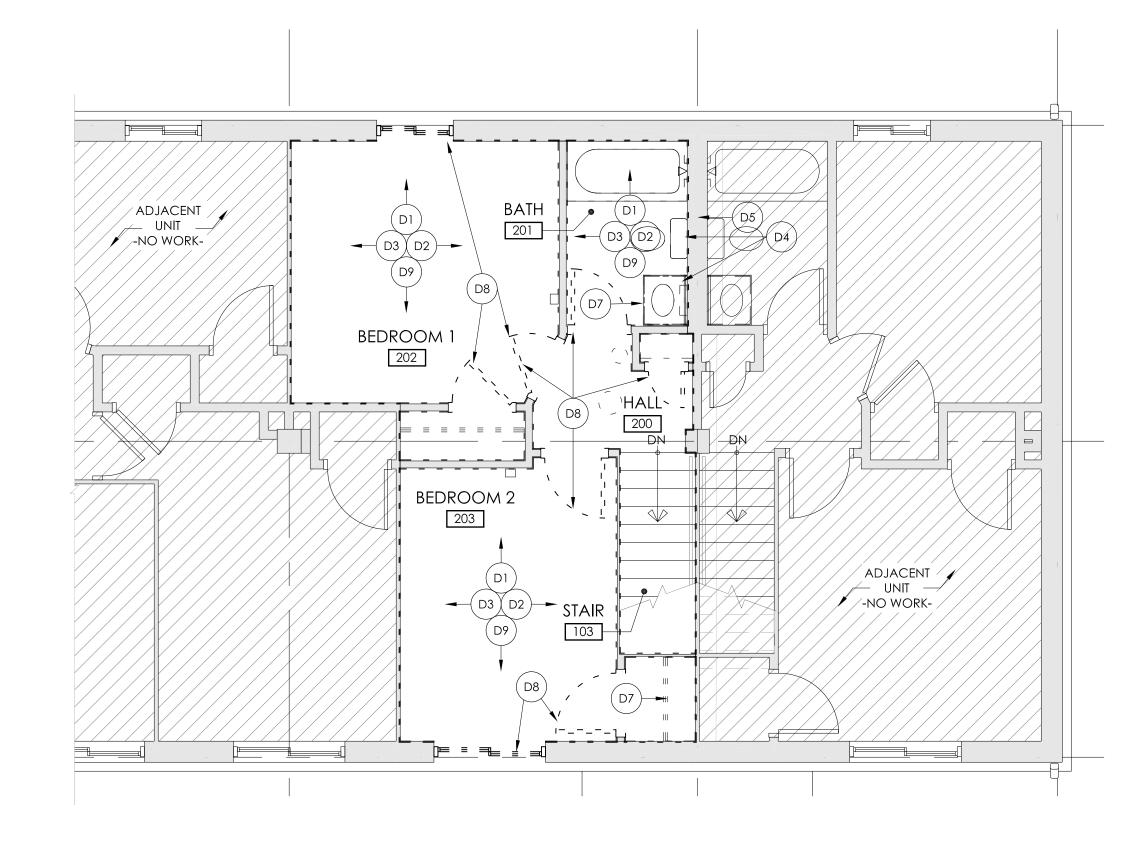
 REMOVE EXISTING GWB ON ALL INTERIOR PARTITIONS AND SOFFITS THROUGHOUT THE UNIT IN ITS ENTIRETY. STABILIZE PLASTER SURFACES (EXTERIOR WALLS, SOME INTERIOR PARTITIONS), SEAL WITH SHELLAC, AND INSTALL SKIM COAT. REMOVE ALL FASTENERS AND OTHER SURFACE MOUNTED COMPONENTS U.N.O. AND PREPARE FOR SEALING AND/OR GWB INSTALLATION AS DETAILED AND SPECIFIED.
- DISCONNECT AND REMOVE EXISTING ELECTRICAL COMPONENTS IN THEIR ENTIRETY INCLUDING RANGE HOOD, SMOKE DETECTORS, DOORBELL, LIGHT FIXTURES, BOXES, WIRING, SWITCHES AND RECEPTACLES. PREPARE FOR INSTALLATION OF NEW ELECTRICAL SYSTEM. SEE ELECTRICAL DRAWINGS FOR COMPLETE SCOPE OF WORK. REPLACE EXISTING PANEL AND EXTERIOR METER.
- TYP.

 D3

 REMOVE EXISTING FURNACE, SUPPLY DIFFUSERS, RETURN GRILLES, THERMOSTAT, DAMAGED DUCTS & OTHER HVAC COMPONENTS IN THEIR ENTIRETY & DISPOSE.


 EXISTING UNDAMAGED RIGID DUCTS ARE PERMITTED TO REMAIN IF PROFESSIONALLY CLEANED UTILIZING VACUUM COLLECTION & ROTARY BRUSH/AIR WHIPS INSIDE AND OUT. PREPARE FOR INSTALLATION OF NEW SYSTEM AS DETAILED & SPECIFIED. SEE HVAC DRAWINGS FOR COMPLETE SCOPE OF WORK.
- REMOVE EXISTING PLUMBING FIXTURES (WATER CLOSET, LAVATORY, SINK, WATER HEATER, WASHER BOX), P-TRAPS, WATER STOPS AND OTHER FITTINGS IN THEIR ENTIRETY AND DISPOSE. OTHER UNDAMAGED IN-WALL OR IN-FLOOR PIPING TO REMAIN U.N.O. PREPARE FOR INSTALLATION OF NEW PLUMBING AND FIXTURES AS DETAILED AND SPECIFIED.
- REMOVE EXISTING BATT INSULATION IN TENANT/UNIT DEMISING WALLS WITH CAVITIES AND BATHROOM/MECHANICAL ROOM WALLS. PREPARE FOR REPLACEMENT. SEE WALL TYPE LEGEND AND FLOOR PLANS.
- REMOVE ALL BATHROOM ACCESSORIES AND PREPARE FOR REPLACEMENT.
 ACCESSORIES INCLUDE A FLUSH MEDICINE CABINET AND MIRROR, SHOWER
 CURTAIN ROD, (2) TOWEL BARS, AND A TOILET PAPER DISPENSER.
- PREMOVE EXISTING BASE/WALL CABINETS, APPLIANCES, CLOSET SHELVING AND RODS AND DISPOSE. EXISTING STAIR HANDRAIL TO REMAIN. SEAL AND PAINT EXISTING HANDRAIL. PREPARE FOR INSTALLATION OF NEW ITEMS.
- REMOVE EXISTING INTERIOR/EXTERIOR DOORS, WINDOWS, AND FRAMES IN THEIR ENTIRETY. REMOVE INTERIOR WINDOW STOOLS/SILLS. EXTERIOR 1ST FLOOR BRICK SILLS TO REMAIN. REPLACE EXTERIOR VINYL OR FIBER CEMENT TRIM AS REQUIRED OR NOTED. EXISTING LINTELS/HEADERS TO REMAIN U.N.O. PREPARE OPENINGS FOR INSTALLATION OF NEW DOORS AND WINDOWS.
- REMOVE ALL EXISTING FLOORING AND ADHESIVE IN ITS ENTIRETY DOWN TO EXISTING CONCRETE SLAB. PREPARE FOR NEW FINISH FLOORING. SEE GENERAL DEMO NOTE 7 REGARDING ABATEMENT.
- REMOVE EXISTING RESILIENT STAIR TREAD AND NOSING IN THEIR ENTIRETY.


 STABILIZE AND PREPARE TO PAINT STEEL STRINGERS AND RISERS. PREPARE TO INSTALL NEW RESILIENT STAIR TREADS AND RISERS. PROTECT ADJACENT WALL SURFACES, FLOORING AND WALL BASE. SEE GENERAL DEMO NOTE 7 REGARDING ABATEMENT.



SECOND FLOOR DEMO PLAN

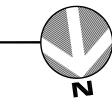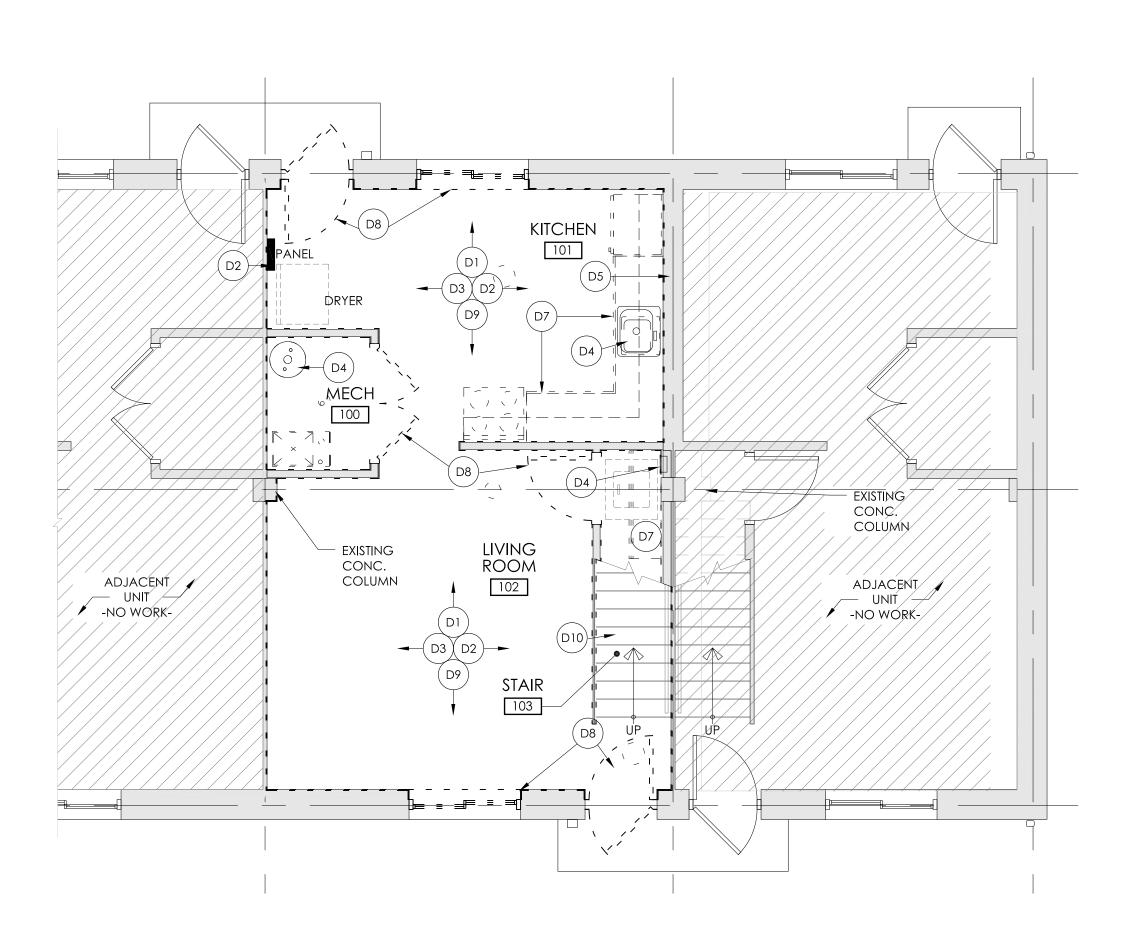SCALE: 1/4" = 1'-0"









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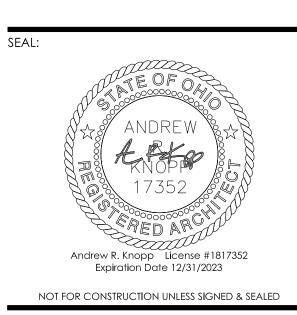
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26 BIRMINGE

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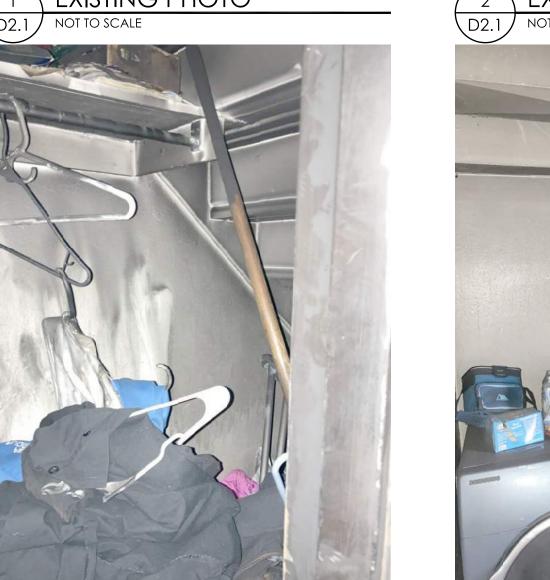
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DEMO PLANS & NOTES









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*SEE PHOTO KEY PLANS ON SHEET D2.0 FOR PHOTO LOCATION TAGS



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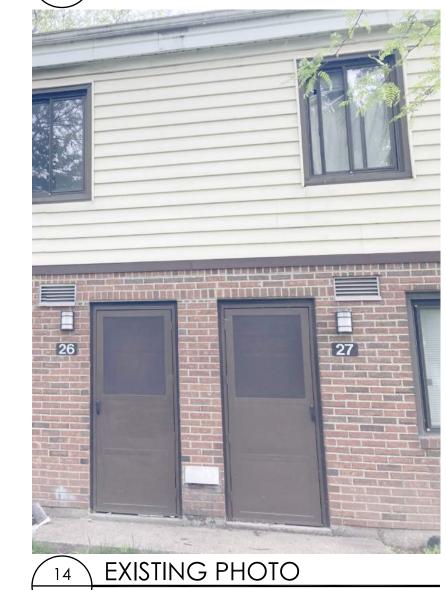
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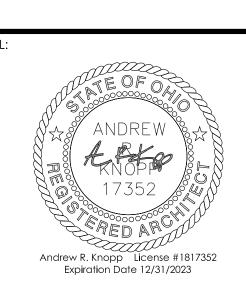
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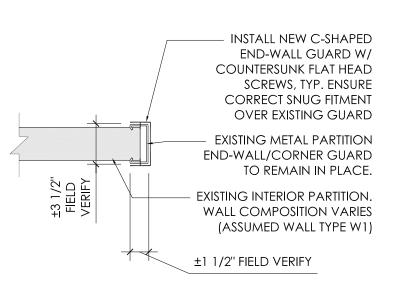
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- EACH CONTRACTOR SHALL NOTIFY THE OWNER'S REPRESENTATIVE AND ARCHITECT IMMEDIATELY IF A
 DISCREPANCY IS FOUND BETWEEN THE DIMENSIONS GIVEN AND THE ACTUAL DIMENSIONS IN THE
 FIELD. CONTRACTOR IS TO FIELD VERIFY ALL DIMENSIONS PRIOR TO WORK AND ORDERING OF
 MATERIALS.
- 2. CONTRACTOR SHALL PROVIDE TEMPORARY BARRIERS/ENCLOSURES AT THE LIMITS OF CONSTRUCTION TO ASSURE PUBLIC SAFETY DURING CONSTRUCTION. CONTRACTOR MUST MAINTAIN ACCESS TO OTHER AREAS OF THE EXISTING STRUCTURE STILL IN USE, PUBLIC STREETS AND EXISTING DRIVES / ENTRANCES AT ALL TIMES.
- 3. ALL DEMOLITION MATERIAL TO BE DISPOSED OF LEGALLY, OFF SITE, UNLESS SPECIFICALLY NOTED OTHERWISE.
- 4. DIMENSIONS SHOWN ON PLAN ARE TO FACE OF EXISTING WALL AND TO STUD OF NEW WALL UNLESS NOTED OTHERWISE. SEE GENERAL NOTE 1 THIS SHEET.
- 5. THE LOCATION OF ALL UNDERGROUND UTILITIES ARE APPROXIMATE. THE EXACT LOCATION OF ANY UNDERGROUND UTILITIES SHALL BE THE CONTRACTOR'S RESPONSIBILITY. THE CONTRACTOR SHALL CONTACT THE OHIO UTILITIES PROTECTION SERVICE (OUPS 1-800-362-2764) AT LEAST TWO (2) WORKING DAYS PRIOR TO TO COMMENCING WORK. NON-MEMBERS MUST BE CALLED DIRECTLY.
- 6. THE CONTRACTOR SHALL PROTECT AND MAINTAIN ALL EXISTING UTILITIES, PAVEMENTS, LANDSCAPING AND TREES WHICH ARE TO REMAIN.
- 7. CONTRACTOR TO COORDINATE STAGING AREA WITH OWNER'S REPRESENTATIVE PRIOR TO MOBILIZING.
- 8. AFTER DEMOLITION, SEAL ALL CONCRETE CEILINGS, EXISTING PLASTER WALLS, AND EXISTING WALL FRAMING W/ ZINSSER B-I-N 2 SHELLAC PRIOR TO INSTALLATION OF NEW MATERIALS.

KEYED PLAN NOTES

- NEW KITCHEN BASE AND WALL CABINETS, COUNTERTOPS AND BACKSPLASH. NEW KITCHEN SINK AND FAUCET. SEE SHEET P1.0 AND INTERIOR ELEVATIONS.
- NEW BATHROOM LAVATORY BASE, VANITY TOP, AND FAUCET. SEE SHEET P1.0 AND INTERIOR ELEVATIONS.
- NEW MEDICINE CABINET, TOILET PAPER DISPENSER, TOWEL BARS AND OTHER WALL MOUNTED OR VANITY MOUNTED RESTROOM ACCESSORIES ONE FOR ONE. SEE INTERIOR ELEVATIONS AND FINISH LEGEND.
- 4 NEW CLOSET SHELVING AND ROD OR LINEN SHELVING. SEE DETAIL ON SHEET A3.0
- 5 NEW EXTERIOR PVC WINDOWS AND INTERIOR BLINDS. NEW DOOR, FRAME, AND HARDWARE.
- 6 EXISTING HANDRAIL TO REMAIN IN PLACE. ENSURE EXISTING HANDRAIL MOUNTING IS SECURE. PREP AND PAINT.
- EXISTING APPLIANCES (REFRIGERATOR AND RANGE) WILL BE REPLACED. OTHERS TO REMOVE, PURCHASE, AND DELIVER NEW ITEMS TO UNIT. CONTRACTOR SHALL INSTALL ITEMS AND PROVIDE ANY AND ALL REQUIRED ELECTRICAL/MECHANICAL CONNECTIONS (SUCH AS GAS LINE OR POWER CHORD EXTENSIONS) THAT ARE NOT PROVIDED WITH APPLIANCE PURCHASE.
- 8 NEW STAINLESS STEEL RANGE WALL COVERING. SEE FINISH LEGEND AND INTERIOR ELEVATIONS.
- 9 NEW 12"X12" (OR 8"X8" AS SPACE ALLOWS) RECESSED METAL PLUMBING ACCESS PANEL W/FRAME. TAMPERPROOF & PAINTABLE. EASTMAN MODEL # 34064 OR APPROVED EQUAL.

WALL TYPE LEGEND											
TAG #	PLAN VIEW	DESCRIPTION									
<u></u>	METAL STUD	EXISTING INTERIOR METAL STUD PARTITION OR DEMISING WALL - 2" WIDTH PER PLAN - 3/4" METAL STUDS W/ 5/8" METAL LATH/PLASTER EA. SIDE. EXISTING INTERIOR PLASTER FINISH SCOPE OF WORK: STABILIZE, SEAL WITH SHELLAC, SKIM COAT, AND FINISH PAINT. DO NOT DISTURB PLASTER/LATH AT ADJACENT UNITS									
<u></u>	WOOD STUD	EXISTING INTERIOR WOOD STUD PARTITION IR DEMISING WALL - THICKNESS VARIES - WOOD STUDS W/ GWB EACH SIDE. EXISTING INTERIOR GWB FINISH SCOPE OF WORK: NEW (1) LAYER 5/8" TYPE X GWB EACH SIDE. FILL CAVITIES W/ NEW MIN. R-13 BATT INSUL AROUND BATHROOM AND MECHANICAL ROOM. DO NOT DISTURB GWB AT ADJACENT UNITS.									
₩3 <u></u>		EXISTING EXTERIOR CONCRETE BLOCK WALL. EXISTING CONTINUOUS INSULATION. EXISTING FIRST FLOOR EXTERIOR BRICK VENEER. EXISTING SECOND FLOOR EXTERIOR VINYL SIDING. EXISTING INTERIOR PLASTER FINISH SCOPE OF WORK: STABILIZE, SEAL WITH SHELLAC, SKIM COAT, AND FINISH PAINT.									



1 PLAN DETAIL @ END WALL A2.0 1-1/2" = 1'-0" CONDITION EXISTS AT TOP AND BOTTOM OF STAIR

SCOPE OF WORK OVERVIEW

THIS SECTION INCLUDES A BRIEF DESCRIPTION OF THE WORK. IT IS ISSUED AS A GUIDE TO AID THE BIDDER IN UNDERSTANDING THE SCOPE OF WORK, BUT SHALL NOT BE CONSIDERED AS BEING ALL INCLUSIVE OR LIMITED TO THE SCOPE OF THE WORK DESCRIBED IN THE CONTRACT DOCUMENTS.


BASE BID: STATE THE DOLLAR AMOUNT TO FURNISH ALL MATERIAL, LABOR AND EQUIPMENT NECESSARY FOR THE COMPLETE INSTALLATION/RENOVATIONS IN THE AREA OF WORK TO A PRE-INCIDENT CONDITION:

- 1. ABATEMENT AS INDICATED. AIR CLEARANCE TESTING AND WIPE TESTS WILL BE BY OWNER.
- 2. REMOVAL AND REPLACEMENT OF EXISTING FINISHES (GYPSUM WALL BOARD, WALL BASE, FLOORING, INTERIOR GYPSUM SOFFITS, DOOR/WINDOW TRIM) AS INDICATED. UNDAMAGED PLASTER ON SELECT WALLS SHALL REMAIN.
- 3. REMOVAL AND REPLACEMENT OF EXISTING ELECTRICAL SYSTEMS AND COMPONENTS IN THEIR ENTIRETY INCLUDING RANGE HOOD, SMOKE DETECTORS, DOORBELL, LIGHT FIXTURES, WIRING DEVICES, WIRING, SERVICE PANEL AND METER, AS INDICATED. UTILIZE SURFACE MOUNTED WIREMOLD AND DEVICES ONLY ON EXISTING PLASTER AND BLOCK WALLS.
- 4. REMOVAL AND REPLACEMENT OF EXISTING N.G. FURNACE, SUPPLY DIFFUSERS, RETURN GRILLES, THERMOSTAT, DAMAGED DUCTS AND OTHER HVAC COMPONENTS IN THEIR ENTIRETY. REPLACE EXISTING EXTERIOR B-VENT WITH CONCENTRIC VENT.
- 5. REMOVAL AND REPLACEMENT OF EXISTING PLUMBING FIXTURES (WATER CLOSET, LAVATORY, SINK, TUB, WATER HEATER), P-TRAPS, WATER STOPS AND OTHER FITTINGS IN THEIR ENTIRETY. SELECT PLUMBING FIXTURES MAY REQUIRE REPLACEMENT OF PIPING BACK TO MAIN WHILE OTHER UNDAMAGED AND CONCEALED PIPING MAY REMAIN WITH VISUAL INSPECTION AND APPROVAL BY OWNER/ARCHITECT AFTER DEMOLITION.
- 6. REMOVAL AND REPLACEMENT OF CASEWORK (RESTROOM VANITY BASE & KITCHEN CABINETS), COUNTERTOPS, AND PANTRY/CLOSET SHELVING/RODS.
- 7. REMOVAL AND REPLACEMENT OF RESTROOM, CLOSET, AND KITCHEN ACCESSORIES, SUCH AS SHELVING, RECESSED MEDICINE CABINET, MIRROR, SHOWER CURTAIN ROD, CLOTHS RODS, TOWEL RACKS, AND TOILET PAPER AND PAPER TOWEL DISPENSERS.
- 8. REMOVE EXISTING RUBBER STAIR TREADS IN THEIR ENTIRETY DOWN TO CONCRETE/STEEL STAIR STRUCTURE. STABILIZE LEAD PAINT ON STEEL AND PAINT STEEL STRINGERS AND RISERS. INSTALL NEW RESILIENT STAIR READS AND RISERS.
- 9. INSTALL STAINLESS STEEL END-WALL GUARD COVER OVER EXISTING PAINTED END-WALL GUARD COVER. LOCATION OF EXISTING GUARDS ARE AT THE TOP AND BOTTOM OF STAIRS. VERIFY IN FIELD LOCATIONS AND SIZES.
- 10. REMOVAL AND REPLACEMENT OF ALL DOORS, HARDWARE, WINDOW AND WINDOW TREATMENTS (BLINDS).
- 11. REMOVAL AND REPLACEMENT OF BATT INSULATION AT UNIT/TENANT SEPARATION WALLS AND RESTROOM WALLS.
- 11. SMOKE AND ODOR ELIMINATION. SEAL ALL EXISTING TO REMAIN SURFACES INCLUDING WALLS, TRIM, DOORS, JOISTS, ETC. WITH SHELLAC BASED WHITE SEALANT.
- 12. THOROUGH CLEANING OF INTERIOR AND EXTERIOR SURFACES AND FIXTURES THROUGHOUT UNIT.
- 13. INTERIOR PRIMING/PAINTING THROUGHOUT THE UNIT.
- 14. PERFORM SANITARY SCOPING FROM ALL EXISTING PLUMBING FIXTURES TO THE EXTERIOR OF THE UNIT AND, IF OBSTRUCTIONS OR DAMAGES EXIST, REMOVE SAID OBSTRUCTION OR REPAIR AND CLEAN SANITARY LINES.


REFER TO DRAWINGS AND SPECIFICATION FOR COMPLETE SCOPE OF WORK.


DEDUCT ALTERNATE: STATE THE DOLLAR AMOUNT TO BE DEDUCTED FROM THE BASE BID TO FURNISH ALL MATERIAL, LABOR AND EQUIPMENT NECESSARY FOR THE COMPLETE INSTALLATION/RENOVATIONS IN THE AREA OR WORK TO A PRE-INCIDENT CONDITION:

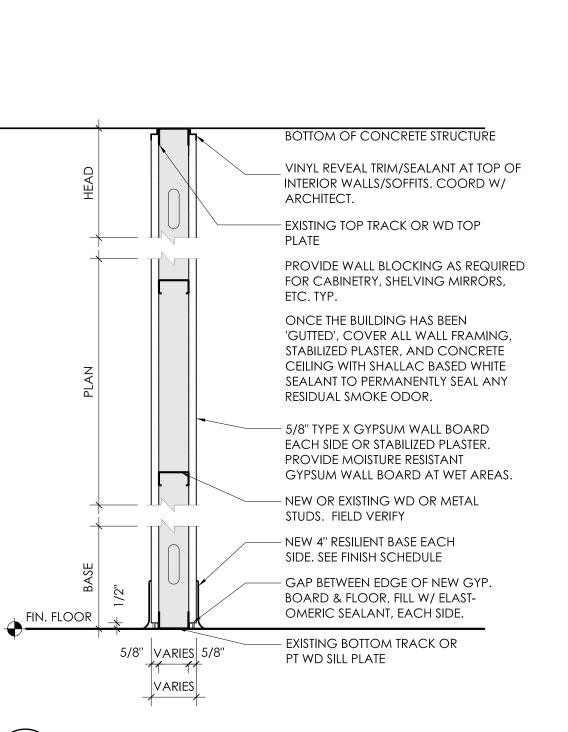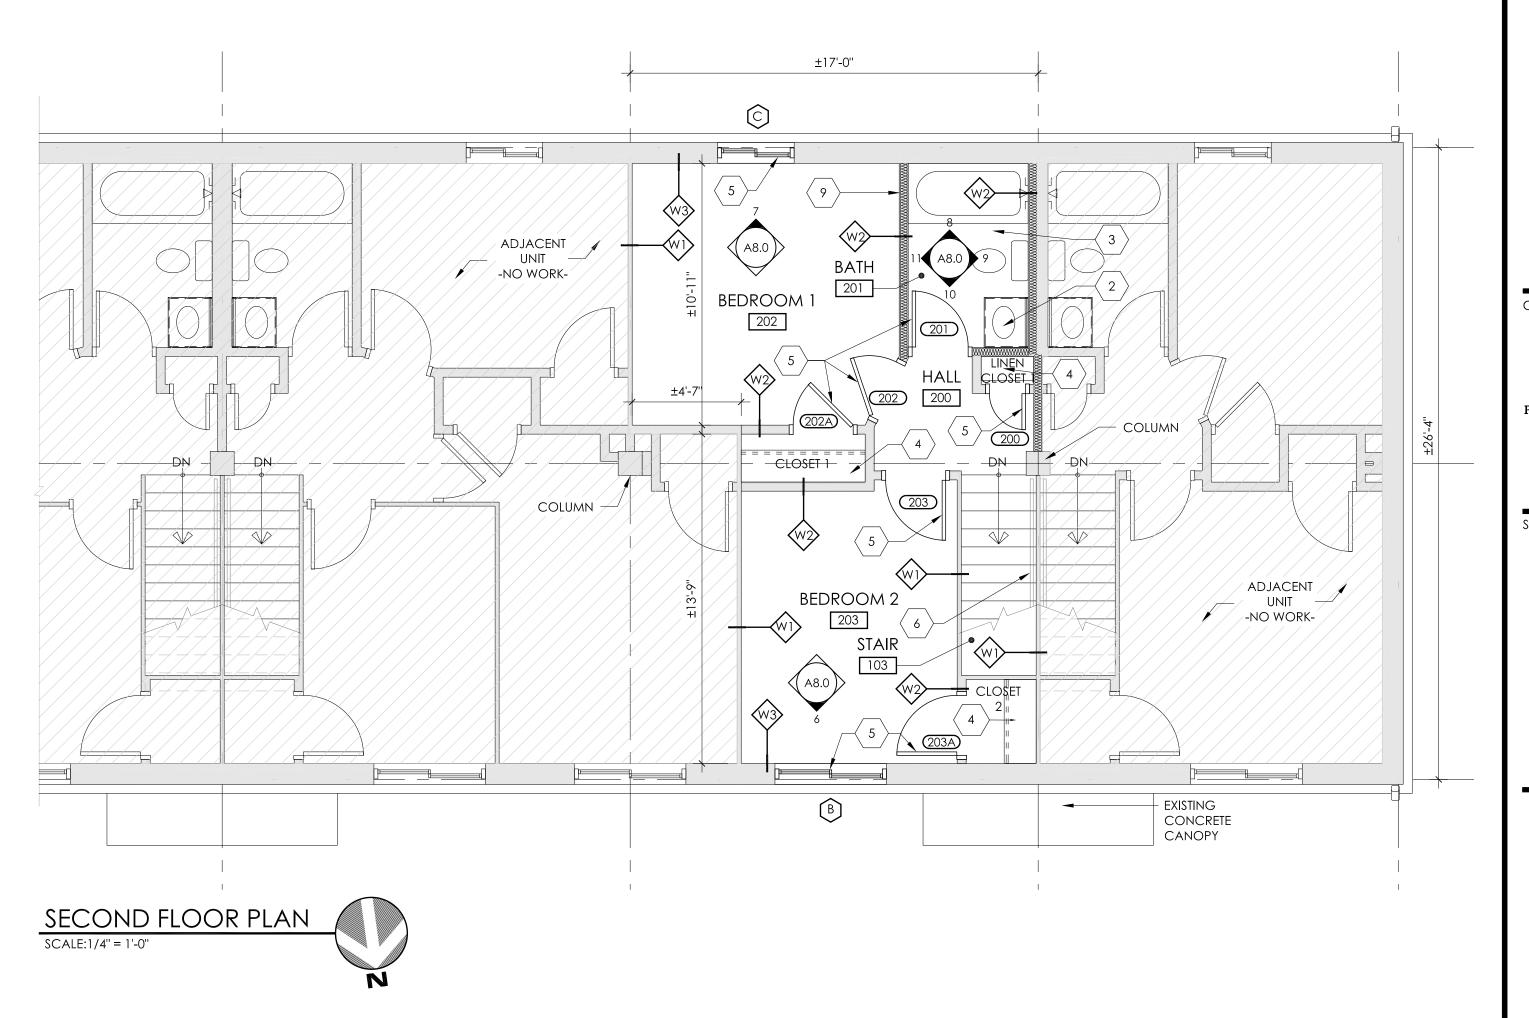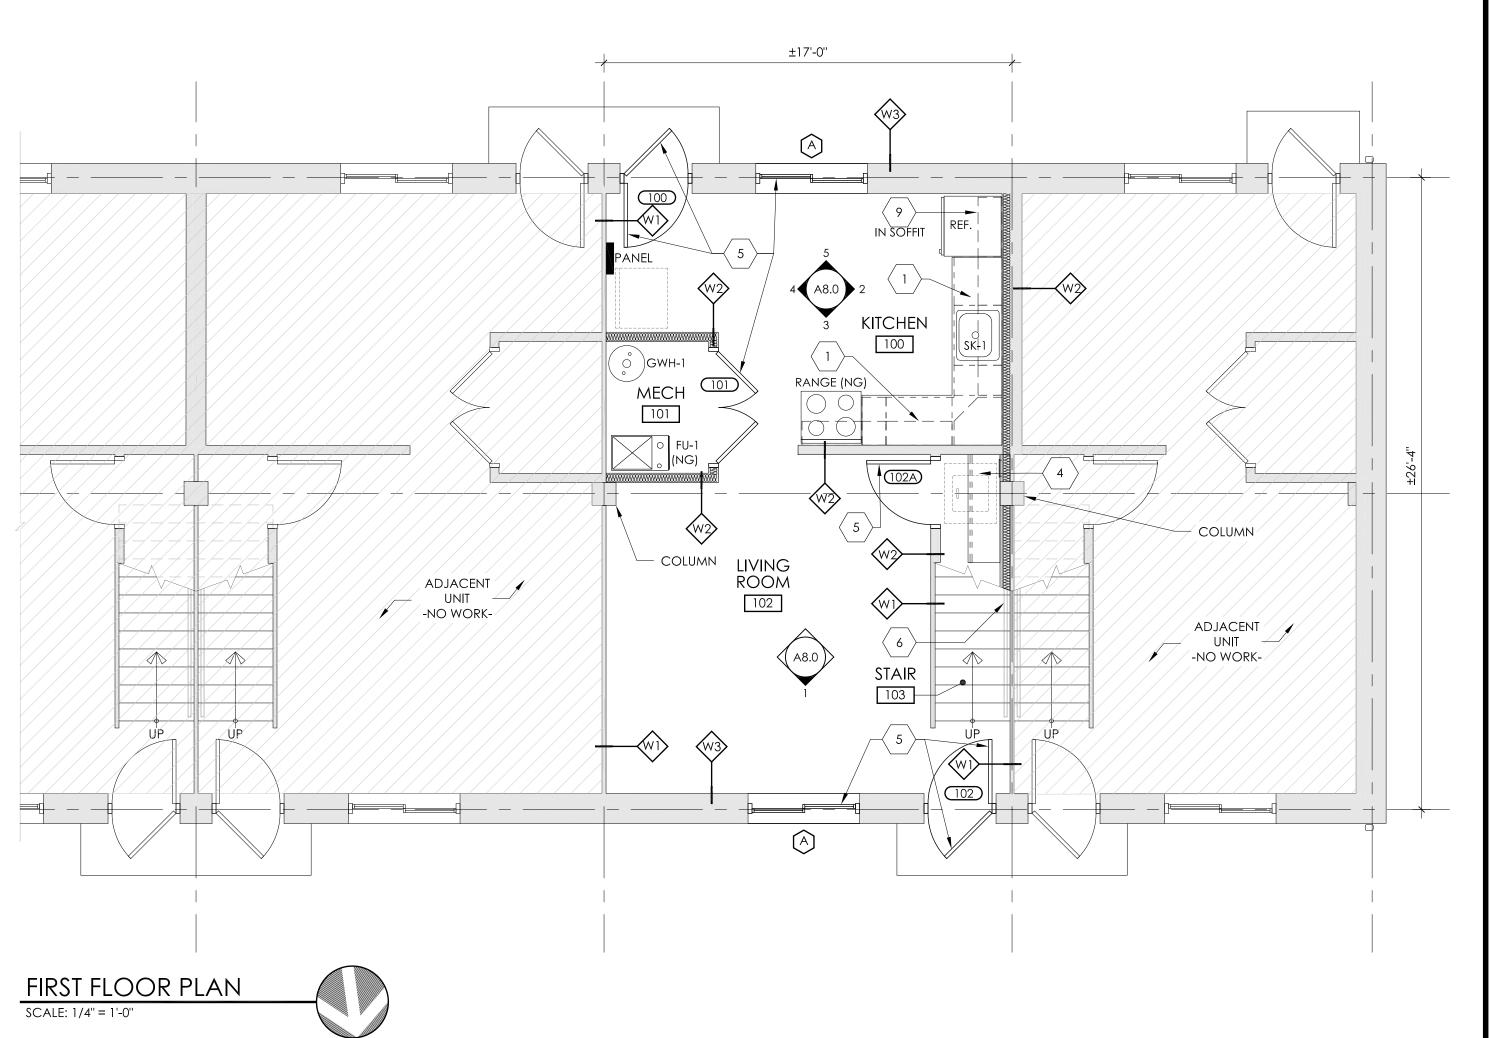1. DEDUCT COST TO PROVIDE A NEW HIGH EFFICIENCY FURNACE WITH NEW CONCENTRIC INTAKE/EXHAUST. INCLUDE THE COST FOR A STANDARD EFFICIENCY FURNACE AND UTILIZE EXISITNG FLUE. SEE SHEET M1.0 FOR BASIS OF SPECIFICATION.











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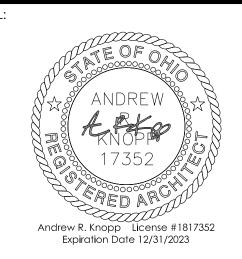
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CHECKED: ARK

TPA COMMISSION NUMBER: 22022

DRAWING TITLE:

FLOOR PLANS
AND NOTES

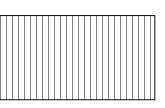
A2.

CEILING LEGEND:

SYMBOL

NEW LIGHT FIXTURE. SEE SHEET E1.0 FOR COMPLETE SCOPE OF WORK.

DESCRIPTION



EXTERIOR VINYL SOFFIT PANEL - EXISTING



PAINTED CONCRETE CEILING (PCC)



NEW GYPSUM WALL BOARD SOFFIT. SEE DETAIL THIS SHEET. TEXTURE AND PAINT AS INDICATED ON FINISH SCHEDULE/LEGEND. MOISTURE RESISTANT GWB AT WET LOCATIONS.

NAME 100 GWB 8'-0"

ROOM AND ROOM NUMBER TAG.

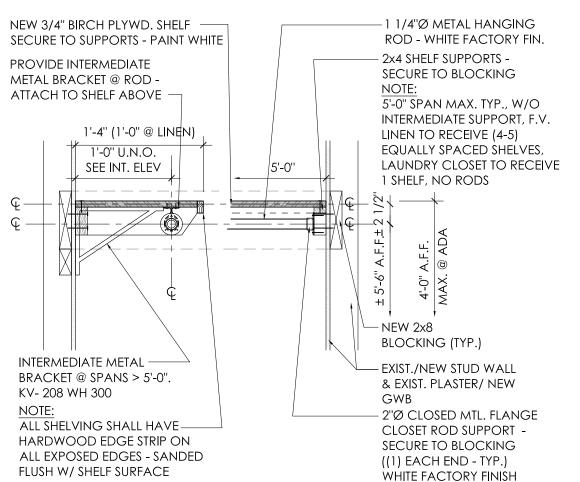
CEILING TYPE AND HEIGHT TAG.

NEW COMBINATION FIRE ALARM SMOKE/CARBON MONOXIDE DETECTOR 120V WITH BATTERY BACKUP & DUAL SENSOR SMOKE (IONIZATION AND PHOTOELECTRIC) TECHNOLOGY SHALL HAVE DUAL CONTACTS FOR INTER-CONNECT WIRING WITHIN EACH DWELLING UNIT.


NEW IN LINE BATHROOM VENTILATION FAN. NEW DUCT. EXISTING WALL PENETRATION. SEE SHEET E1.0 FOR COMPLETE SCOPE OF WORK.


CEILING GENERAL NOTES:

- 1. ALL WORK AND FINISHES SHALL BE NEW.
- 2. REFER TO FINISH SCHEDULE SHEET A8.0 FOR ALL MATERIALS, PAINTS & CEILING HEIGHT SPECIFICATIONS.
- 3. COORDINATE CEILING PENETRATIONS WITH OTHER TRADES. NEATLY SEAL PERIMETER OF PENETRATIONS PRIOR TO FINISH PAINT.
- 4. PAINTED CONCRETE CEILING (PCC) TYP., SHELLAC SEAL, REPAIR AND PAINT. SEE FINISH LEGEND SHEET A8.0
- 5. 5/8" TYPE X GWB AT SOFFITS. 1/2" SAG RESISTANT GWB PERMITTED ONLY WHERE MEMBERS ARE SPACED AT 16" O.C. MAX. SEE FINISH LEGEND SHEET A8.0. MOISTURE RESISTANT GWB AT WET AREAS.




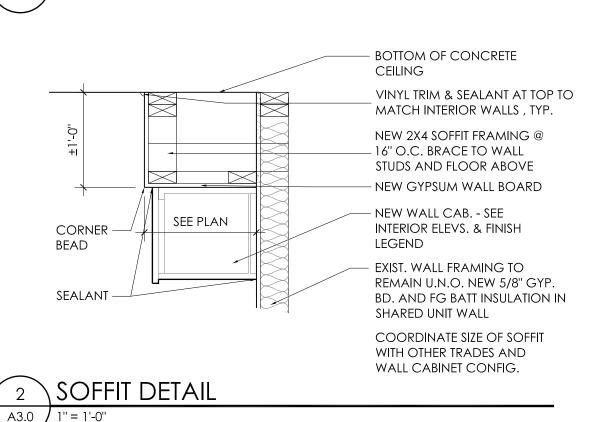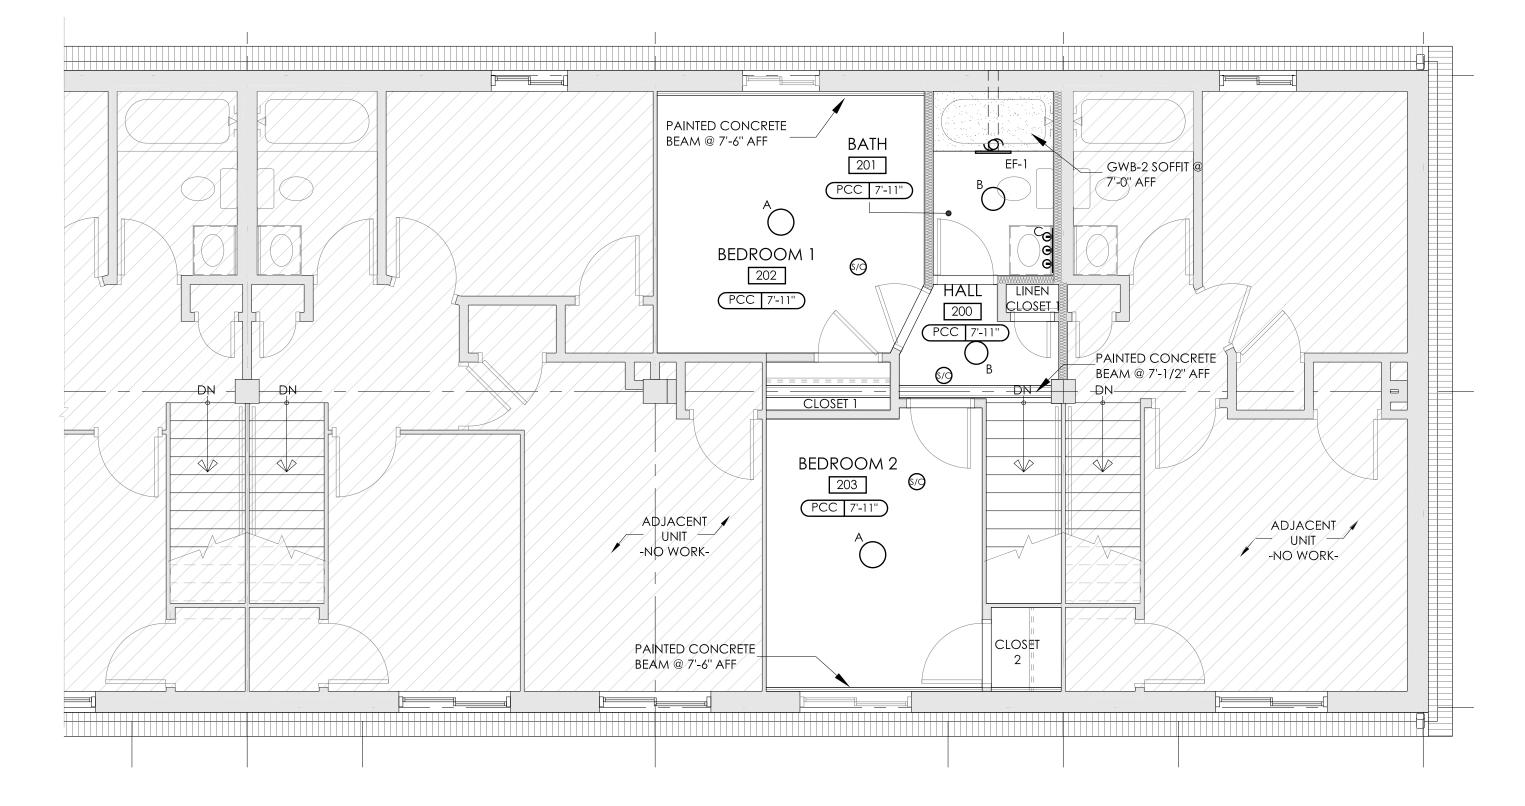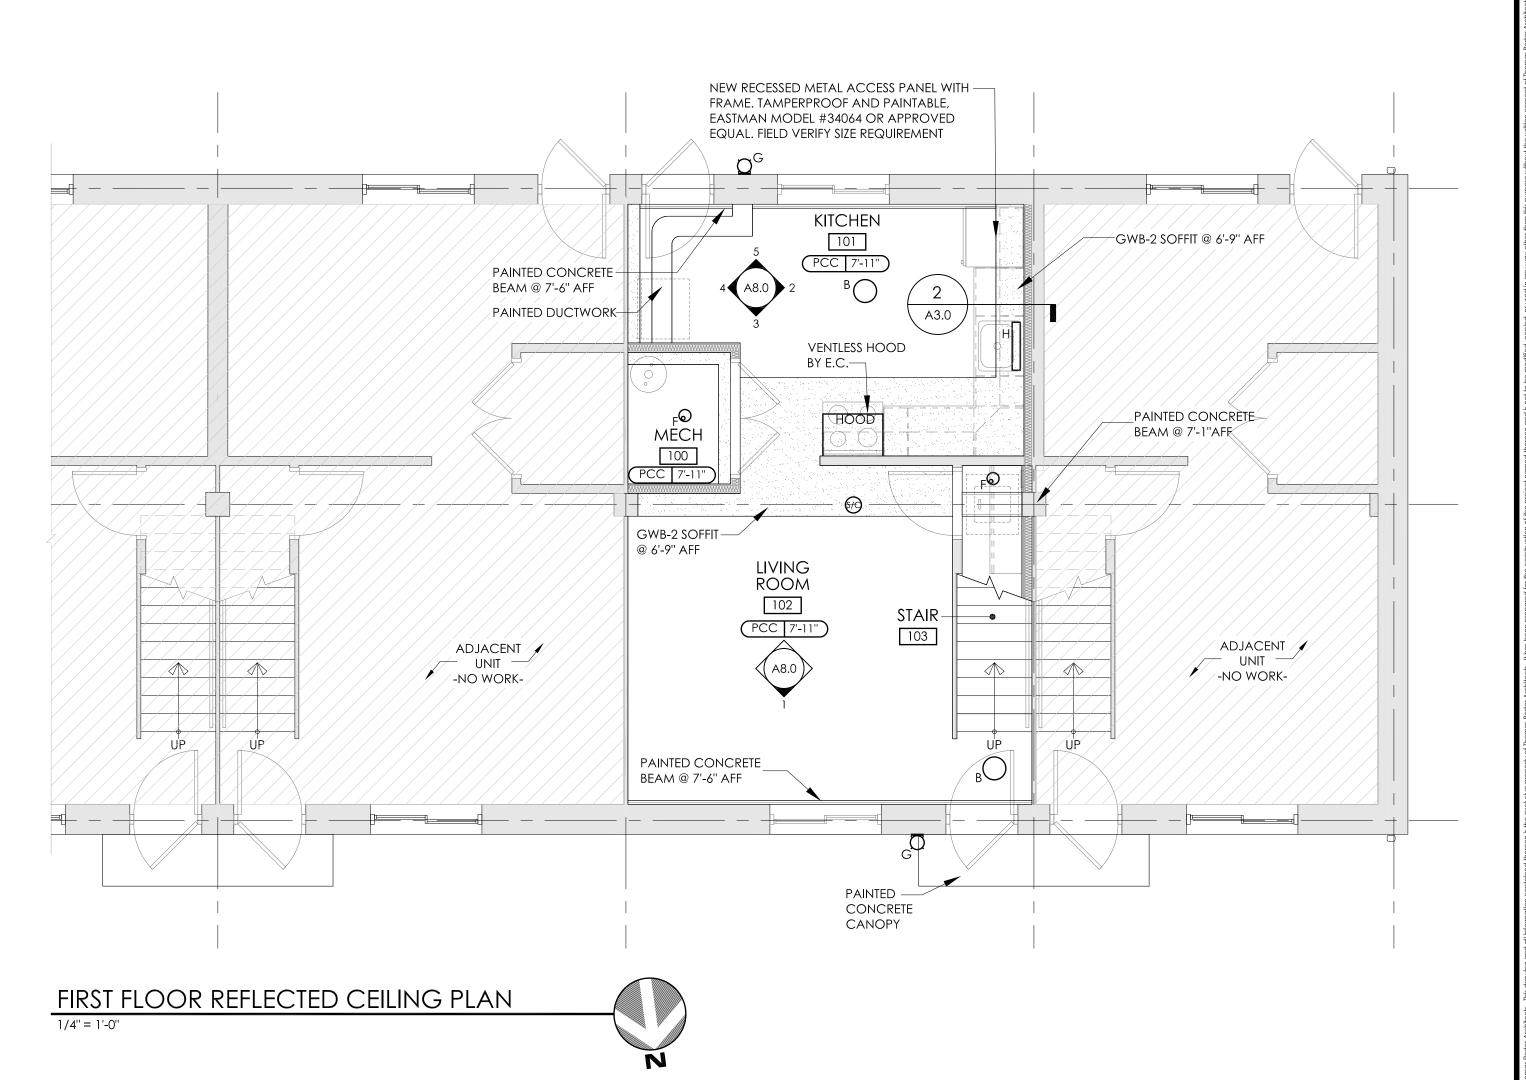1 TYPICAL CLOSET ROD & SHELF DETAIL A3.0 $\int 1'' = 1'-0''$












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ISSUE OR REVISION:


02.09.2023 ISSUE FOR PERMIT ISSUE / REVISION

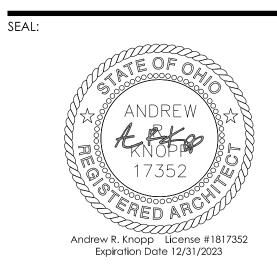DESIGNED: ACH DRAWN: EN / BLK CHECKED: ARK

TPA COMMISSION NUMBER:

DRAWING TITLE:

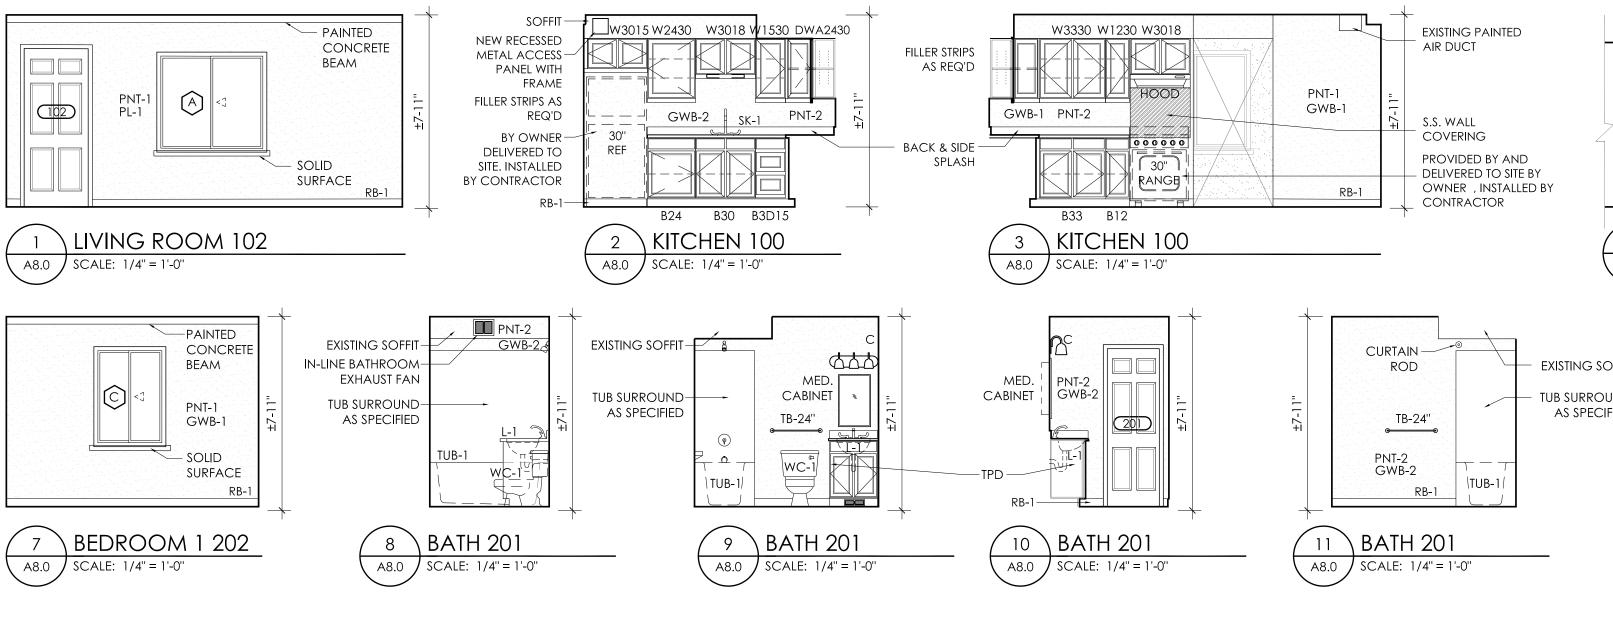REFLECTED CEILING PLANS



	ROOM FINISH SCHEDULE														
NO.). NAME F	FLR	BASE	SE WALL											REMARKS
				NOR ⁻	TH	EA	ST	SOL	SOUTH		WEST				
				MAT'L	FIN.	MAT'L	FIN.	MAT'L	FIN.	MAT'L	FIN.	MAT'L	FIN.	HGT.	
100	KITCHEN	VCT-1	RB-1	GWB-1	PNT-1	PL-1	PNT-1	PL-1	PNT-1	GWB-2	PNT-2	PCC-1 / GWB-1	PNT-1	± 7'-11"	
101	MECHANICAL	VCT-1	RB-1	GWB-2	PNT-2	PL-1	PNT-2	GWB-2	PNT-2	GWB-2	PNT-2	PCC-1 / GWB-2	PNT-2	± 7'-11"	
102	LIVING ROOM	VCT-1	RB-1	PL-1	PNT-1	PL-1	PNT-1	GWB-1	PNT-1	PL-1	PNT-1	PCC-1 / GWB-1	PNT-1	± 7'-11"	INCLUDES LAUNDRY CLOSET
103	STAIR	RB-2	RB-1	PL-1	PNT-1	PL-1	PNT-1	PL-1	PNT-1	PL-1	PNT-1	PCC-1	PNT-1	± 7'-11"	
200	HALL	VCT-1	RB-1	GWB-1	PNT-1	GWB-1	PNT-1	GWB-1	PNT-1	GWB-1	PNT-1	PCC-1	PNT-1	± 7'-11"	INCLUDES LINEN CLOSET 1
201	BATH	VCT-1	RB-1	GWB-2	PNT-2	GWB-2	PNT-2	PL-1 / GWB-2	PNT-2	GWB-2	PNT-2	PCC-1 / GWB-2	PNT-2	± 7'-11"	
202	BEDROOM 1	VCT-1	RB-1	GWB-1	PNT-1	PL-1	PNT-1	PL-1	PNT-1	GWB-1	PNT-1	PCC-1	PNT-1	± 7'-11"	INCLUDES CLOSET 1
203	BEDROOM 2	VCT-1	RB-1	PL-1	PNT-1	PL-1	PNT-1	GWB-1	PNT-1	PL-1/GWB-1	PNT-1	PCC-1	PNT-1	± 7'-11"	INCLUDES CLOSET 2

SPECIFICATION NOTES:

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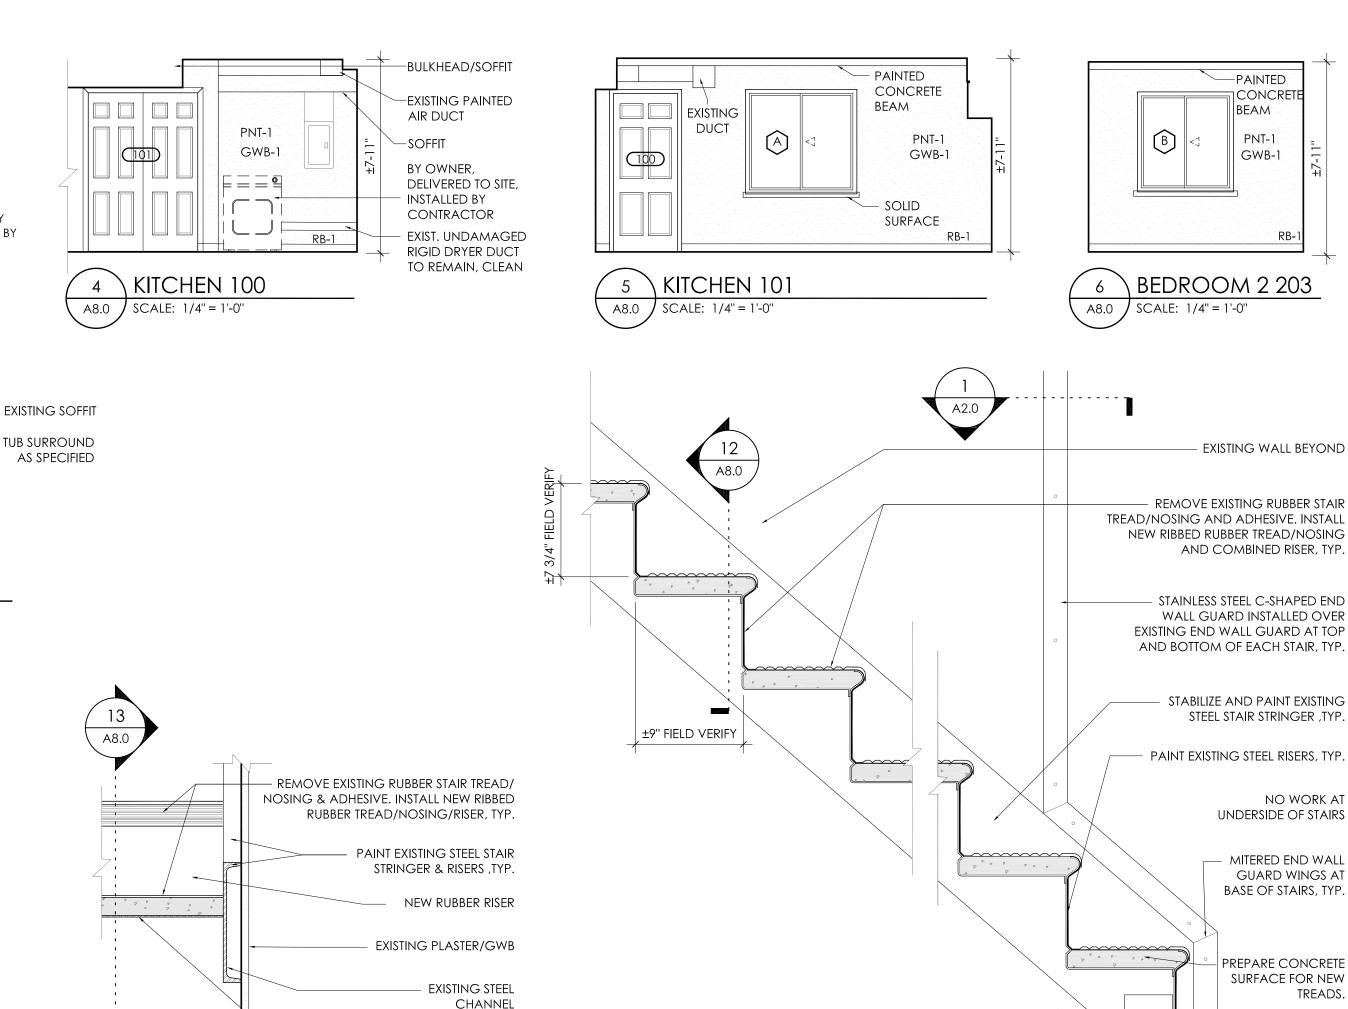
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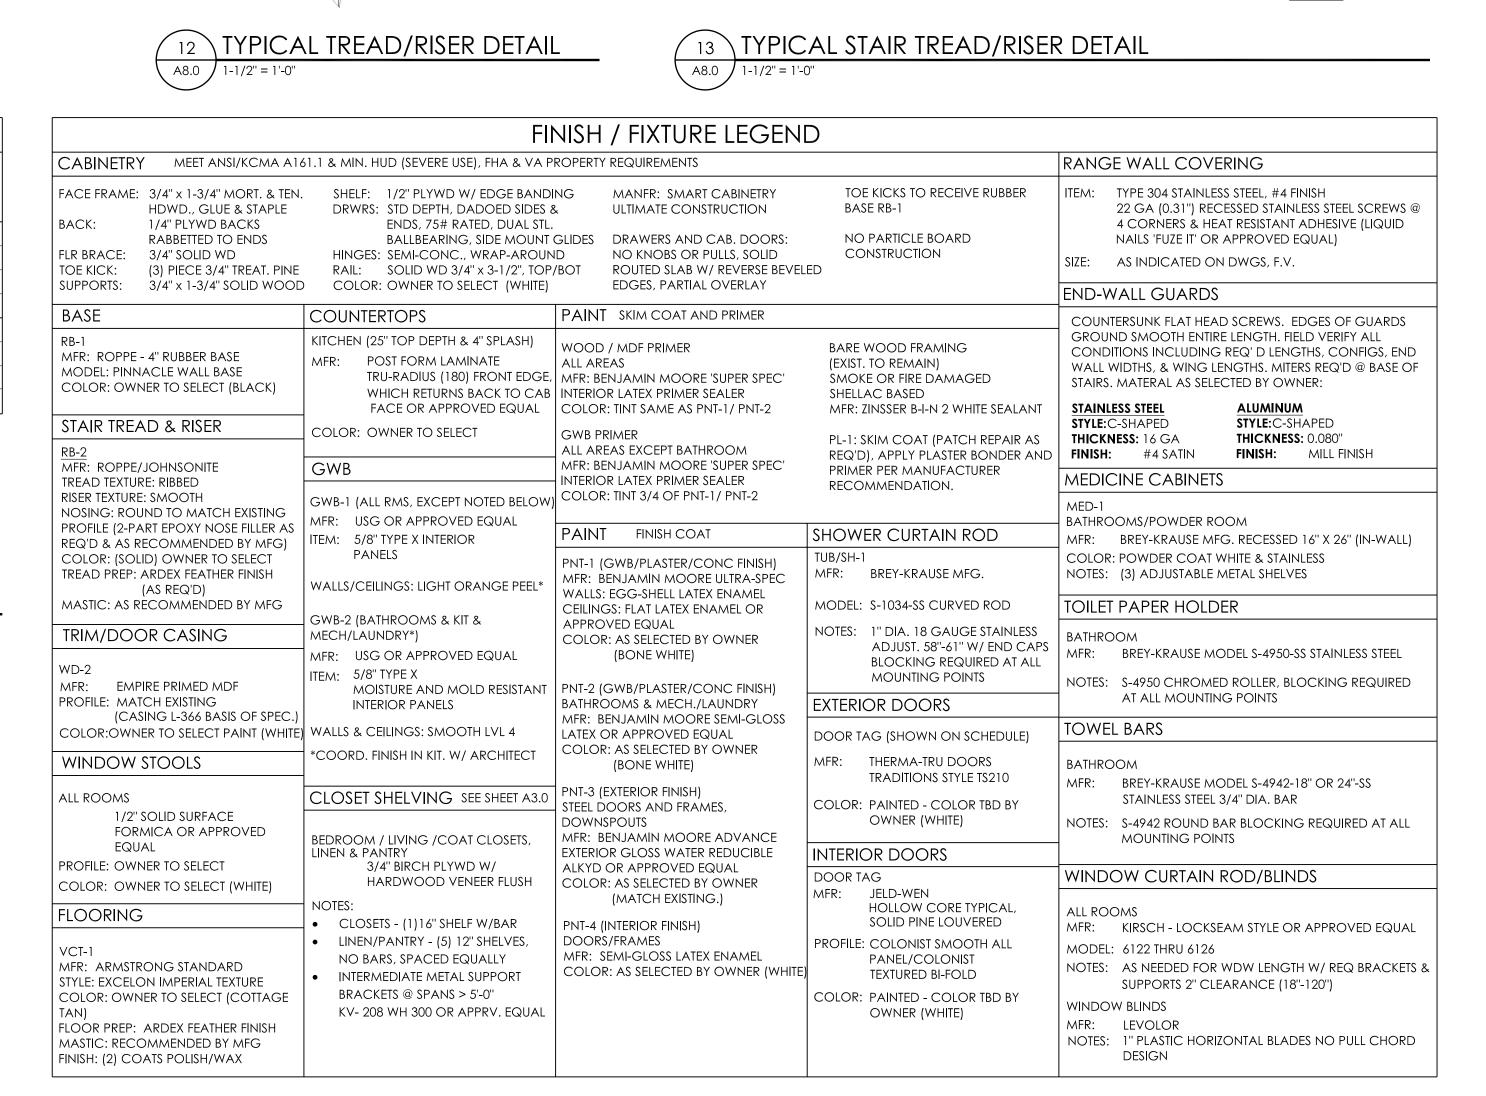
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- 1. MANUFACTURER AND CATALOG/SERIES NUMBERS SHOWN ARE A BASIS OF SPECIFICATION. ALTERNATES OR SUBSTITUTIONS MUST BE SUBMITTED TO OWNER/ARCHITECT 10 DAYS PRIOR TO BID FOR
- 2. CONTRACTOR TO VERIFY ALL PRODUCTS, STYLES, COLORS, FINISHES, ETC. THROUGH THE SUBMITTAL PROCESS PRIOR TO ORDERING ANY MATERIALS. SUBMIT 5 SETS / COPIES OF PHYSICAL SHOP DRAWINGS FOR APPROVAL PRIOR TO ORDERING ANY MATERIAL. ELECTRONIC COPIES ARE ACCEPTABLE.
- 3. Contractor to field verify all dimensions and existing conditions prior to ordering any materials.
- 4. CONTRACTOR TO INSTALL ALL FINISHES AND FIXTURES PER MANUFACTURER'S INSTRUCTIONS / SPECIFIC ATIONS
- 5. PAINT COATING REQUIREMENTS SHALL BE PER MANUF. RECOMMENDATIONS AS TO COVERAGE & QUALITY OF APPLICATION METHODS. ADDITIONAL COATINGS MAY BE REQUIRED BASED ON FIELD OBSERVATIONS AS DICATED BY OWNER OR ARCHITECT.
- 6. CABINET FINISH TO CONSIST OF STAIN, ONE COAT CATALYZED SEALER, ONE CATALYZED TOP COAT. EACH COAT TO BE OVEN DRIED AND SEALER COAT SANDED. PLYWOOD IS UV FINISHED. CABINET FINISH MAY ALSO INCLUDE A FACTORY PAINTED FINISH.
- 7. CABINETRY CORNER BLOCKS @ TOE AND CROSS MEMBERS. STAPLES USED THRU FLOOR INTO CROSS MEMBERS & THRU BACKS.
- & THRU BACKS.
 8. WHERE REPLACEMENT OF FLOORING IS REQUIRED OVER WOOD SUBFLOORS, CONTRACTOR TO INCLUDE NEW UNDERLAYMENT (1/4" PATRIOT 'SUREPLY'). FOR NEW FLOORING OVER CONCRETE SLABS, CONTRACTOR

UTILIZE 'ARDEX FEATHER FINISH' AS REQUIRED TO ELIMINATE ANY UNEVEN TRANSLATIONS THROUGH

- 9. WHERE REPLACEMENT OF FLOORING IS INDICATED, CONTRACTOR TO REMOVE AND REPLACE WALL BASE. WALL BASE SHALL BE APPLIED TO CABINET TOE-KICKS.
- 10. FOR ALL COLOR SELECTIONS, OWNER TO SELECT FROM MANUFACTURER'S FULL RANGE.
- 11. PROVIDE MIN 5%, UNOPENED PACKAGES, OF "ATTIC STOCK" MATERIAL. MATERIAL TO INCLUDE FLOORING (VCT-1), STAIR TREADS/RISERS (RB-2), (1) PASSAGE LOCKSET & (1) PRIVACY LOCKSET.





STRINGERS, TYP.

STRUCTURE


- PAINT UNDERSIDE OF STEEL



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CONSULTANTS:



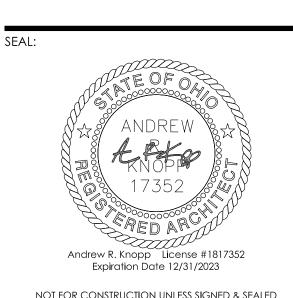

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BIRMINGHAM TERRACE UNIT REPAIRS AND RENOVATIONS

FINISH FLOOR

/±2" F.V.

DESIGNED: ACH
DRAWN: EN / BLK

DRAWN: EN / BLK
CHECKED: ARK

TPA COMMISSION NUMBER: 2202

DRAWING TITLE:

INTERIOR
ELEVATIONS &
FINISH SCHEDULE

DRAWING NUMBER:

A8.0

	DOOR SCHEDULE												
DOOR	R SIZE	DOO	DOOR / WINDOW / OPENING						DETAIL				REMARKS
NO.		MAT'L	TYPE	FIN.	GLS TYPE		MAT'L.	TYPE	JAMB	HEAD	RATING	HDW SET	
100	2'-8" x 6'-8" x 1 3/4"	НМ	PN/SD	PAINT	-	_	НМ	F-1/F-3	J2	H2	-	2	ENTRY DOOR
101	2'-4" x 6'-8" x 1 3/4" (PAIR)	SCW	PA	PAINT	-	-	НМ	F-2	J1	Н1	-	4	MECHANICAL ROOM
102	2'-8" x 6'-8" x 1 3/4"	НМ	PN/SD	PAINT	-	-	НМ	F-1/F-3	J2	H2	-	2	ENTRY DOOR
102A	2'-8" x 6'-6" x 1 3/4"	SCW	PA	PAINT	-	-	НМ	F-2	J1	Н1	-	1	CLOSET *FIELD VERIFY HIEGHT UNDER STAIR*
200	1'-6" x 6'-8" x 1 3/4"	SCW	PA	PAINT	-	_	НМ	F-2	J1	Н1	-	1	CLOSET
201	2'-4" x 6'-8" x 1 3/4"	SCW	PA	PAINT	-	-	НМ	F-2	J1	Н1	-	3	BATHROOM
202	2'-6" x 6'-8" x 1 3/4"	SCW	PA	PAINT	-	-	НМ	F-2	J1	Н1	-	1	BEDROOM
202A	2'-6" x 6'-8" x 1 3/4"	SCW	PA	PAINT	-	-	НМ	F-2	J1	Н1	-	1	CLOSET
203	2'-6" x 6'-8" x 1 3/4"	SCW	PA	PAINT	-	-	НМ	F-2	J1	Н1	-	1	BEDROOM
203A	2'-6" X 6'-8" X 1 3/4"	SCW	PA	PAINT	-	-	НМ	F-2	J1	Н1	-	1	CLOSET

DOOR / WINDOW GENERAL NOTES:

- 1. FIELD VERIFY ALL DOOR / WDW MASONRY & ROUGH OPENINGS PRIOR TO ORDERING ANY MATERIALS.
- 2. FIELD VERIFY ALL LINTELS AND HEADERS PRIOR TO INSTALLATION OF ANY NEW WORK. NOTIFY OWNER REPRESENTATIVE AND ARCHITECT/ENGINEER OF ANY DISCREPANCIES OR DEFICIENCIES.
- 3. ALL ENTRY DOOR FRAMES TO BE MIN. 16 GA STL ± 6 3/4" WIDE. ALL INT DOOR FRAME WIDTHS TO MATCH WALL THICKNESS (VARIES) OR EXCEED BY 1/2" MAX ON EITHER SIDE. ALL FRAMES PRIMED & CONTR PAINTED - OWNER TO SELECT COLOR.
- 4. THRU-DOOR VIEWERS TO BE 698 x 190 DEGREES. INCLUDE (1) PER EXTERIOR DOOR.
- ALL INTERIOR DOOR AND WINDOW CASING TO BE STOCK COLONIAL PROFILE PRIMED & PAINTED. TRIM TO BE 1x WOOD FLAT STOCK - PRIMED & PAINTED. TRIM SHALL BE HIGH QUALITY, KILN DRIED STOCK, & MILLED PER INDUSTRY STANDARDS. TRIM SHALL BE FREE OF MACHINE OR CHATTER MARKS. ALL MITERS SHALL BE BLIND NAILED WHERE POSSIBLE. ANY WORK WHICH CHECKS, CRACKS, OPENS AT JOINTS, OR WARPS SHALL BE REMOVED & REPLACED. OWNER TO SELECT COLOR. (WHITE)

HARDWARE SETS:

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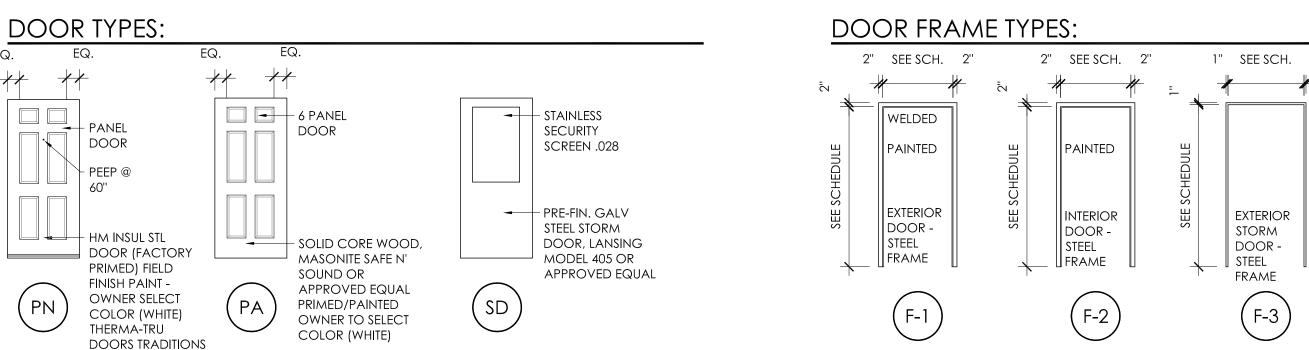
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- 1. PASSAGE LOCKSET NON-HANDED ADA LEVER DESIGN, FULLY ADJ. LATCH, LIFETIME MECH. & FINISH WARRANTY A. INTERIOR DOOR STOPS TO BE HINGE TYPE OR APPROVED EQUAL ANSI/BHMA GRADE 3, MEET 4.12.9 ADA REQ. (MIN. 3 5/8" LEVER OR APPROVED EQUAL)
- INTERCONNECTED ENTRY LOCKSET LEVER DESIGN, WITH A SMALL FORMAT REMOVABLE CORE SYSTEM KEYED to owners existing keying system ansi/bhma grade 2, meeting 4.12.9 ada req.,with life time MECHANICAL WARRANTY (MIN. 3 1/8" LEVER OR APPROVED EQUAL) W/ SWEEP, WEATHERSTRIP, THERMAL BREAK THRESHOLD, STORM DOOR, AND PEEP SIGHT.
- 3. LOCK/PRIVACY LOCKSET PIN & TUMBLER, SEE PASSAGE LOCKSET FOR STD SPECS & NOTES (OR APPROVED EQUAL)
- 4. PAIR CLOSET DOORS PULL FULL-SIZE DUMMY SET, SEE PASSAGE LOCK FOR STD SPECS & NOTES (OR APPR. EQ.) ROCKWOOD 910RC BALL CATCHES

- 6. ENTRY DOORS TO BE MIN. 25 GA. INSUL. STL. W/ 16GA. STEEL FRAMES, 6 PANEL EMBOSSED, PREMIUM SERIES W/ 10-YEAR WARRANTY & HAVE WEATHER STRIP/SEAL. ENTRY DOOR TO MEET OR EXCEED ALL CURRENT ENERGY-STAR REQ. / RATINGS. STORM DOOR TO BE STL. STORM DOOR W/ .023" STAINLESS STEEL SCREEN, COMPLETE W/ ALL HARDWARE, DOOR CLOSURE & ADJ. SWEEP, BUT W/OUT GLASS STORM PANEL. OWNER TO SELECT COLOR.
- 7. ALL EXTERIOR ENTRY DOORS TO HAVE LOW- RISE ADA THRESHOLDS. (MAXIMUM RISE OF 1/2")
- 8. WINDOWS DETAILED ARE BASED ON POLARIS ULTRAWELD 8430 SERIES (OWNER TO SELECT COLOR). ALL WDWS. ARE DBL. HUNG TYPE, W/ FULL SCREENS.(ALUMINUM SCREEN WIRE), DBL. PANE, INSULATED, LOW E W/ ARGON, TEMPERED CLEAR GLASS. ALL FRAMES TO BE ± 3 1/4" WIDE. WDWS. TO MEET OR EXCEED ALL CURRENT ENERGY-STAR REQ. / RATINGS.
- . ALL CAVITIES OF NEW EXTERIOR DOOR & WINDOW INSTALLATIONS IN EXIST. & NEW OPENINGS ARE TO BE THOROUGHLY INSUL. W/ DOOR AND WINDOW FOAM INSUL. & CAULKED W/ EXT. GRADE SILICONE SEALANT.

HARDWARE NOTES:

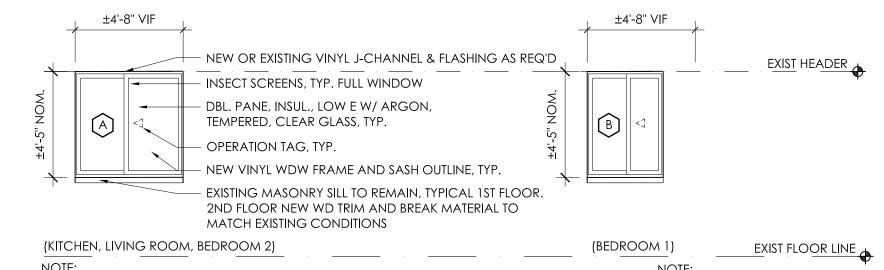
- B. OWNER TO SELECT ALL FINISHES / COLORS & APPROVE ALL MATERIALS PRIOR TO ORDERING / INSTALLATION
- C. ALL HARDWARE MUST MEET ADA AND UNIVERSAL DESIGN STANDARDS
- D. ALL EXTERIOR ENTRY DOORS TO BE KEYED TO LMHA IC CORE MASTER SYSTEM
- E. ALL HARDWARE TO INCLUDE ALL NECESSARY ACCESSORIES, STRIKES, LATCHES, ESCUTCHEONS, TRIM, ETC. (U.N.O.)
- F. ALL INTERIOR DOORS TO HAVE MIN. OF 2 PLAIN BEARING BUTT HINGES 4 1/2" X 4 1/2", FINISH AS SELECTED.
- G ALL EXTERIOR DOORS TO HAVE 3 PLAIN BEARING BUTT HINGES 4 1/2" X 4 1/2", FINISH AS SELECTED
- H. INCLUDE ADDITIONAL "ATTIC STOCK", UNOPENED, (1) PASSAGE LOCKSET AND (1) PRIVACY LOCKSET



NOTE: WINDOW FRAME/SASH/RAIL PROFILES OR EXTRUSIONS MAY DIFFER FROM DETAILS SHOWN DEPENDING ON TYPE OF WINDOW SPECIFIED. INTERIOR AND EXTERIOR SURROUNDING MATERIALS AND CONFIGURATIONS APPLY

WINDOW TYPES:


STYLE TS210





REFER TO EXTERIOR, AND INTERIOR ELEVATIONS, ROOM FINISH SCHEDULES, SECTIONS AND DETAILS FOR ADDITIONAL REQUIREMENTS. EXISTING ROUGH OPENINGS TO REMAIN. REPLACE EXISTING TRIMS DIMENSIONS AND EXISTING AS REQUIRED FOR A COMPLETE AND PROPER WINDOW REPLACEMENT SYSTEM. PATCH AND REPAIR ADJACENT SURFACES WITH MATCHING MATERIALS AS NOTED AND PER NEW SCHEDULED FINISHES.

CONTRACTOR TO FIELD VERIFY ALL CONDITIONS PRIOR TO SUBMITTING WINDOW SHOP DRAWINGS

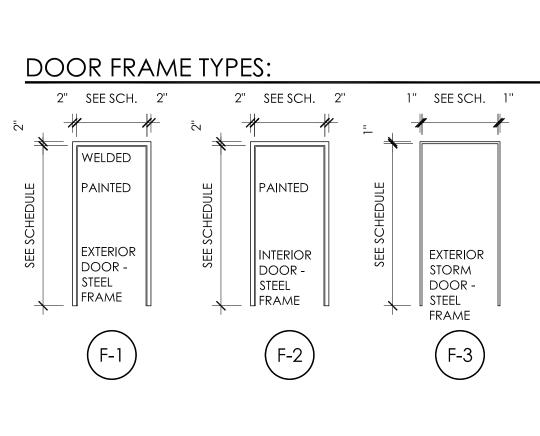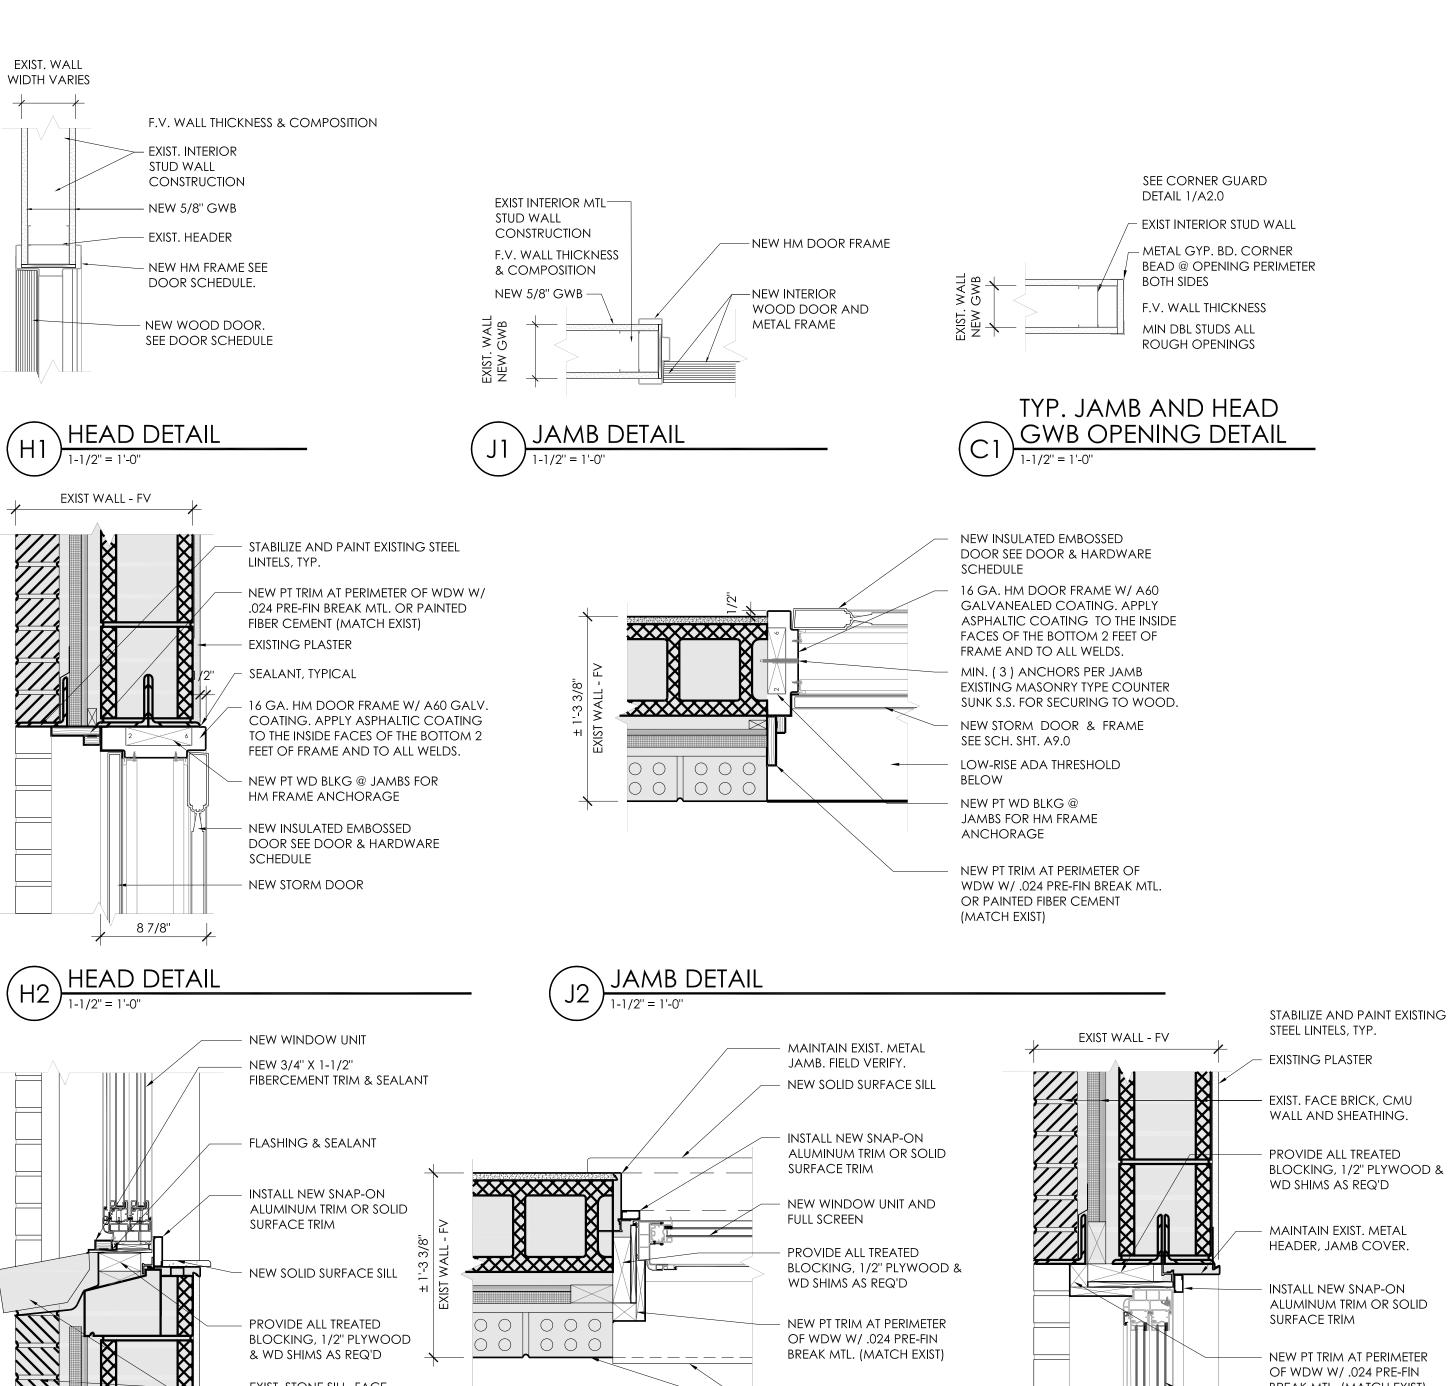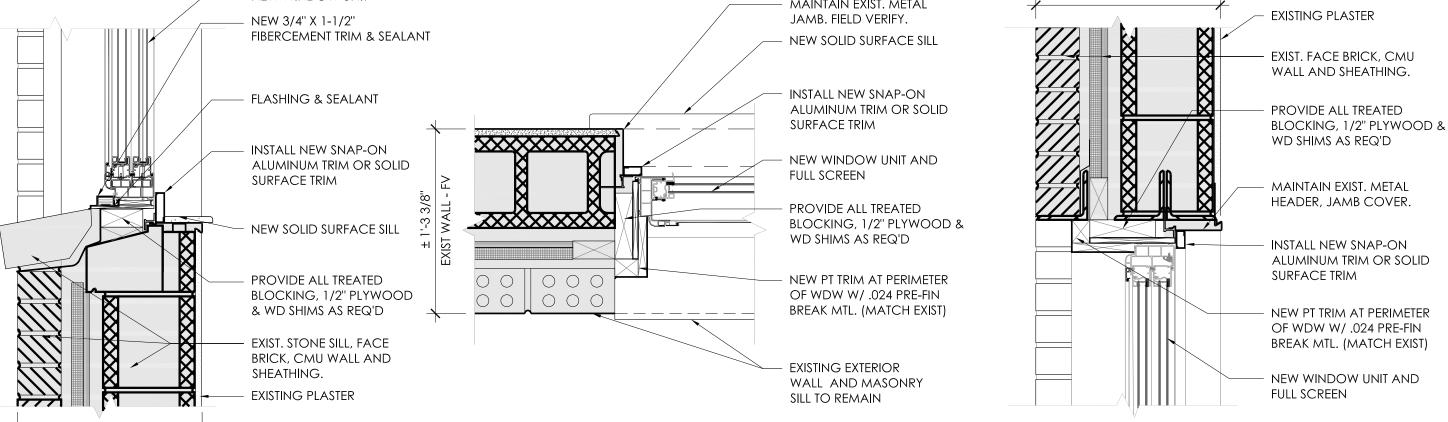REPLACEMENT WINDOWS SHALL COMPLY WITH RCO 310.2.5 REPLACEMENT WINDOWS.







INSTALL NEW SNAP-ON

SURFACE TRIM

NEW WINDOW UNIT

ALUMINUM TRIM OR SOLID

NEW SOLID SURFACE STOOL AND

WOOD APRON. EXTEND MIN.

OF 3-1/4" EACH SIDE OF JAMB

NEW PT TRIM AT PERIMETER

OF WDW W/ .024 PRE-FIN

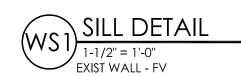
BREAK MTL. (MATCH EXIST)

EXISTING SIDING U.N.O


REPLACE WINDOW

PERIMETER TRIM AS


REQ'D



EXIST WALL - FV

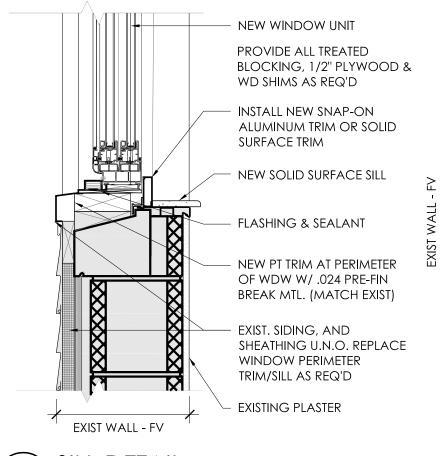



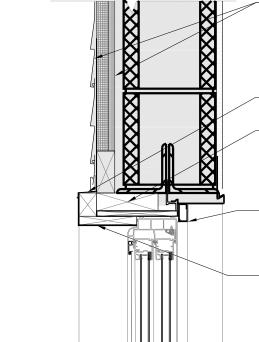

EXIST WALL - FV

HEAD DETAIL

PROVIDE ALL TREATED BLOCKING, 1/2" PLYWOOD & WD SHIMS AS REQ'D INSTALL NEW SNAP-ON ALUMINUM TRIM OR SOLID SURFACE TRIM - NEW PT TRIM AT PERIMETER OF WDW W/ .024 PRE-FIN

- EXIST. SIDING, AND

SHEATHING U.N.O. REPLACE WINDOW

PERIMETER TRIM/SILL AS

DRIP EDGE FLASHING

BREAK MTL. (MATCH EXIST) - NEW WINDOW UNIT

DOOR & WINDOW

BIRM

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ARCHITECTS

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Expiration Date 12/31/2023

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SEAL:

ISSUE / REVISION DESIGNED: ACH

DRAWN: EN / BLK

CHECKED: ARK TPA COMMISSION NUMBER:


DRAWING TITLE:

DOOR SCHEDULE,

DETAILS

	PLUMBING FIXTURE SCHEDULE											
DESCRIPTION	SYM!	B <u>OL</u>	CM	HM	WASTE	<u>VENT</u>	SPECIFICATIONS					
WATER CLOSET FLOOR SET 1.28 GPF ADA TANK TYPE		<u>MC-1</u>	1/2"		4"	2"	TWO PIECE 'COMFORT HEIGHT' ELONGATED TOILET, I.28 GPF W/PLASTIC SEAT, WHITE FINISH. POLISHED CHROME HANDLE,(LEFT OR RIGHT), WATER SENSE RATING ICC/ANSI AIIT.I COMPLIANT. KOHLER MODEL K-3519-0; SEAT MODEL K-4774.					
LAVATORY SEMI-COUNTER TOP	£	<u>L-l</u>	1/2"	1/2"	l I/2"	l I/2"	ONE PIECE VANITY TOP 22-1/2" X 31" W/ BACK & SIDE SPLASH. LAVATORY TOP W/INTEGRAL BOWL, HEAT. CHEMICAL & STAIN RESISTANT. SWANSTONE MODEL CHIB2225. FINISH AS SELECTED BY OWNER. CENTERSET SINK FAUCET; SINGLE HANDLE 4" CENTERS, I.2 GPM FLOW RATE. POLISH CHROME FINISH WITH POP-UP DRAIN. WOLVERINE BRASS MODEL 85250. AREATOR: NIAGARA MODEL N3210N-PC NON TAMPER RESISTANT					
SINK STAINLESS STEEL DOUBLE BOWL	0	<u>5K-l</u>	1/2"	1/2"	I-I/2"	I-I/2"	21-1/2"D X 25'W TOP MOUNT, I BOWL 6-9-1/16"" DEEP, HEAVY GAUGE SS SOLID BRASS STRAINER DELUXE DUO MACHINE THREADS, BRASS LOCK AND COUPLING, STAINLESS BASKET AND STOPPERS. SELF RIM STAINLESS STEEL, ROUNDED CORNERS, SEAMLESS, 3 HOLE PUNCH WI STRAINER AND STOPPER, DAYTON/ELKAY MODEL D-23322. FAUCET; WSINGLE HANDLE. 8-1/2" SWING REACH, I.5 GPM FLOW RATE WO SIDE SPRAY. POLISH CHROME FINISH, WOLVERINE BRASS 85050. AREATOR: NIAGARA MODEL N3104PC.					
SOAKING TUB ADA		TVB-I	1/2"	1/2"	2"	I-I/2"	(3) PIECE 30" X 60" TUB/SHOWER UNIT. AMERICAN STANDARD MODEL 6030SW WALL SURROUND. TUB; AMERICAN STANDARD MODEL 2391202. SINGLE LEVER BATH AND SHOWER VALVE TRIM KIT, CHROME FINSIH, MOEN MODEL L2363. SHOWER HEAD, CHROME FINISH, I.5 GPM, NON-AERATING, LOWFLOW, 9 JET SPRAY MASSAGER; NIAGARA MODEL N2915CH.					
HOSE BIBB	+	<u>HB-I</u>	3/4"				EXISTING					
FLOOR CLEANOUT	0	<u>FCO</u>			SEE DWGS		EXISTING					
CLEANOUT TO GRADE	0	<u>COTG</u>			SEE DWGS		ZURN #Z-1406-HD-VP, EXTERIOR CLEANOUT, HEAVY DUTY WITH VANDAL PROOF SCREWED TOP.					
FLOOR DRAIN	•	FD-l			3"		EXISTING					
WASHER BOX PIP2	0	CMDB-I	1/2"	1/2"	2"	I-I/2"	GUY GRAY MFG. CO MODEL #BB200TS. FOR WASHING MACHINE WATER SUPPLY AND DRAIN					

WATER HEATER SCHEDULE											
SYMBOL	MANUFACTURER	MODEL	BTV/HR		RECOVERY GPH @ 90°F	WATER CONNECTION	DIMENSIONS	WATTS	VOLTS	ELECTRICAL	REMARKS
GMH-I	RWD	PROU 638-40N	40,000	40	40.5	3/4" <i>CO</i> LD 3/4" HOT	57-3/4" TALL 19-3/4" DIA.		120		PROVIDE POWER DAMPER AND VENT UP THROUGH ROOF.

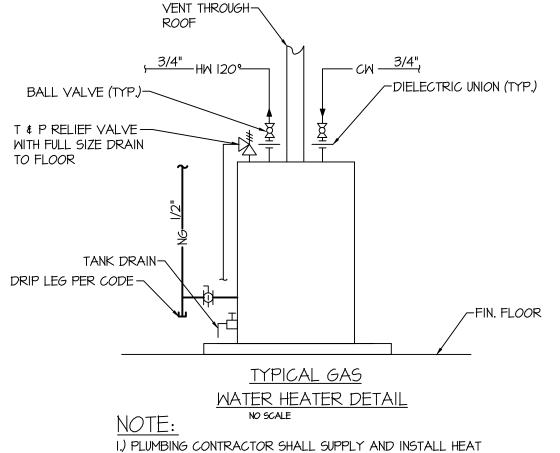

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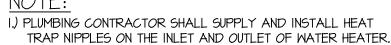
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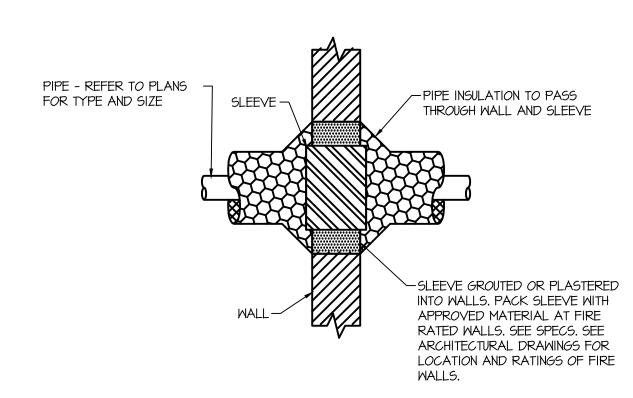
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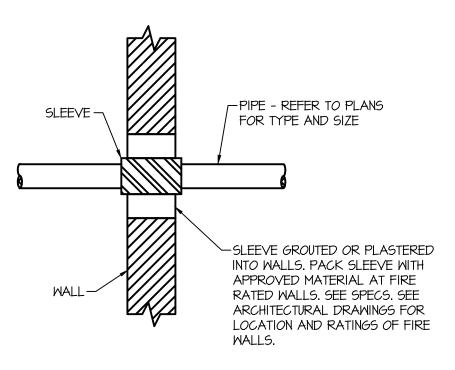
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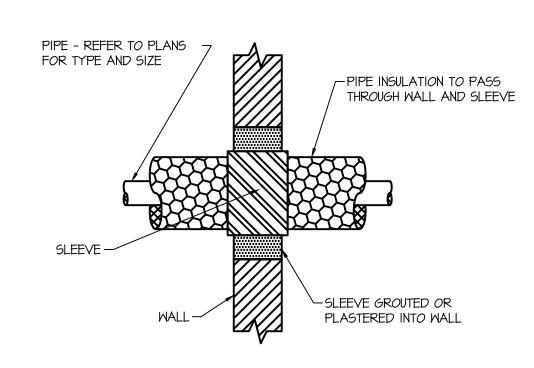




INSULATED PIPE THRU FIRE WALL DETAIL



PIPE THRU FIRE WALL DETAIL



INSULATED PIPE THRU WALL DETAIL

GENERAL PLUMBING NOTES:

- I.) ALL DOMESTIC WATER VALVES TO BE BALL TYPE UNLESS NOTED OTHERWISE. 2.) CONTRACTOR TO INSTALL A SIZE "A" WATER HAMMER ARRESTOR AND A FULL SIZE
- 3.) CONTRACTOR TO FIELD COORDINATE PLUMBING UTILITIES TO MISS ALL EXISTING AND NEW PIPING, ELECTRICAL AND HVAC.
- 4.) SANITARY PIPING 2 1/2 INCHES AND BELOW TO MAINTAIN 1/4 IN/FT SLOPE. ALL OTHER

ISOLATION BALL VALVES AS REQUIRED PER PLUMBING CODE.

- SANITARY PIPING TO MAINTAIN A MINIMUM 1/8 IN/FT SLOPE. 5.) PRIOR TO INSTALLATION, CONTRACTOR TO FIELD VERIFY EXISTING TIE IN LOCATIONS AND
- SERVICE SIZES. UTILITIES INCLUDE: SANITARY, DOMESTIC COLD WATER, DOMESTIC HOT WATER, AND DOMESTIC HOT WATER RETURN.
- 6.) CONTRACTOR TO INSULATE ALL DOMESTIC HOT WATER MAINS WITH I/2" THICK INSULATION. 7.) ALL FINAL CONNECTIONS AND PLUMBING ROUGH-INS TO BE PERFORMED BY PLUMBING
- CONTRACTOR IN FIELD.
- 8.) DOMESTIC WATER, SANITARY AND VENT PIPING SHALL BE TESTED PER THE PLUMBING CODE. 9.) DOMESTIC WATER PIPING SHALL BE CLEANED AND FLUSHED PER PLUMBING CODE.
- IO.) WATER HAMMER ARRESTOR SHALL BE MANUFACTURED BY "PRECISION DX-TRU-68 PLUMBING PRODUCTS, INC". SIZE & LOCATION TO CORRESPOND WITH PLUMBING & DRAINAGE INSTITUTE STANDARD PVI-WH201 & ASSE #1010 STANDARD.
- II.) PROVIDE AND INSTALL POWERS TEMPERING VALVE ASSE 1070 AT ALL LAVATORIES, AND HAND SINKS.
- 12.) PLUMBING PIPING, MATERIALS, TESTING OF PIPE, PIPE CLEANING, DISINFECTING AND PIPE SUPPORTING SHALL BE PER THE OHIO PLUMBING CODE.
- 13.) NATURAL GAS PIPING SHALL BE BLACK STEEL SCH. 40, MALLEABLE IRON THREADED FITTINGS, AND THREADED JOINTS. SIZING IS BASED UPON 1/4 PSI DELIVERY PRESSURE. PREP FACTORY FINISH AND PAINT ALL EXPOSED NAT. GAS PIPES OUTSIDE OF MECHANICAL
- 14.) PROVIDE AND INSTALL FROST PROOF HOSE BIBB, WITH VACUUM BREAKER, STANDARD MALE HOSE THREADS, ZURN MODEL ZI345 WHERE SHOWN ON DRAWINGS.

PLUMBING PLAN KEY NOTES:

- P) PROVIDE NEW PLUMBING FIXTURE AND NEW PIPING TO RECONNECT INTO EXISTING PLUMBING LOCATED AT WALL AND/OR FLOOR. PROVIDE NEW WATER STOPS ON ALL FIXTURES. DO NOT REUSE ANY EXPOSED PIPING THAT IS NOT CONCEALED WITHIN WALLS, FLOORS AND/OR CEILINGS.
- REPLACE EXISTING PIPING BACK TO MAIN FOR THIS FIXTURE OR EQUIPMENT WHERE FIRE DAMAGE WAS SEVERE.
- PROVIDE NEW MECHANICAL EQUIPMENT AND NEW PIPING TO RECONNECT INTO EXISTING PLUMBING LOCATED AT WALL, FLOOR AND/OR CEILING. PROVIDE NEW ISOLATION VALVES FOR ALL EQUIPMENT. DO NOT REUSE ANY EXPOSED PIPING THAT IS NOT CONCEALED WITHIN WALLS, FLOORS AND/OR
- PROVIDE NEW DOMESTIC CITY WATER METER SETTING AND ISOLATION VALVES.
- PROVIDE PLUMBING PIPING TO NEW EQUIPMENT PROVIDED BY OTHERS AND RECONNECT INTO EXISTING PLUMBING LOCATED AT WALL, FLOOR AND/OR CEILING. PROVIDE NEW ISOLATION VALVES FOR ALL EQUIPMENT. DO NOT REUSE ANY EXPOSED PIPING THAT IS NOT CONCEALED WITHIN WALLS, FLOORS, CRAWLS AND/OR CEILINGS.


SAN	- SANITARY PIPING (ABOVE GROUND)
SAN	- SANITARY PIPING (UNDER GROUND)
	HOT WATER PIPING (ABOVE GROUND)
	- COLD WATER PIPING (ABOVE GROUN
	HOT WATER PIPING (UNDER GROUND)
CM	- COLD WATER PIPING (UNDER GROUND
NG	- NATURAL GAS (ABOVE GROUND)
NG	- NATURAL GAS (UNDER GROUND)
HMR	- HOT WATER RECIR (ABOVE GROUND)
v	- VENT PIPING
D	SIZE REDUCER
rod þá	BALL VALVE
ď	BALL VALVE IN VERTICAL
2	CHECK VALVE
\bowtie	GATE VALVE
FD	FLOOR DRAIN
VTR	VENT THROUGH ROOF
A NC	NEW CONNECTION
NOTE ALL LIGHT L	NEW CONNECTION INE WORK INDICATES EXISTING.



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SCHEDULES AND DETAILS


DRAWING NUMBER:

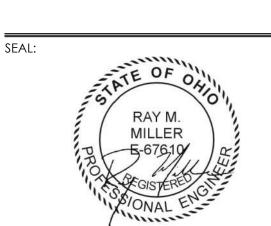DRAWING TITLE:

PLUMBING

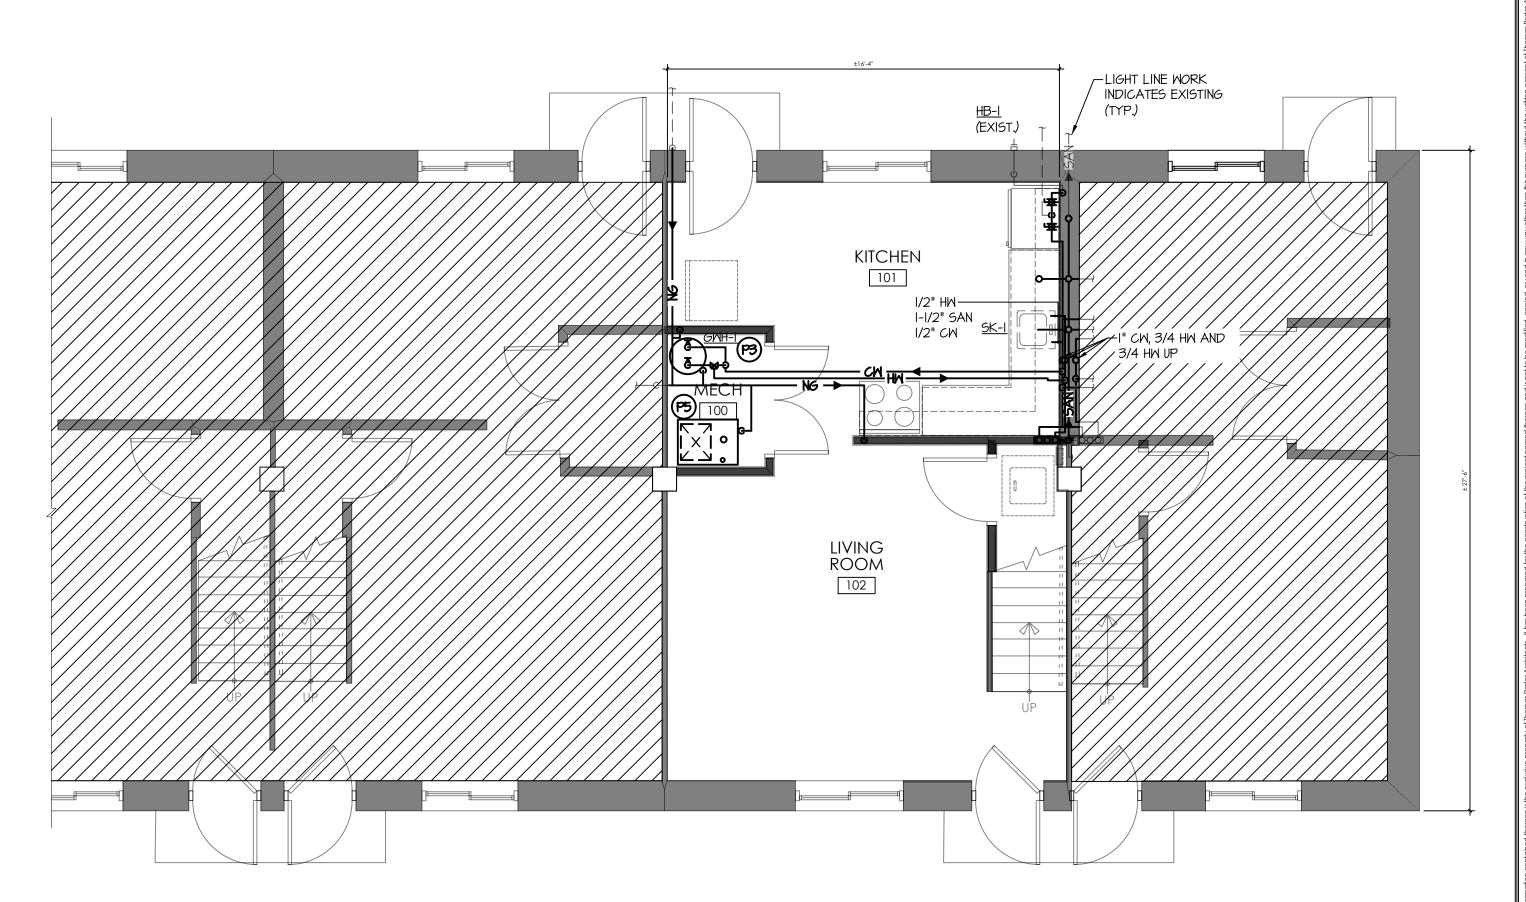BEDROOM 1 I" CM, 3/4 HM AND 3/4 HM DOWN. ROUTED IN WALL TO 2ND FLOOR FIXTURES. 203 HALL 201 BEDROOM 2










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CHECKED: VDG

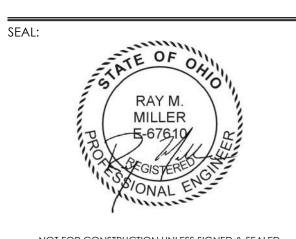TPA COMMISSION NUMBER: 22022

DRAWING TITLE:

PLUMBING FLOOR PLANS

GENERAL HVAC SPECIFICATIONS:

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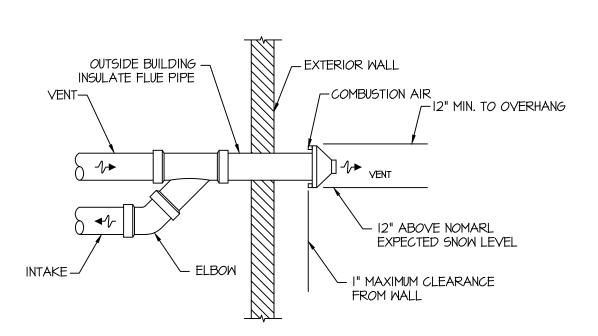
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- A. CONTRACT DRAWINGS: IN GENERAL DRAWINGS ARE SCHEMATIC IN NATURE AND SHOW DESIGN INTENT TO MEET MECHANICAL BUILDING CODES, BUT DO NOT NECESSARILY SHOW ALL DETAILS, OFFSETS, ETC. ALL DRAWINGS ARE TO BE THOROUGHLY INSPECTED. THE CONTRACTORS WORK SHALL CONFORM TO THE INFORMATION CONTAINED IN THIS SPECIFICATION AND/OR AS INDICATED IN THE LATEST REVISION OF THE DRAWINGS REFERRED TO THEREIN. THE CONTRACTOR SHALL CONSULT WITH THE ENGINEER REGARDING ALL QUESTIONS ON WHICH HE MAY BE IN DOUBT BEFORE PROCEEDING WITH FABRICATION OF PARTS AFFECTED. THE CONTRACTOR SHALL PREPARE ALL ADDITIONAL DETAIL OR FIELD INSTALLATION DRAWINGS NECESSARY AT HIS OWN EXPENSE. THE CONTRACTOR SHALL VERIFY ALL DIMENSIONS AND CONDITIONS INDICATED ON THE ENGINEER'S LAYOUT DRAWINGS AND DETERMINE IF ANY CHANGES ARE REQUIRED IN CONDUITS, PIPING RUNS, DRAINS, ETC. TO AVOID INTERFERENCE. MAJOR CHANGES SHALL NOT BE MADE WITHOUT THE APPROVAL OF THE ENGINEER. WHILE THE DRAWINGS ARE TO BE ADHERED TO AS CLOSELY AS POSSIBLE, THE CONTRACTOR HAS THE RIGHT TO VARY THE RUN OF CONDUITS, PIPING AND/OR DUCTS DURING PROGRESS OF THE WORK AS MAY BE FOUND NECESSARY OR DESIRABLE TO AVOID INTERFERENCES. MAJOR REVISIONS SHALL BE VERIFIED AND APPROVED BY THE ENGINEER.
- VERIFICATION: BEFORE RUNNING ANY CONDUITS, DUCT, PIPING, ETC. WITHIN THE BUILDING, THIS CONTRACTOR SHALL BE ASSURED THAT THEY CAN BE INSTALLED AS CONTEMPLATED WITHOUT TRAPPING OR INTERFERING WITH COLUMNS, BEAMS, FIXTURES, ETC. ANY NECESSARY MAJOR DEVIATION SHALL BE REFERRED TO THE ENGINEER FOR ADJUSTMENT BEFORE LINES ARE RUN, AT NO INCREASE IN CONTRACT PRICE. OF NECESSITY, OPENINGS, SUPPORTING STEEL, FIELD BUILT CURBS; ELECTRICAL DATA, SPACE REQUIREMENTS, ETC. WERE DESIGNED AROUND SPECIFIC PARAMETERS, WHEN THE CONTRACTOR DETERMINES THE MAKE OF EQUIPMENT TO BE PROVIDED FOR THE JOB, IT SHALL BE HIS RESPONSIBILITY TO VERIFY AND COORDINATE UNIT DIMENSIONS WITH GENERAL CONTRACTOR AND ALL OTHER INTERESTED CONTRACTORS ON THE JOB. IT SHALL ALSO BECOME THE CONTRACTOR'S RESPONSIBILITY TO CHANGE AS NECESSARY, THROUGH THE ENGINEER; ALL REQUIRED DIMENSIONS 50 THAT OPENINGS, SUPPORTING STEEL, CURBS, ELECTRICAL DATA, ETC. WILL FIT THE EQUIPMENT SUPPLIED. ANY ADDITIONAL COST WILL BE THE SOLE RESPONSIBILITY OF THIS CONTRACTOR. IN ADDITION, ELECTRICAL POWER, INTERLOCK, AND CONTROL DIAGRAMS AND PIPING ARRANGEMENTS WERE DESIGNED AROUND ONE SPECIFIC MANUFACTURER. IF ADDITIONAL WIRING, PIPING CONTROLS, ETC. ARE REQUIRED FOR OTHER EQUIPMENT, THIS CONTRACTOR SHALL INCLUDE THE COST OF THE SAME IN HIS PRICE. DIMENSIONS, ELEVATIONS AND RELATIVE LOCATIONS OF EXISTING EQUIPMENT, SEWERS, PIPES, DUCTS, CONDUITS, ETC. IN PLACES AS SHOWN ON THE DRAWINGS, ARE TAKEN FROM AS-BUILT AND RECORD DRAWINGS AND ARE DEEMED RELIABLE ONLY INSOFAR AS GENERAL LAYOUT IS CONCERNED. SUCH DIMENSIONS SHALL NOT BE USED FOR LAYOUT DRAWINGS NOR DETAILING OF COMPONENTS. THE RESPONSIBILITY FOR CHECKING IN PLACE ITEMS WILL BE THE CONTRACTORS, ALL MEASUREMENTS, THE EXACT DETERMINATION OF RELATIVE ELEVATIONS OR LOCATIONS, THE ASCERTAINING OF ACCURACY OF ALL GIVEN ELEVATIONS AND DIMENSIONS SHALL BE THE RESPONSIBILITY OF THE CONTRACTOR.
- C. GUARANTEE: THE CONTRACTOR GUARANTEES BY HIS ACCEPTANCE OF THE CONTRACT THAT ALL WORK WILL BE FREE FROM DEFECTS IN WORKMANSHIP AND/OR MATERIALS AND THAT ALL APPARATUS WILL DEVELOP CAPACITIES AND CHARACTERISTICS SPECIFIED. SHOULD ANY DEFECTS IN WORKMANSHIP, AND/OR MATERIAL REQUIRE REDESIGN OF ANY PART OF THE ELECTRICAL, MECHANICAL, HVAC, OR ARCHITECTURAL LAYOUT, ALL SUCH REDESIGN AND ALL NEW DRAWINGS AND DETAILING REQUIRED THERE OF SHALL, WITH THE APPROVAL OF THE ARCHITECT, BE PREPARED AT THE CONTRACTORS OWN EXPENSE. WHERE SUCH APPROVED DEVIATION REQUIRES A DIFFERENT QUANTITY AND ARRANGEMENT OF DUCTWORK, PIPING, WIRING, CONDUIT AND/OR EQUIPMENT FROM THAT SPECIFIED OR DETAILED ON THE DRAWINGS, WITH THE APPROVAL OF THE ARCHITECT, THE CONTRACTOR SHALL FURNISH AND INSTALL ALL SUCH MATERIALS AND/OR EQUIPMENT REQUIRED BY THE SYSTEM AT NO ADDITIONAL COST TO THE OWNER.
- D. SUBMITTALS: AFTER RECEIVING APPROVAL OF EQUIPMENT MANUFACTURERS AND PRIOR TO DELIVERY OF ANY MATERIAL TO THE JOB SITE AND SUFFICIENTLY IN ADVANCE OF THE REQUIREMENTS TO ALLOW THE ARCHITECT AMPLE TIME FOR CHECKING, SUBMIT FOR REVIEW DETAILED DIMENSIONED DRAWINGS AND/OR EQUIPMENT CUT SHEETS SHOWING CONSTRUCTION SIZE, ARRANGEMENT, OPERATING CLEARANCES, PERFORMANCE CHARACTERISTICS AND CAPACITY OF MATERIAL AND EQUIPMENT. SHOP DRAWINGS SHALL SHOW THE RATINGS OF ITEMS AND SYSTEMS AND HOW THE COMPONENTS OF AN ITEM AND SYSTEM ARE ASSEMBLED, FUNCTION TOGETHER AND HOW THEY WILL BE INSTALLED ON A PROJECT. DATA AND SHOP DRAWINGS FOR COMPONENT PARTS ON AN ITEM OR SYSTEM SHALL BE COORDINATED AND SUBMITTED AS UNIT. IT IS THE INTENT OF THESE CONTRACT DRAWINGS TO HAVE THE MECHANICAL CONTRACTOR PREPARES "AS-BUILT" RECORD DRAWINGS IN ACCORDANCE WITH THESE CONTRACT DOCUMENTS.
- E. NEW WORK: UNLESS OTHERWISE NOTED, ALL WORK INDICATED THROUGHOUT THESE DRAWINGS SHALL BE CONSIDERED TO BE NEW WORK AND SHALL BE INCLUDED AS AN INTEGRAL PART OF THIS CONTRACT.
- F. TEMPERATURE CONTROL WIRING: MECHANICAL CONTRACTOR SHALL BE RESPONSIBLE FOR ALL TEMPERATURE CONTROL WIRING REQUIRED FOR THE PROJECT. SYSTEM REQUIREMENTS.
- G. DUCTWORK CONSTRUCTION: ALL DUCTWORK SHALL BE CONSTRUCTED FOR THE STATIC PRESSURE CLASSIFICATION INDICATED IN THIS SPECIFICATION FURNISH TURNING VANES IN ALL SUPPLY AIR RECTANGULAR DUCTWORK ELBOWS AND T-SPLITS (REFER TO APPROPRIATE DETAIL FOR ADDITIONAL REQUIREMENTS). THE GENERAL ROUTING IN CEILING VOID SPACE SHALL BE DETERMINED BY THE JOB SITE CONDITIONS AND SHALL BE COORDINATED WITH ALL OTHER CONSTRUCTION TRADES. ALL DUCT SIZES ARE GIVEN IN INTERNAL CLEARANCES. DUCT LOCATED IN UNCONDITIONED SPACE TO CONSIST OF I" INSULATION. DUCTWORK TO BE CONSIDERED AS LOW PRESSURE CLASS GALVANIZED SHEET METAL DUCT WITH MAXIMUM I/2"w.g. STATIC PRESSURE CLASS AND SEAL CLASS C. INTERIOR EXPOSED DUCT TO HAVE FINISH TRIM COLLAR. DUCT LOCATED OUTSIDE TO BE WRAPPED WITH WEATHER PROOF INSULATION. CONTRACTOR TO CONNECT DUCT TO COOLING/HEATING UNIT WITH FLEXIBLE NEOPRENE DUCT CONNECTORS TO MINIMIZE DUCT VIBRATION AND NOISE. CONTRACTOR TO INSTALL A CONTROL DAMPER IN SUPPLY & RETURN BRANCH DUCT PRIOR TO EACH AND EVERY ROOM TERMINAL FOR AIR BALANCING, CONTRACTOR TO SEAL ALL DUCT PENETRATIONS THROUGH ROOF AND EXTERIOR WALLS. PROVIDE PROPER FLASHING, SLEEVES AND WEATHER PROOFING INCLUDING BIRD SCREENS AND RAIN CAPS. ALL ROOF CURBS TO BE PROPERLY INSTALLED AND SIZED FOR THE EQUIPMENT INTENDED. PROVIDE FLASHING AND WEATHER PROOFING AT CURB. ALL DUCTWORK TO BE INSTALLED AND CONSTRUCTED PER SMACNA STANDARDS.
- H. AIR DEVICE LOCATION: THE MECHANICAL CONTRACTOR SHALL REFER TO THE ARCHITECTURAL CEILING PLAN AND THE ELECTRICAL LIGHTING PLAN FOR ALL AIR DEVICE LOCATIONS. THE LOCATIONS INDICATED ON THE HVAC FLOOR PLAN ARE INTENDED FOR GENERAL POSITIONING PURPOSES ONLY.
- I. MECHANICAL COORDINATION DRAWINGS: THE MECHANICAL CONTRACTOR SHALL PROVIDE COMPLETE AND DETAILED MECHANICAL SYSTEM COORDINATION DRAWINGS WHICH SHALL BE SUBMITTED AND APPROVED BY THE ENGINEER BEFORE ANY MATERIALS OR EQUIPMENT ARE INSTALLED BY THE CONTRACTOR. (NOT APPLICABLE)
- J. PENETRATIONS: CONTRACTOR TO SEAL ALL DUCT PENETRATIONS THROUGH ROOF AND EXTERIOR WALLS PROVIDE PROPER FLASHING, SLEEVES AND WEATHER PROOFING INCLUDING BIRD SCREENS AND RAIN CAPS. ALL FRESH AIR INTAKE OPENINGS TO BE LOCATED A MINIMUM OF 10' HORIZONTAL OR 2' BELOW ANY HAZARDOUS OR NOXIOUS CONTAMINATES, SUCH AS COMBUSTION VENTS, CHIMNEYS, AND HVAC VENTS. CONTRACTOR TO PITCH ALL VENT/INTAKE PIPING AND CONDENSATE PIPING ACCORDING TO MANUFACTURES SPECIFICATIONS FOR ALL FURNACES AND CONDENSER UNITS.
- K. EQUIPMENT CURBS AND PADS: ALL ROOF CURBS TO BE PROPERLY INSTALLED AND SIZED FOR THE EQUIPMENT INTENDED. PROVIDE FLASHING AND WEATHER PROOFING AT CURB.
- L. AIR BALANCE: CONTRACTOR TO AIR BALANCE HVAC SYSTEM FOR PROPER AIR DISTRIBUTION AT EACH ROOM TERMINAL

LOW PRESSURE SUPPLY DUCT ALL ROUND DUCT FITTINGS SHALL BE THIS TYPE. VOLUME DAMPER NOT REQUIRED FOR PRIMARY BRANCHES TO FVAV BOXES.
--

LOW PRESSURE SPININ FITTINGS DETAIL
NOT TO SCALE



2 TYPICAL CONCENTRIC VENT DETAILS

	SYMBOL SCHEDULE							
SYMBOL	DESCRIPTION							
	CEILING SUPPLY AIR REGISTER							
<u></u>	RETURN GRILLE							
—D	EXHAUST FAN							
٦	AIR VOLUME CONTROL DAMPER							
T	7-DAY PROGRAMMABLE THERMOSTAT WITH NIGHT SET BACK (MH=48" TO TOP)							
[- \	UNIT HEATER							
F▲	FIRE DAMPER, I HR. RATED IN HORIZONTAL DUCT							
F∳	FIRE DAMPER, I HR. RATED IN VERTICAL DUCT							

	HEATING AND COOLING UNIT SCHEDULE													
TAG DESCRIPTION MANUF. MODEL NO. POWER / MCA TONNAGE COIL SEER BTU INPUT BTU OUTPUT AFUE% SUPPLY CFM S.P. O.A. CFM REMAI										REMARKS				
FU-I (BASE BID)	DOWNFLOW FURNACE	RHEEM	CLASSIC PLUS SERIES	115/I 12A				56,000	54,000	95%	700	1/2"		1,2,4,5,6
FU-I (ALT)	DOWNFLOW FURNACE	RHEEM	CLASSIC PLUS SERIES	115/I 12A				75,000	61,000	80%	700	1/2"		1,3,4,5,6
· · · · · · · · · · · · · · · · · · ·	E EQUIPPED WITH DISCONNE (ENERGY STAR COMPLIAN ALTERNATE				5.)	OUTSIDE !	AIR IS P		' NATURAL VE		ION. OOR DRAIN. F	PROVIDE 1/2	." AIR GAP C	ONNECTION.

EXHAUST FAN SCHEDULE										
TAG	MANUFACTURE	MODEL NO.	POWER	CFM	5.P.	FRPM	REMARKS			
EF-I	F-I PANOSONIC FV-08WQI 120V / 0.2A 70 1/4"				660	I, 2, 3				
<u>EMARKS</u> Vent through	H SIDEWALL WITH WEATHER CAP &	BIRD SCREEN	2) INTER	RLOCK WITH RE	STROOM LIGH	IT SWITCH	3.) SIDEWALL MOUNT			

					D	IFFL	ISE	2, F	EG	STE	R, 1	4ND) GF	RILL	ES	SCHE	EDU.	LE			
	TYPE	MAKE		ACCES!	SORIES	ò		٢	1ATERI/	\ L		FINISH				COLOR	2			MISC.	
REF.	SERVICE AND TYPE	MAKE AND MODEL	MULTI-SHUTTER VALVE	OPPOSED BLADE DAMPER	SQ. TO ROUND ADAPTER	SEPARATE PLASTER FRAME	OTHER ADAPTER	STEEL	ALUMINUM	STAINLESS STEEL	BAKED ENAMEL	LACQUER	GOLDEN SAND	STANDARD GREY	CLEAR OR LACQUER	STANDARD OFF-WHITE	MATCH T-BAR	MATCH CEILING	DEFLECTION	BLADE SPACING	REMARKS
А	SUPPLY REGISTER	HART & COOLEY	Х					Х					Х								18"x4.5" SUPPLY REGISTER (BASEBOARD MOUNT)
В	RETURN REGISTER	HART & COOLEY 650						X								×			20°	1/3"	I6"x24" RETURN REGISTER (LOW SIDE WALL)
С	SUPPLY REGISTER	HART & COOLEY						×					×								IO"x4" SUPPLY REGISTER (TOE KICK GRILLE)




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JIRMINGHAM TERRACE
JINIT REPAIRS AND RENOVATIC
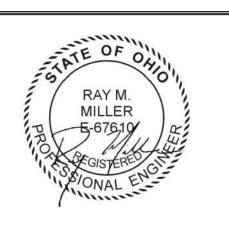
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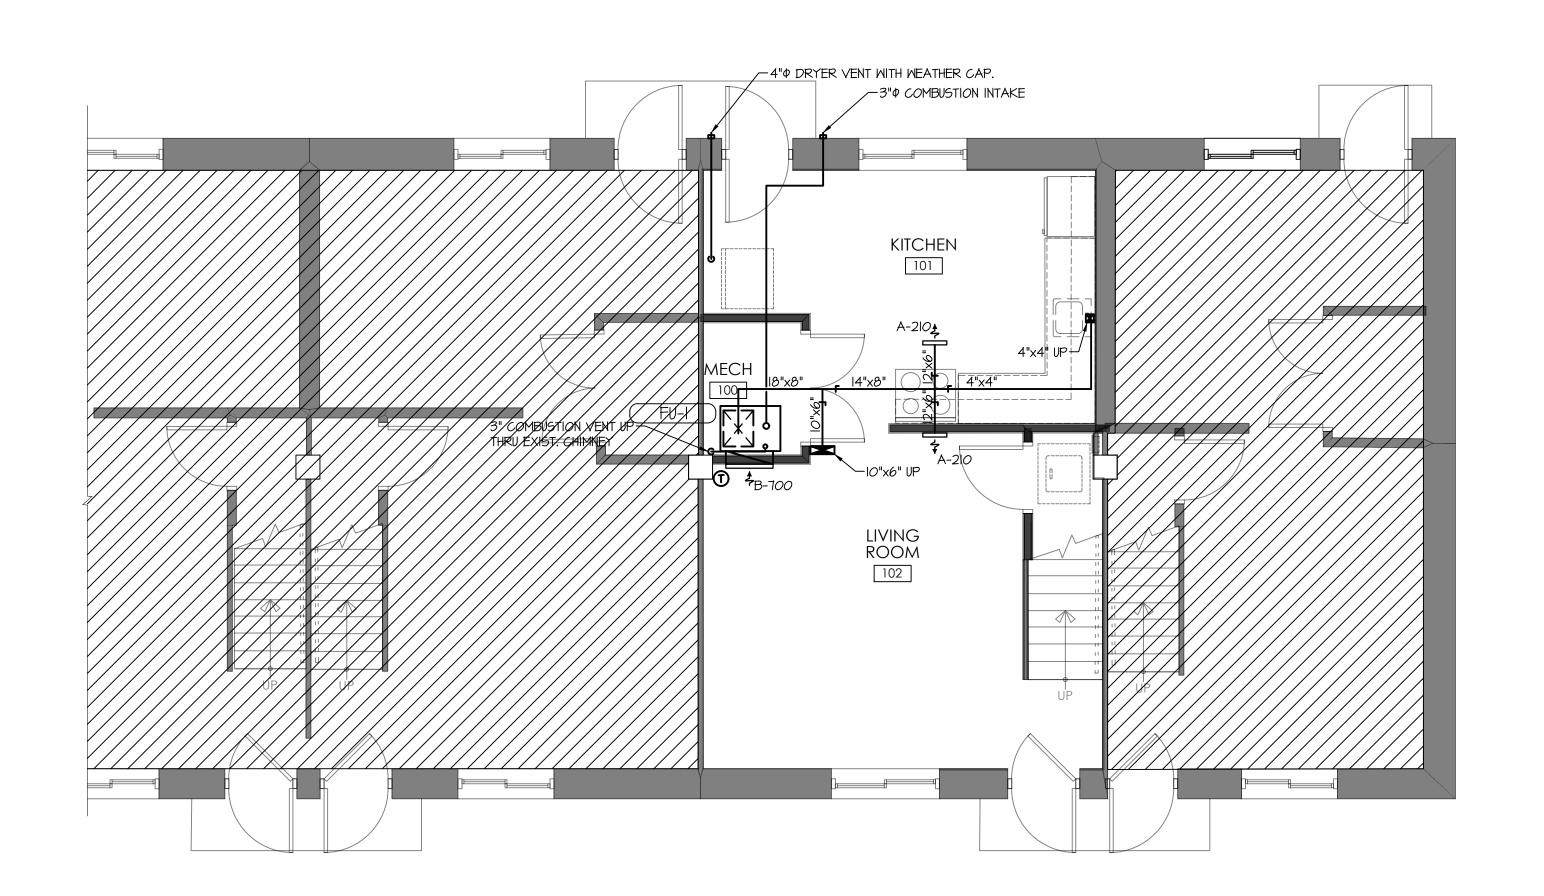
HVAC SCHEDULES AND DETAILS

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6"¢ WALL CAP WITH—— BIRD SCREEN AND BACKDRAFT DAMPER BEDROOM 1 203 HALL 201 BEDROOM 2










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DESIGNED: VDG DRAWN: VDG CHECKED: VDG

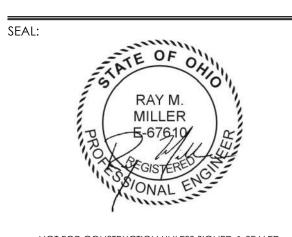TPA COMMISSION NUMBER: 22022

DRAWING TITLE:

HVAC FLOOR PLANS

GENERAL SCOPE OF WORK AND ELECTRICAL SPECIFICATIONS:

I. GENERAL SCOPE OF WORK: FURNISH AND INSTALL ALL LABOR, MATERIALS, TOOLS, ETC. TO PROVIDE A COMPLETE AND OPERATIONAL ELECTRICAL INSTALLATION, AS INDICATED ON THE PLANS. CONTRACTOR SHALL REFER TO THE WORK INDICATED ON THE ASSOCIATED MECHANICAL, ELECTRICAL, ARCHITECTURAL AND STRUCTURAL PLANS, ETC. AS WORK SHOWN THEREON MAY AFFECT OR INCLUDE ADDITIONAL ELECTRICAL WORK. ALL MATERIALS INCLUDED IN THE WORK SHALL BE NEW UNLESS SPECIFICALLY NOTED OTHERWISE; EACH ITEM SHALL BE U.L. LISTED OR LABELED TO ASSURE ITS SUITABILITY AND APPROVAL FOR THE PURPOSE SHOWN. ALL LABOR SHALL BE PERFORMED BY QUALIFIED AND SKILLED WORKERS, IN A NEAT AND WORKMANLIKE MANNER, AND IN ACCORDANCE WITH INDUSTRY STANDARDS AND PRACTICES.

2. PRIOR TO RELEASING ANY ORDER FOR MATERIAL FOR THIS PROJECT, THE CONTRACTOR SHALL SUBMIT FOR REVIEW, DETAILED DRAWINGS AND/OR EQUIPMENT CUT SHEETS, SHOWING DIMENSIONS, SIZES, WEIGHTS. ELECTRICAL RATINGS AND OPERATING CHARACTERISTICS, CAPACITIES, MATERIALS, COLORS AND ROUGH-IN REQUIREMENTS, FOR ALL MAJOR EQUIPMENT SUPPLIED. SUBMITTALS SHALL BE MADE SUFFICIENTLY IN ADVANCE OF THE REQUIRED ORDER RELEASE DATE TO ALLOW THE OWNER AMPLE TIME TO REVIEW SUCH INFORMATION. MULTIPLE COMPONENTS INTENDED TO FUNCTION TOGETHER, SHALL BE COORDINATED AND SUBMITTED AS A UNIT.

3. CONTRACTOR SHALL COORDINATE HIS WORK WITH THAT OF THE OWNER AND THE OPERATIONS OF THE OWNER. ALL SHUTDOWN WORK SHALL BE PERFORMED AT TIMES WHICH WILL NOT INTERFERE WITH THE REGULAR OPERATION OF THE FACILITY AND THE OWNER, CONTRACTOR SHALL NOTIFY ALL AFFECTED PARTIES AT LEAST FOURTEEN DAYS PRIOR TO SHUTDOWNS AND CUT-OVERS.

4. ELECTRICAL WORK SHALL COMPLY WITH REQUIREMENTS OF NATIONAL ELECTRICAL CODE, NATIONAL ELECTRICAL SAFETY CODE OF BUREAU OF STANDARDS, STATE BUILDING RULES AND REGULATIONS AND LOCAL ORDINANCES, AND SUCH OTHER STATUTORY PROVISIONS THAT PERTAIN TO THIS CLASS OF WORK.

5. CONTRACTOR SHALL GUARANTEE THIS INSTALLATION AGAINST DEFECTS IN EQUIPMENT AND/OR WORKMANSHIP FOR A PERIOD OF TWELVE (12) MONTHS FROM DATE OF FINAL ACCEPTANCE.

6. CONTRACTOR SHALL VISIT THE SITE AND EXAMINE THE PREMISES AND SHALL FULLY INFORM HIMSELF AS TO THE CONDITIONS UNDER WHICH WORK IS TO BE DONE. FAILURE TO DO SO SHALL NOT RELIEVE THE CONTRACTOR OF THE RESPONSIBILITY FOR THE FULL PERFORMANCE OF THE CONTRACT.

7. CONTRACTOR SHALL PROVIDE ALL MATERIALS NECESSARY FOR PROPER EXECUTION OF THE WORK, ALL MATERIALS SHALL BE NEW AND BEST OF THEIR RESPECTIVE KINDS FOR USE INTENDED. MATERIAL SHALL BE APPROVED BY U.L. INC. OF NATIONAL BOARD OF UNDERWRITERS.

8. SUPPLY UPDATED PANELBOARD DIRECTORIES, NEATLY TYPED FOR ALL PANELS.

9. CONDUCTORS FOR POWER SHALL BE 300 VOLT STRANDED COPPER THHN/THW NO. 12 AWG MIN. (#14 AWG FOR CONTROL WIRING). CONDUIT SHALL BE I/2" EMT MIN., (GRS AND PVC CONDUIT FOR OUTDOOR WORK).

IO. CONTRACTOR SHALL OBTAIN ALL NECESSARY ELECTRICAL PERMITS AND CERTIFICATES OF INSPECTION FOR CONSTRUCTION.

II. WORKMANSHIP SHALL BE IN ACCORDANCE WITH THE BEST PRACTICES OF THE TRADE. ELECTRICAL WORK SHALL BE INSTALLED BY JOURNEYMAN ELECTRICIANS, UNDER THE DIRECT SUPERVISION OF A COMPETENT FOREMAN. AT NO TIME SHALL ELECTRICAL WORK BE INSTALLED BY APPRENTICE ELECTRICIANS OR LABORERS WITHOUT THE IMMEDIATE, ON THE JOB SUPERVISION OF A JOURNEYMAN ELECTRICIAN.

12. CONTRACTOR SHALL COORDINATE HIS WORK WITH BUILDING OWNER. CONTRACTOR SHALL DO ALL CUTTING, FITTING AND PATCHING THAT MAY BE

13. ELECTRICAL CONTRACTOR SHALL USE CONDUIT WHERE CALLED FOR ON DRAWINGS OR REQUIRED BY NATIONAL, STATE OR LOCAL CODES, MINIMUM SIZE SHALL BE 1/2".

14. ELECTRICAL CONTRACTOR SHALL COORDINATE ALL POWER WIRING, SAFETY DISCONNECT MEANS, MOTOR CONTROL AND CONTROL WIRING FOR HEATING EQUIPMENT WITH THE EQUIPMENT SHOP DRAWINGS, MANUFACTURER RECOMMENDATIONS AND IN ACCORDANCE WITH THE N.E.C.

15. NOT USED.

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16. ALL SINGLE POLE 15 AMP AND 20 AMP CIRCUITS SHALL HAVE INDIVIDUALS NEUTRALS TO COMPLY WITH THE NEC. EACH NEUTRAL SHALL BE IDENTIFIED AT EACH JUNCTION BOX AND TERMINALS THE SAME AS IT'S CORRESPONDING BRANCH CIRCUIT NUMBER.

	SYMBOL LEGEND
YMB0L5	DESCRIPTION
Ов	LED OR H.I.D. LIGHTING FIXTURE, LETTER INDICATES TYPE SEE LIGHTING FIXTURE SCHEDULE
Юр	WALL MOUNTED LIGHTING FIXTURE, LETTER INDICATES TYPE SEE LIGHTING FIXTURE SCHDULE
5	SINGLE POLE SWITCH, 20A., 120V. MH - 4'-0" UNLESS NOTED.
53 54	3-WAY SWITCH, 20A., 120V. MH - 4'-0" UNLESS NOTED. 4-WAY SWITCH, 20A., 120V. MH - 4'-0" UNLESS NOTED.
5p	PILOT SMITCH, 20A., 120V. MH - 4'-0" UNLESS NOTED.
-	SINGLE RECEPTACLE, 30A, 125V, 2-POLE, 3-WIRE GROUNDING TYPE, UNLESS OTHERWISE NOTED
Ě	TAMPER PROOF DUPLEX RECEPTACLE, 20A., 125VOLT, 2 POLE, 3 WIRE, GROUNDING TYPE. MH = 12" U.N.O.
SF	FUSED SWITCH UNIT, I5A, I2OV UNO
<u> </u>	TAMPER PROOF GFI TYPE RECEPTACLE 20A, 125V, 2-POLE, 3 WIRE GROUNDING TYPE, MH = 12" UNO
	CONDUIT CONCEALED IN OR UNDER FLOOR OR BURIED.
	CONDUIT EXPOSED OR ABOVE CEILING NON-FUSIBLE DISCONNECT SMITCH 300V, 2 POLE UNO., SMITCH SIZE AS INDICATED
60A 40AF	FUSIBLE DISCONNECT SMITCH 300V, 2 POLE UNO., SMITCH SIZE AND FUSE SIZE AS INDICATED
MH	MOUNTED HEIGHT - FROM FINISHED FLOOR TO BOTTOM OF EQUIPMENT
MP	WEATHERPROOF
AFF	ABOVE FINISHED FLOOR
AFG	ABOVE FINISHED GRADE
GFI	GROUND FAULT INTERRUPTER
EC	ELECTRICAL CONTRACTOR
MC	MECHANICAL CONTRACTOR
€0	COMBINATION FIRE ALARM SMOKE/CARBON MONOXIDE DETECTOR 120V. WITH BATTERY BACKUP & DUAL SENSOR SMOKE (IONIZATION ANI PHOTOELECTRIC) TECHNOLOGY. DETECTORS SHALL ALSO HAVE DUAL CONTACTS FOR INTER-CONNECT WIRING WITH-IN EACH DWELLING UN
<u> </u>	CARBON MONOXIDE DETECTOR, 120V. WITH BATTERY BACK-UP, AND COMPLY WITH UL2034.
ŏ I	SPECIAL RECEPTACLE 40A. 240V. IP. 3W. GROUNDING TYPE. MH = 12" U.N.O.
	ELECTRICAL SERVICE PANEL
™ 20AF	COMBINATION MAGNETIC MOTOR STARTER- FULL VOLTAGE TYPE WITH FUSIBLE DISCONNECT SWITCH, NEMA STARTER SIZE AND FUSE SIZE AS INDICATED
#IO & #IO-3/4"C	INDICATES QUANTITY AND SIZE OF POWER CONDUCTORS, SIZE OF GROUNDING CONDUCTOR (IF ANY) AND CONDUIT SIZE.
(E)	JUNCTION BOX SPECIFICALLY REQUIRED AT LOCATION SHOWN
/5/ M	MOTOR, HOSEPOWER AS INDICATED MANUAL MOTOR STARTER, MOUNTED TO UNIT, UNO.
T 45KVA	TRANSFORMER KVA AS INDICATED
TC	TIME CLOCK - 120V. 24 HOUR, ASTRONOMICAL TYPE, TORK OR APPROVED EQUAL
ES	EQUIPMENT SUPPLIER
NTS	NOT TO SCALE
FB0	FURNISHED BY OTHERS
UNO	UNLESS NOTED OTHERWISE CONTROL PANEL, FBO
<i>Œ</i>	CONDUIT TURNING UP
-	CONDUIT TURNING DOWN
─	INDICATES CIRCUITS TO PANEL, UNLESS NOTED.
■	TELEPHONE SYSTEM FLUSH WALL OUTLET, MH=12" UNO. (4" SQ. J-BOX I-GANG PLASTER RING)
◁	COMPUTER SYSTEM WALL OUTLET, MH=12" UNO. (4" SQ. J-BOX I-GANG PLASTER RING) STUBBED ABOVE CEILING)
DC	SURFACE MOUNTED DOOR CHIME, NUTONE OR OWNER APPROVED EQUAL
•	DOOR CHIME PUSHBUTTON
⊕	44" NEXT TO SYMBOL INDICATES SYMBOL M.H. = 44" AFF
G	SURFACE MOUNTED GARAGE DOOR OPENER
A	SURFACE MOUNTED LIGHT FIXTURE
<u> </u>	DECORATIVE EXTERIOR GOOSENECK WALL SCONCE
	GARAGE DOOR PUSH BUTTON
<u>早</u>	EXTERIOR COACH LIGHT
\ominus	FLOOR DUPLEX RECEPTACLE 20A, 125V, 2P, 3M, FLUSH FL, TYPE

NOTE: NOT ALL SYMBOLS ARE USED.

	EQUI	PMENT & LIGHTING FIXTURE	5 (CHEDULE
TYPE	LAMPS	DESCRIPTION	VOLTS	MFR. CAT. NO.
А	(2) IOW LED	13" CEILING MOUNTED FIXTURE WITH LED LAMPS IN WHITE FINISH.	120	SEAGULL 75942EN3-I5
В	(I) IOW LED	II.5" CEILING MOUNTED FIXTURE WITH LED LAMP IN WHITE FINISH.	120	SEAGULL 75940EN3-15
С	(3) IOW LED	24" BATH VANITY FIXTURE WITH LED LAMPS IN CHROME FINISH.	120	SEAGULL 4490303EN3-05
D	(2) IOW LED	15.25" CEILING MOUNTED FIXTURE WITH LED LAMPS IN WHITE FINISH.	120	SEAGULL 4485IEN-782-WHITE
F	(I) IOW LED	CEILING MOUNTED PORCELAIN LAMP HOLDER WITH PULL CHAIN AND WHITE FINISH. GE LED ENERGY STAR CERTIFIED BULB.	120	LEVITON OR EQUAL
6	(I) IOW LED	EXISTING 4.5" EXTERIOR WALL MOUNTED LED FIXTURE IN BLACK FINISH. DETACH, REWIRE AND RESET.	120	PROGRESS P560072-031-30
Н	(I) IOW LED	24" LED LINKABLE UNDERCABINET LIGHT WITH RUGGED POST-PAINTED LOW PROFILE STEEL HOUSING AND WHITE ACRYLIC DIFFUSER. WHITE FINISH. ON/OFF ROCKER SWITCH	120	LITHONIA #UCEL-24IN-3OK-9OCRI-SWR-WH OR OWNER APPROVED EQUAL
S/C	SUPPLIED WITH UNIT	COMBINATION SMOKE/CO DETECTOR. 9V BATTERY BACK-UP, LED INDICATOR, 85DB @ IO'-O" TEST RESET WMEMORY (120V HARDWIRED & INTERCONNECTED)	120	GENTEX GN-503 SERIES
EF-I	(I) 24W LED	BATH EXHAUST FAN 70 CFM	PANASONIC FV-08WQI	
HOOD	(I) I3.5W LED	DUCTED, WALL MOUNT, THERMALLY PROTECTED. 6" X 30" W/3" X IO" DAMPER I3.5W LED AI9, 2-SPEED ROCKER SWITCH.	120	NUTONE 43000 SERIES-WHITE OR STAINLESS STEEL SELECTED BY OWNER

- COORDINATE ALL MOUNTING HEIGHTS AND LOCATIONS WITH OWNER/ARCHITECT PRIOR TO ROUGH-IN ELECTRICAL.
- 2. ALL LIGHTING FIXTURES, CEILING FANS AND BATH/EXHAUST FANS MUST BEAR THE EPA ENERGY STAR LABEL. 3. MANUFACTURER AND CATALOG NUMBER SHOWN ARE A BASIS OF SPECIFICATION. ALTERNATIVES OR SUBSTITUTIONS
- MUST BE SUBMITTED TO OWNER/ARCHITECT IO DAYS PRIOR TO BID FOR CONSIDERATION. 4. ALL LED LAMPS SHALL BE WARM WHITE (2700° K) AS MANUFACTURED BY CREE OR SATCO LAMPS.
- 5. FAN-I/FAN-2 AND HOOD SUPPLIED BY ELEC. CONTRACTOR AND COORDINATED WITH HVAC CONTRACTOR FOR DUCT TO OUTSIDE.

	PANEL P-I TYPE <u>120/240V IPH 3W</u> SURFACE OR FLUSH <u>SURFAC</u> MAIN LUGS <u>100A M.C.B.</u> RATING <u>22,000</u>	E						LOC FEE TOP FED	ATION DER _ OR B FROM	<u>KITCHE</u> 3#3 & OTTOM_	N #86 BOT1 EDO ED		
CIRCUIT	DESCRIPTION	WIRE SIZE	VA	C.	.B.	A	В	C AMP	.B.	VA	WIRE SIZE	DESCRIPTION	CIRCUI"
6	BEDROOM RECEPT'S/LTG.	12	740	20	- 1	2020		20	1	1280	12	LIVING & KITCH. LTG/PWR	20
<u>3</u>	BEDRM 2/HALL RECEPT'S/LTG	. I2	920	20	- 1		2120	20		1200	12	KITCH. COUNTER RECEPT	46
5 a	REFRIGERATOR	12	800	20	-	1800		20		1000	12	KITCH. COUNTER RECEPT	(6a)
	KITCHEN COUNTER RECEPT	12	1000	20	- 1		1200	20		200	12	MECH/LAUNDRY	(3b)
9a	DRYER	10	2250	30	2	3750		20		1500	12	WASHER	400
IIb	 	-	2250	-	-		3474	20		1224	12	FU-I	I2b
13a	BATHROOM LTG/PWR	12	400	20	1	1100		20		700	12	OVEN/HOOD	(14a)
(15b)	SPARE	12	-	20	1		200	20		200	12	EXTERIOR RECEPT/LTG	(16b)
(Ta)	SPARE	12	-	20		-		20		-	12	SPARE	₫
						8670	6994						

= DENOTES ARC-FAULT, CIRCUIT INTERRUPTER COMBINATION TYPE BREAKER


NOTE: ALL BRANCH CIRCUITS FEEDING RECEPTACLES INSTALLED IN KITCHENS, BEDROOMS, LIVING ROOMS, DINING ROOMS, CLOSETS, HALLWAYS AND LAUNDRY AREAS SHALL BE ARC-FAULT, CIRCUIT INTERRUPTING COMBINATION TYPE PER N.E.C. 210.12.



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ELECTRICAL

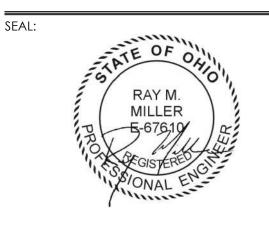SCHEDULES AND SPECIFICATIONS

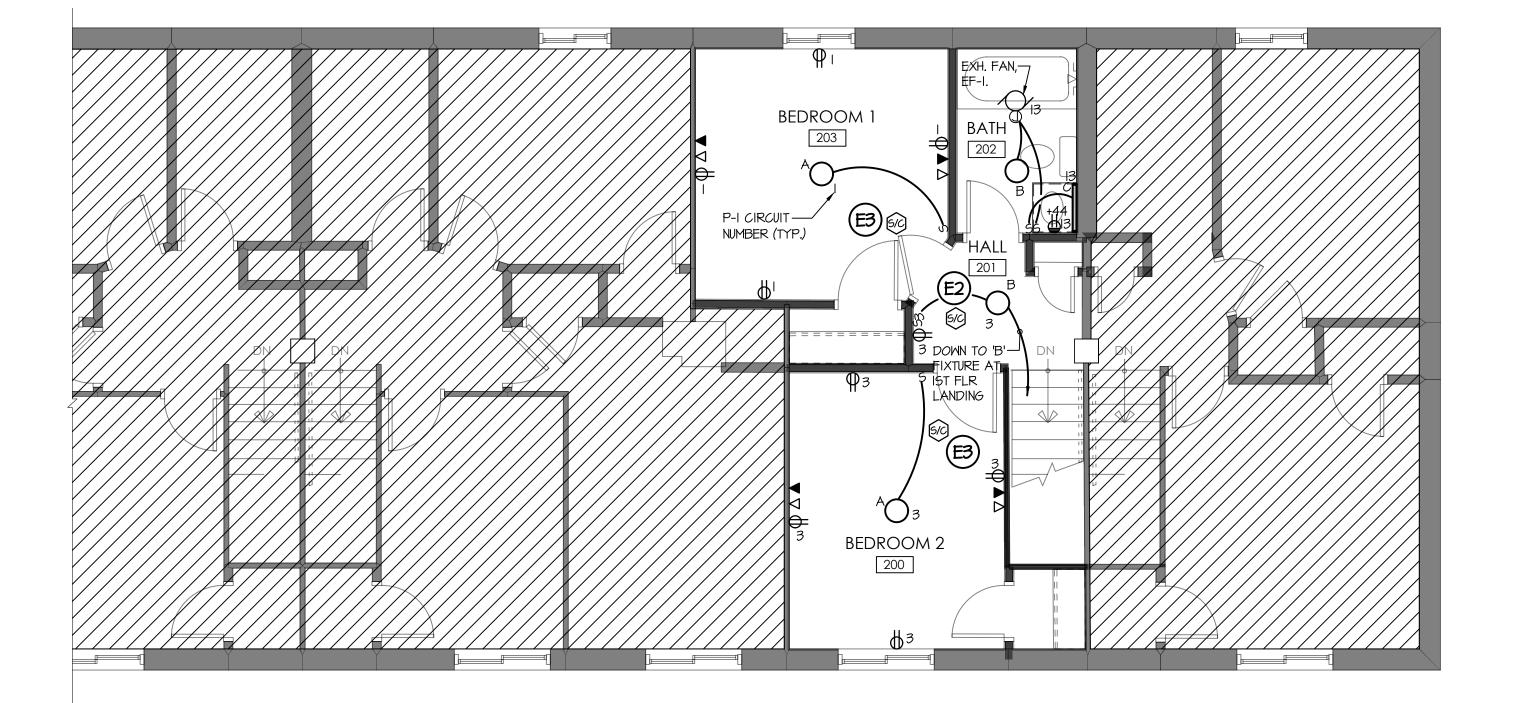
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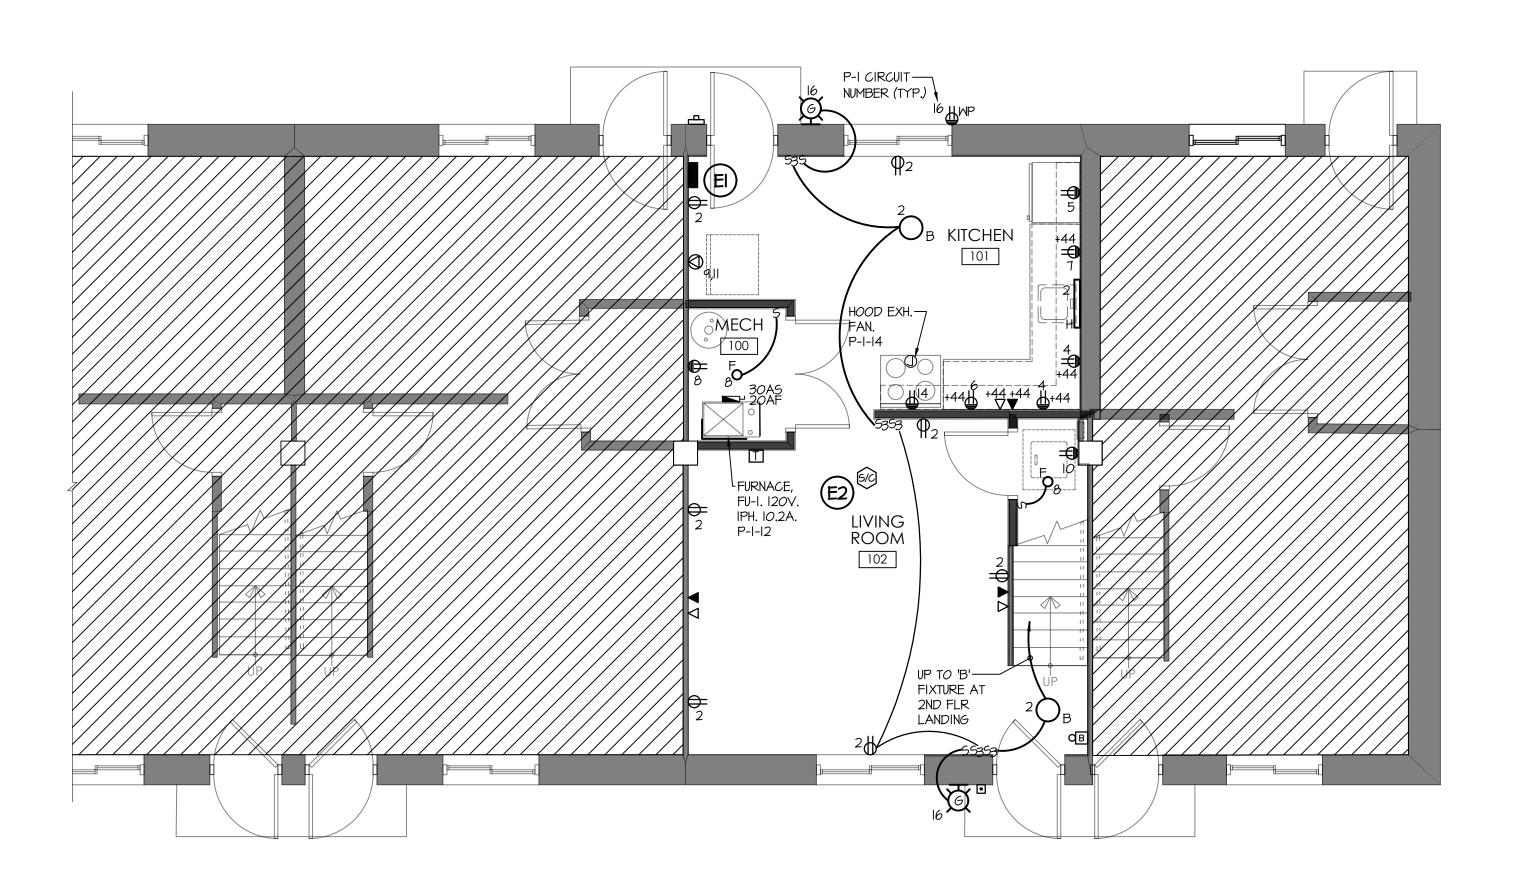
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ELECTRICAL PLAN KEY NOTES:

- EI REMOVE THE EXISTING I20/240V., IPH., IOOA. PANELBOARD AND ASSOCIATED BREAKERS AND REPLACE WITH A NEW I20/240V., IPH. IOOA PANELBOARD AND RE-ENERGIZED VIA THE EXISTING ELECTRICAL METER SERVICE PROVIDED BY TOLEDO EDISON. MAINTAIN ALL EXISTING CIRCUITS, CONDUITS AND WIRING. THE E.C. SHALL UPDATE THE PANELBOARD SCHEDULE LISTING WITH THE DESCRIPTION OF EACH EXISTING CIRCUIT DETAILING WHAT IS POWERED BY THEIR RESPECTIVE BREAKER. DISCARD ALL ITEMS DEMOLISHED AND/OR REMOVED AT THE OWNER'S DISCRETION.
- PREMOVE EXISTING SMOKE DETECTOR, IF ANY, AND REPLACE WITH A NEW SMOKE/CARBON MONOXIDE COMBINATION DETECTOR TO BE POWERED BY THE NEAREST EXISTING BRANCH CIRCUIT. ALL SMOKE DETECTORS SHALL BE INTERCONNECTED IN SUCH A MANNER THAT THE ACTIVATION OF ONE ALARM WILL ACTIVATE ALL OF THE ALARMS IN THE INDIVIDUAL UNIT, PER O.B.C. 907.2.11.5. DISCARD ALL ITEMS DEMOLISHED AND/OR REMOVED AT THE OWNER'S DISCRETION.
- PROVIDE NEW SMOKE/CARBON MONOXIDE DETECTOR AND POWER NEW SMOKE/CARBON MONOXIDE DETECTOR VIA NEAREST LOCAL AVAILABLE 120V CIRCUIT. DO NOT OVERLOAD EXISTING CIRCUITS. ALL DETECTORS SHALL BE INTERCONNECTED IN SUCH A MANNER THAT THE ACTIVATION OF ONE ALARM WILL ACTIVATE ALL OF THE ALARMS IN THE INDIVIDUAL UNIT, PER O.B.C. 907.2.11.5.












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ELECTRICAL FLOOR PLANS
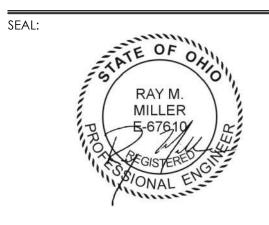
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