

818 S. FLORES ST. SAN ANTONIO, TEXAS 78204 DD www.saha.org

Procurement Department

ADDENDUM # 3

To: File 1805-909-23-4796

RFP for: Victoria Plaza Rehabilitation and Modernization

Please note the following additions and changes:

Please note closing date and time, has changed to July 20, 2018 at 2:00 p.m. see answer to Question 17.

- A. See attached Supplement to the Room Finishes.
- B. In the abatement plan please note the following: While converting the specification into pdf form, the exterior door frame caulking listed below carried over to page 2 creating a duplicate. There is only 5,000 linear feet of the material at the building. Please have contractors exclude the duplicate.
 - § Exterior Door Frame Caulking The brown door frame caulking material utilized around the exterior metal door frames throughout were previously identified by PSI to contain 2% Chrysotile asbestos. The asbestos-containing door frame caulking materials identified were noted to be in a good condition and were assessed as being non-friable. It is estimated that there exists approximately 5,000 linear feet of this materials in the above listed areas.
- C. See attached image of the Project Building
- D. Pre-submittal Sign in sheets are attached
- E. Replacement pages are attached for the drawings which were having print and reading issues.
- F. Replace Section D sub-section V. Liquidated Damages with the following:

LIQUIDATED DAMAGES: For each day that performance under the contract is delayed beyond the time specified for completion, the successful Respondents shall be liable for liquidated damages in the amount of \$500.00 per day. However, the timeframe for performance may be adjusted at SAHA's discretion in writing prior to default under the contract.

The following questions were received:

Question 1: What is the amount of the Liquidated Damages, our bonding companies will need to know this?

Answer 1: \$500.00 per day see above change.

Question 2: What is the estimated construction cost range?

Answer 2: Our estimated range for this project is \$10,000,000 to \$11,000,000 (+/-).

Question 3: Will you post the sign in sheets for this pre-submittal?

Answer 3: Sign In sheets are attached.



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Question 4: What is the specked product and color for the solid surface tops in the Break room on the first floor?

Answer 4: Please refer to the interior finish supplement attachment. The color will be selected from the manufacturer's color palate.

Question 5: Regarding the window installation; Both products specified have a frame depth of 3 ½". The existing product is just under 3 3/4". There is going to be a 1/2" gap to account for inside or outside. Need a detail on how to finish that off.

Answer 5: Contractor should make every effort to match existing and must meet minimum specifications. If a non-matching product is used, contractor should bid to include a turnkey, finished product. The ½" "gap" indicated is not a gap, as the difference just exposes a bit more of the interior wall jamb or sill surface than the previous solution. The existing materials and associated painting shall be extended to the back of the new window frame in these instances.

Question 6: We will not have the ability to use anchor clips to secure the windows. Need clarification on how they want to secure the new windows with the given wall conditions.

Answer 6: Contractor shall refer to manufacturer's specifications. Clips may be utilized however they may also require some selective demolition around the openings to tie in the waterproofing. Bidder has some freedom to determine their best solution to the problem.

Question 7: Will the 5" aluminum sill on the exterior remain or does that need to be bid to be replaced along with the windows?

Answer 7: The window sub sills and the aluminum extrusion which acts as a sill over the face brick do not need to be replaced if they work with the replacement windows, but if they do not, then they must be replaced with new profiles to match the existing in look and performance.

Question 8: Having trouble getting the drawings to print properly, on a number of sheets the notes and specs only print portions of the words the rest is just blank boxes.

Answer 8: See attached revised drawings.

Question 9: Window not shown on elevator or schedule. Please supply info and quantity (A103).

Answer 9: See attached clarification.

Question 10: Please provided mark for first floor windows (A200 and A201).

Answer 10: See attached clarification.

Question 11: Please identify first floor windows (A203).

Answer 11: See attached clarification.

Question 12: Windows on A202 beneath the roof tower are not shown on the schedule.

Answer 12: See attached clarification.



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Question 13: The specs for the Fire Alarm at Victoria Plaza reference an EST panel or equivalent. Would Gamewell-FCI, Silent Knight, Fire-Lite or Farenhyt be accepted if the functions and operations are equal to that of EST products?

Answer 13: As long as the function and quality are equal SAHA will consider and may accept alternate products. Please refer to Section D subsection H "EQUAL" (page 24) of the RFP.

Question 14: There are currently two Fire Alarm Panels on site will this be reduced to one complete system? **Answer 14:** The new Fire Alarm System has a voice evacuation system, which replaces both of the

existing systems. We have no objection to Notifier.

Question 15: Are there any special function systems on site? i.e. clean agent systems

Answer 15: There are no special agent systems.

Question 16: Other Systems Acceptable? **Answer 16:** See response to Question 13.

Question 17: We would like to request an extension on the bid date for Victoria Plaza. **Answer 17:** The closing date and time are changed to July 20, 2018 at 2:00 p.m.

Question 18: Sht M1.2 note 2 states that restroom exhaust fans are to be provided by division 26 and installed by mechanical contractor. Please clarify which division this equipment is to be supplied under, as this equipment is mechanically spec'd (Section 23 34 00) and scheduled (M0.2).

Answer 18: The note indicates the restroom exhaust fan is to be provided by div 26, but the mechanical contractor is to provide and install exhaust ductwork. The note does not say the mechanical contractor is to install the fan. We do have an exhaust fan on the roof to serve the apartments that are by the elevator lobby. This is specified by Div 23.

Date: July 2, 2018

By: Charles RSade
Charles Bode Asst. Director of Procurement

ADDENDUM

RESPONSES TO RFI QUESTIONS ON WINDOWS

SHEET A-103 Floor Plan Level 2 to 9

Question: Window Not shown on Elevation or Schedule. Please supply info and quantity.

Answer: There is no new window at Central Stairs. See Sheet A-190, Note 9 referring to Alternate #2 Stair Pressurization.

SHEET A-200 Exterior Elevation North

Question: Window as drawn, does not appear on schedule. Please supply info. please confirm windows

labeled in red as "K" are correct.

Answer: Banks of windows on Level 1 are all "K" type, Quad, Double or Triple, Single Hung

SHEET A-201 Exterior Elevation South

Question: Windows not shown on schedule. Please supply Info.

Answer: Windows on Level 1 are #27 Type, 2'-0" H x 3'-0" W, Casement, match other PGT series

SHEET A-202 Exterior Elevation East

Question: Windows not shown on schedule. Please supply info.

Answer: Windows (48 count) are 2-10 ¾" H x 2'-7" W, Single Hung, match other PGT series

Answer: Windows (24 count) are "L" Type, 5'-9 1/2" H x 2'-7" W, Single hung, match other PGT series

SHEET A-203 Exterior Elevation West

Question: Please confirm windows labeled in red as "K" are correct. Answer: Banks of windows on Level 1 are "K" type, Quad Single Hung




SIGN IN SHEET 1805-909-23-4796 Victoria Plaza Rehabilitation and Modernization June 20, 2018

				Chois Slocume	Mank Josep	Tosand Answers	mu hones	Jonathon Chew	Kalan Lewis	Charles Bode	Name (Please print)	
				Robles 1	Alamo I	The Range Bouglition	The Rapor Osnolition.	K-Air S413 Bardero. #403	K-Air 5413 Bundeva Rd Ste 403	SAHA , , ,	Company Name & Address	
				210.787.9325	20.464.720	(20) 225 - 883	(20)725 - 583	3463872261	210 393 8544	210-477-6703	Phone Number	
				chris@joblesl.net	fine 20 dano cen	Jacap remondent literon-cum	Questo remondentition con	ionathon ell-airapenation lori	Kelon @ K-air corporation com	charles_bode@saha.org	e-mail	

			Mike Noven	Frank 6 A12A	73 Perez	Name (Please print)
		Stoddard Construction	Supply Services,	Heat + Treat	P.O. BOX 840 Van amy TX 78073 210-623-8/78	Company Name & Address
		830 438 5904	(216) 523-0102	9960. EBC (a) E)	210-623-8/72	Phone Number
		bids@stoddardcmi.com v	Mike & Cleanolog Services Com	Frank@heatandtreat con	jj.mlp@aH.net	e-mail

	Jorge A. Zapata	Name (Please print) Jack Mehl Raut Scott Edre: 6 Mezz
	2221 E. Chavaneaux 5.0. Tx. 78294	Company Name & Address RKJ Construction, Inc. 604 W Mye C, Lampas 85, Tx All Prosentons+ All Prosentons+ All E.Chavaneaux
	210-639-1616	Phone Number 512-556-3684 210-627-2563
	Jorge @ apgc.biz	e-mail imehlortico.com rawir@apqc.biz dreieapyc.biz

San Focavis	Zac Woodan	Hector Martinez	JUSTIN HOME	John Blackwell	CSTEBAN MIREIES	ODSAP H SCHWOMMOT CALLDAD BETSEE	Store Doughet	Name (Please print)
DAR ARCHITECTS	SANA	SAHA	NINDOW EXPERTS	American Profing & Metal 801 WYOMING S.A. TX 78203	IZII PLEASANTON RA 782/4	CALIDAD DEGISTE OAK	About 2500 Newsders Ry SP. Th. 78217	Company Name & Address
210-308-0080	210-477-62cy	210-477-6507	218-254-0830	310-224-5463	210-784-8255	DEBSIE ORK 210-3476868 .	3/0-386-8431	Phone Number
S. Polandowkerenine US	Zacharial - wooded @ Sq. 49, 079	Histor Martinez (Saharos	JUSTINHONE @WINDOWEXPERTSTX.COM	John@ amerrostina-com	ESTERAN & AMSTAKINGG. COM	DSchuchapot. CATIOADLLC V	Seve Jalanot-con	e-mail

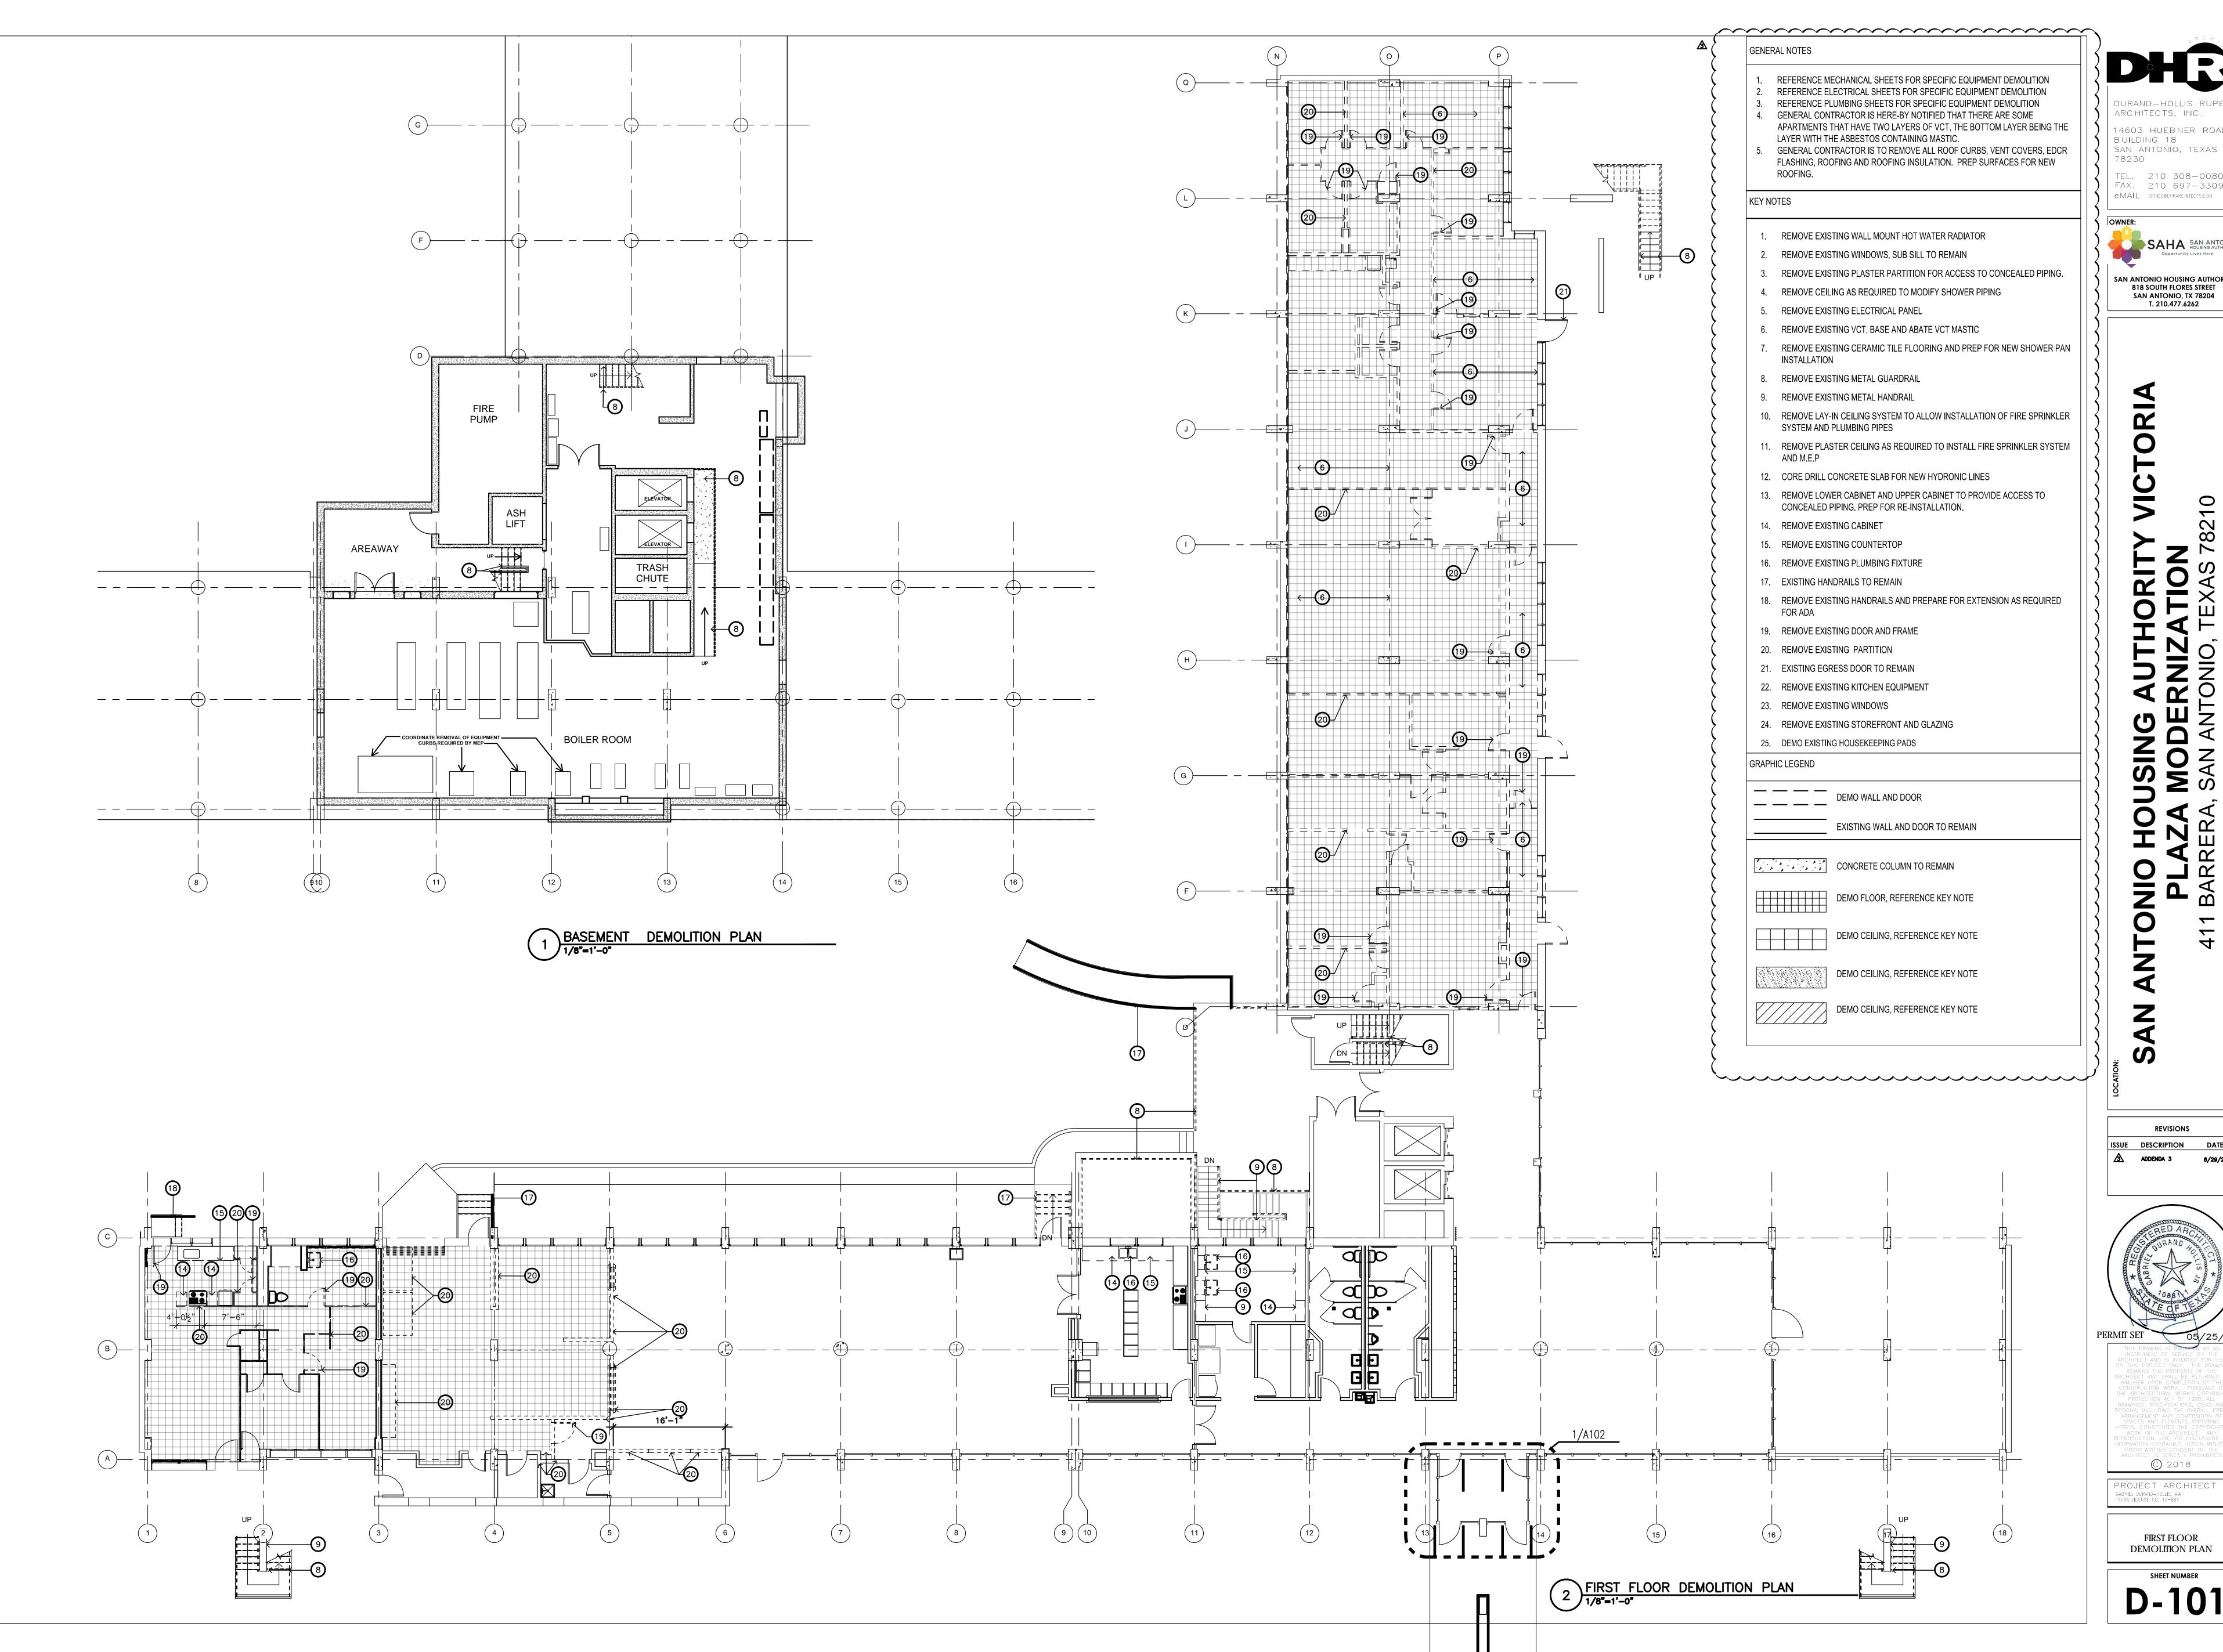


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> TEL. 210 308-0080 FAX. 210 697-3309

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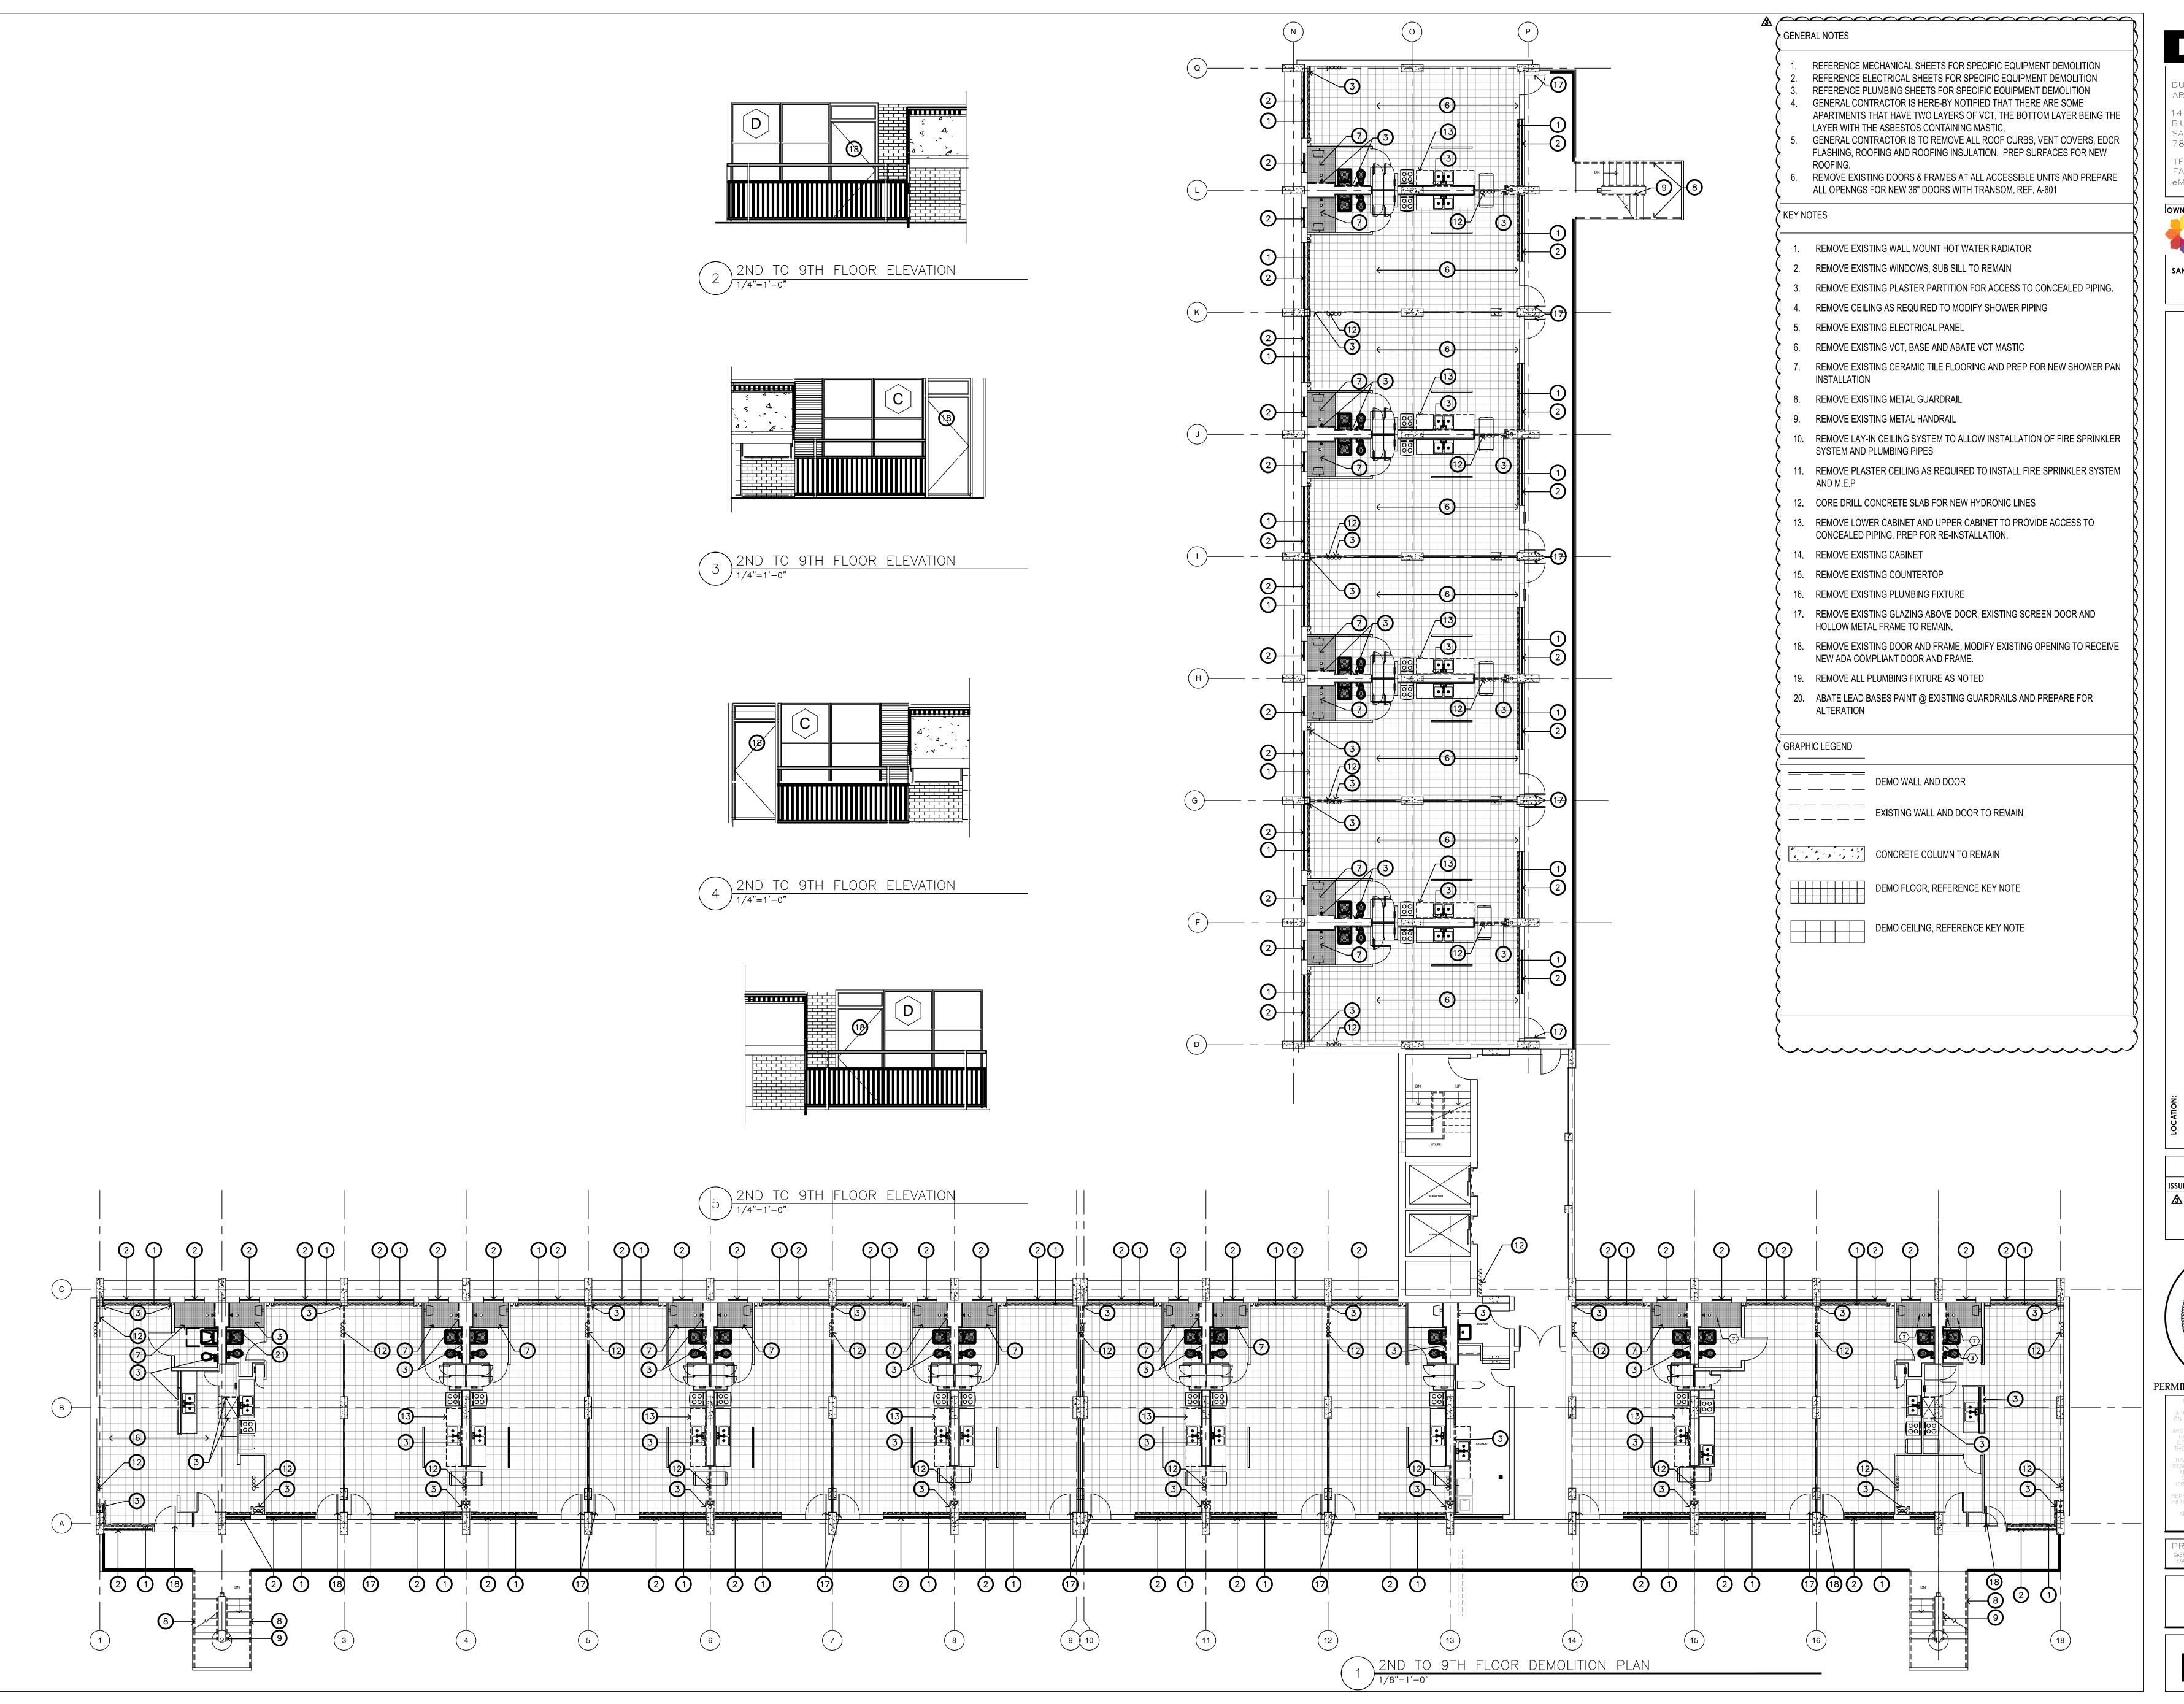
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TEXAS LICENSE NO. 10-881

FIRST FLOOR DEMOLITION PLAN



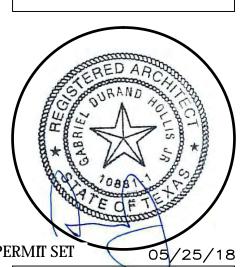

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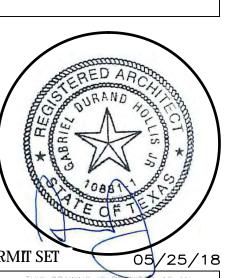
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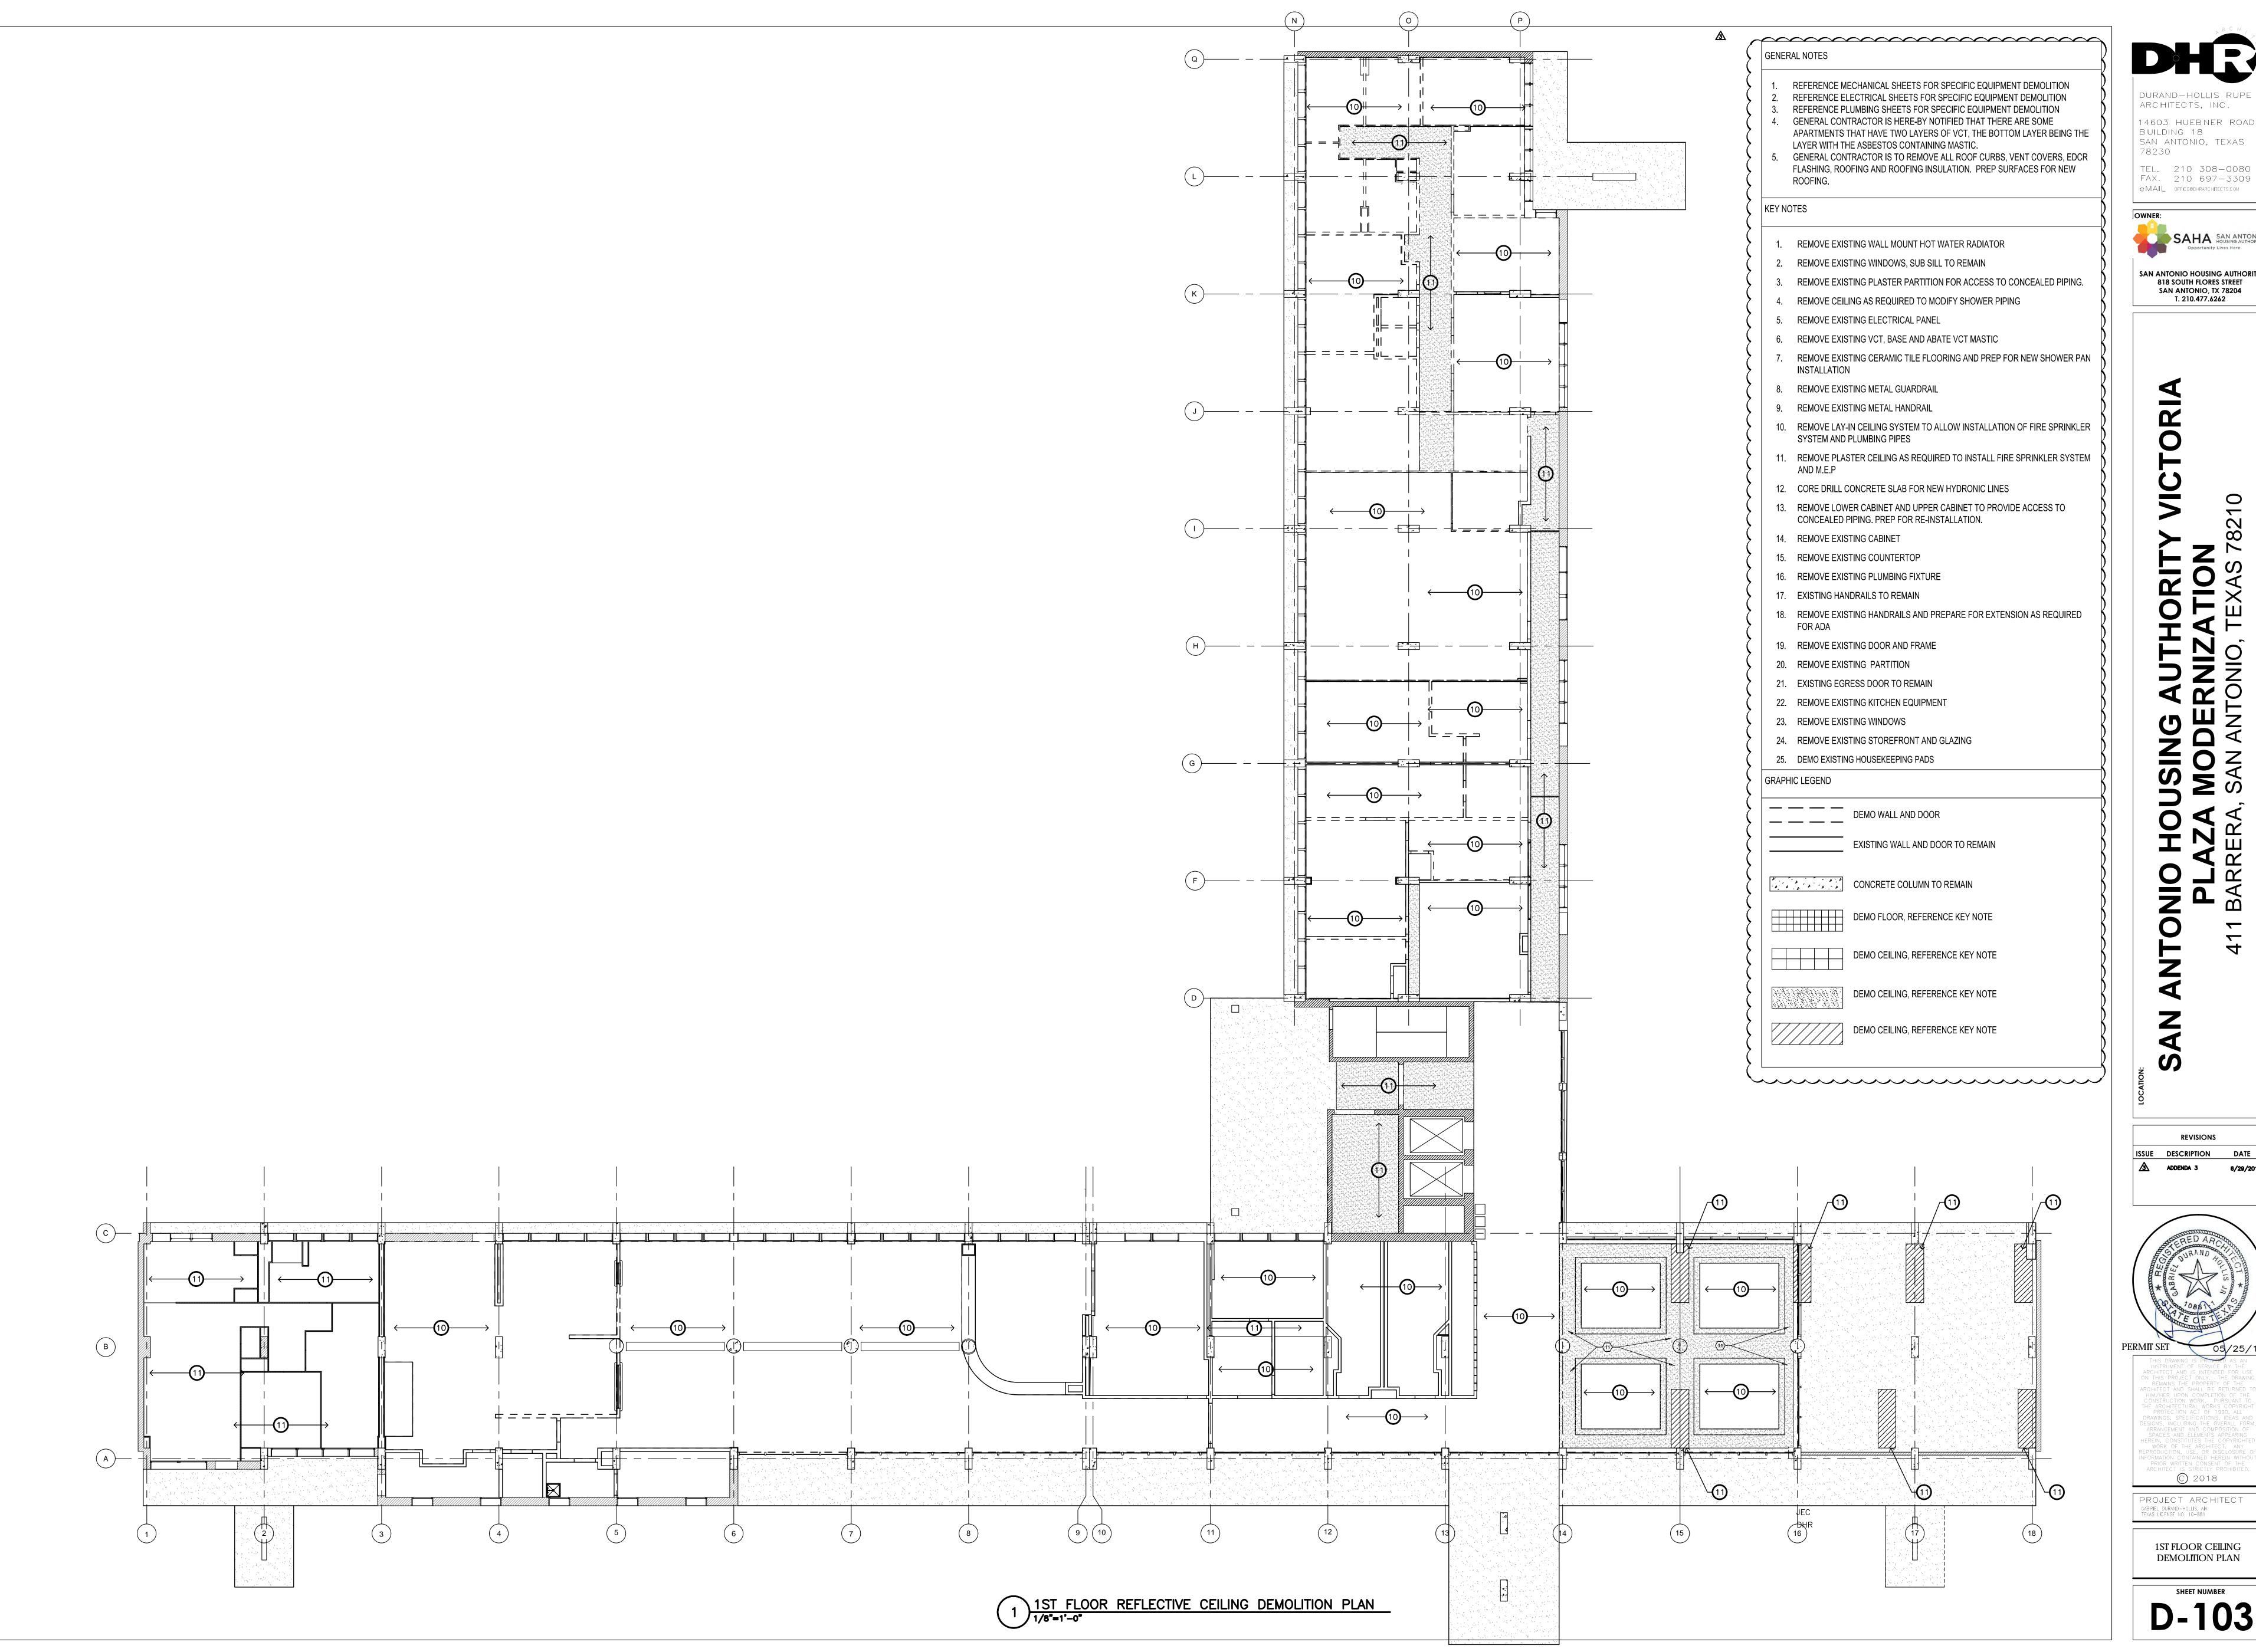
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2ND - 9TH FLOOR

2ND - 9TH FLOOR DEMOLITION PLAN

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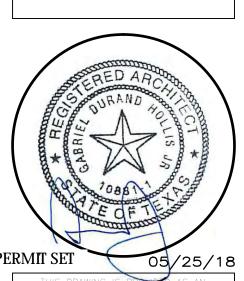
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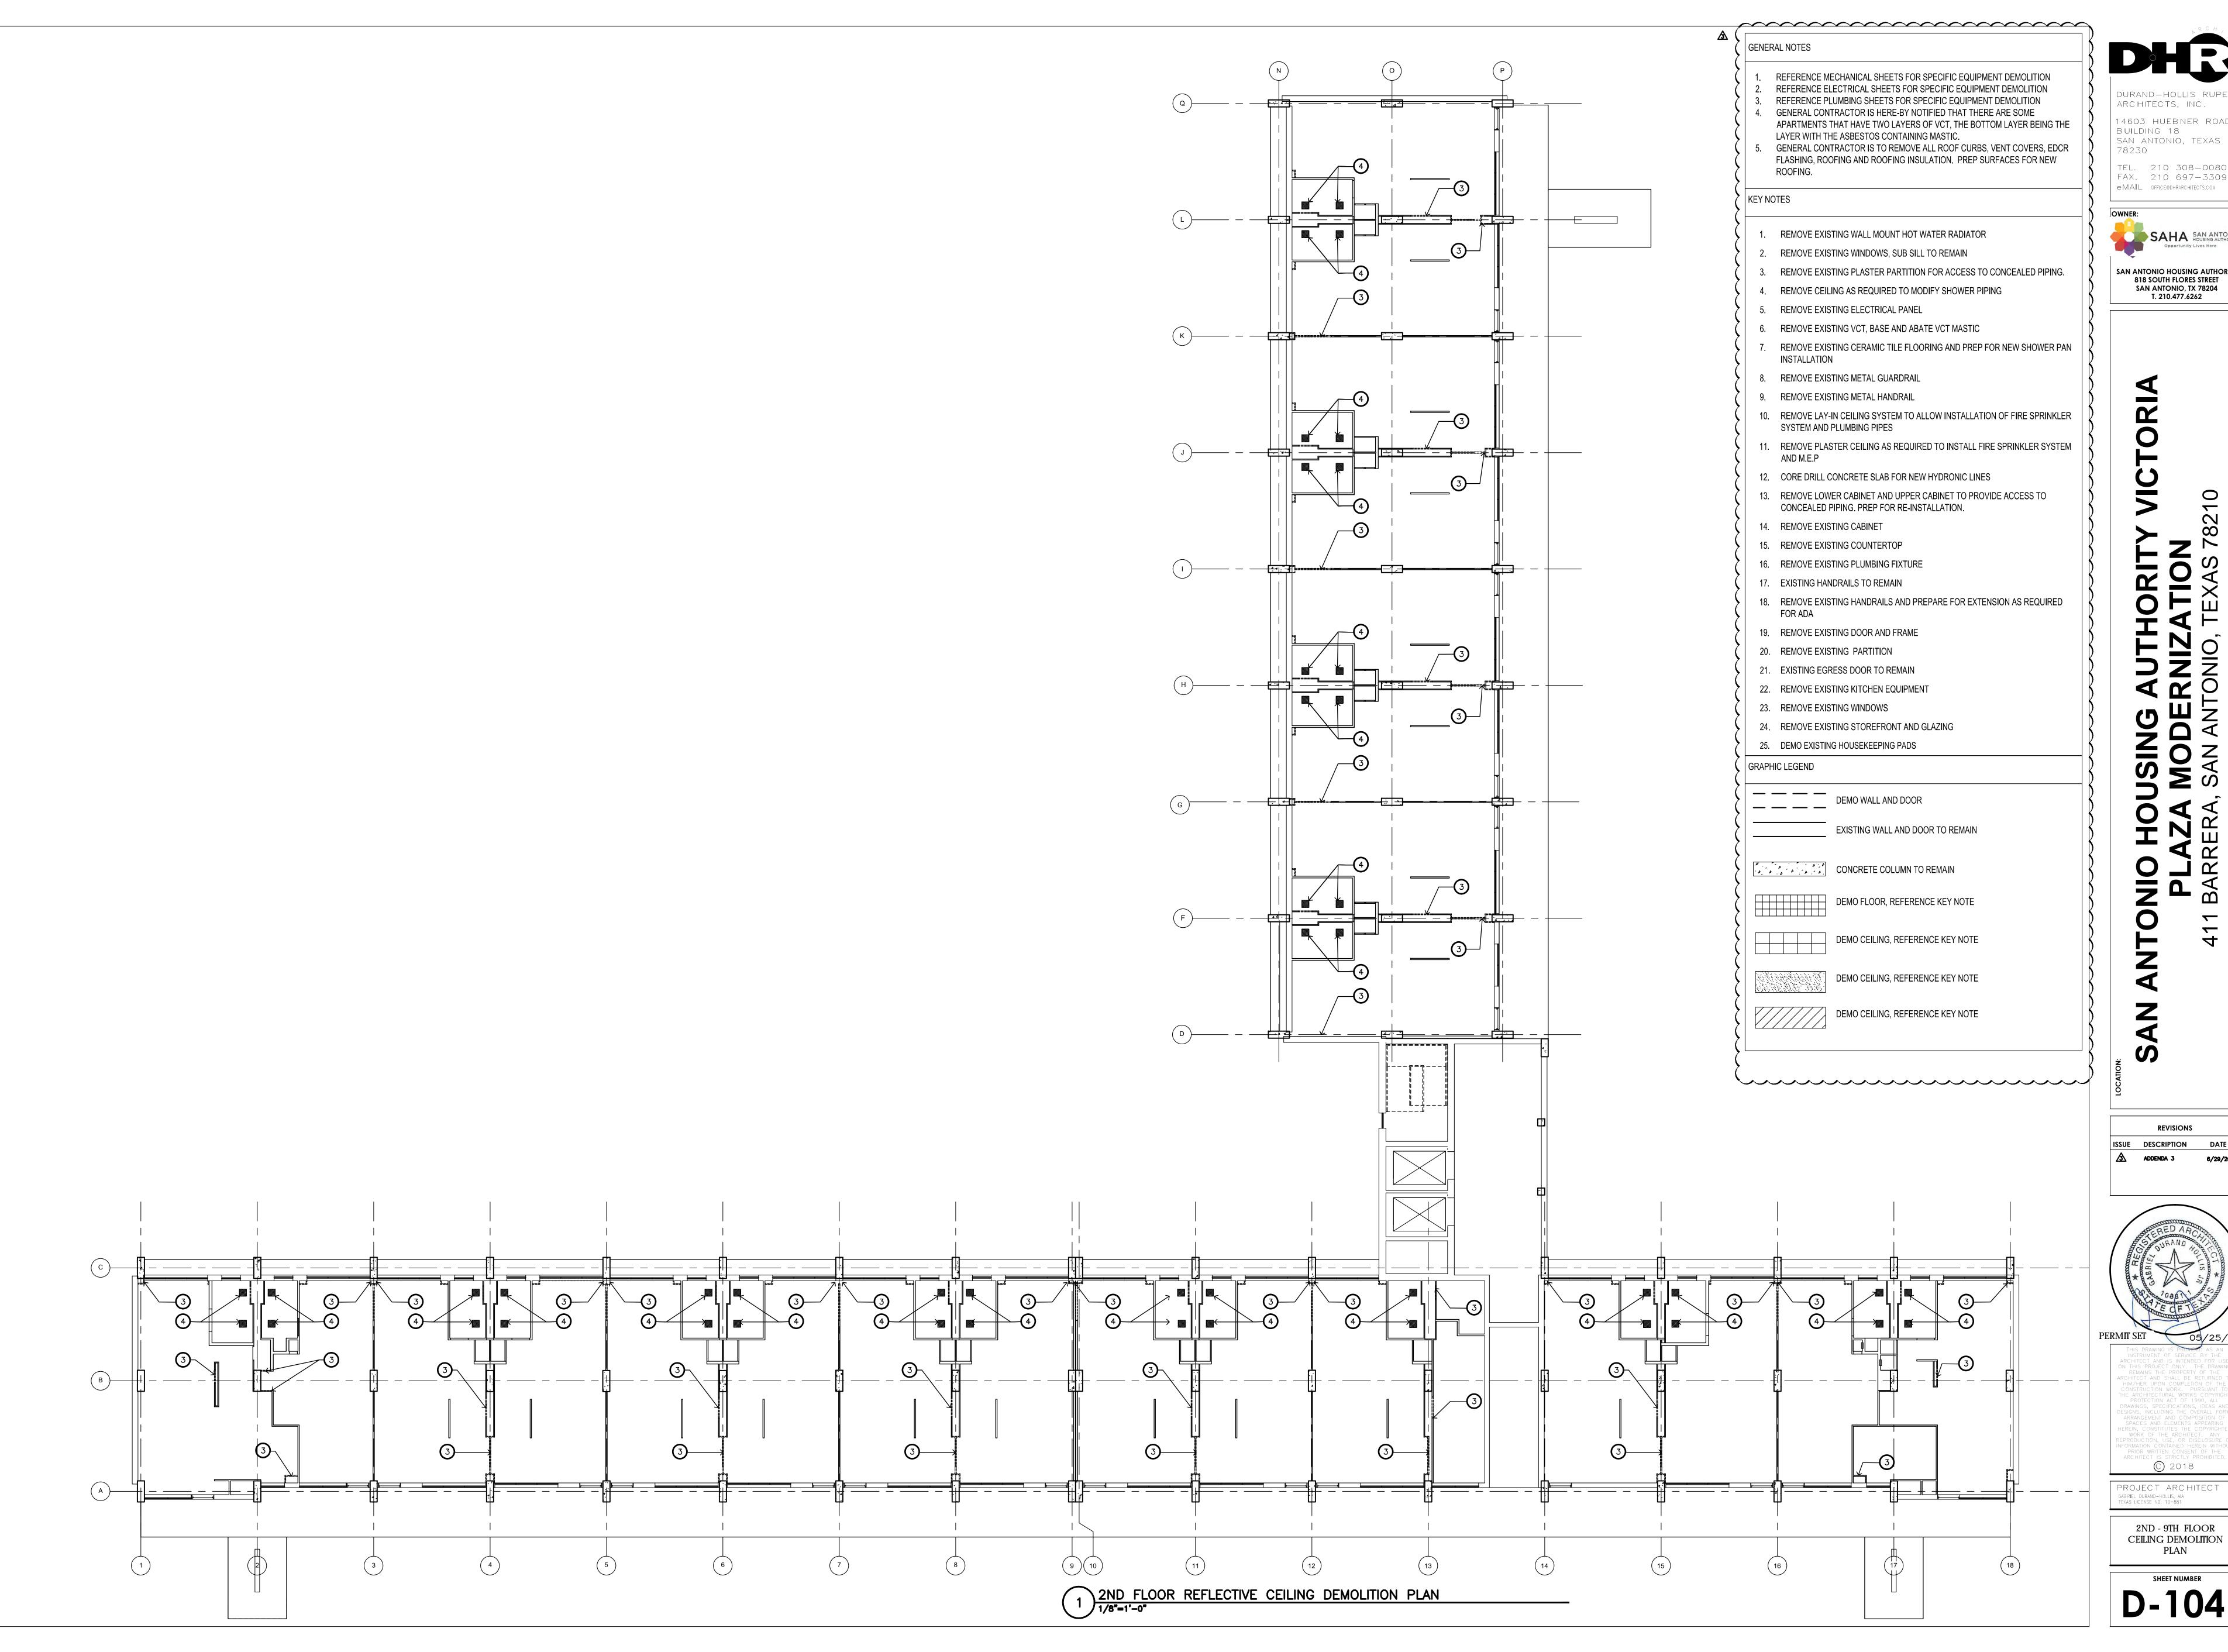
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> 1ST FLOOR CEILING DEMOLITION PLAN





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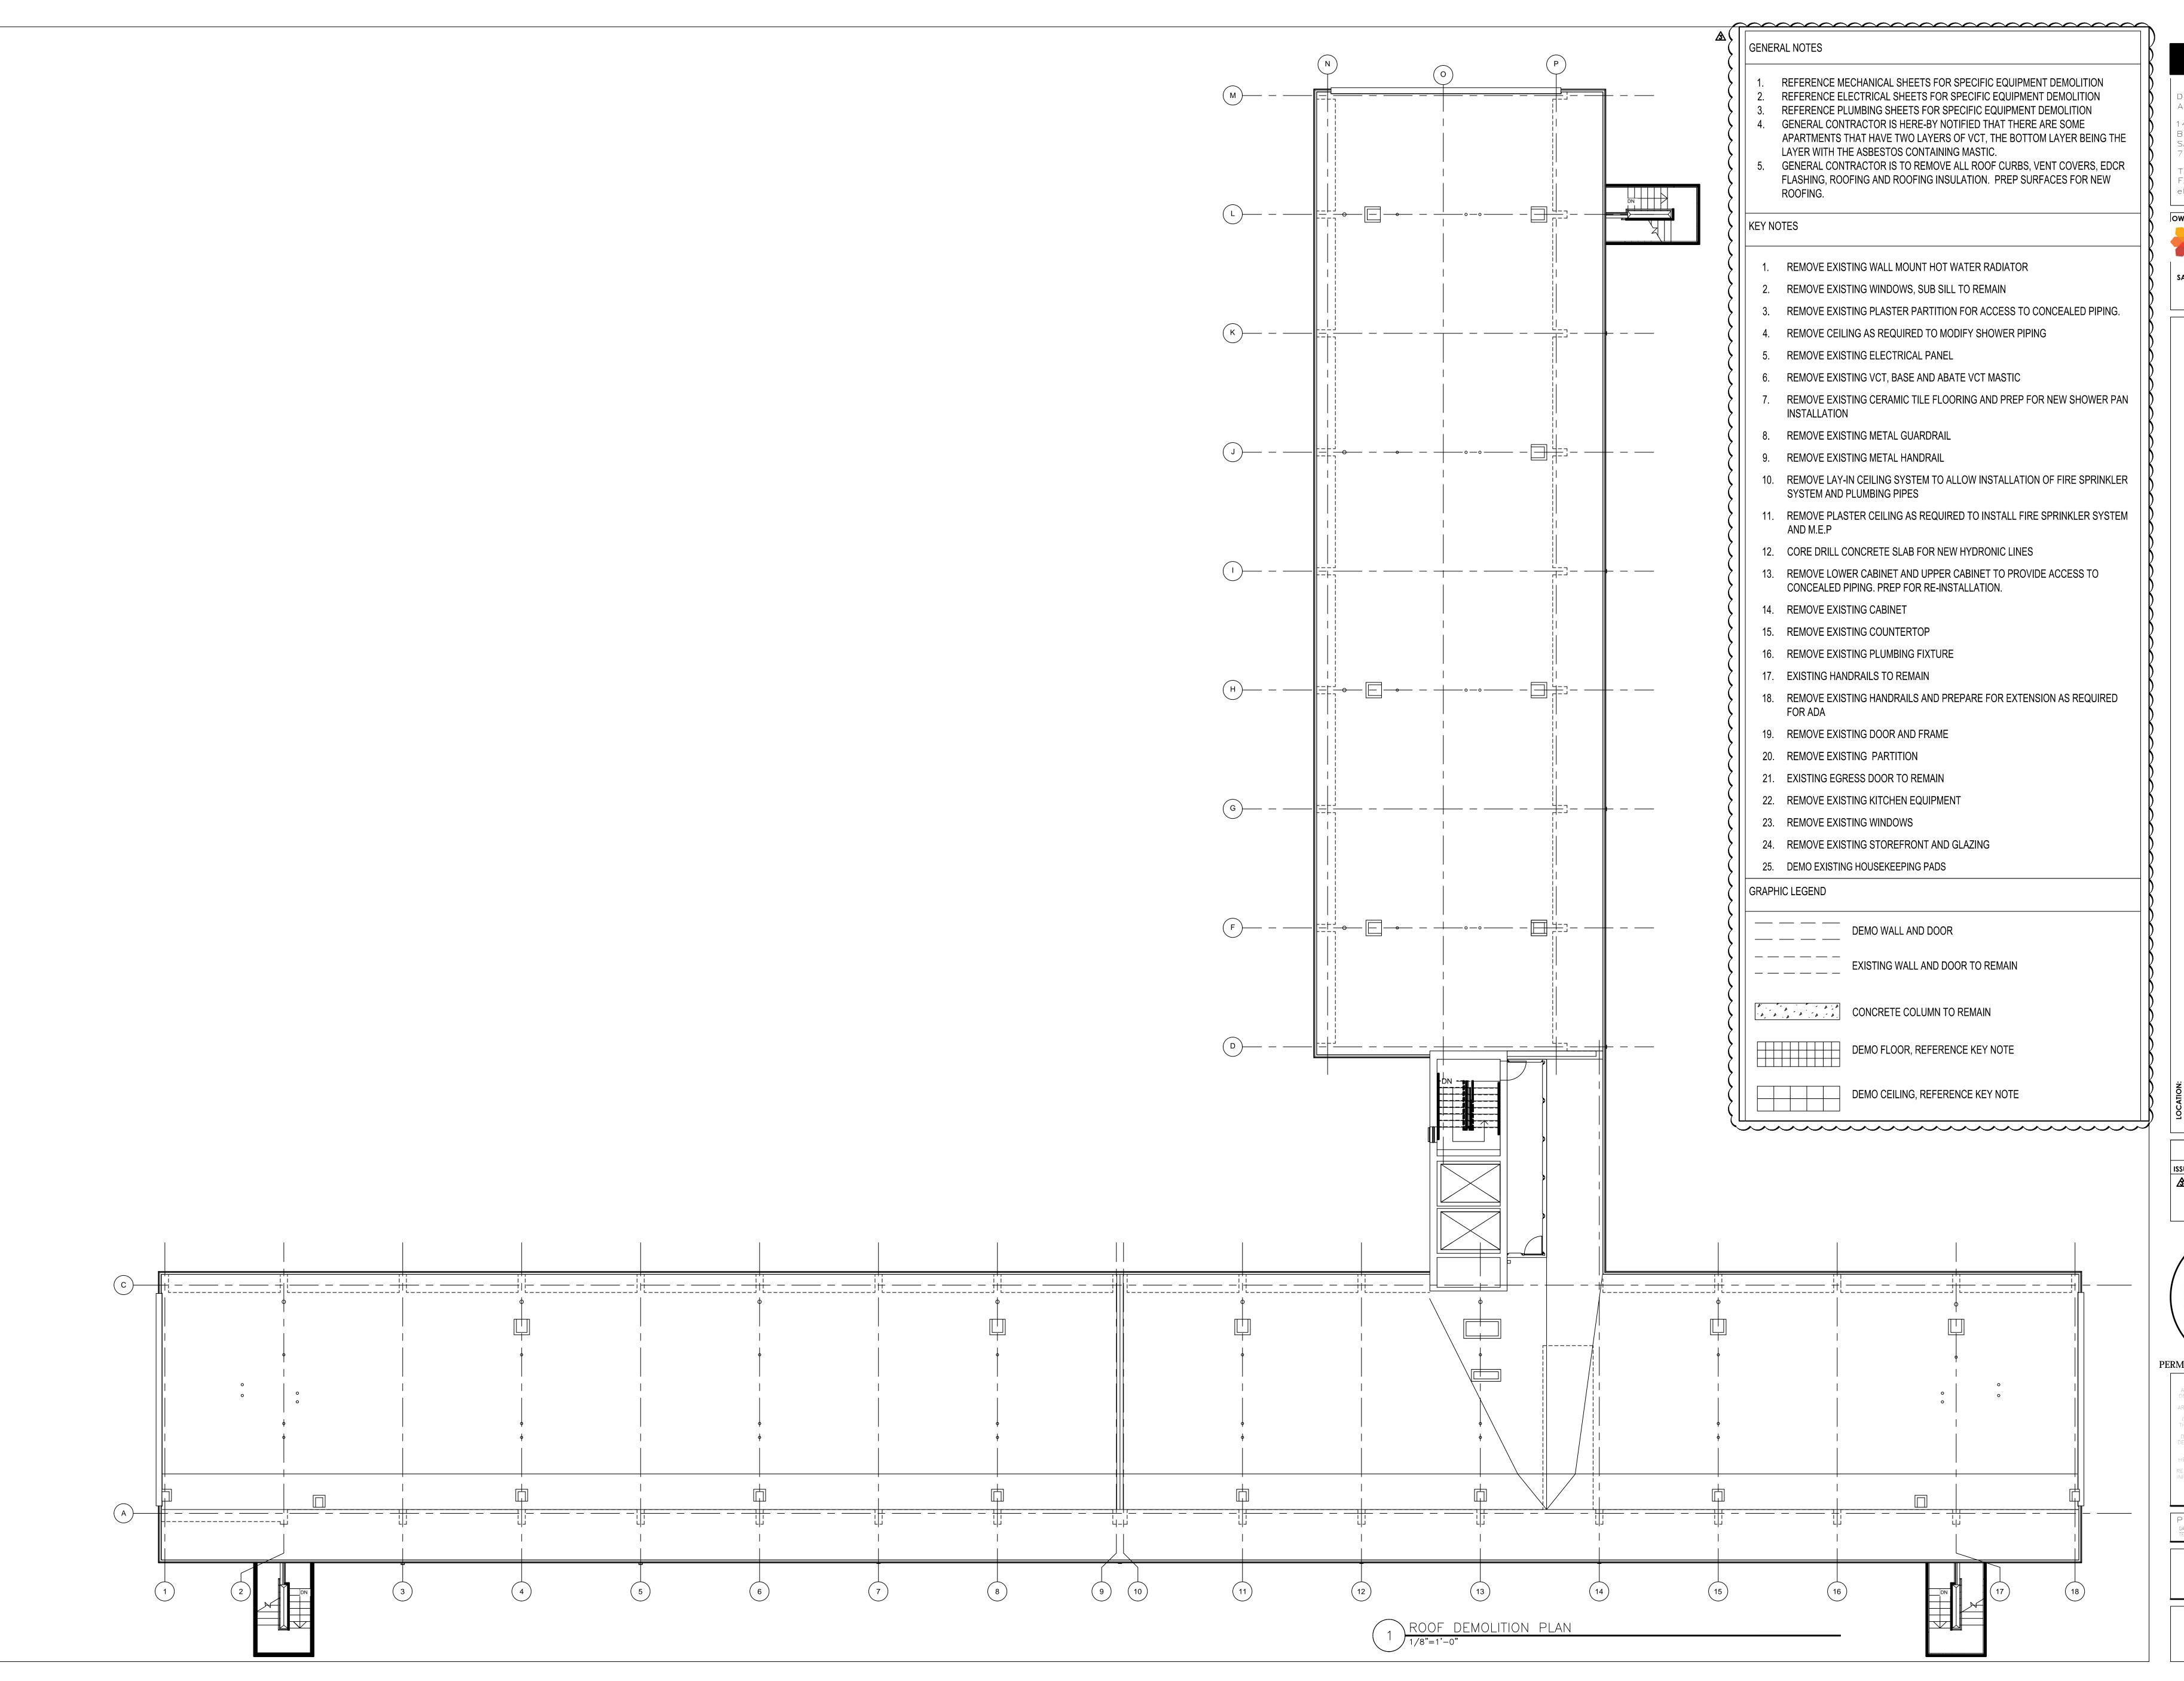
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2ND - 9TH FLOOR CEILING DEMOLITION





DURAND-HOLLIS RUPE ARCHITECTS, INC.

14603 HUEBNER ROAD BUILDING 18
SAN ANTONIO, TEXAS

TEL. 210 308-0080 FAX. 210 697-3309 eMAIL OFFICE@DHRARCHITECTS.COM



SAN ANTONIO HOUSING AUTHORITY 818 SOUTH FLORES STREET SAN ANTONIO, TX 78204

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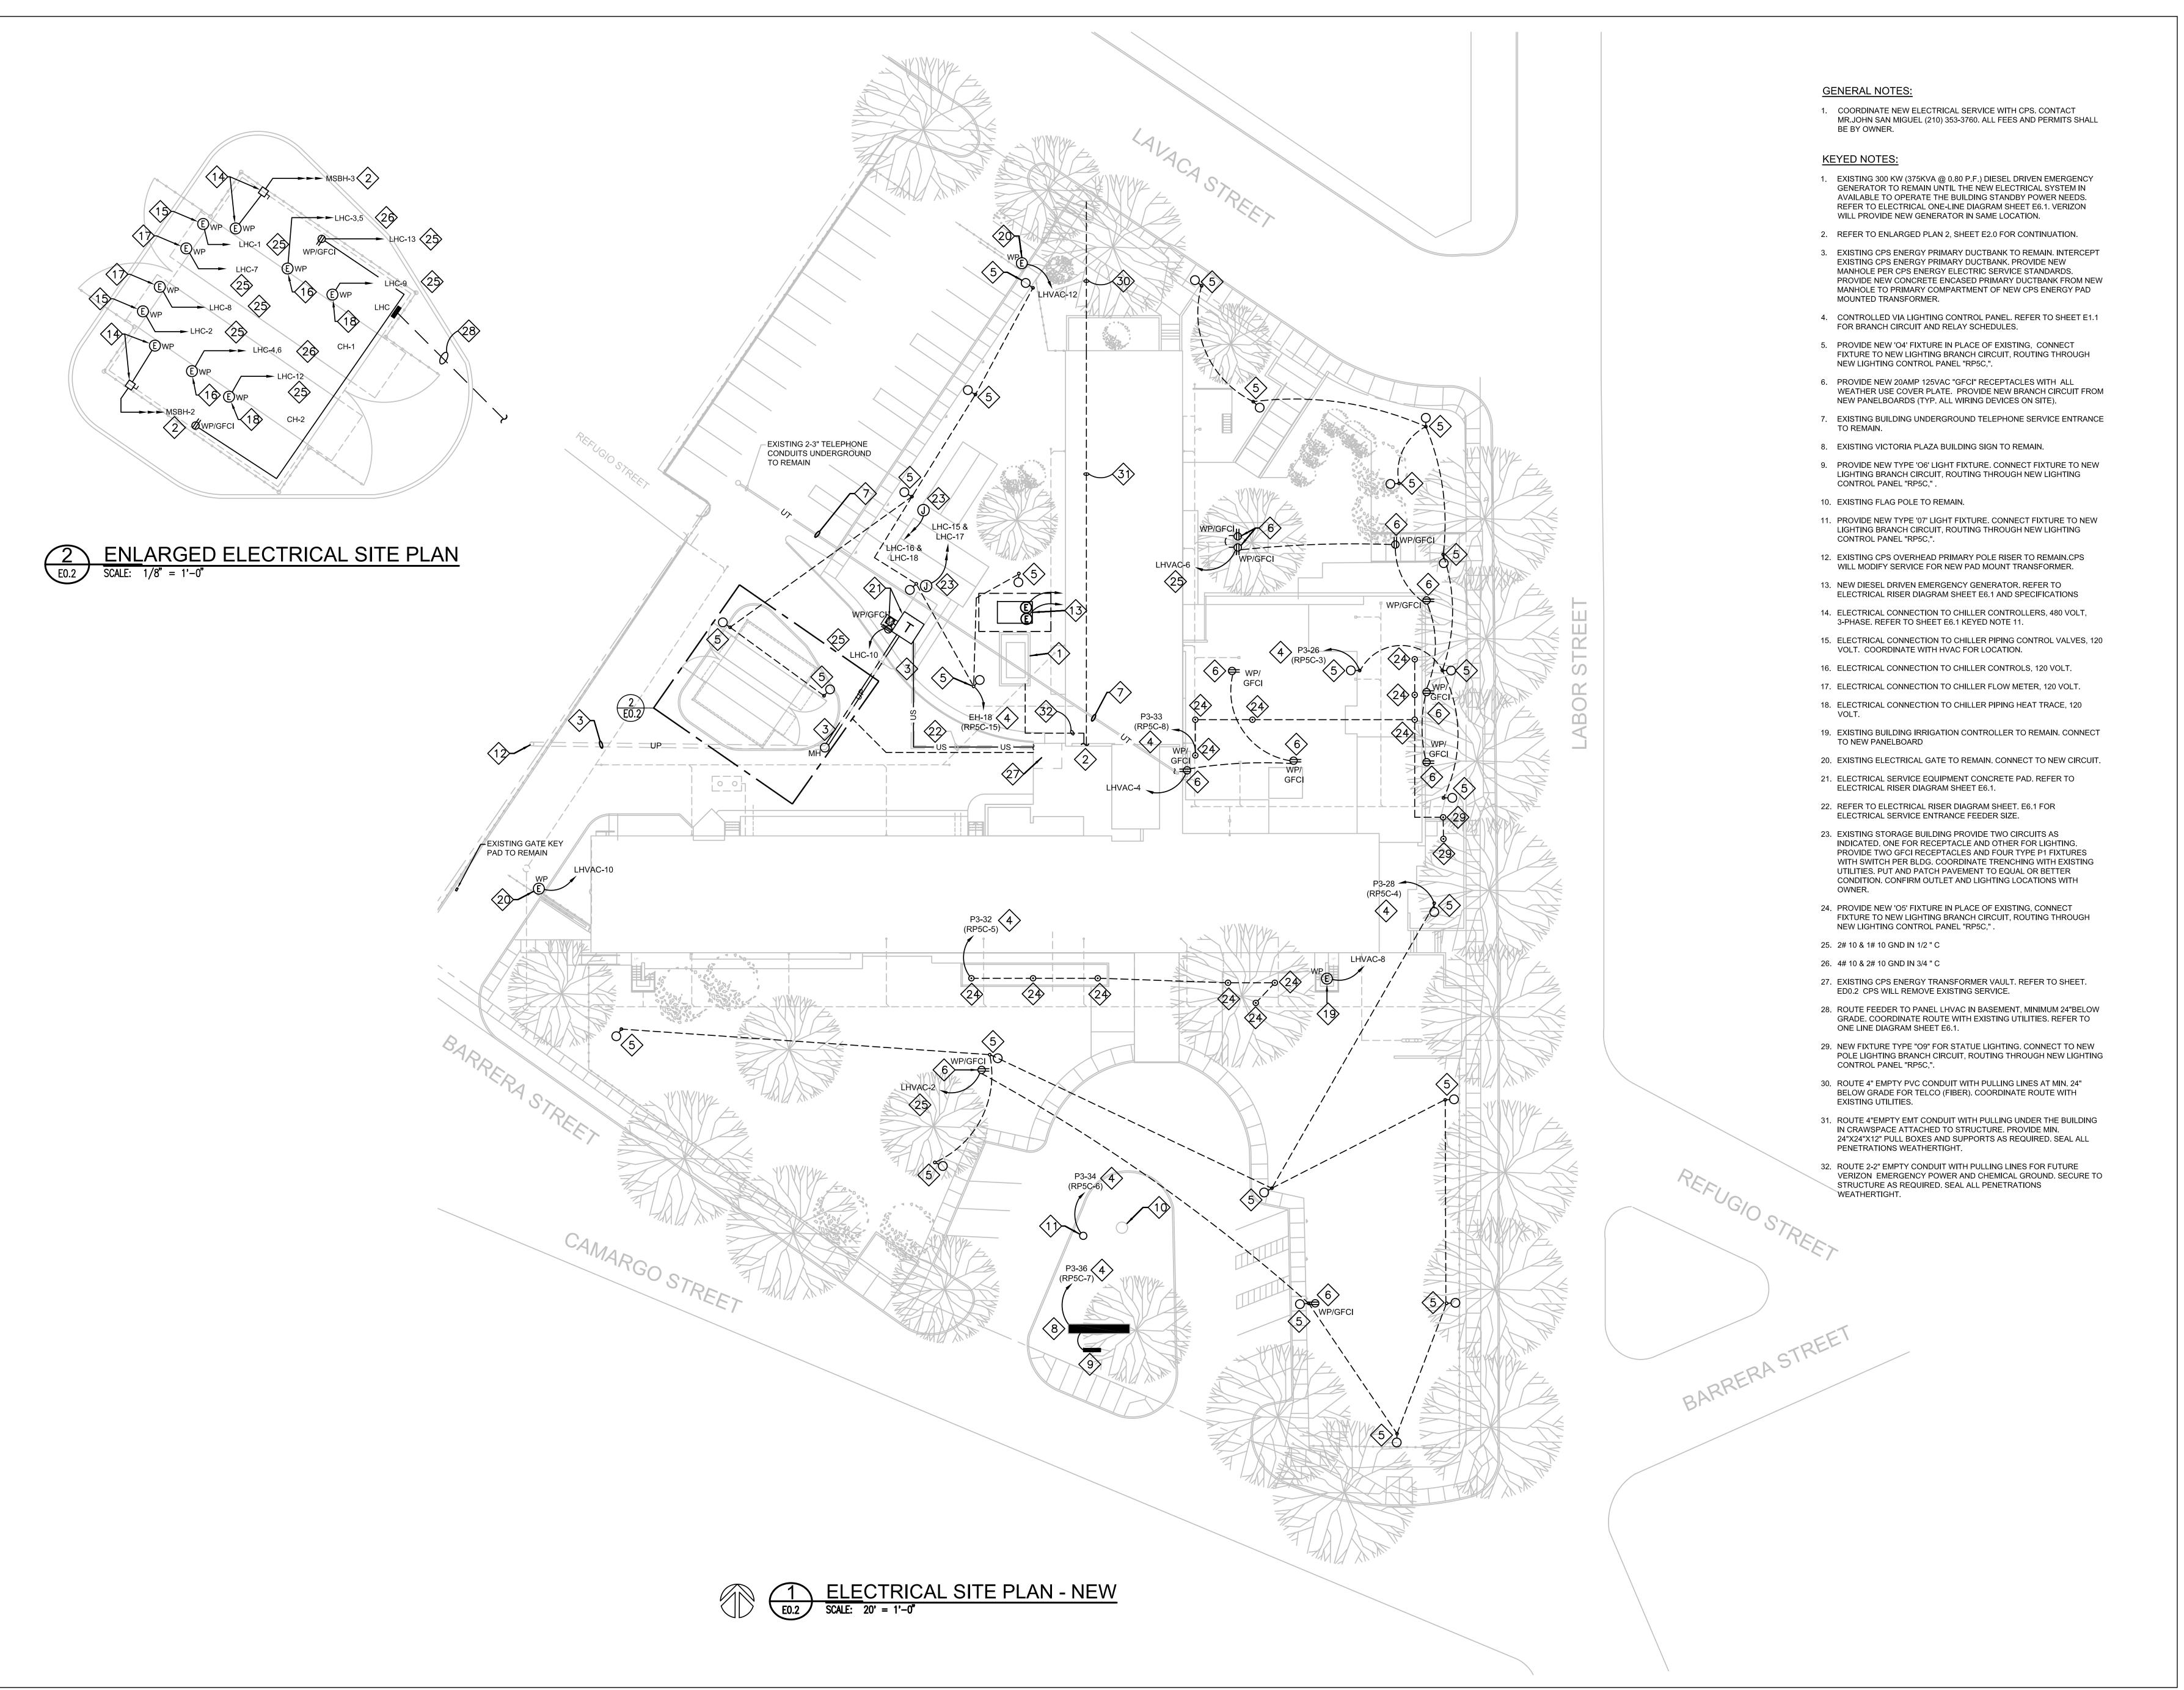
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ROOF DEMOLITION PLAN

SHEET NUMBER

D-105





ARCHITECTS, INC. 14603 HUEBNER ROAD BUILDING 18

SAN ANTONIO, TEXAS 78230

TEL. 210 308-0080 visionworks 210 524-6572 eMAIL a.trevino@dhrarchitects.com STOREDESIGN@ECCA.COM










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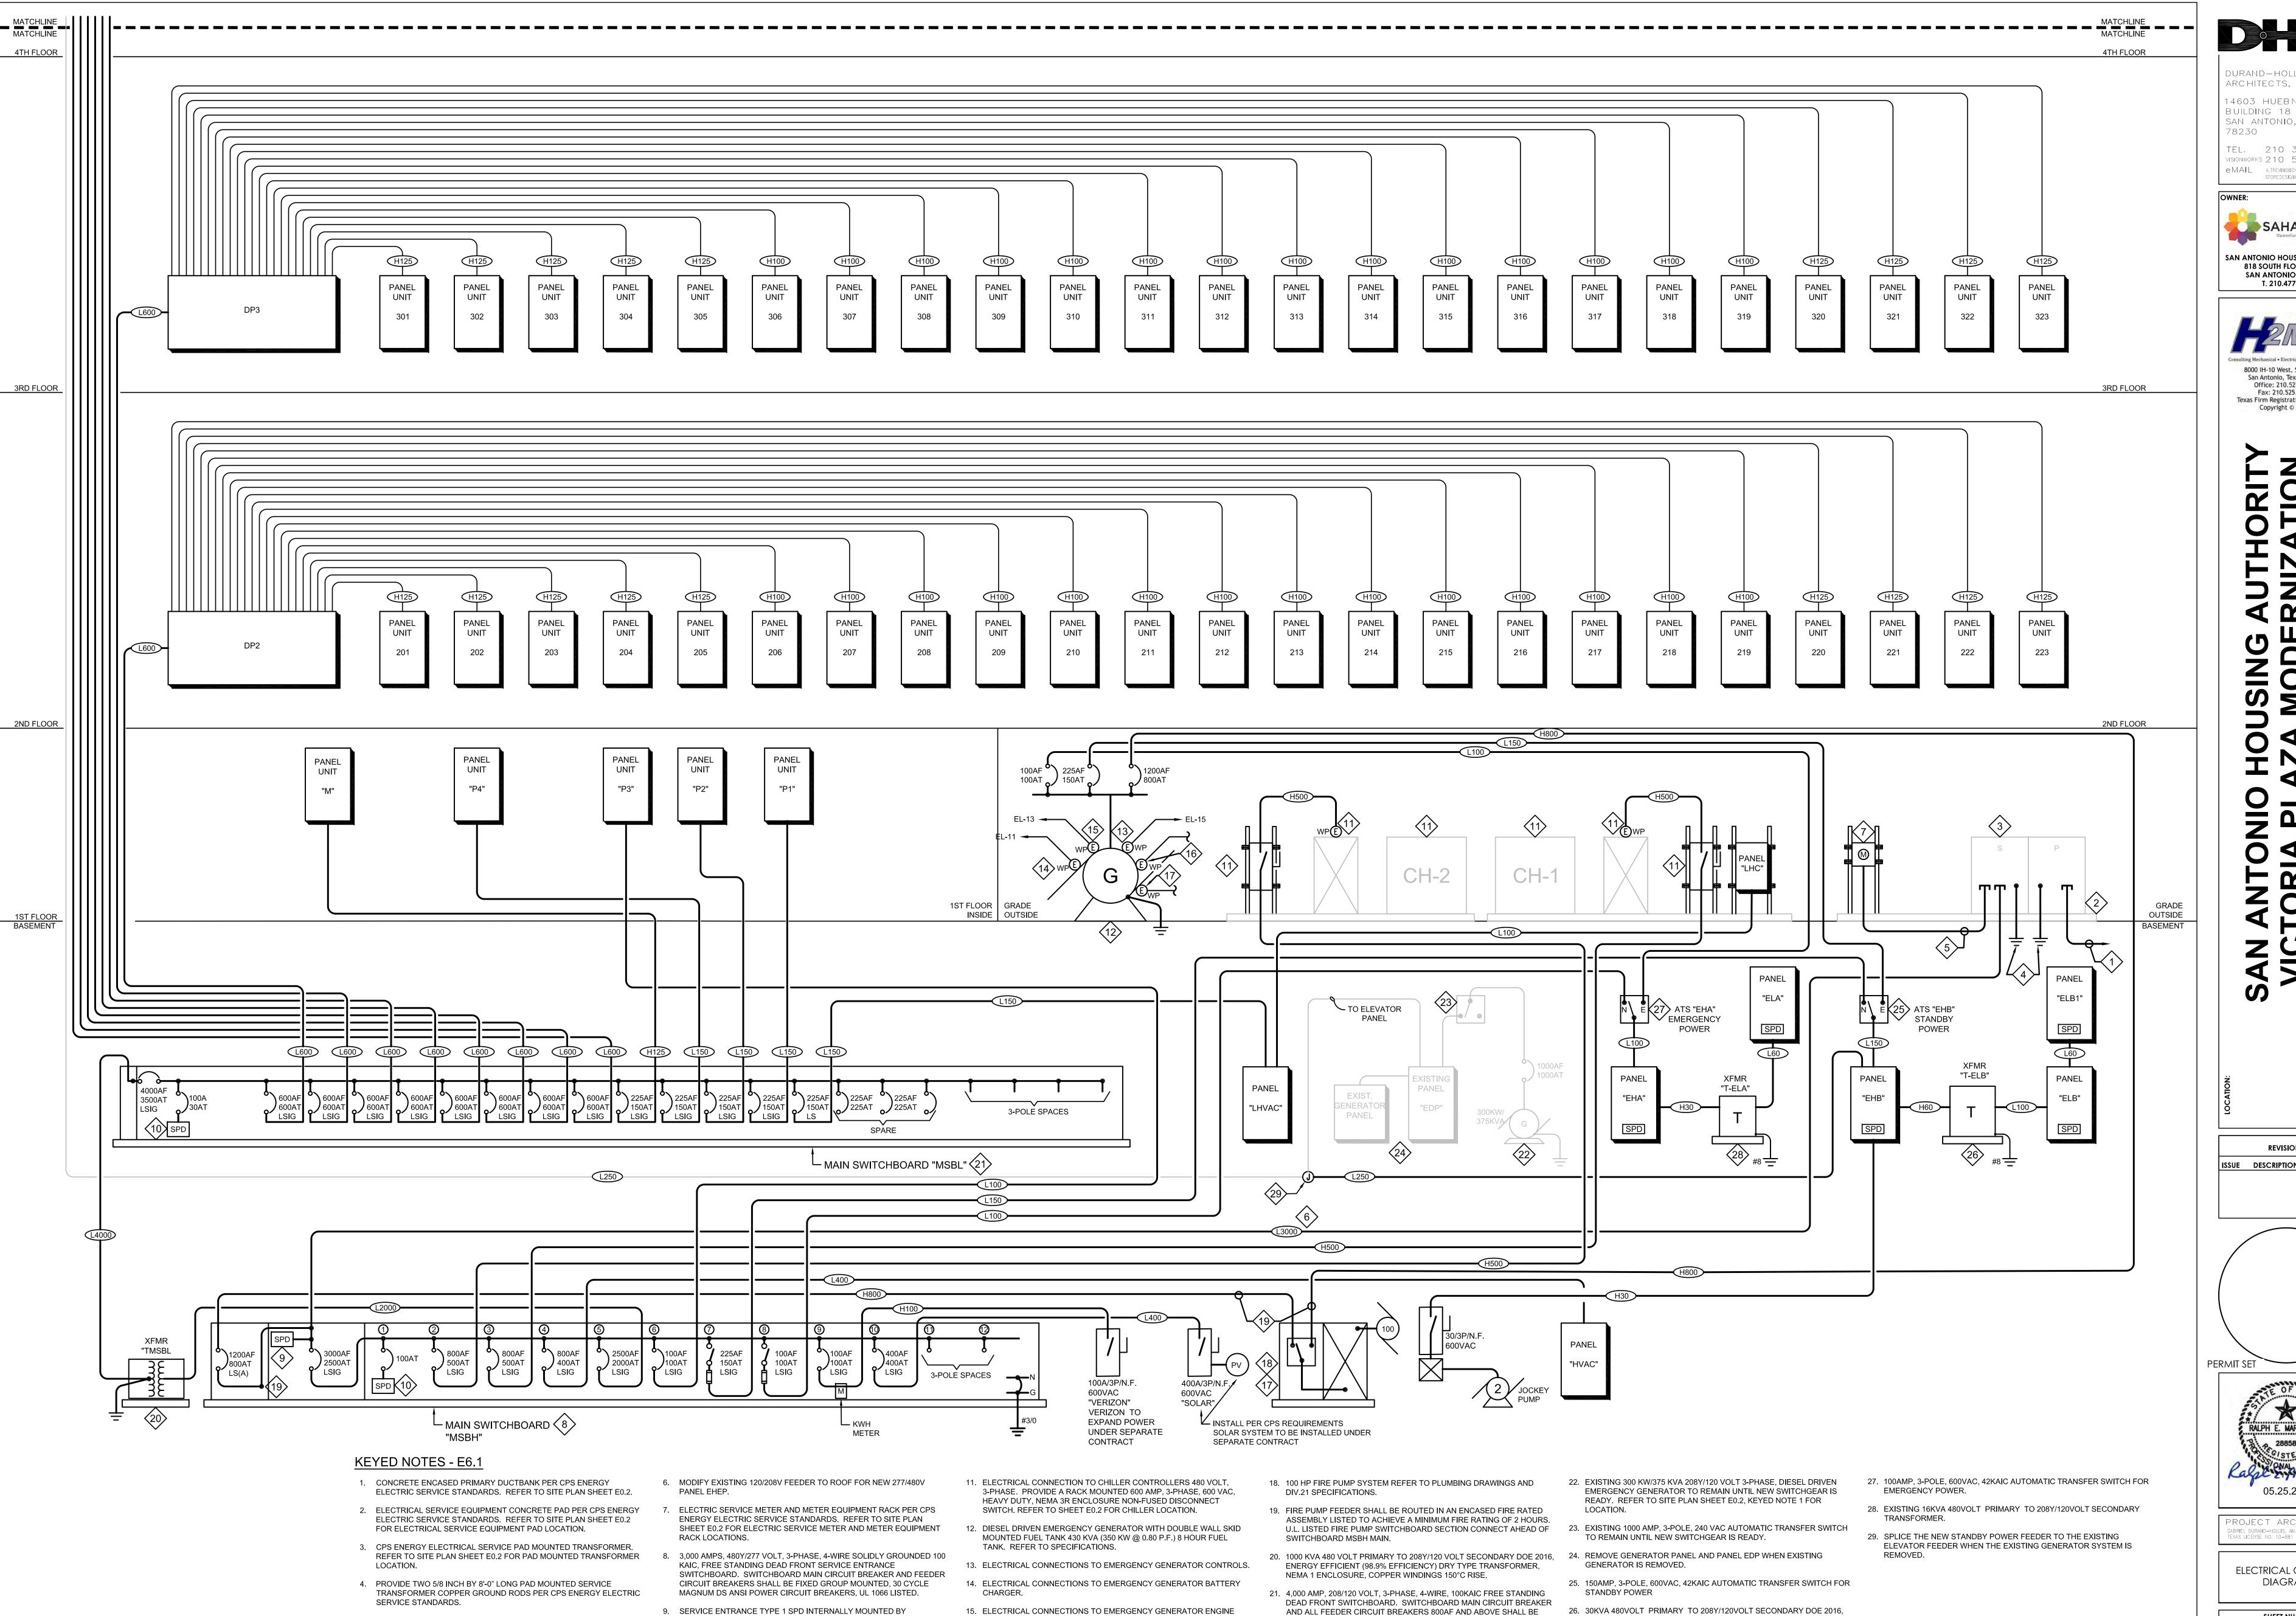
PERMIT SET 05/25/18



PROJECT ARCHITECT

SITE PLAN - NEW ELECTRICAL

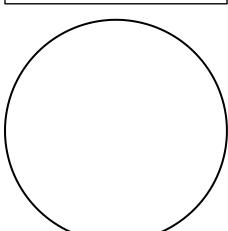E0.2



BLOCK HEATER.

EMERGENCY GENERATOR REMOTE ANNUNCIATOR PANEL LOCATED IN

THE BUILDING FIRE COMMAND CENTER ROOM.

10. TYPE 2 SPD INTERNALLY MOUNTED BY SWITCHGEAR MANUFACTURER. 16. ROUTE 2" C. FROM EMERGENCY GENERATOR CONTROL PANEL TO

EATON FIXED MOUNTED MAGNUM DS 30-CYCLE POWER CIRCUIT

ENERGY EFFICIENT DRY TYPE TRANSFORMER, NEMA 1 ENCLOSURE

COPPER WINDING 150° C RISE.

5. 2 INCH PVC SCHEDULE 40 CONDUIT FROM SERVICE TRANSFORMER

SHEET E0.2 FOR ELECTRICAL SERVICE METER LOCATION.

SECONDARY COMPARTMENT TO ELECTRICAL SERVICE METER PER

CPS ENERGY ELECTRIC SERVICE STANDARDS. REFER TO SITE PLAN

SWITCHGEAR MANUFACTURER.

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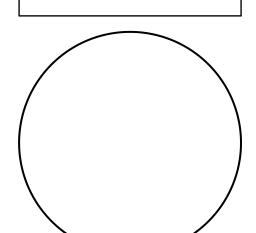
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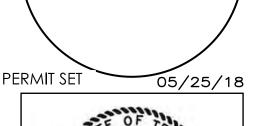


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San Antonio, Texas 78230
Office: 210.525.0220
Fax: 210.525.0225
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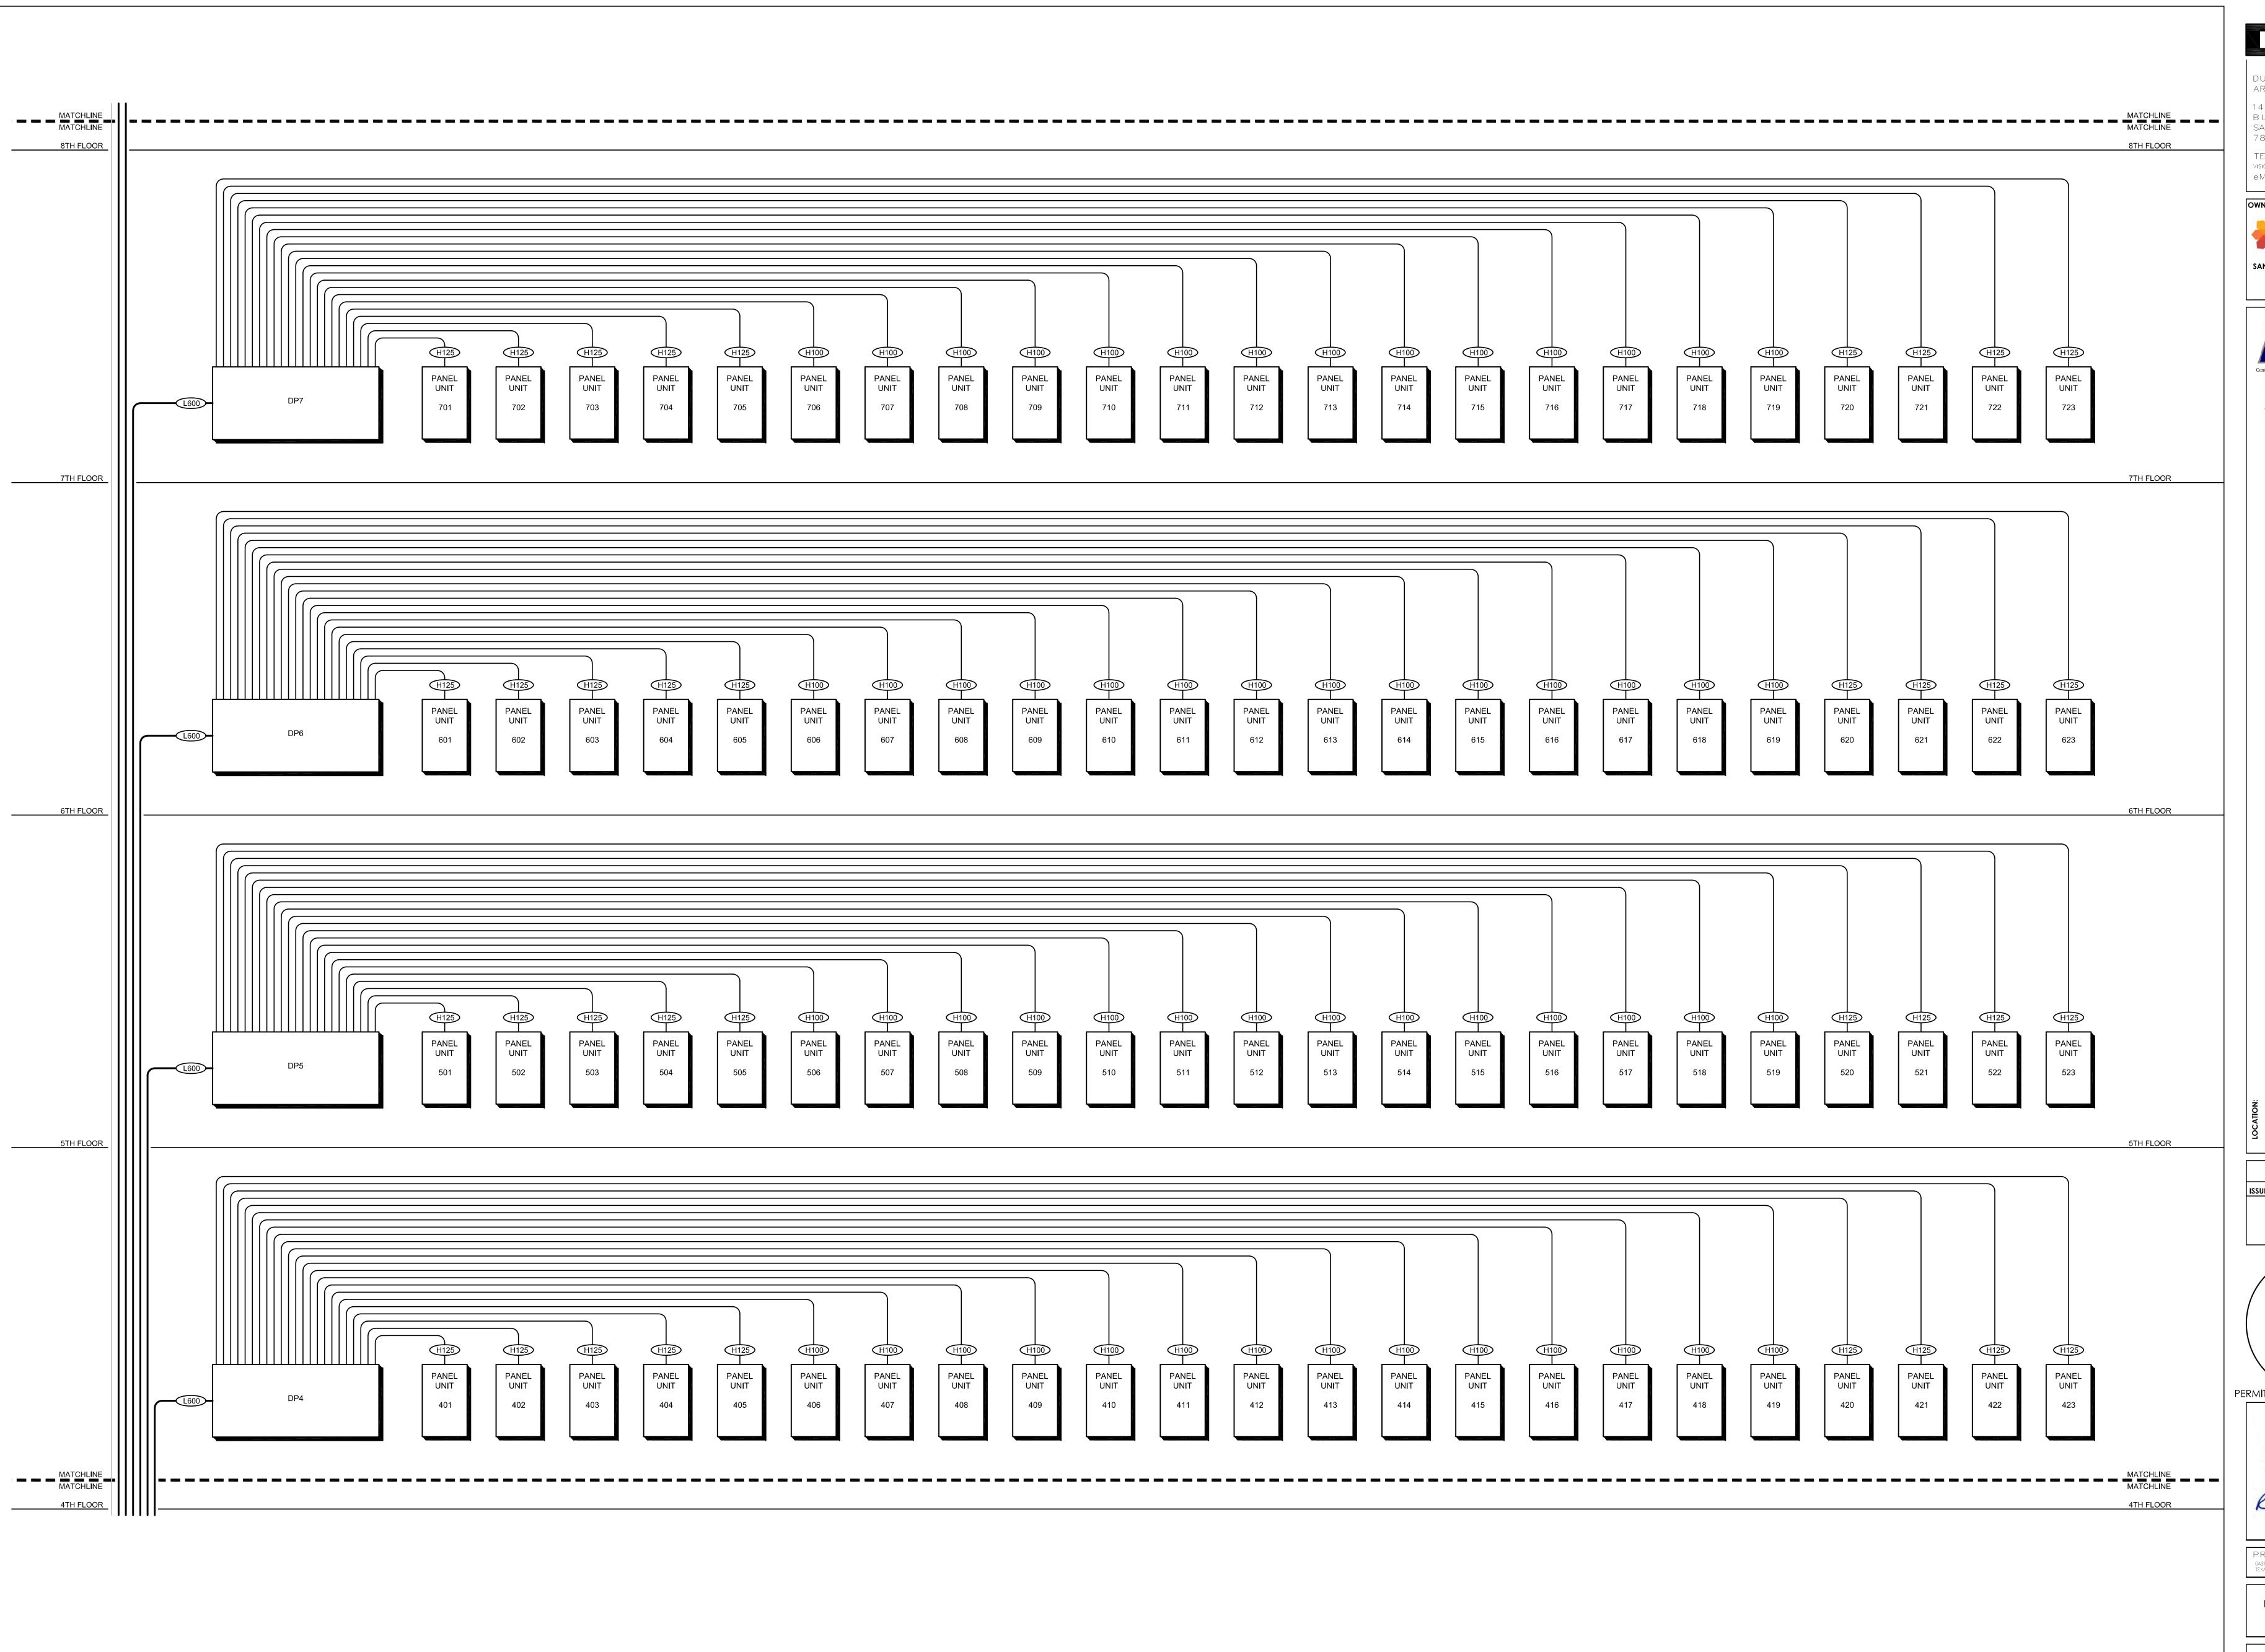




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ELECTRICAL ONE-LINE DIAGRAM

SHEET NUMBER





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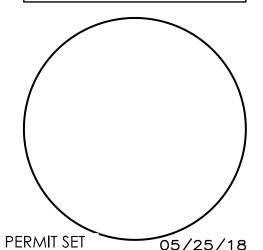
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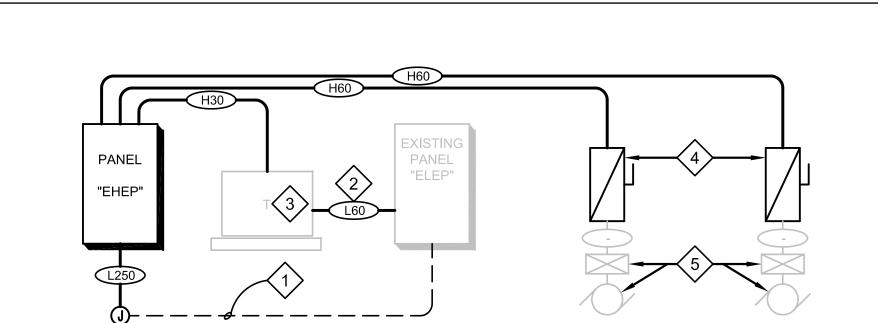




PROJECT ARCHITECT FEXAS LICENSE NO. 10-881

ELECTRICAL ONE-LINE DIAGRAM

> SHEET NUMBER E6.2




KEYED NOTES - E6.3

- 1. MODIFY EXISTING 208V FEEDER FROM EXISTING BASEMENT PANEL EDP TO EXISTING PANEL ELEP TO BECOME 480V FEEDER FROM NEW
- PANEL EH IN BASEMENT TO NEW PANEL EHEP. 2. EXISTING PANELBOARD TO REMAIN. MODIFY 208V FEEDER FROM

16KVA TRANSFORMER TO PANEL ELEP.

- 3. REUSE EXISTING 16KVA TRANSFORMER. 480V-120/208V, 3PH, 4W. PROVIDE NEW FEEDERS.
- 4. PROVIDE BUSSMAN #PS-6-T48-RX-K-G-N6-B-F1-U ELEVATOR POWER MODULE SWITCH WITH 60AMP DUAL ELEMENT FUSES FOR ELEVATOR MACHINE POWER. PROVIDE 2 N.O. AND 2 N.C. CONTACTS INTERLOCK WITH FACP PER ANI 17.1.
- UNDER A SEPARATE CONTRACT, THE 15HP, 480VOLT ELEVATOR MOTORS AND ELEVATOR CONTROLLER WILL BE REPLACED WITH NEW 15HP, 480VOLT MOTORS. CONNECT NEW ELEVATOR CONTROL MOTORS TO NEW PANEL EHEP.

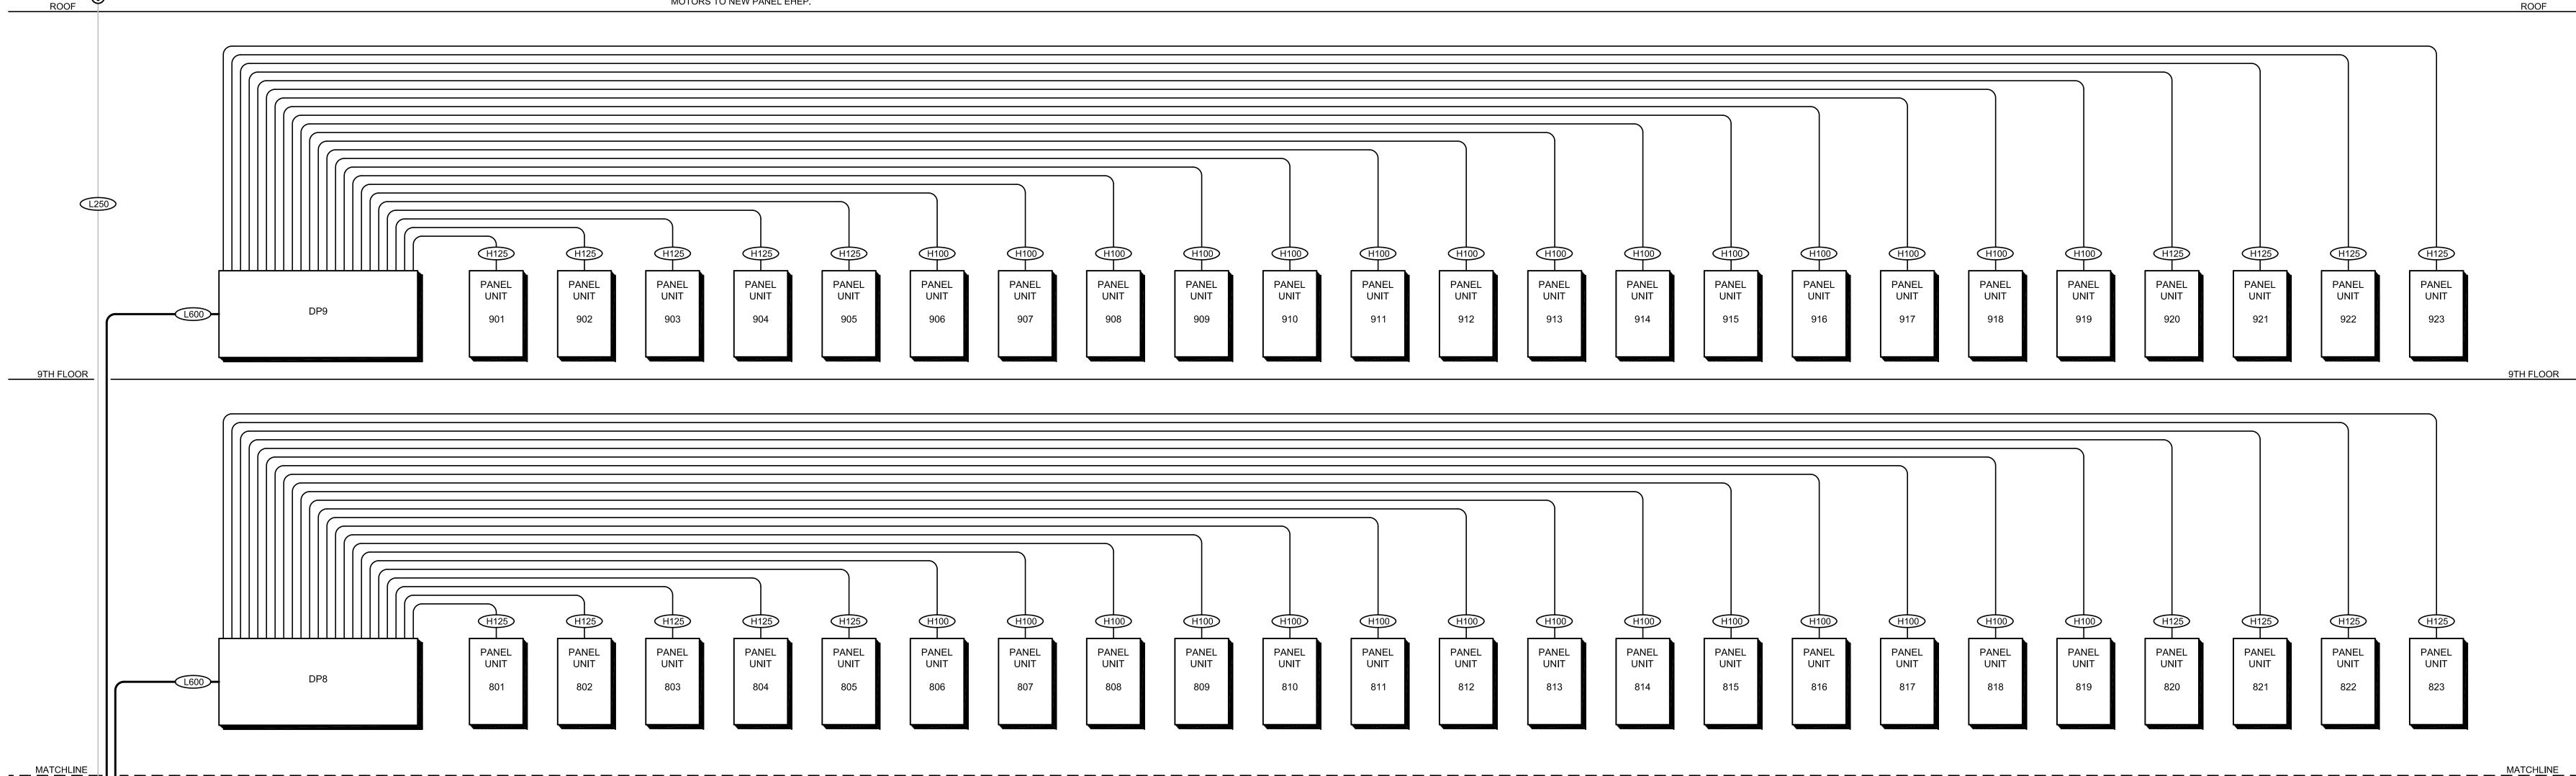

oad Description		Connected Load (KVA)	Demand Factor %	<u>Demand</u> Load (KVA)
1. Lighting load:		22.6	100.00%	22.6
2. Building apartments load:		2925.5	23.00%	672.9
3. Laundry equipment load:				
	a. Dryers 18 x 5 KW = 90 KVA	80.0	47.00%	37.6
	(NEC Table 220.54)			
	b. Washers 18 x 1.5 KW = 27 KVA	24.0	100.00%	24.0
4. HVAC equipment load:	21.111			
	a. Chillers 2 – 220 tons at 50%	F20.0	FO 000/	264.0
	capacity each 440 tons x 1.2	528.0	50.00%	264.0
	KVA/ton:			
	b. Primary pumps	12.6	100.00%	12.6
	(2) x 5 HP/ea			
	c. Secondary pumps 2-pumps	42.0	50.000/	24.4
	(redundant)	42.8	50.00%	21.4
	2 x 20 HP/ea			
	d. Exhaust fan	2.4	100.00%	2.4
	1 x 1 ½ HP			
	e. Existing hot water pumps (2) x	42.8	60.00%	25.7
	20 HP/ea			
	f. New AHU's			
	3 x 10 HP = 34.9 KVA	34.9	100.00%	34.9
5. Plumbing equipment load:				
5. Frambling equipment load.	a. Booster pumps			
	(2) x 5 HP/ea	12.6	100.00%	12.6
	b. Existing pumps:			
	(1) \times 5 HP = 6.0			
	$(1) \times 3117 = 0.0$ $(1) \times 10 \text{ HP} = 11.1$	19.5	100.00%	19.5
	$(1) \times 10^{11} = 11.1$ $(1) \times 1 \frac{1}{2} \text{ HP} = 2.4$		100.0070	13.3
	19.5 KVA			
	c. Existing sumps			
	(2) x 1½ HP	2.4	50.00%	1.2
	d. Existing lift station			
	(1) x 5 HP	6.0	100.00%	6.0
6. Existing elevators	(4) (3) (1)			
(2) x 15 HP/ea		34.9	75.00%	26.2
7. Fire protection (*) note				
	a. Fire pump			
	1 x 100 HP = 98.3 KVA			
	b. Jockey pump	101.1	100.00%	101.1
	1 x 2 HP = 2.8			
	101.1			
8. Misc. Future Loads		250.0	60.00%	150.0
0. 350/				
9. 25% largest motor 100 HP = 98.3 KVA x 0.25		24.6	100.00%	24.6
		4400 71014	35.00%	1450 210 / 4
Totals		4166.7 KVA	35.00%	1459.2 KVA

E6.3 SCALE: NOT TO SCALE

* NOTE: FIRE PUMP WILL BE CONNECTED AHEAD OF THE MAIN.

THEREFORE PROVIDE A 2,500 AMP, 480Y/277 VOLT, 3-PHASE,

1 SWITCHBOARD = <u>1,545 KVA</u>= 1859 AMP

4-WIRE SOLIDLY GROUNDED SWITCHBOARD.

lectrical Design Load Summary		First Floor 2 Bedroom Apartme	<u>ent</u>		Building Apartment Loads			
ote: Approximate area per apt. unit = 400 ft2		Electrical Design Load Summary			184 apartment units x 15.80 KVA / apt =	2,907.20 KV		
oad Description: Lighting and receptacle loads (per NEC Table 220.12 and 220.14d)	Note: Approximate area per apt. unit = 9	90 ft2	(1) first floor 2 bedroom apt x 18.27 KVA =Total Connected Load Apartment Load =	18.27 KVA 2,925.47 KVA				
	1.2 KV/A	<u>Load Description:</u> 1. Lighting and receptacle loads		Connected Load (KVA)	Total Building Apartment Demand Load			
400 ft2 x 3.0 watt/ft2 = 1,200 v	watt 1.2 KVA	(per NEC Table 220.12 and 220.14d)			(per NEC Table 220.84)			
. Small appliances load (per NEC 210.52.(B)(1))		000 ft2 2 0	2.070	2.07.1074	2,928.47 KVA x 23% =	672.86 KVA		
2 appliances x 1,500 watt/appliance = 3,000 v	watt 3.0 KVA	990 ft2 x 3.0 watt/ft2 =	2,970 watt	2.97 KVA	Total Building Apartment Demand Load =	672.86 KVA		
Bathroom branch circuit (heat lamp)	watt 5.0 KVA	2. Small appliances load (per NEC 210.52.(B)(1))						
1 ckt x 1,500 watt/ckt = 1,500 v	watt 1.5 KVA	2 appliances x 1,500 watt/appliance =	3,000 watt	3.0 KVA				
. Kitchen range		3. Bathroom branch circuit (heat lamp)						
1 range x 8,000 watt/range = 8,000 v	watt 8.0 KVA	1 ckt x 1,500 watt/ckt =	1,500 watt	1.5 KVA				
. HVAC equipment load (3) - FCU @ 5.8 amp/ea @120V		4. Kitchen range						
(3) (5.8A) x 120 Volt = 2,088 v	watt <u>2.10 KVA</u>	1 range x 8,000 watt/range =	8,000 watt	8.0 KVA				
otal Connected Load / Apt Unit	15.80 KVA	5. HVAC equipment load						
Service / Apt = 15.8 KVA/208 V, 1-Phase =	(4) - FCU @ 5.8 amp/ea @120 V							
herefore provide a 100 amp, 120/208 volt, 1-pha: partment.	er (4) 5.8 amp x 120 V =	2,784 watt	2.8 KVA					
otes:	Total Connected Load / Apt Unit		18.27 KVA					
here are no dishwashers, disposals, laundry equippartment units.	the I Service / Apt = 18.27 KVA / 208 V, 1-Pha	I Service / Apt = 18.27 KVA / 208 V, 1-Phase = 87.4 amps						

DURAND—HOLLIS RUPE ARCHITECTS, INC. 14603 HUEBNER ROAD BUILDING 18 SAN ANTONIO, TEXAS 78230

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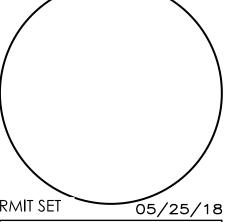
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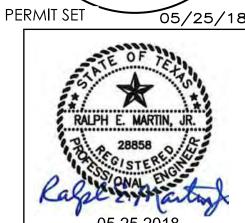
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411 BARRERA, SA

8TH FLOOR

REVISIONS





PROJECT ARCHITECT TEXAS LICENSE NO. 10-881

ELECTRICAL ONE-LINE DIAGRAM AND LOAD ANALYSIS

SHEET NUMBER

		COPPER FEEDER	RSCH	EDULE
AMPERE RATING	FEEDER ID	3-WIRE WITH GROUND	FEEDER ID	4-WIRE WITH GROUND
30A	(H30)	3#10, 1#10 GND IN 1/2" C.	L30	4#10, 1#10 GND IN 1/2" C.
40A	H40	3#8, 1#10 GND IN 3/4" C.	L40	4#8, 1#10 GND IN 3/4" C.
60A	H60	3#4, 1#10 GND IN 1" C.	L60	4#4, 1#10 GND IN 1-1/4" C.
70A	H70	3#4, 1#8 GND IN 1" C.	L70	4#4, 1#8 GND IN 1-1/4" C.
80A	(H80)	3#3, 1#8 GND IN 1-1/4" C.	L80	4#3, 1#8 GND IN 1-1/4" C.
100A	(H100)	3#1, 1#8 GND IN 1-1/2" C.	L100	4#1, 1#8 GND IN 1-1/2" C.
125A	H125	3#1, 1#6 GND IN 1-1/2" C.	L125	4#1, 1#6 GND IN 2" C.
150A	H150	3#1/0, 1#6 GND IN 2" C.	L150	4#1/0, 1#6 GND IN 2" C.
175A	H175	3#2/0, 1#6 GND IN 2" C.	L175	4#2/0, 1#6 GND IN 2" C.
200A	H200	3#3/0, 1#6 GND IN 2" C.	(1200)	4#3/0, 1#6 GND IN 2" C.
225A	H225	3#4/0, 1#4 GND IN 2-1/2" C.	(1225)	4#4/0, 1#4 GND IN 2-1/2" C.
250A	H250	3#250KCMIL, 1#4 GND IN 2-1/2" C.	<u> </u>	4#250KCMIL, 1#4 GND IN 3" C.
300A	H300	3#350KCMIL, 1#4 GND IN 3" C.	L300	4#350KCMIL, 1#4 GND IN 3-1/2" C.
350A	H350	2-SETS OF 3#2/0, 1#3 GND IN 2" C. EACH	L350	2-SETS OF 4#2/0, 1#3 GND IN 2-1/2" C. EACH
400A	(H400)	2-SETS OF 3#3/0, 1#3 GND IN 2" C. EACH	L400	2-SETS OF 4#3/0, 1#3 GND IN 2-1/2" C. EACH
500A	(H500)	2-SETS OF 3#250KCMIL, 1#2 GND IN 2-1/2" C. EACH	L500	2-SETS OF 4#250KCMIL, 1#2 GND IN 3" C. EACH
600A	H600	2-SETS OF 3#350KCMIL, 1#1 GND IN 3-1/2" C. EACH	L600	2-SETS OF 4#350KCMIL, 1#1 GND IN 3-1/2" C. EACH
700A	H700	3-SETS OF 3#250KCMIL, 1#1/0 GND IN 3" C. EACH	<u> </u>	3-SETS OF 4#250KCMIL, 1#1/0 GND IN 3-1/2" C. EACH
800A	(H800)	3-SETS OF 3#300KCMIL, 1#1/0 GND IN 3" C. EACH	L800	3-SETS OF 4#300KCMIL, 1#1/0 GND IN 3-1/2" C. EACH
1000A	(H1000)	3-SETS OF 3#400KCMIL, 1#2/0 GND IN 3-1/2" C. EACH	(L1000)	3-SETS OF 4#400KCMIL, 1#2/0 GND IN 3-1/2" C. EACH
1200A	(H1200)	4-SETS OF 3#350KCMIL, 1#3/0 GND IN 3-1/2" C. EACH	(L1200)	4-SETS OF 4#350KCMIL, 1#3/0 GND IN 3-1/2" C. EACH
1600A	(H1600)	5-SETS OF 3#400KCMIL, 1#4/0 GND IN 3-1/2" C. EACH	(L1600)	5-SETS OF 4#400KCMIL, 1#4/0 GND IN 3-1/2" C. EACH
2000A	H2000	6-SETS OF 3#400KCMIL, 1#250KCMIL GND IN 3-1/2" C. EACH	(L2000)	6-SETS OF 4#400KCMIL, 1#250KCMIL GND IN 4" C. EACH
			L3000	8-SETS OF 4#500KCMIL, IN 4" C. EACH
			<u>(14000)</u>	10 SETS: 4 #600 KCMIL, 1 #500 KCMIL GND. EACH IN 5"C.



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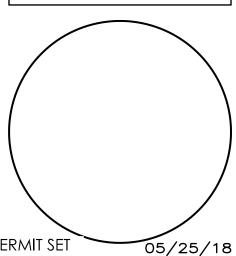


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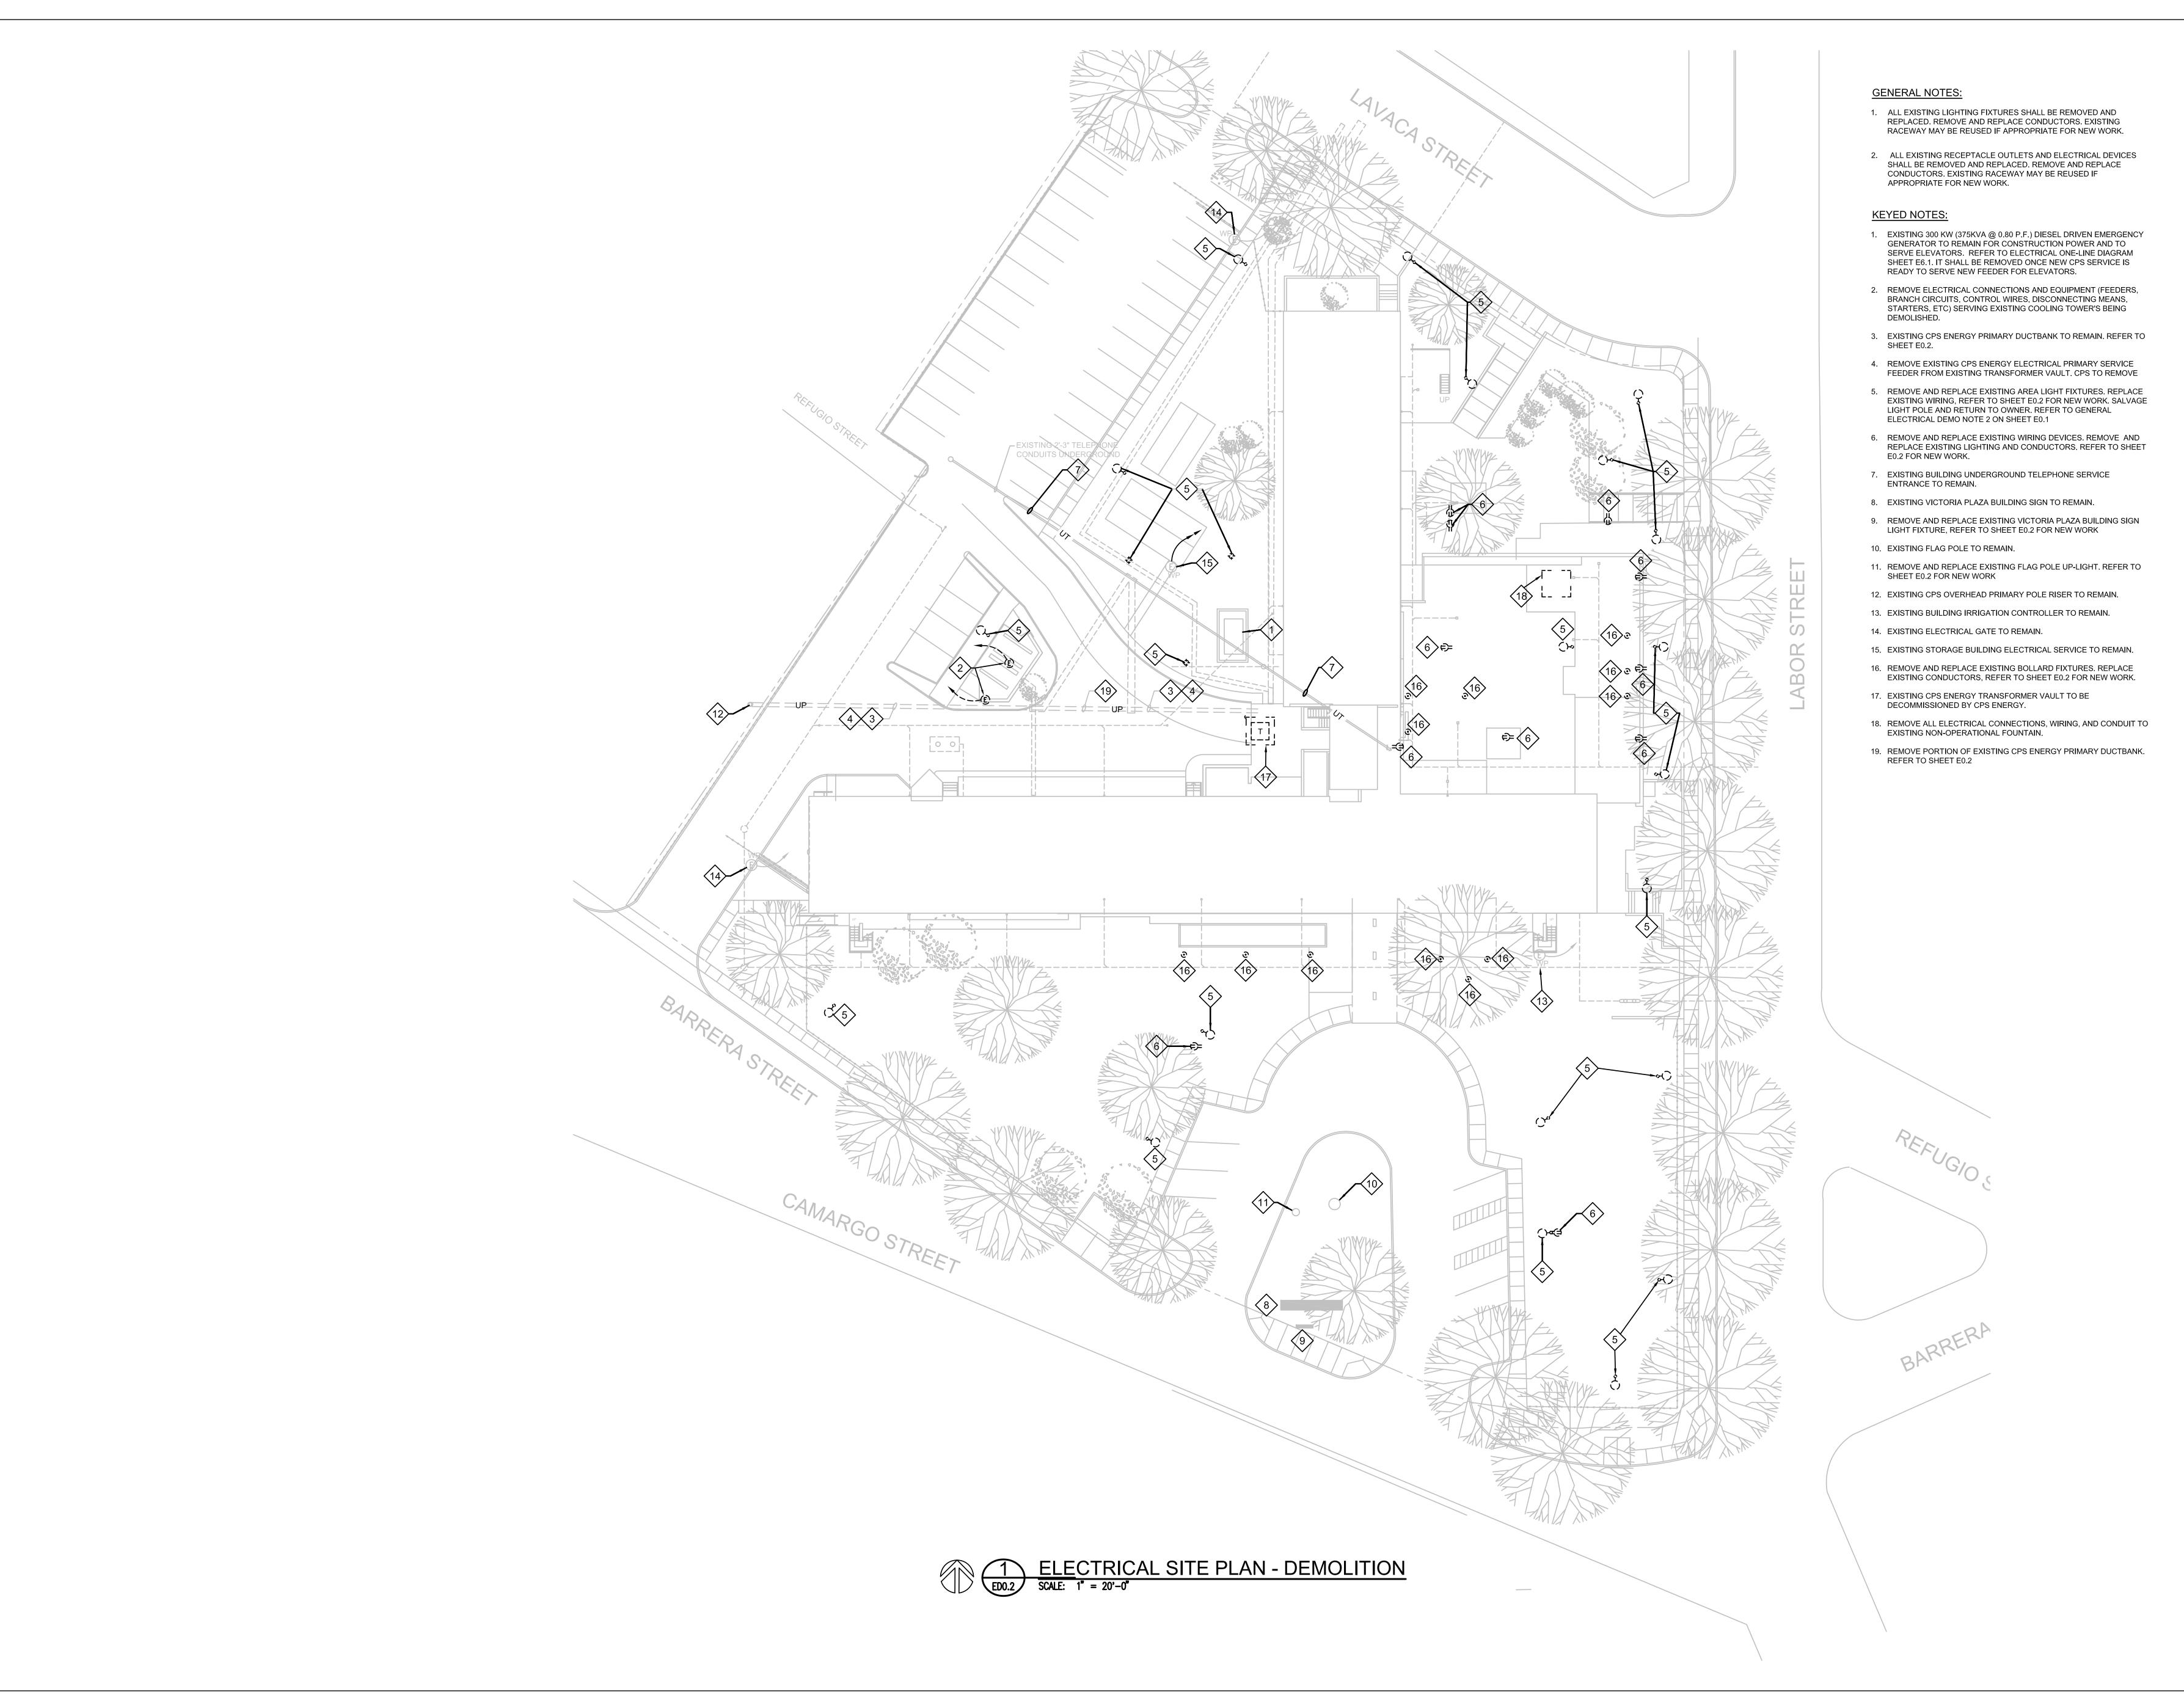


PROJECT ARCHITECT

GABRIEL DURAND-HOLLIS, AIA
TEXAS LICENSE NO. 10-881

ELECTRICAL ONE-LINE DIAGRAM

SHEET NUMBER





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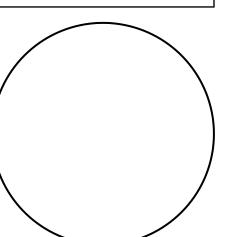
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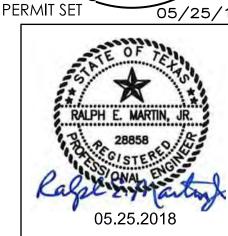


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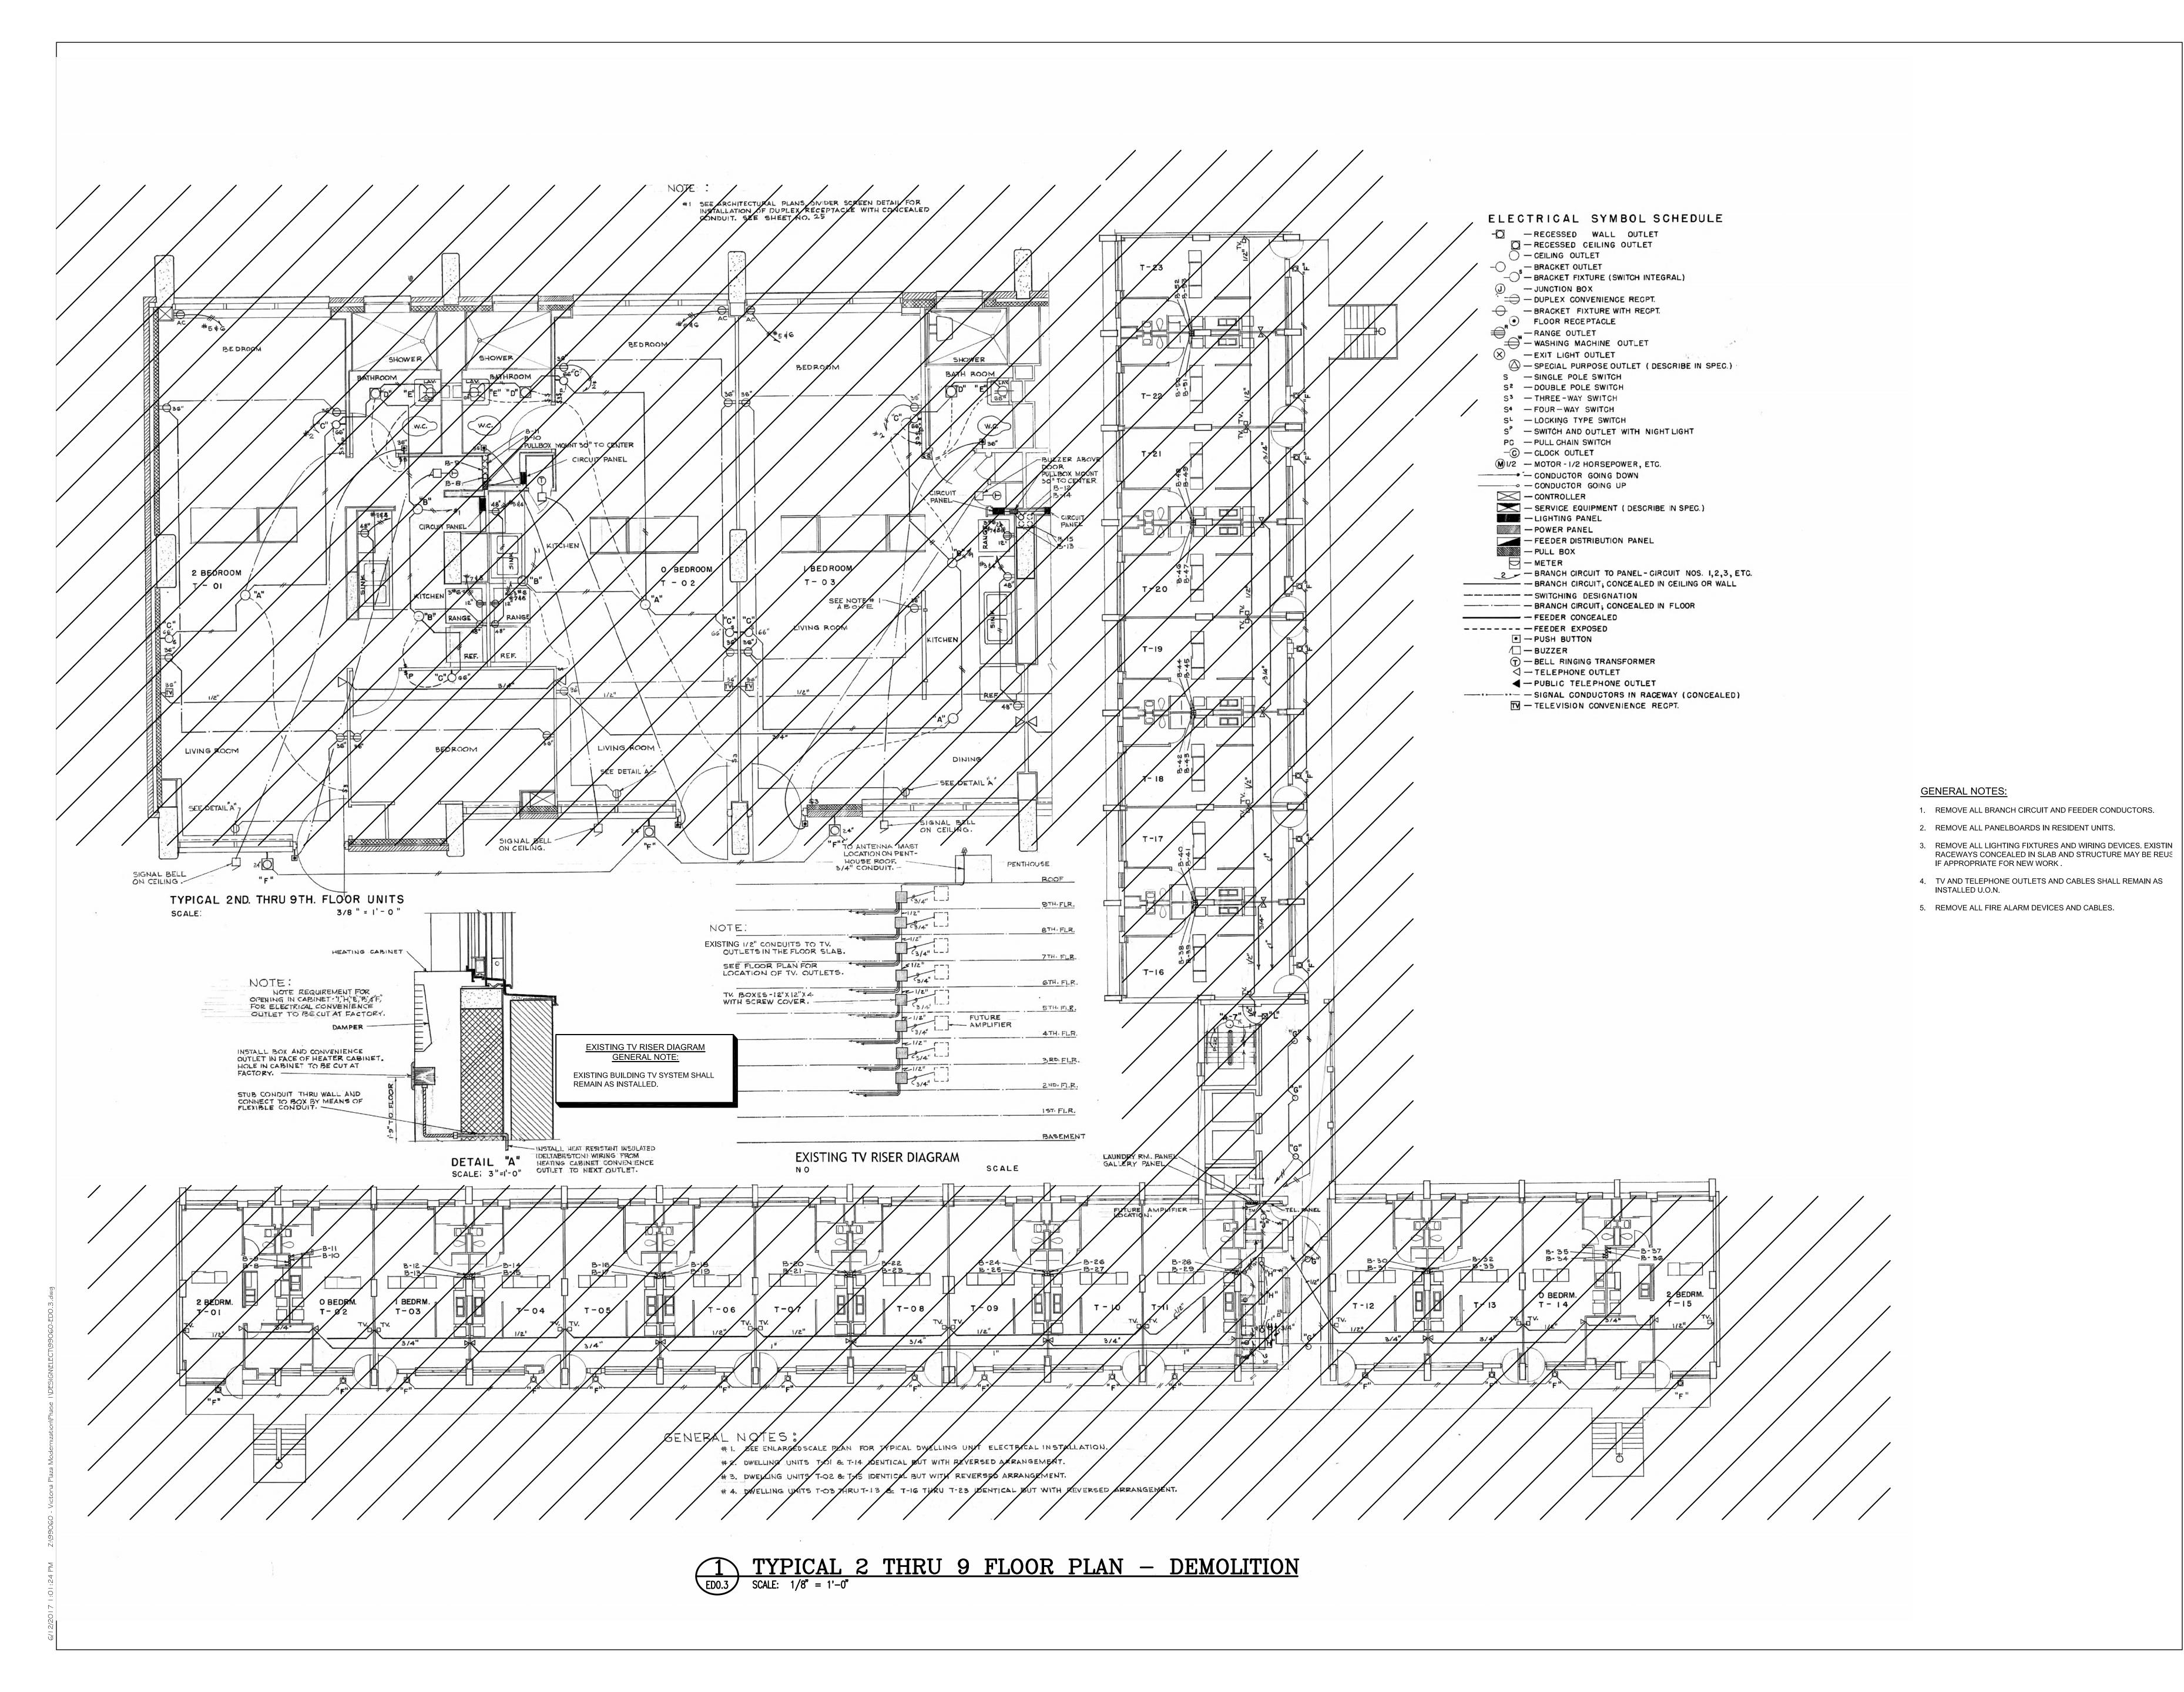




PROJECT ARCHITECT

SITE PLAN -

DEMOLITION





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SAN ANTONIO, TEXAS

TEL. 210 308-0080 visionworks 210 524-6572 eMAIL a.trevino@dhrarchitects.com

STOREDESIGN@ECCA.COM

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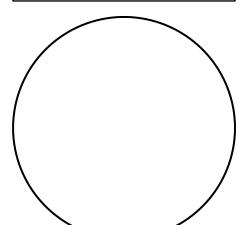
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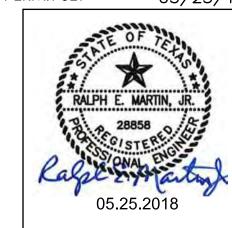
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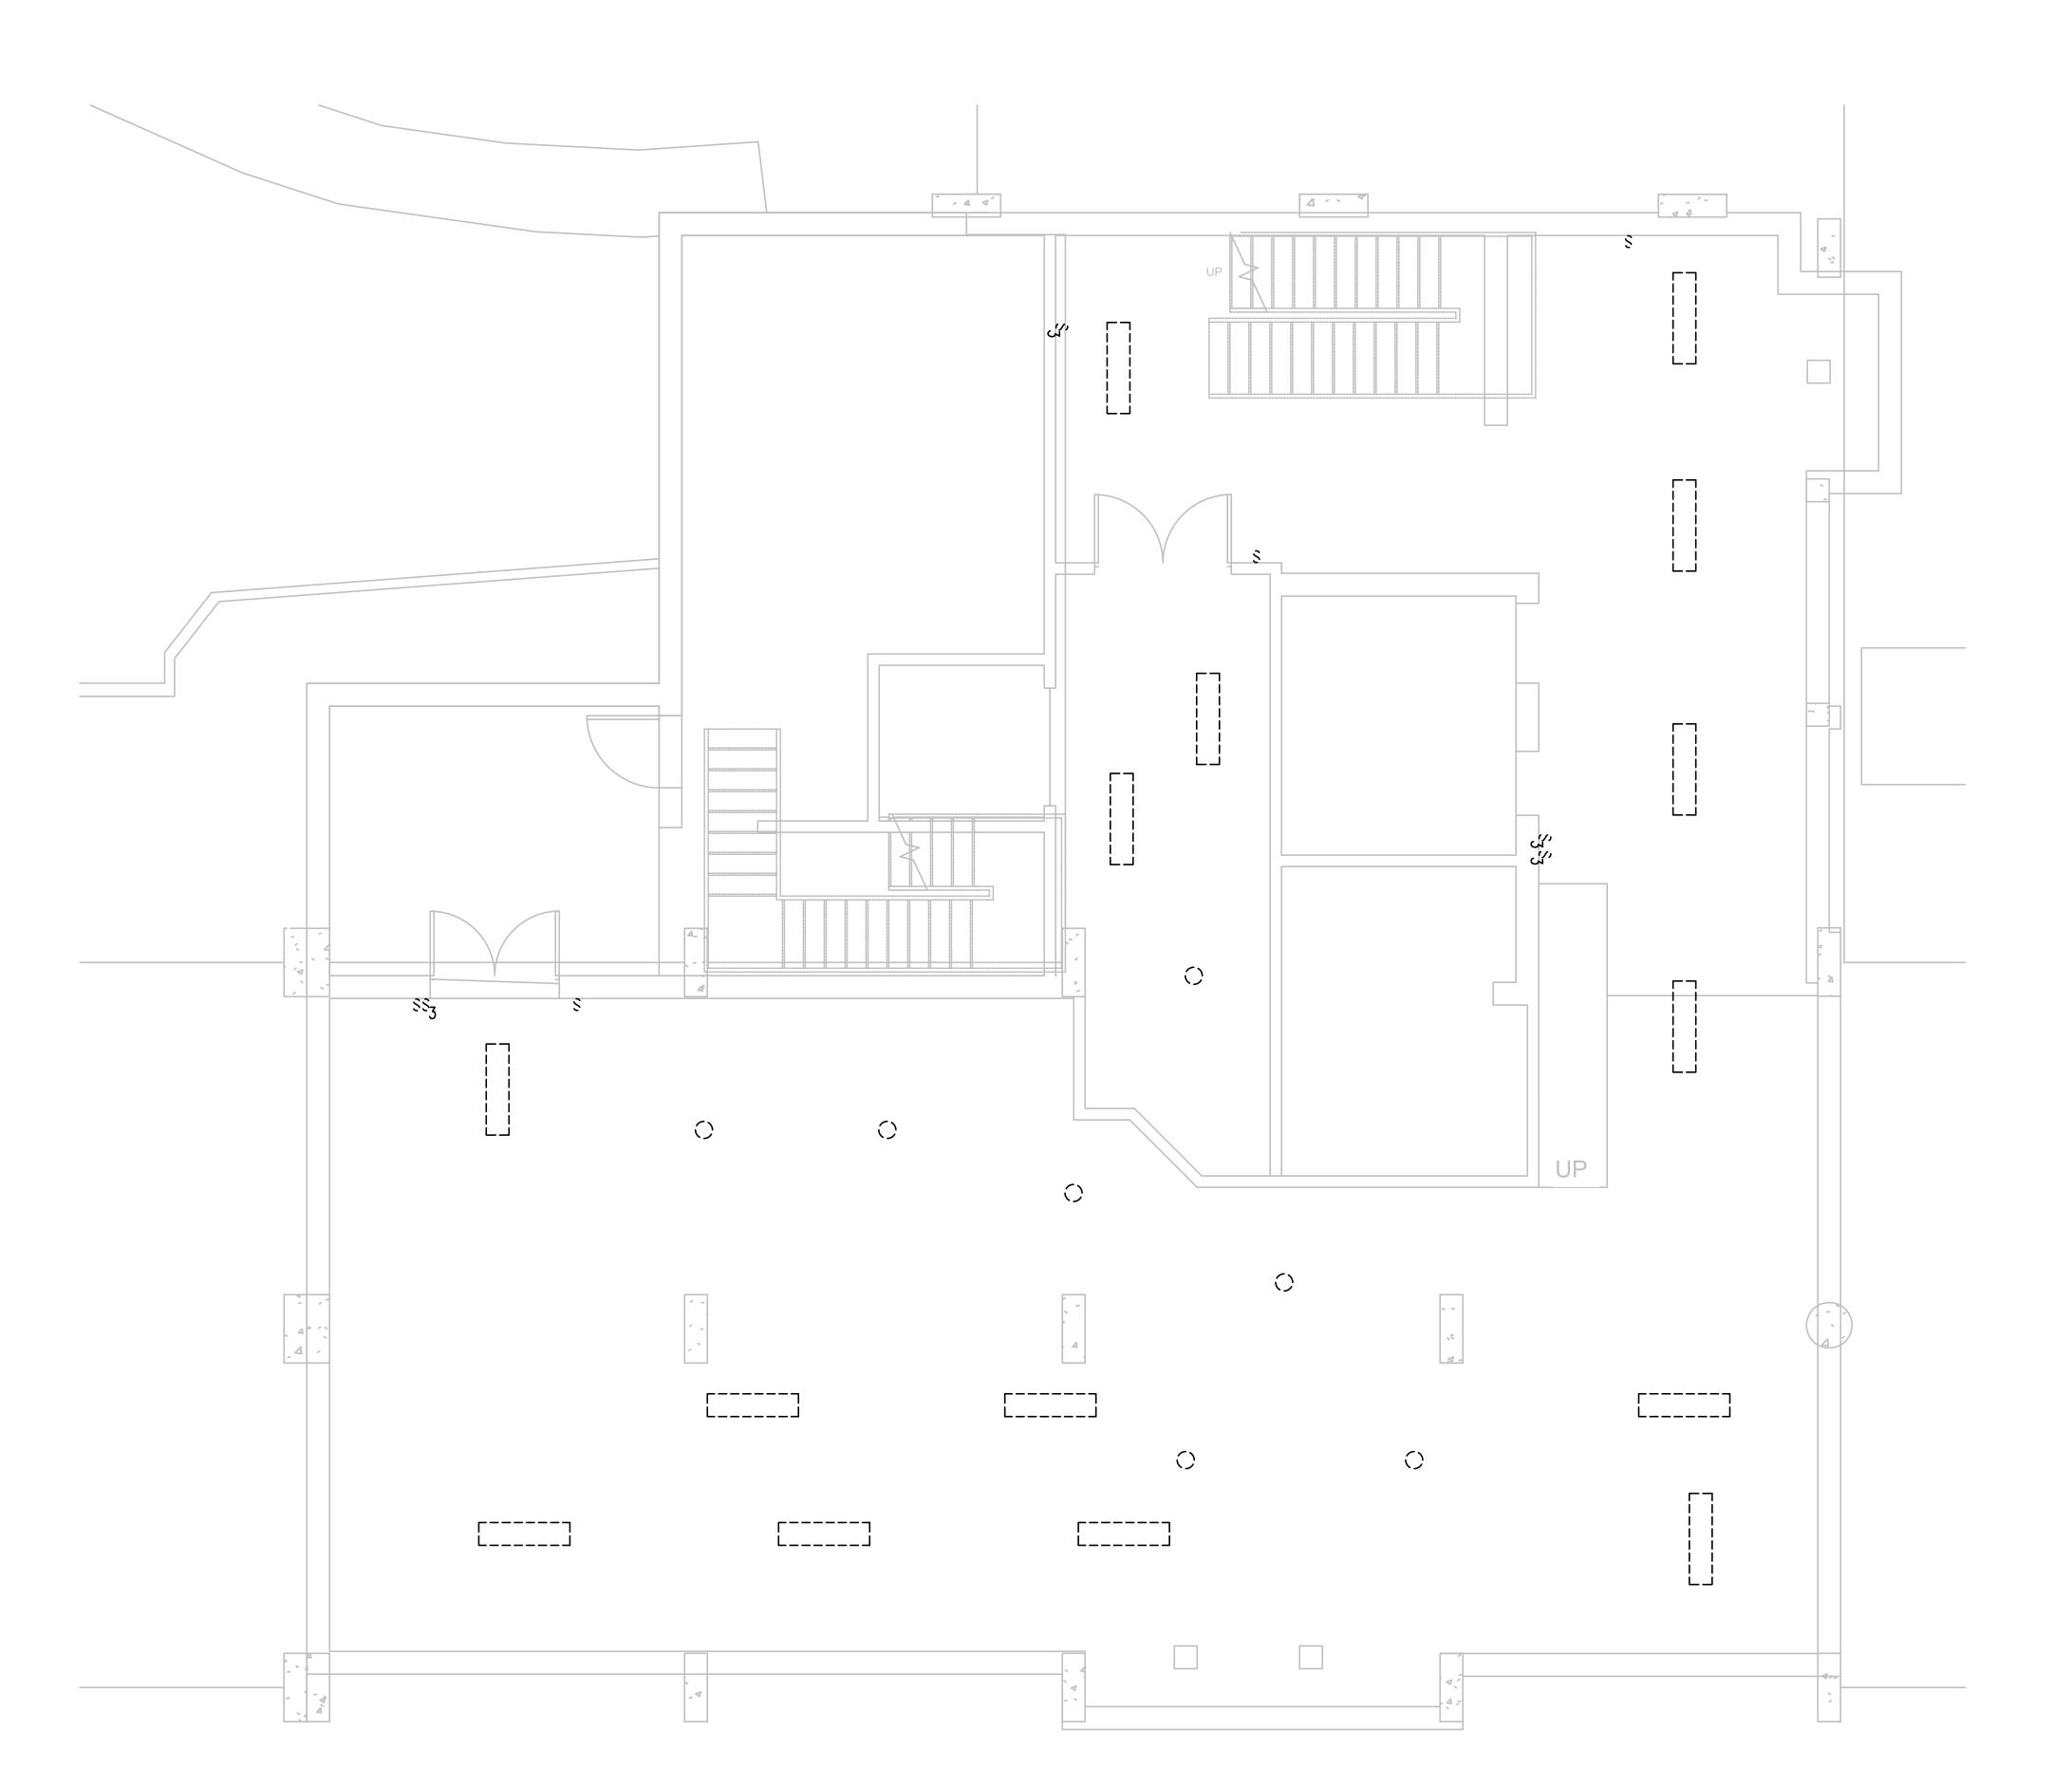
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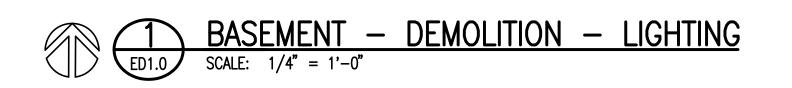
TYPICAL 2 THRU 9 FLOOR PLAN - DEMOLITION ELECTRICAL

ED0.3

GENERAL NOTES:

- ALL EXISTING LIGHTING FIXTURES SHALL BE REMOVED AND REPLACED. REMOVE AND REPLACE CONDUCTORS. EXISTING RACEWAY MAY BE REUSED IF APPROPRIATE FOR NEW WORK.
- ALL EXISTING LIGHTING SWITCHES ASSOCIATED WITH THE LIGHTING FIXTURES BEING REMOVED SHALL BE REMOVED.







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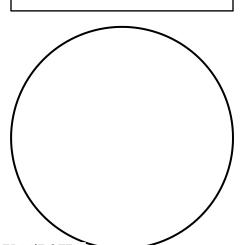







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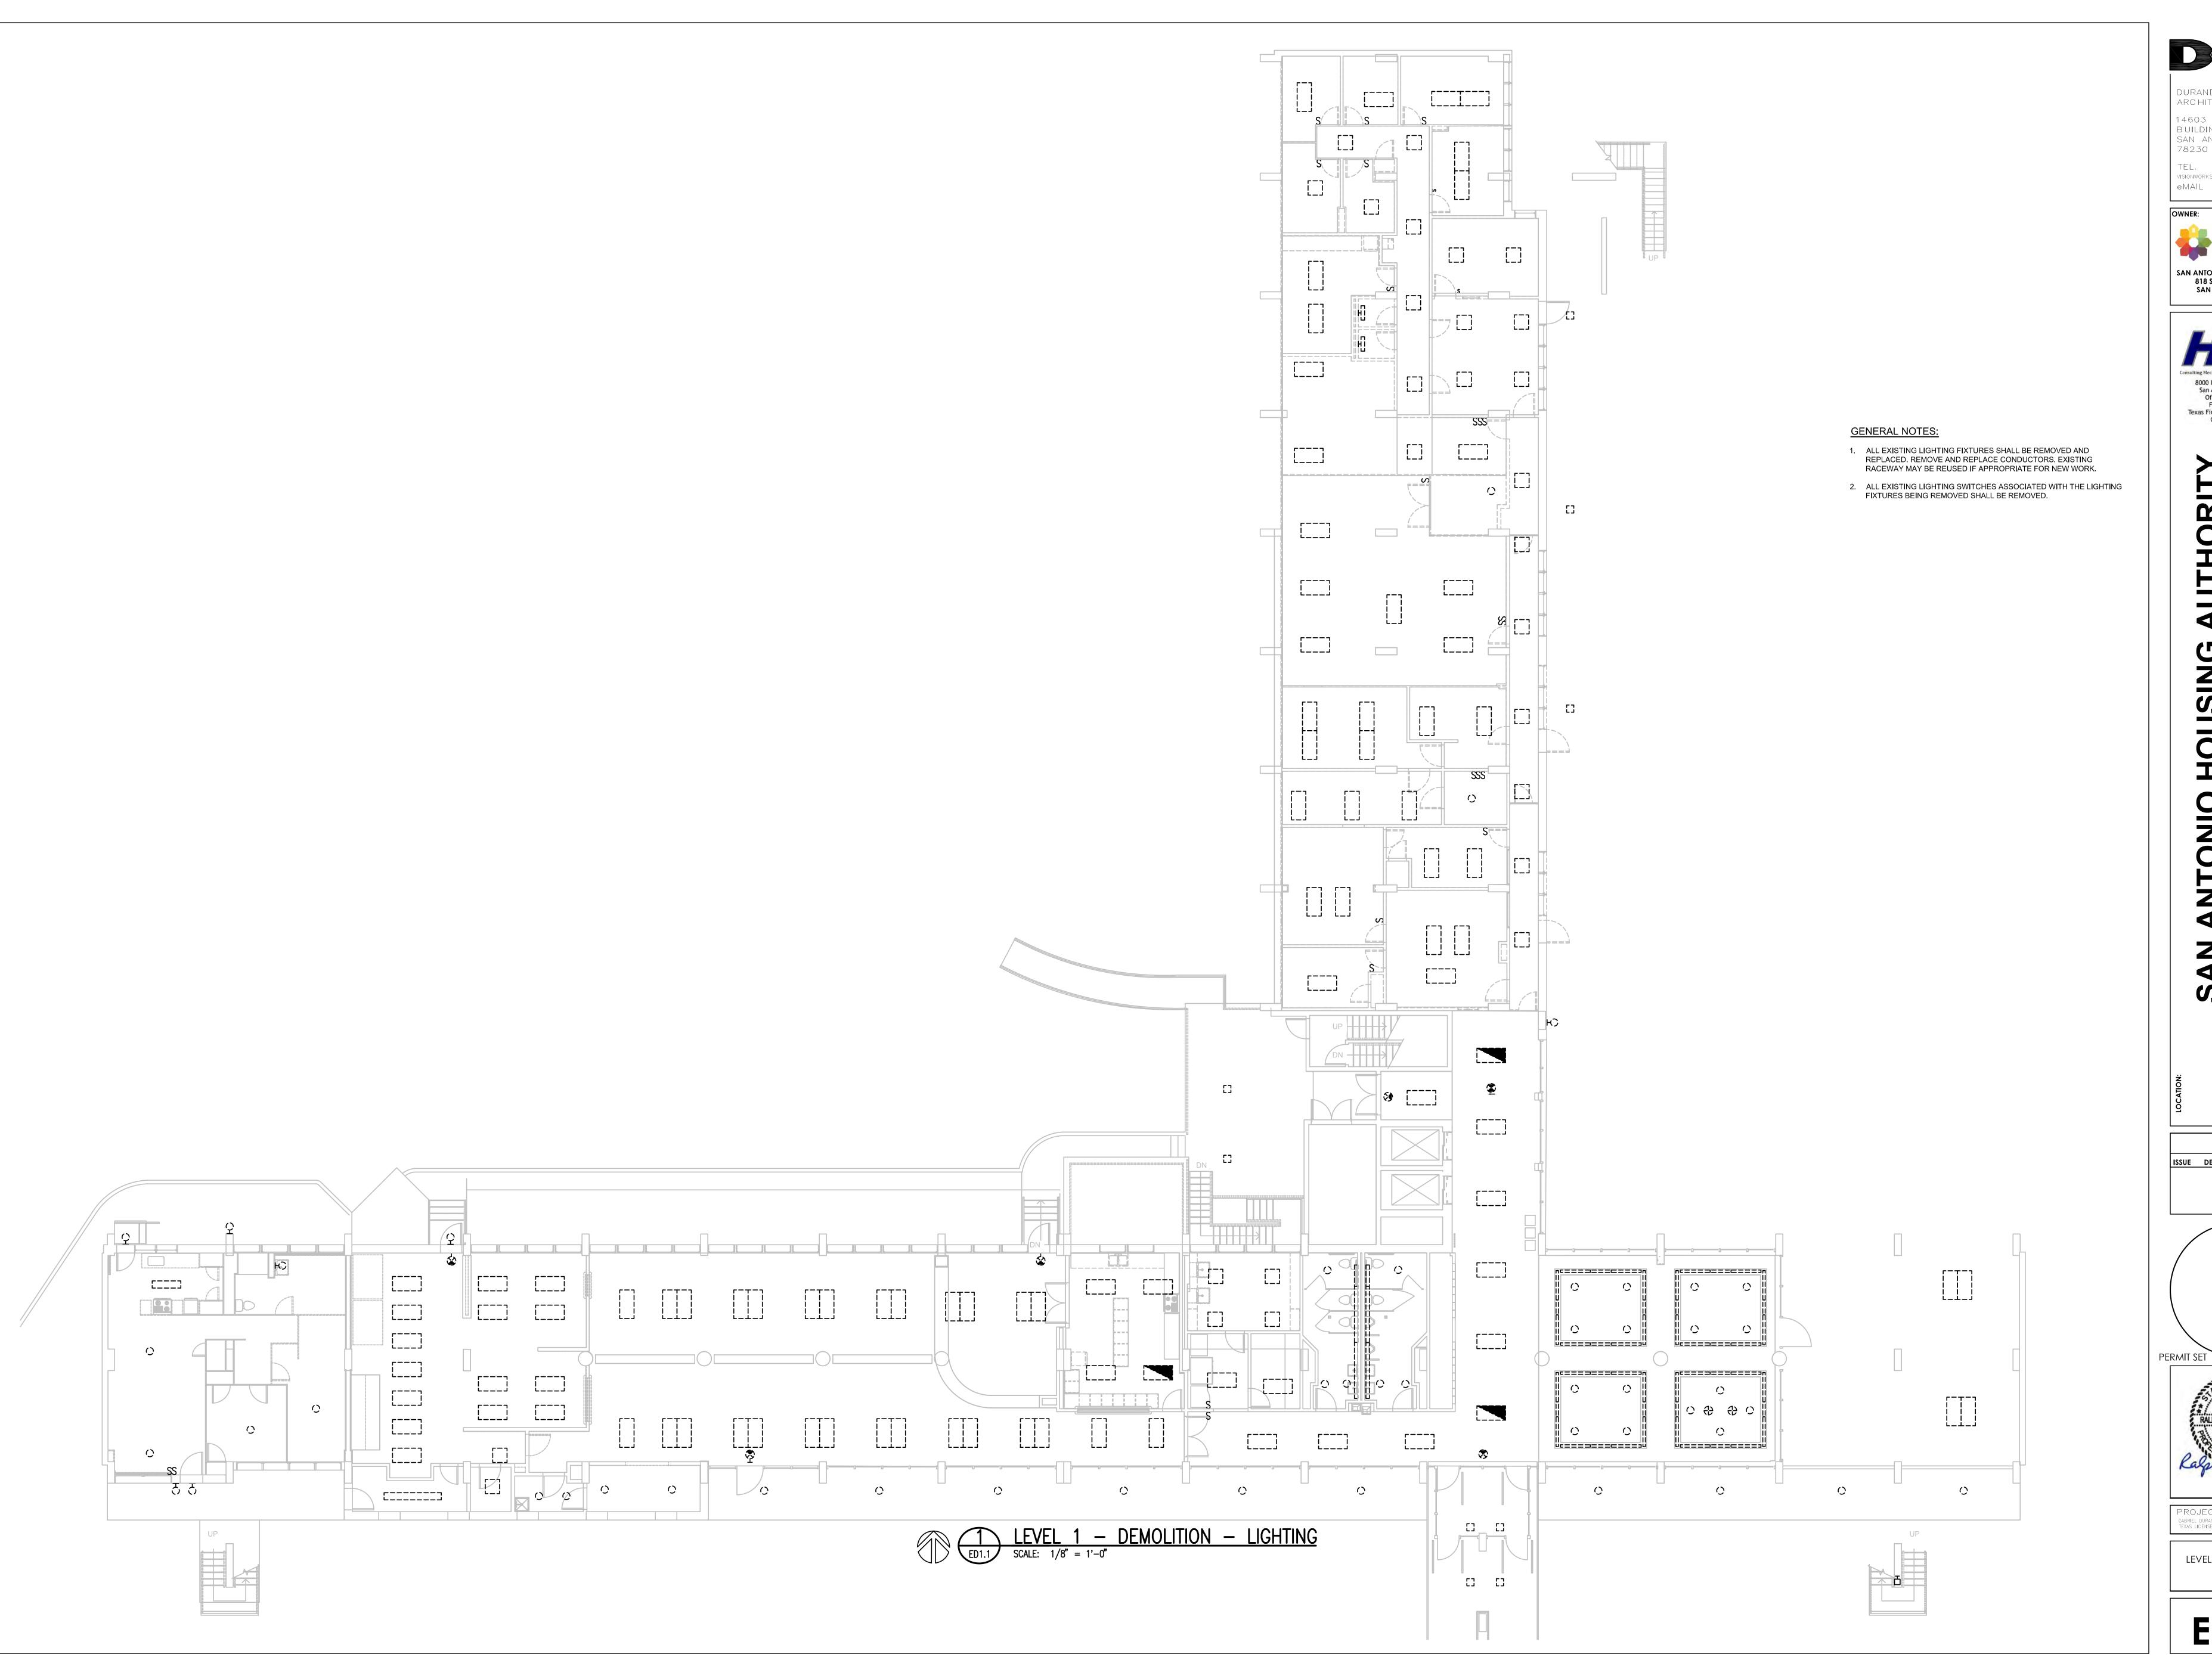
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PROJECT ARCHITECT
GABRIEL DURAND-HOLLIS, AIA
TEXAS LICENSE NO. 10-881

BASEMENT - DEMOLITION - LIGHTING



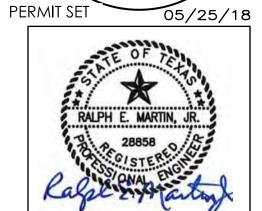

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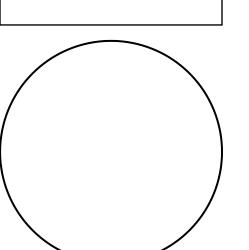
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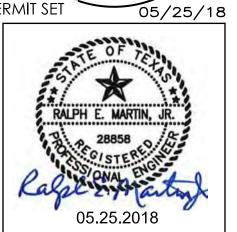






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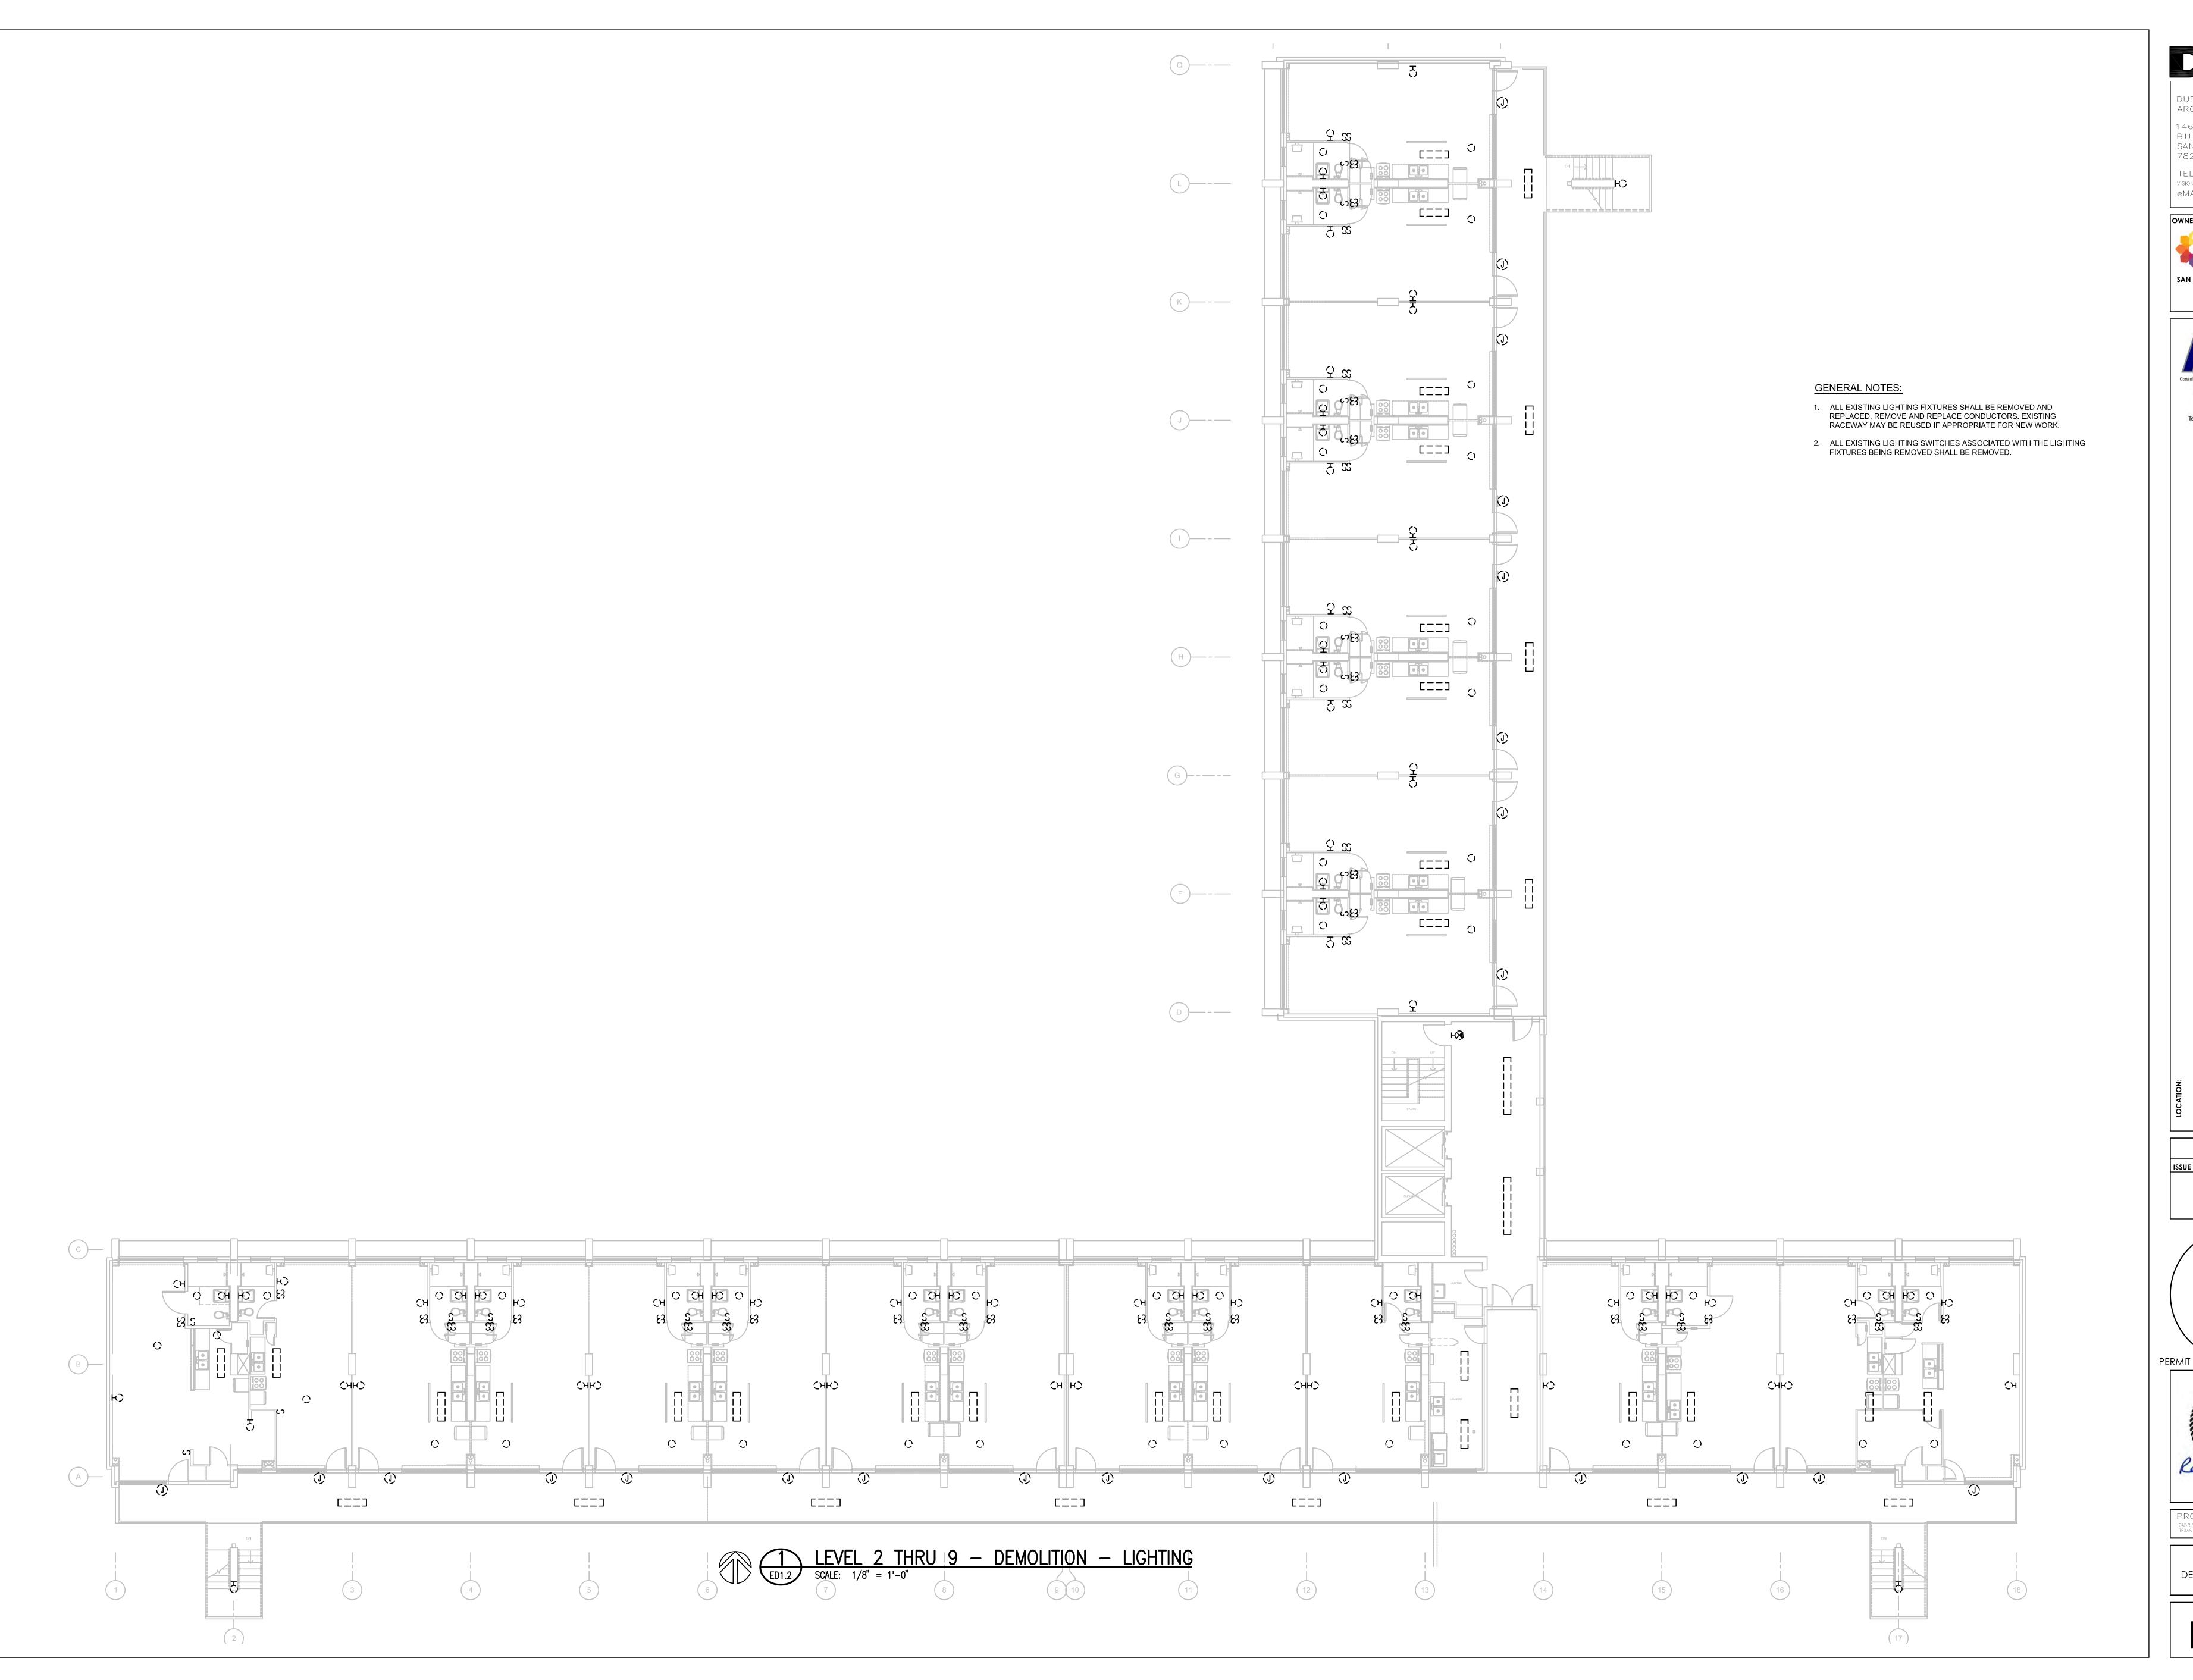


PROJECT ARCHITECT

GABRIEL DURAND-HOLLIS, AIA
TEXAS LICENSE NO. 10-881

LEVEL 1 - DEMOLITION -LIGHTING

SHEET NUMBER ED1.1





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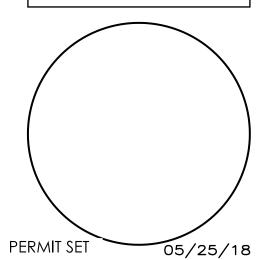
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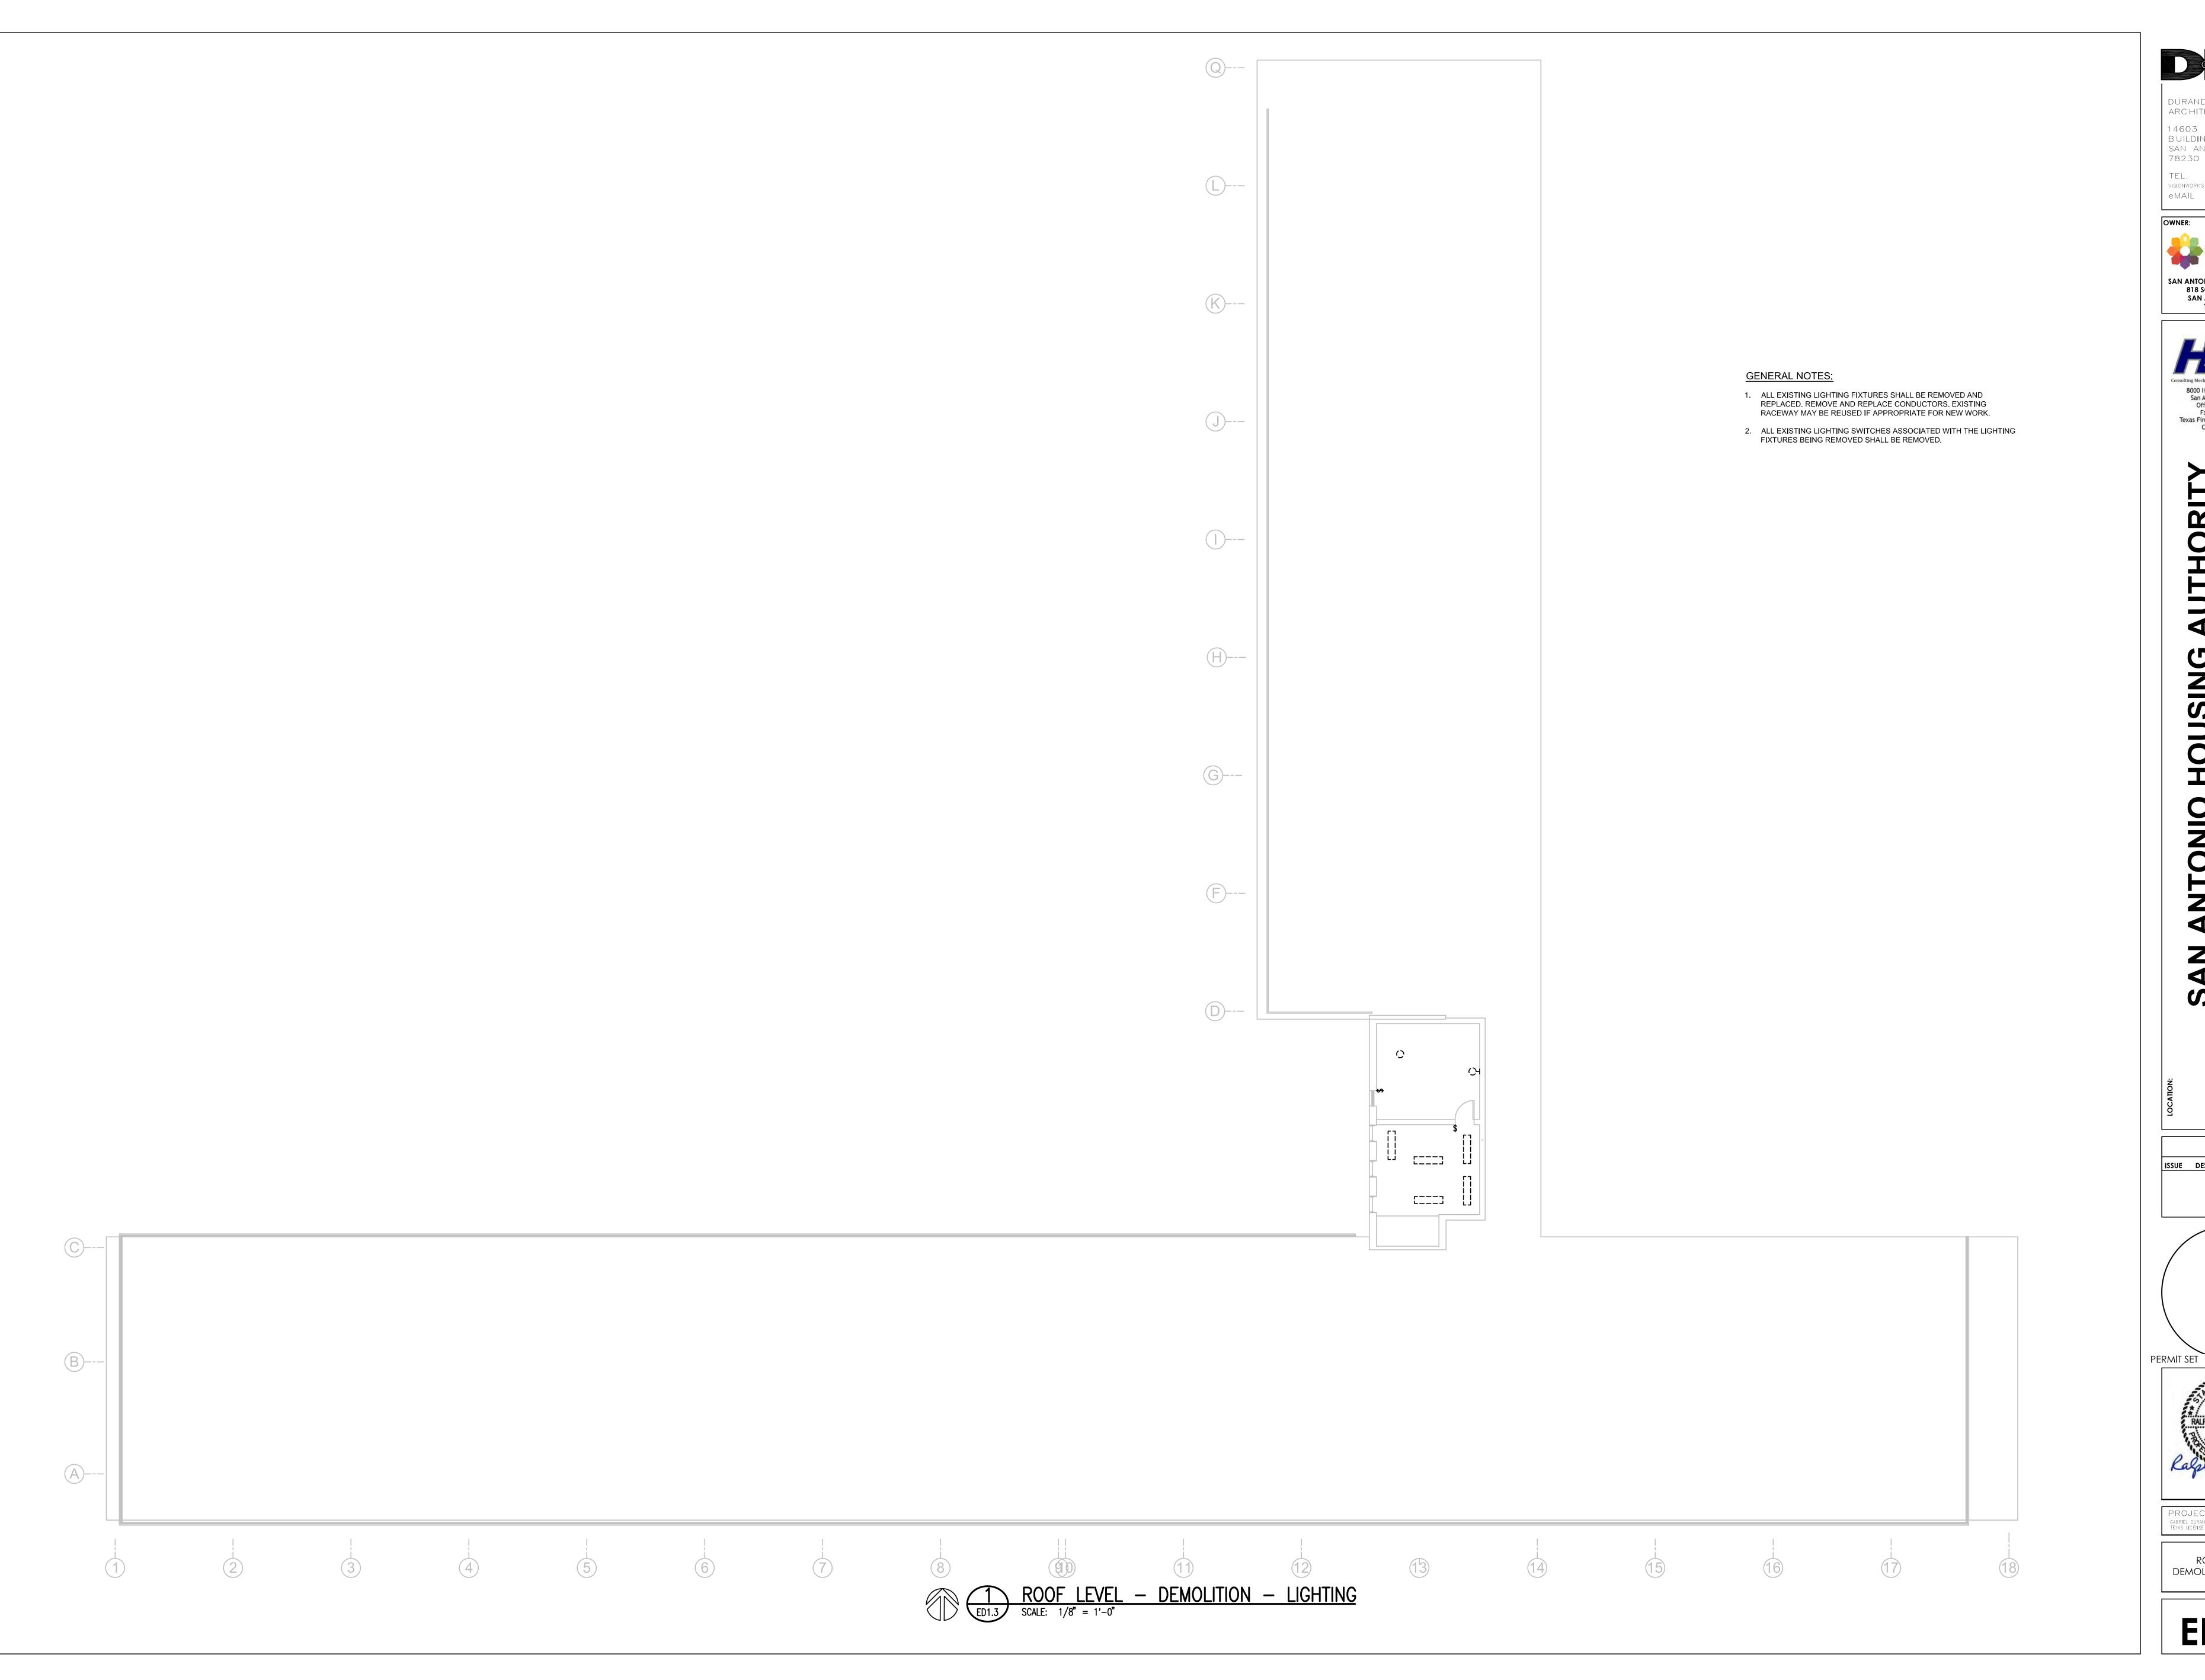


PROJECT ARCHITECT

GABRIEL DURAND-HOLLIS, AIA
TEXAS LICENSE NO. 10-881

LEVEL 2 THRU 9 -DEMOLITION - LIGHTING

SHEET NUMBER





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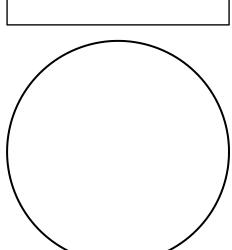
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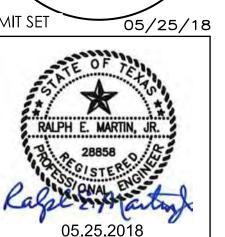
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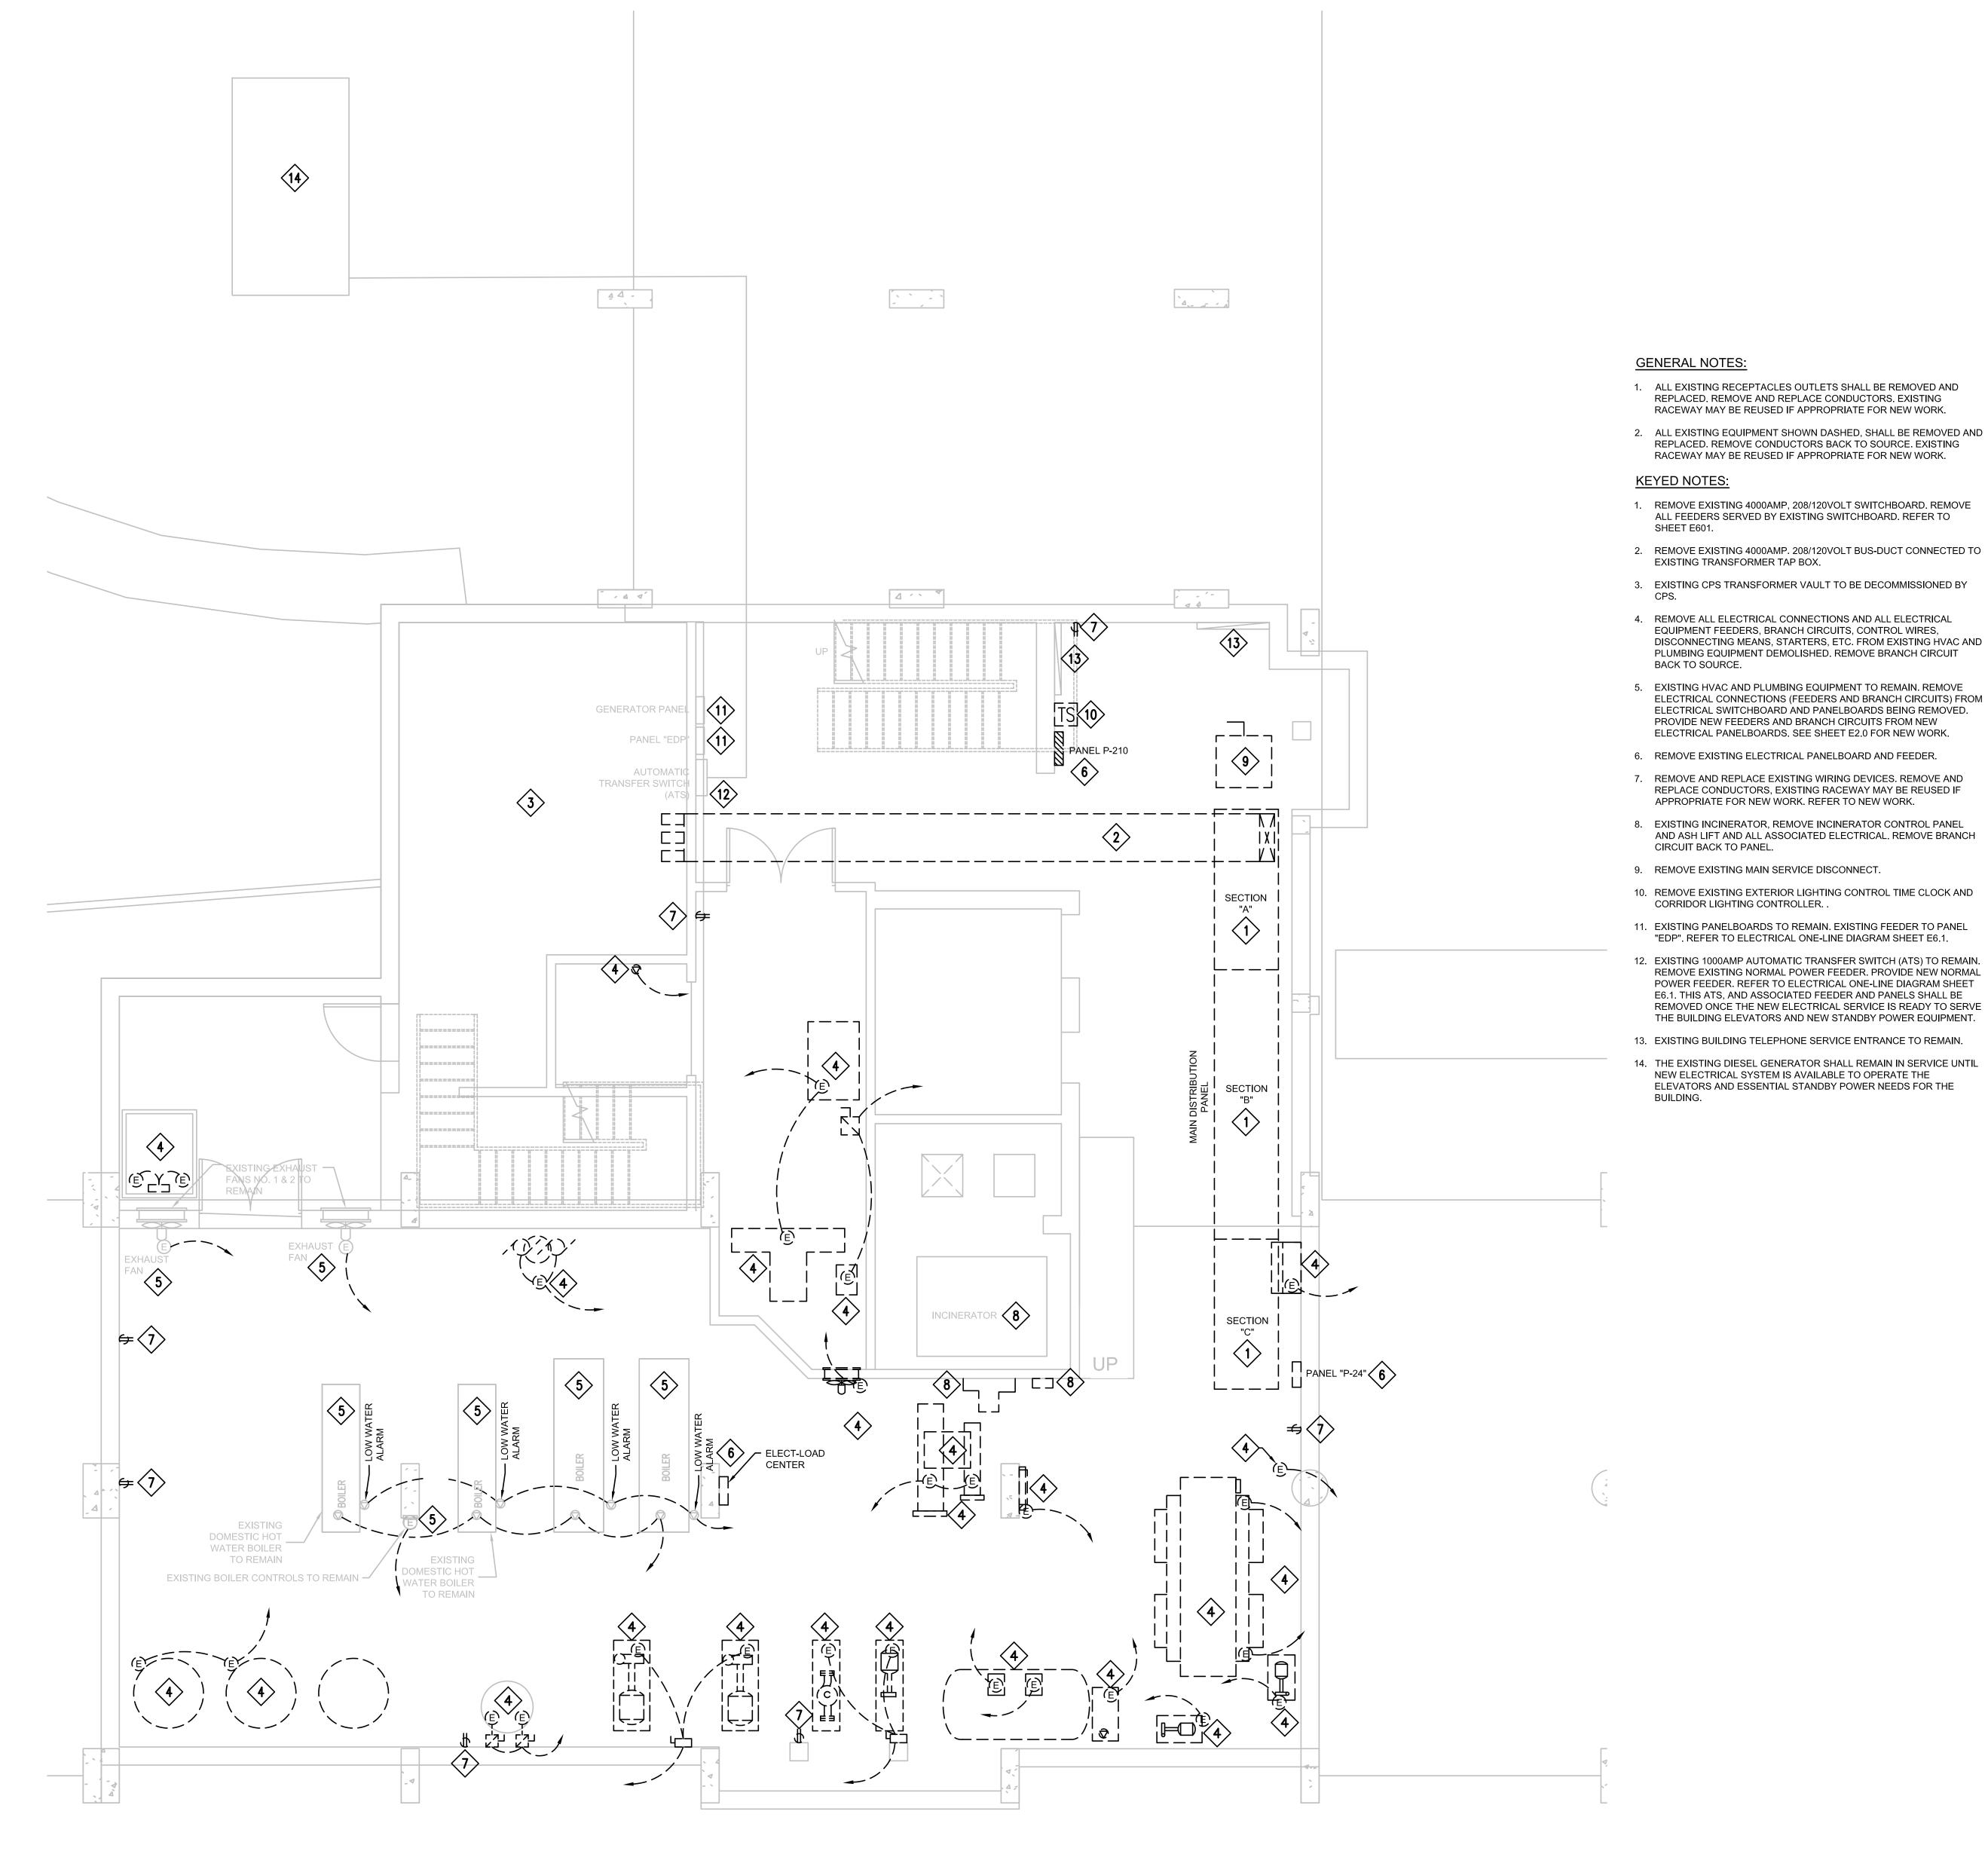
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PROJECT ARCHITECT
GABRIEL DURAND-HOLLIS, AIA
TEXAS LICENSE NO. 10-881

ROOF LEVEL -DEMOLITION - LIGHTING



BASEMENT - DEMOLITION - ELECTRICAL

SCALE: 1/4" = 1'-0"



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PLUMBING EQUIPMENT DEMOLISHED. REMOVE BRANCH CIRCUIT BACK TO SOURCE. 5. EXISTING HVAC AND PLUMBING EQUIPMENT TO REMAIN. REMOVE ELECTRICAL CONNECTIONS (FEEDERS AND BRANCH CIRCUITS) FROM ELECTRICAL SWITCHBOARD AND PANELBOARDS BEING REMOVED. PROVIDE NEW FEEDERS AND BRANCH CIRCUITS FROM NEW

6. REMOVE EXISTING ELECTRICAL PANELBOARD AND FEEDER.

7. REMOVE AND REPLACE EXISTING WIRING DEVICES. REMOVE AND REPLACE CONDUCTORS, EXISTING RACEWAY MAY BE REUSED IF APPROPRIATE FOR NEW WORK. REFER TO NEW WORK.

8. EXISTING INCINERATOR, REMOVE INCINERATOR CONTROL PANEL AND ASH LIFT AND ALL ASSOCIATED ELECTRICAL. REMOVE BRANCH CIRCUIT BACK TO PANEL.

9. REMOVE EXISTING MAIN SERVICE DISCONNECT.

10. REMOVE EXISTING EXTERIOR LIGHTING CONTROL TIME CLOCK AND CORRIDOR LIGHTING CONTROLLER. .


11. EXISTING PANELBOARDS TO REMAIN. EXISTING FEEDER TO PANEL "EDP". REFER TO ELECTRICAL ONE-LINE DIAGRAM SHEET E6.1.

12. EXISTING 1000AMP AUTOMATIC TRANSFER SWITCH (ATS) TO REMAIN. REMOVE EXISTING NORMAL POWER FEEDER. PROVIDE NEW NORMAL POWER FEEDER. REFER TO ELECTRICAL ONE-LINE DIAGRAM SHEET E6.1. THIS ATS, AND ASSOCIATED FEEDER AND PANELS SHALL BE REMOVED ONCE THE NEW ELECTRICAL SERVICE IS READY TO SERVE

13. EXISTING BUILDING TELEPHONE SERVICE ENTRANCE TO REMAIN.

14. THE EXISTING DIESEL GENERATOR SHALL REMAIN IN SERVICE UNTIL NEW ELECTRICAL SYSTEM IS AVAILABLE TO OPERATE THE ELEVATORS AND ESSENTIAL STANDBY POWER NEEDS FOR THE

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PROJECT ARCHITECT

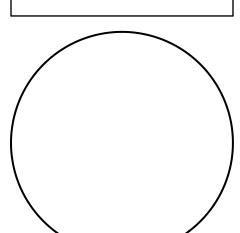BASEMENT - DEMOLITION - ELECTRICAL





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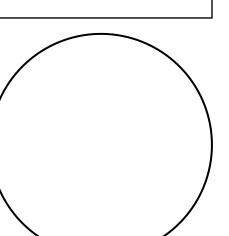



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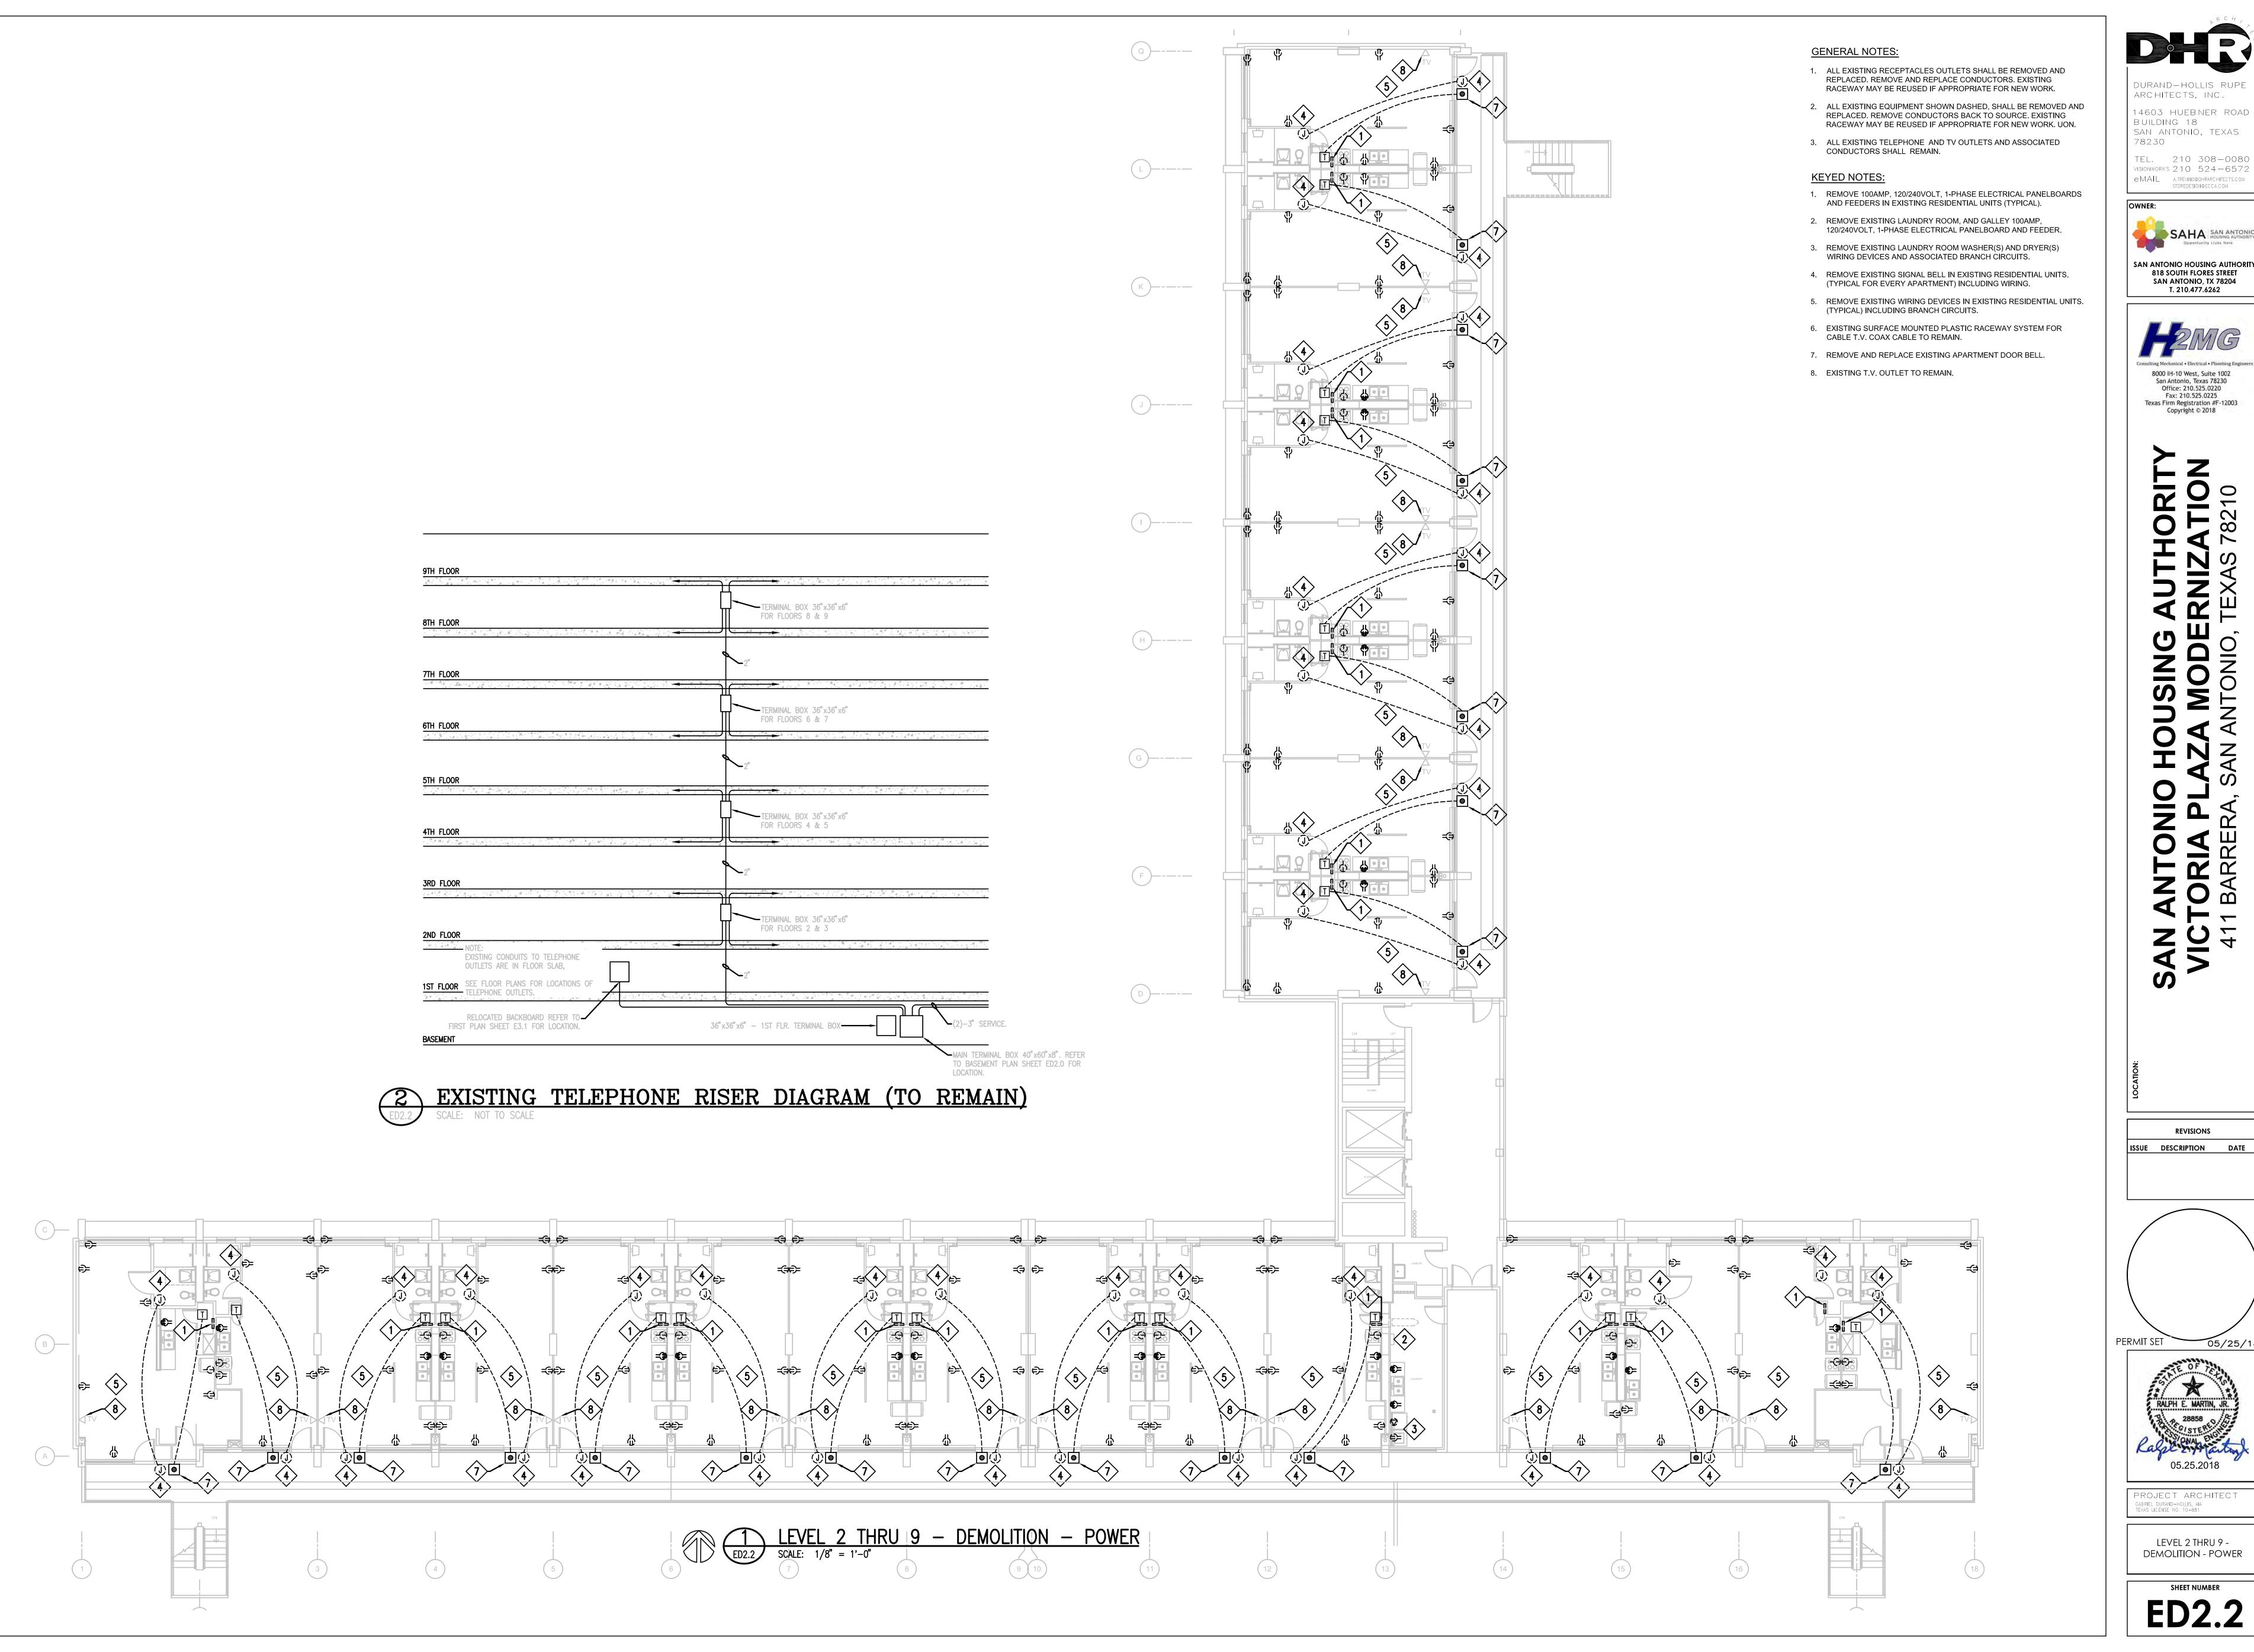


PROJECT ARCHITECT

GABRIEL DURAND-HOLLIS, AIA
TEXAS LICENSE NO. 10-881

LEVEL 1 - DEMOLITION -POWER

SHEET NUMBER **ED2.1**

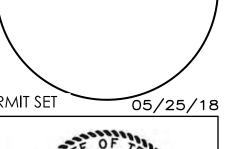



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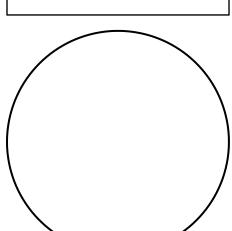
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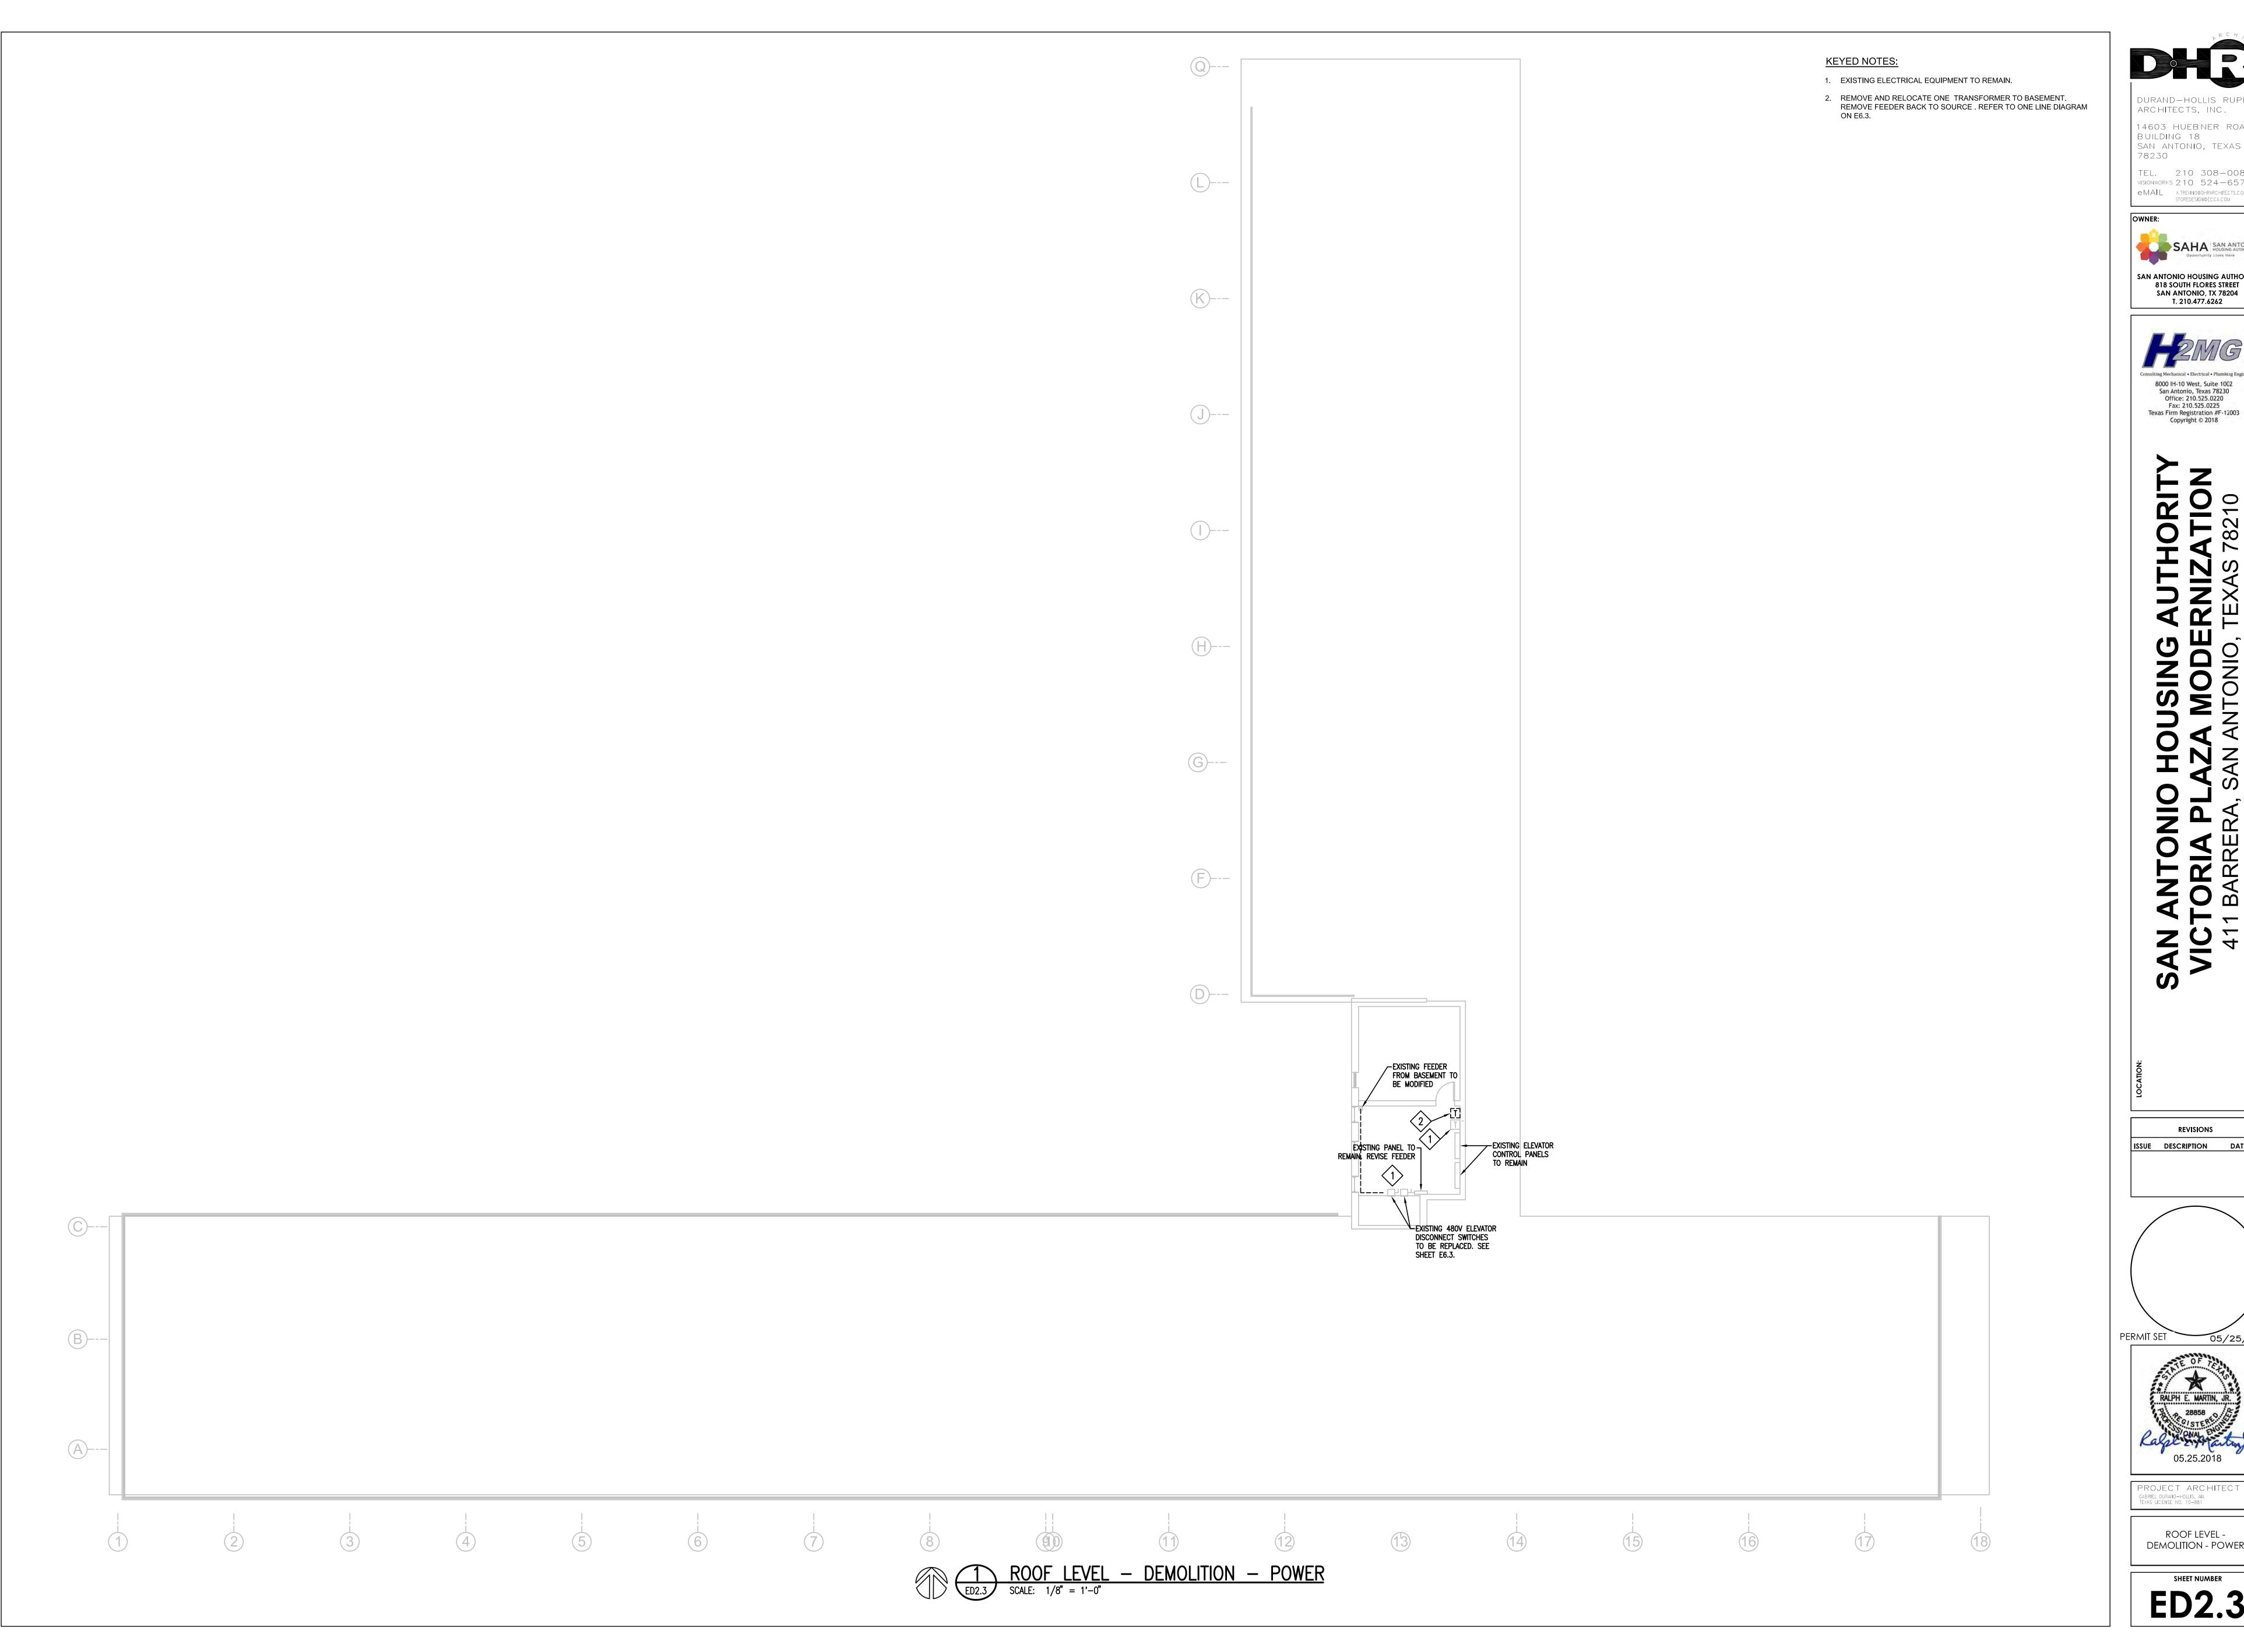
05/25/18



PROJECT ARCHITECT GABRIEL DURAND-HOLLIS, AIA TEXAS LICENSE NO. 10-881

LEVEL 2 THRU 9 -DEMOLITION - POWER

SHEET NUMBER



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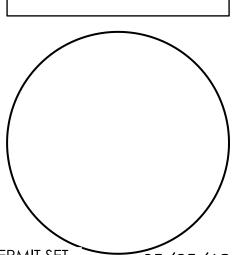


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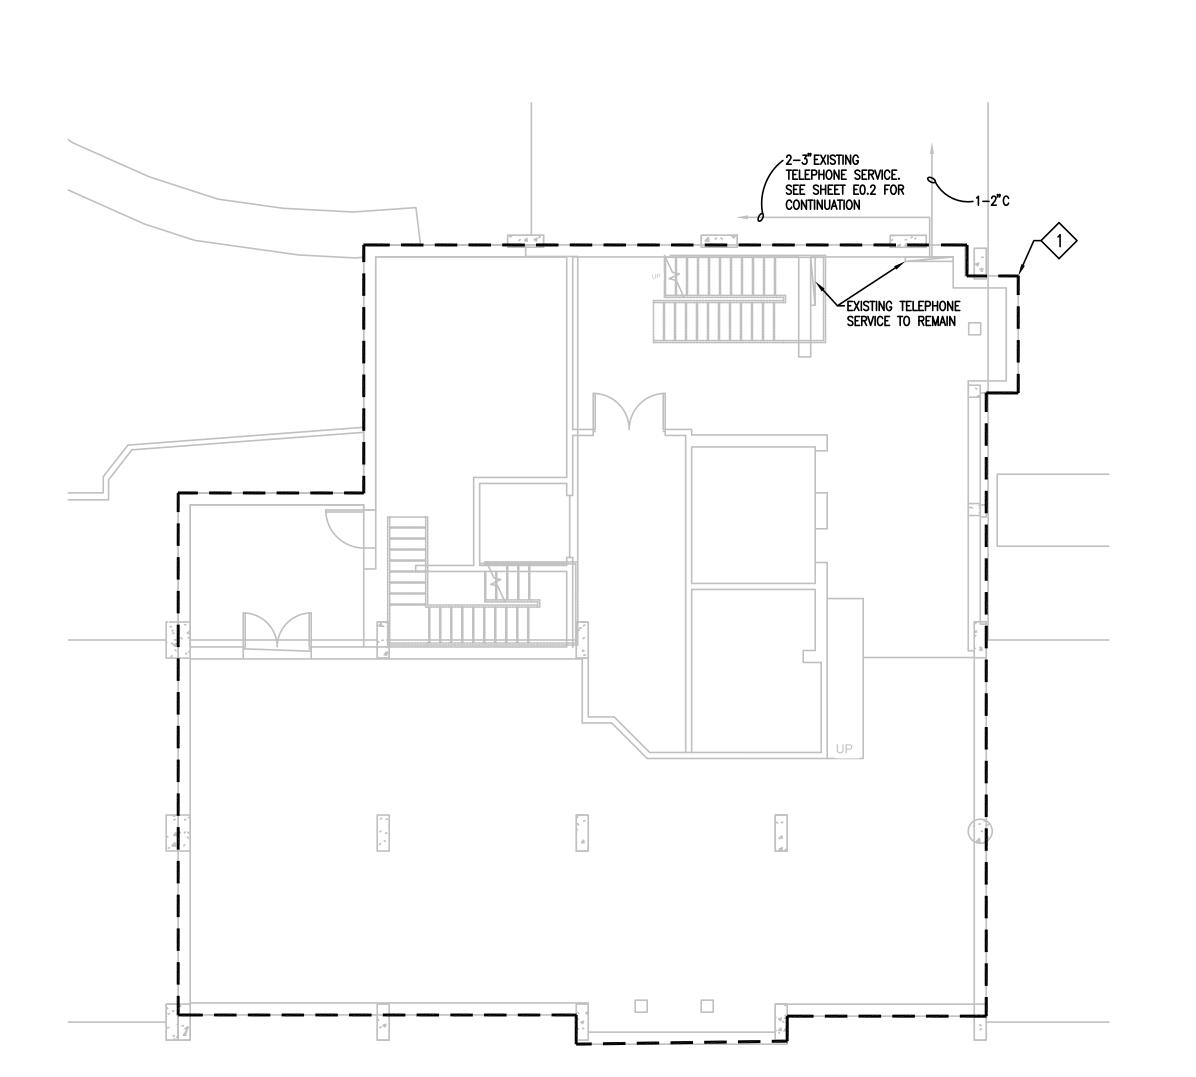
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PROJECT ARCHITECT
GABRIEL DURAND-HOLLIS, AIA
TEXAS LICENSE NO. 10-881

ROOF LEVEL -DEMOLITION - POWER



KEYED NOTES:

REMOVE ALL EXISTING FIRE ALARM/SPECIAL SYSTEMS DEVICES IN THIS AREA.

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BUILDING 18


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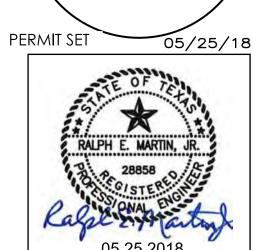


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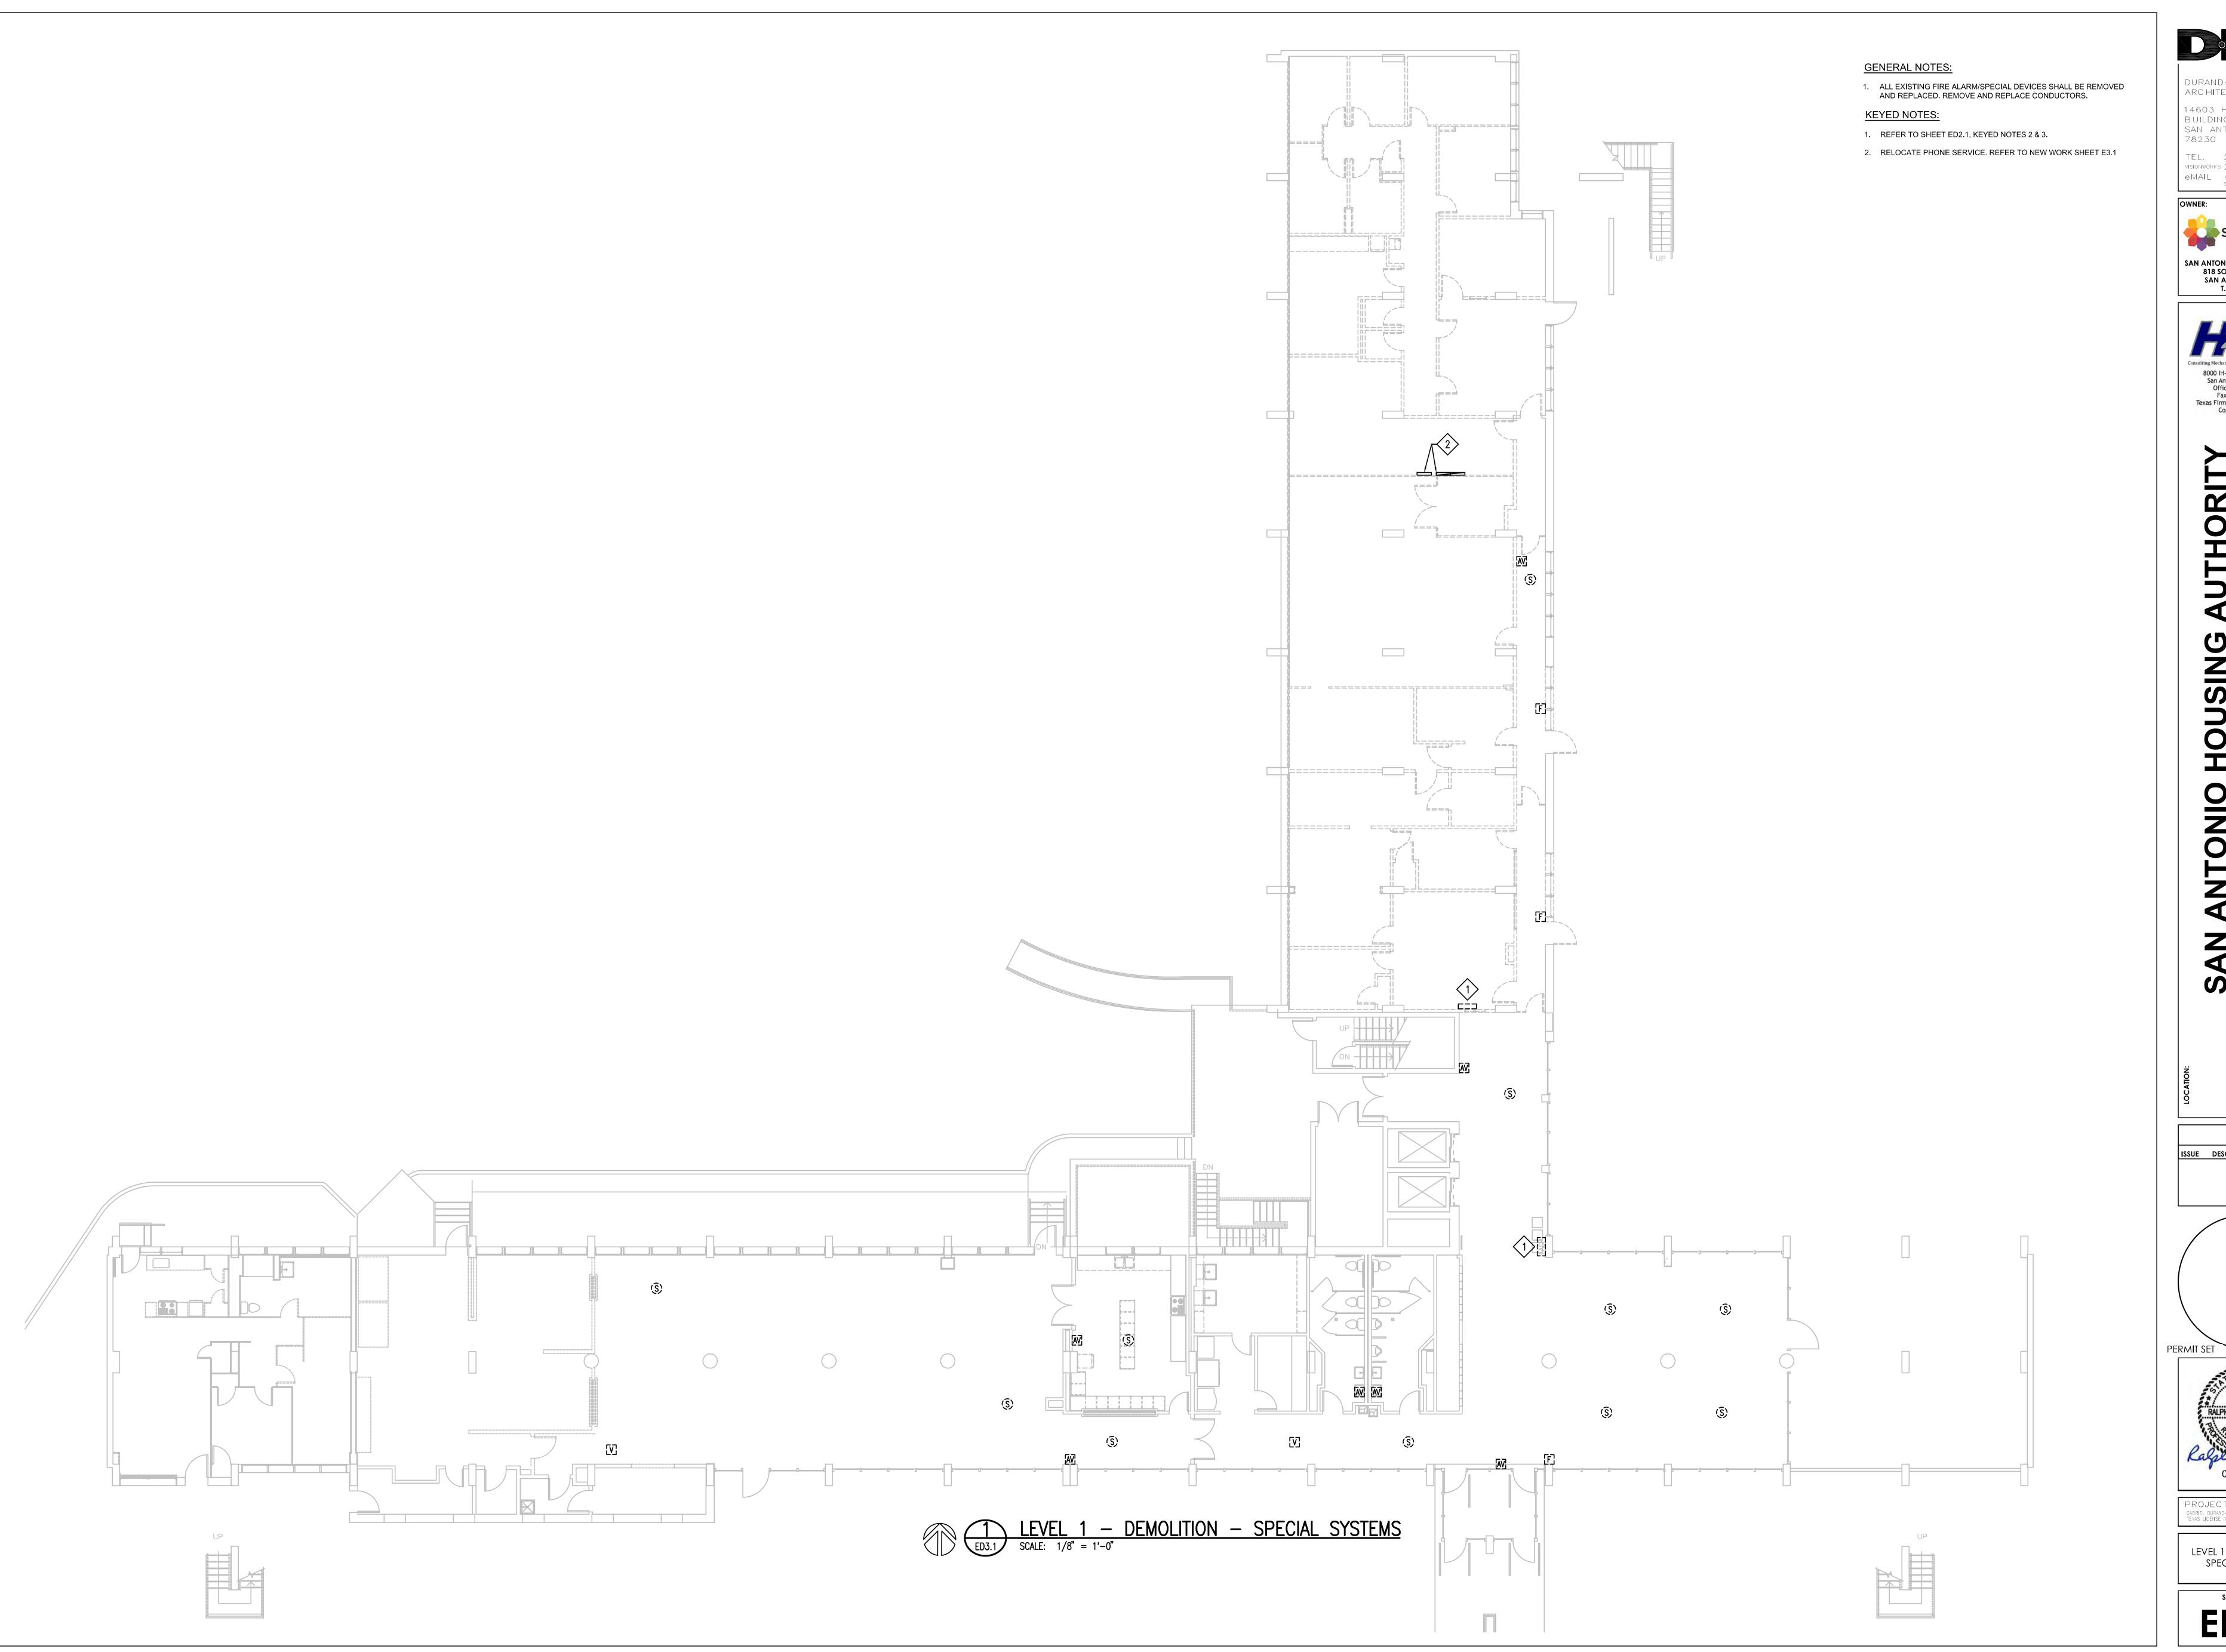
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GABRIEL DURAND-HOLLIS, AIA
TEXAS LICENSE NO. 10-881

BASEMENT - DEMOLITION - SPECIAL SYSTEMS

SHEET NUMBER

BASEMENT - DEMOLITION - SPECIAL SYSTEMS

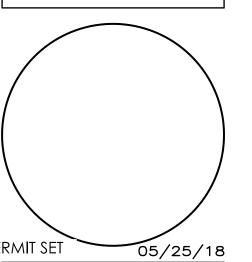SCALE: 1/8" = 1'-0"






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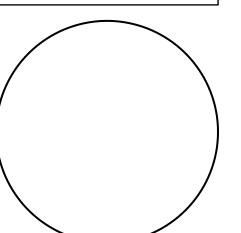
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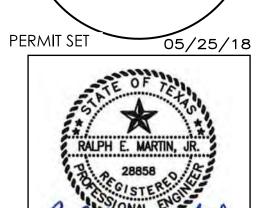






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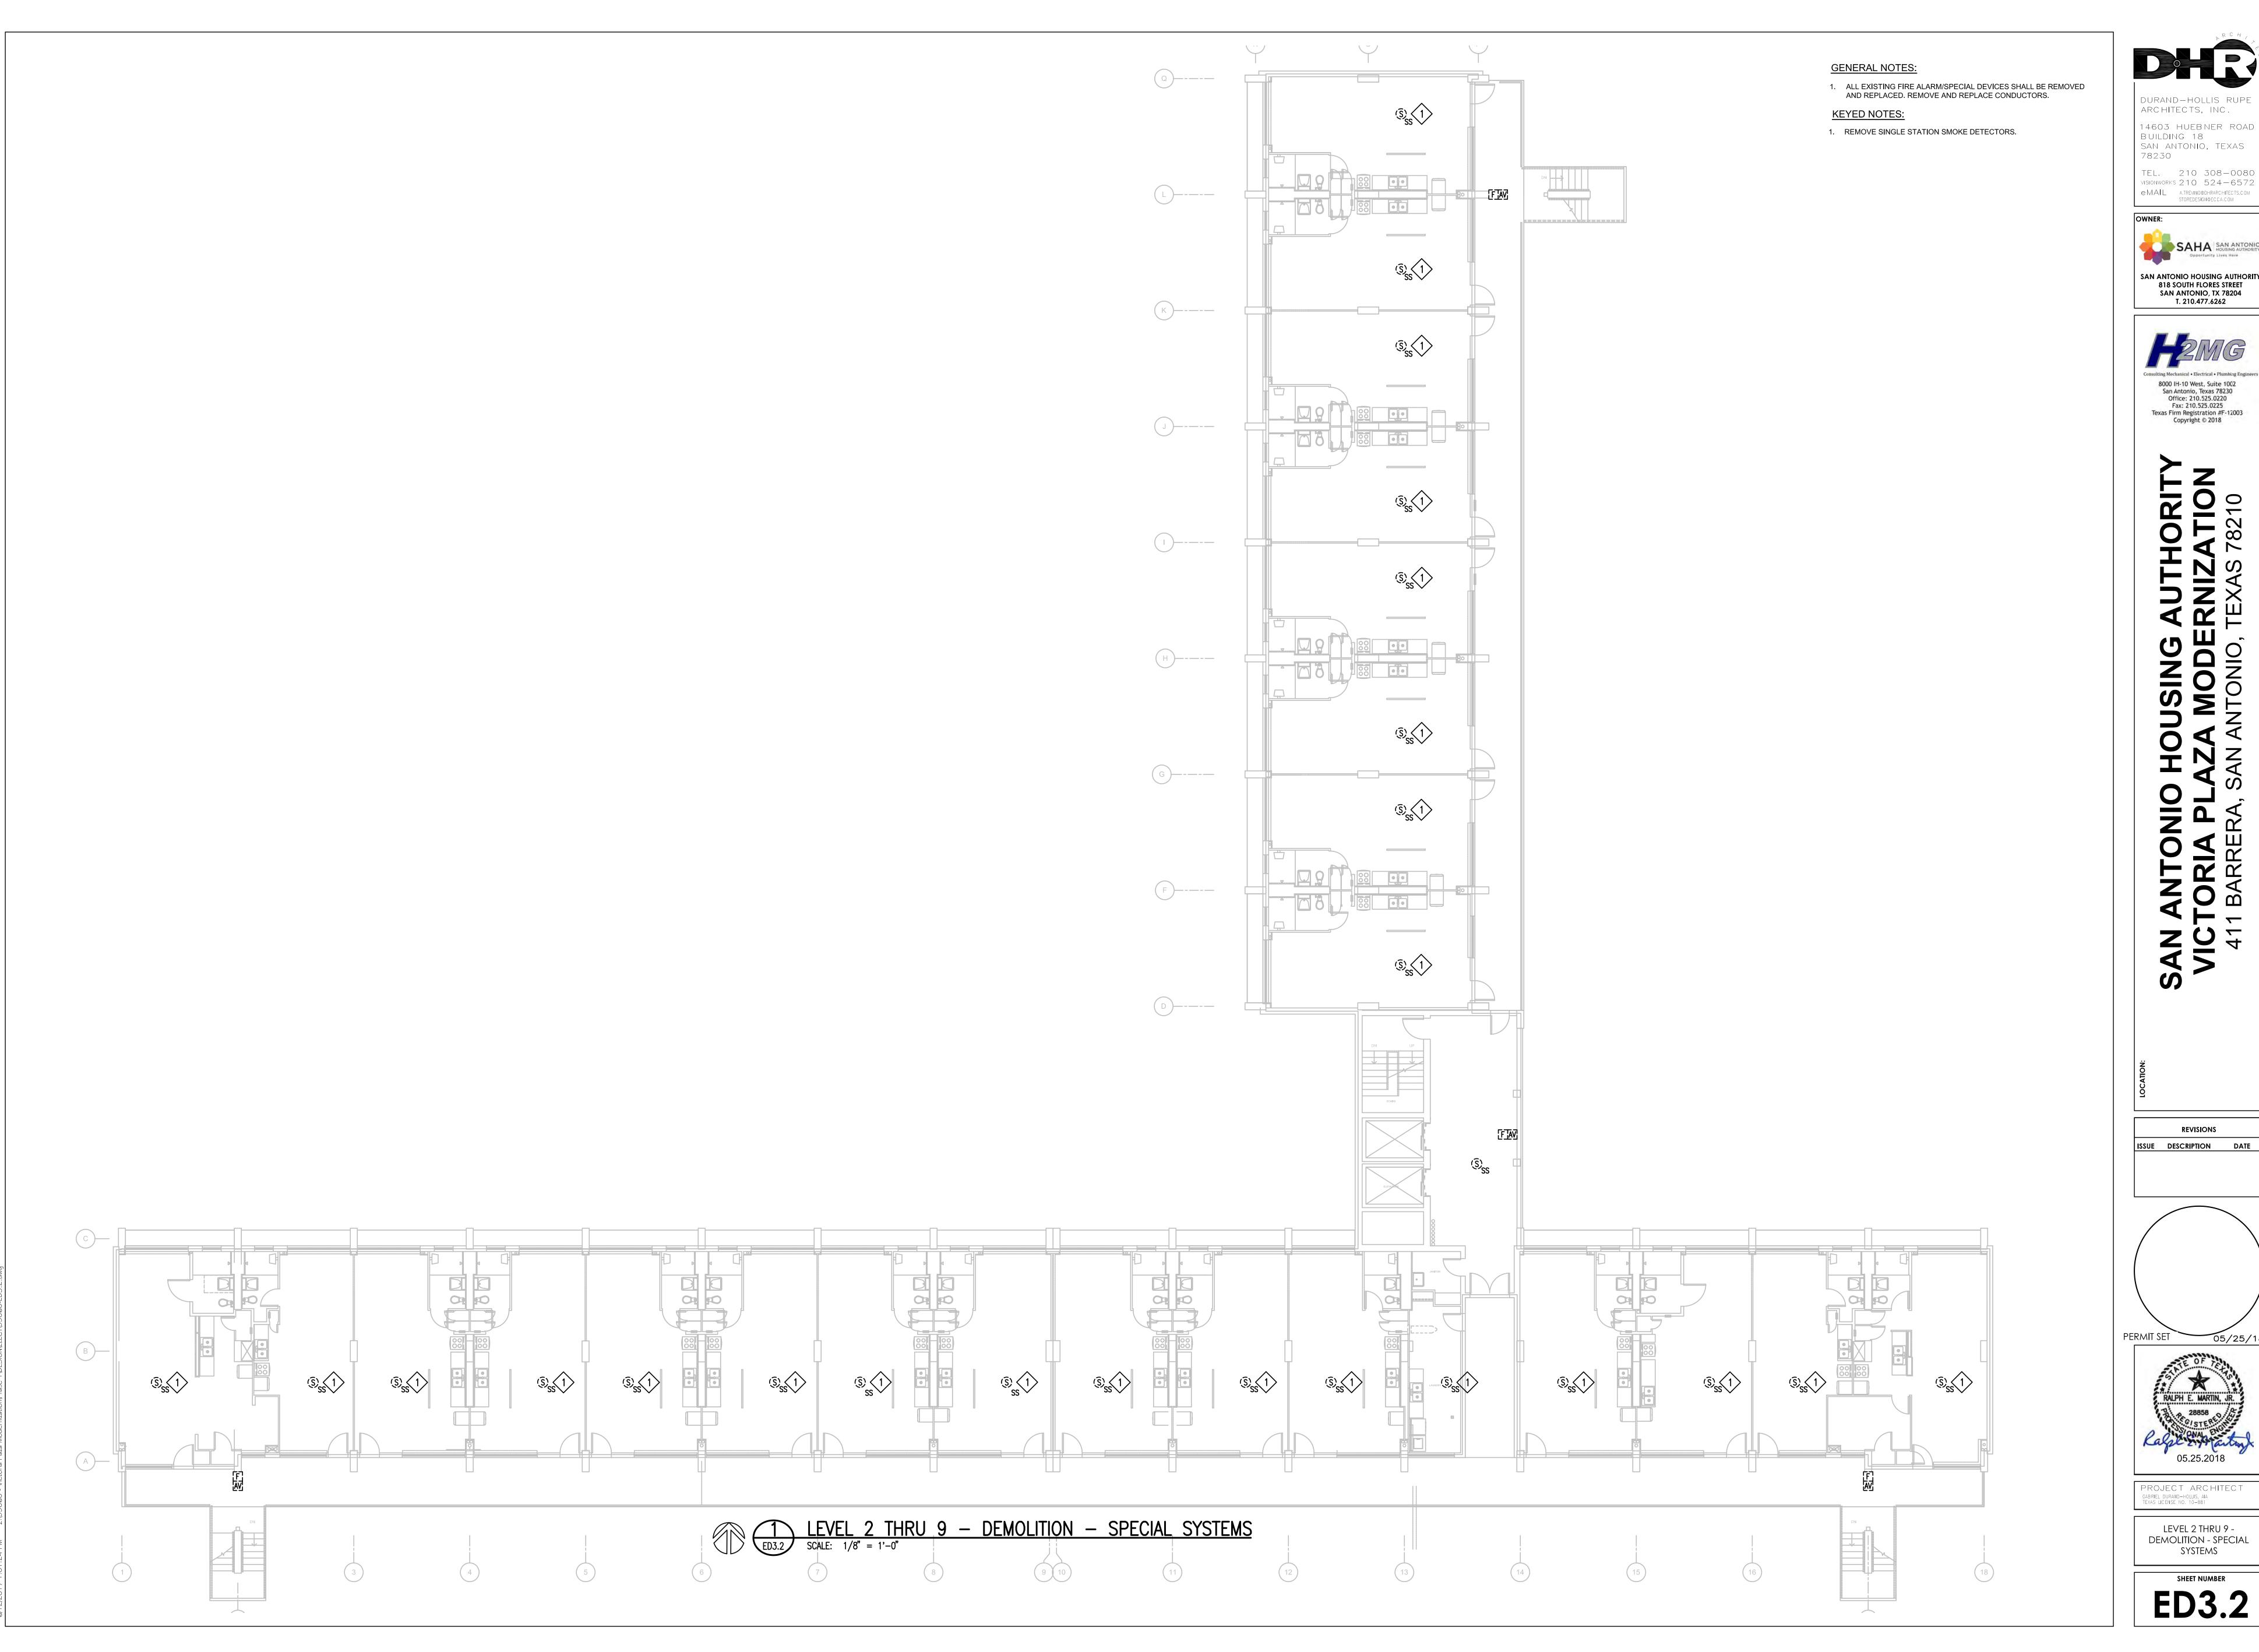
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TEXAS LICENSE NO. 10-881

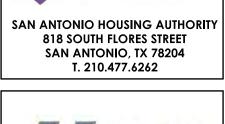LEVEL 1 - DEMOLITION -SPECIAL SYSTEMS

SHEET NUMBER

ED3.1






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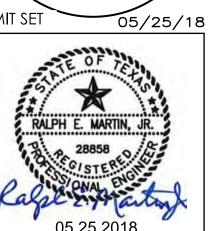
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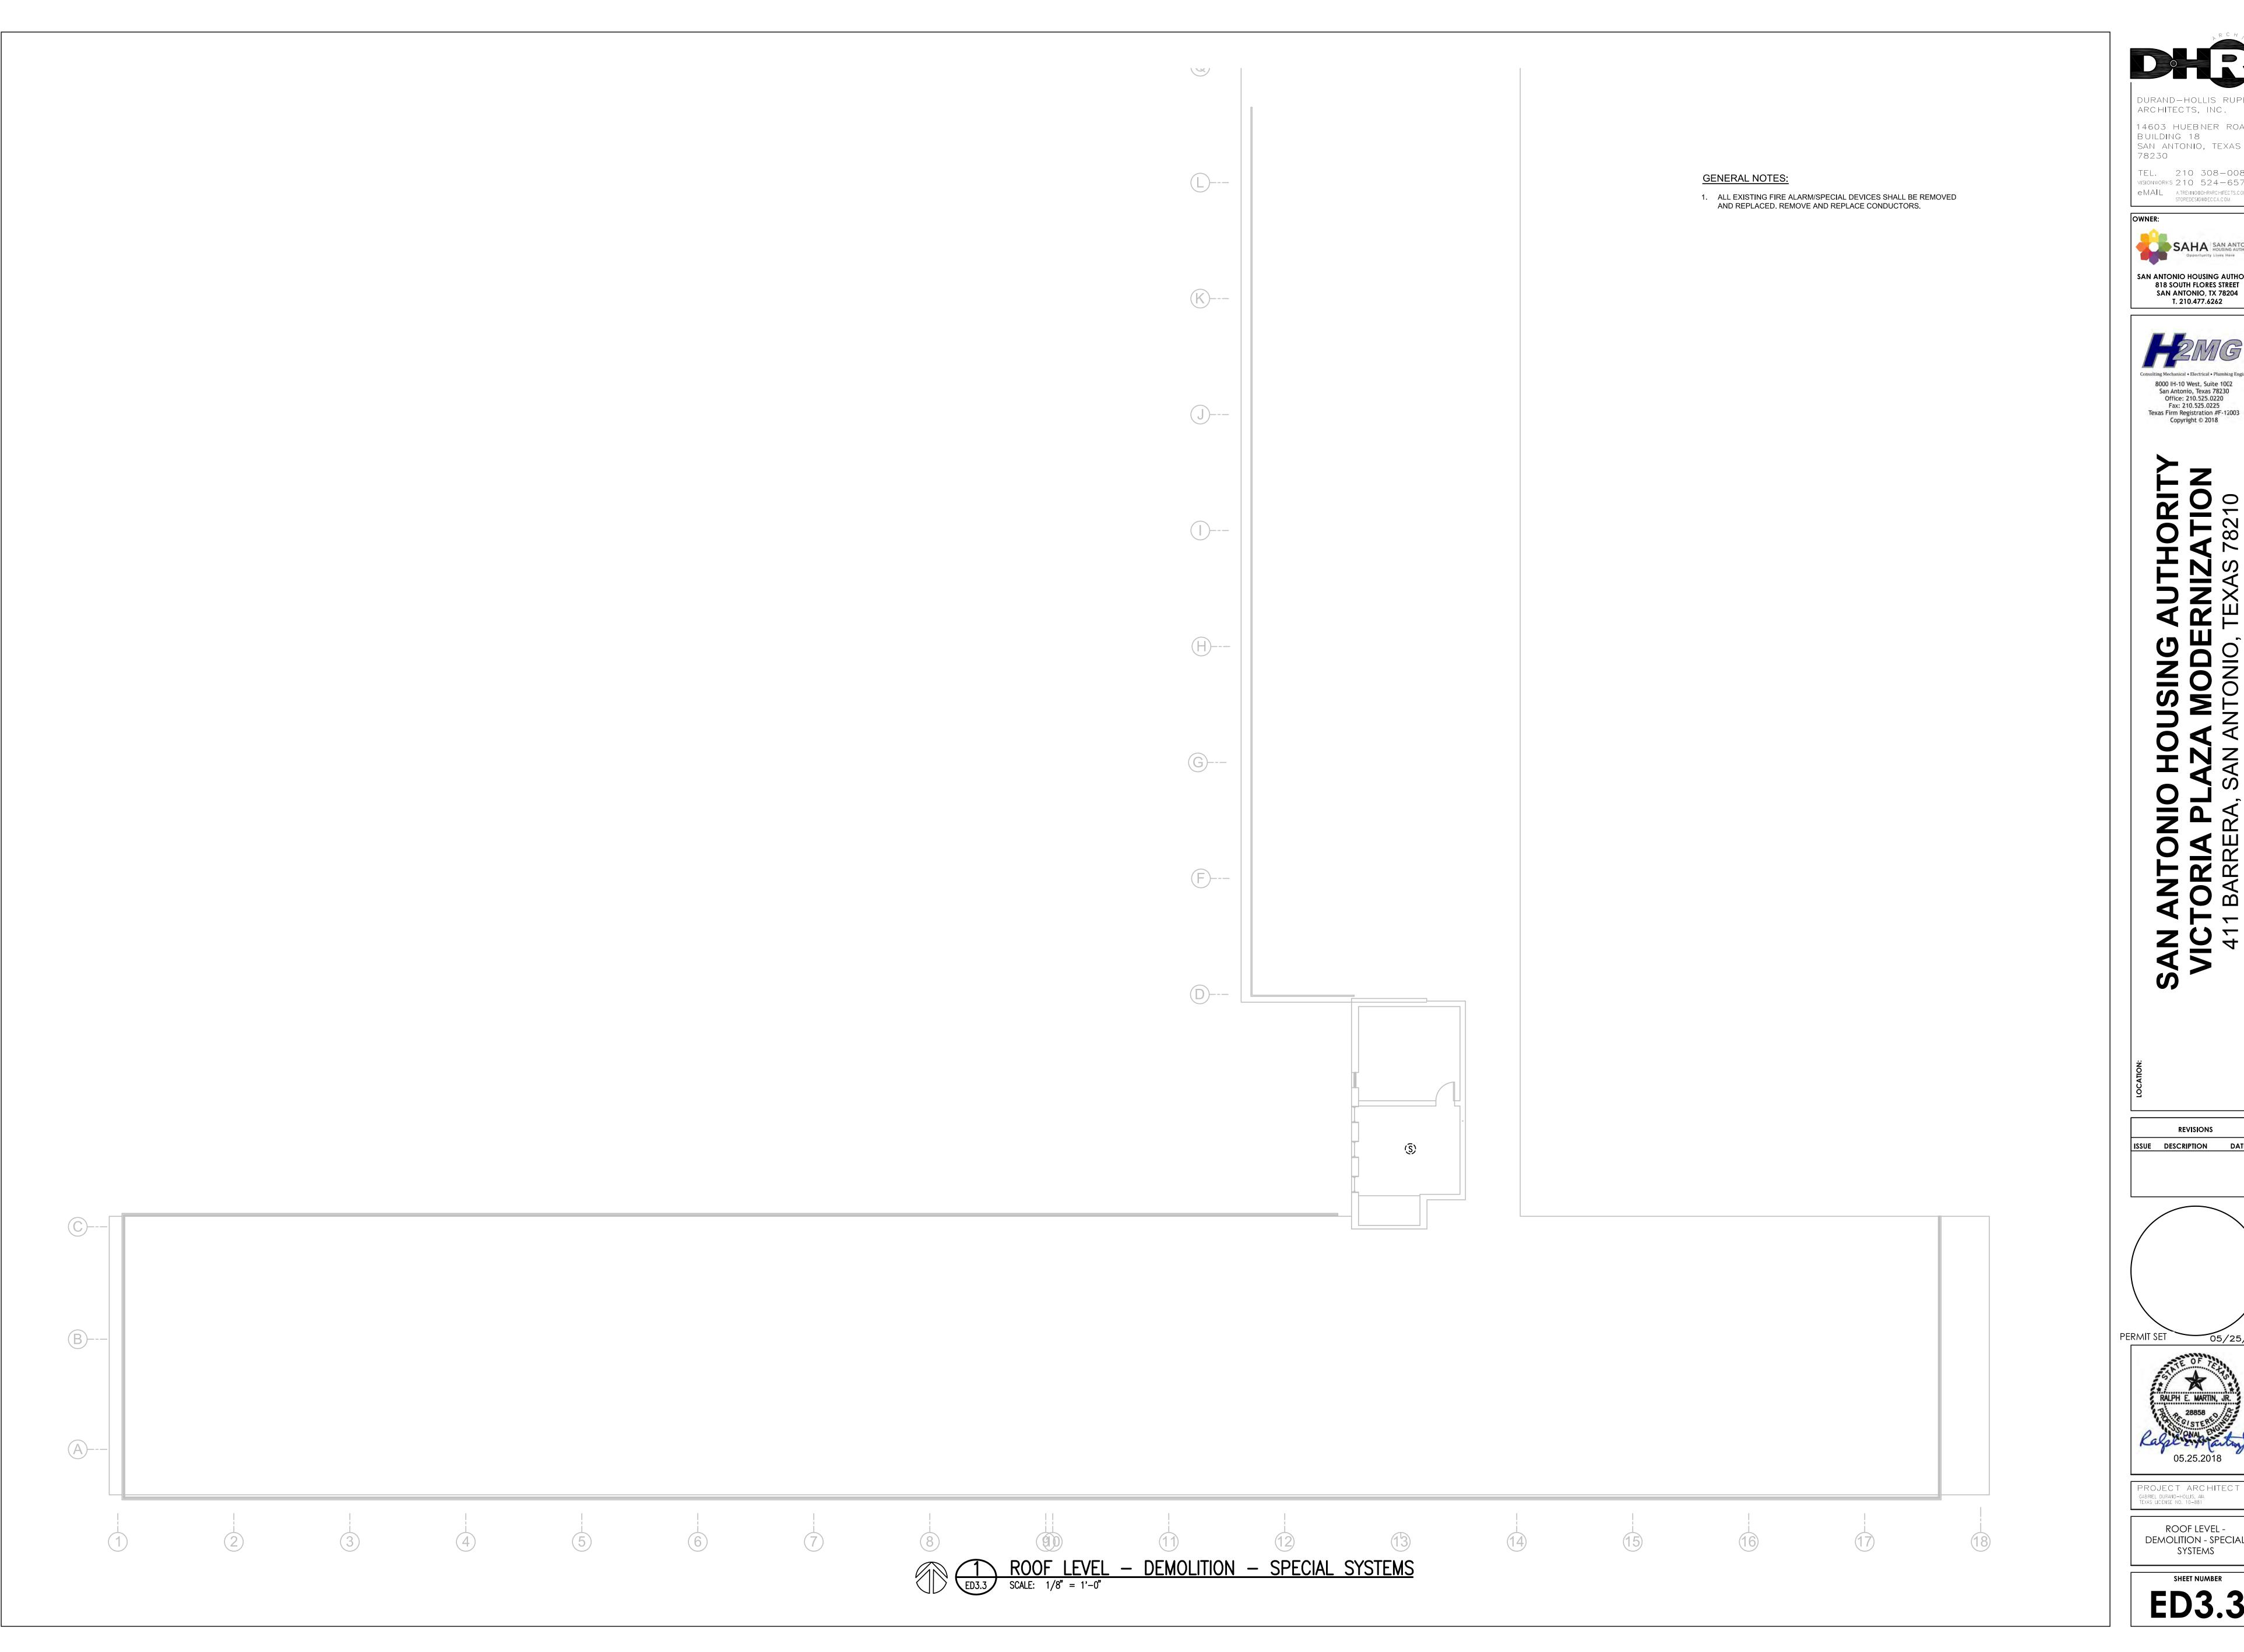




PROJECT ARCHITECT

LEVEL 2 THRU 9 -DEMOLITION - SPECIAL SYSTEMS

SHEET NUMBER **ED3.2**

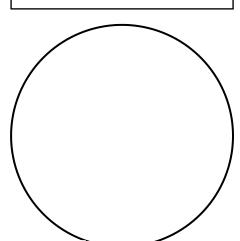



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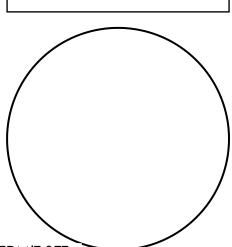
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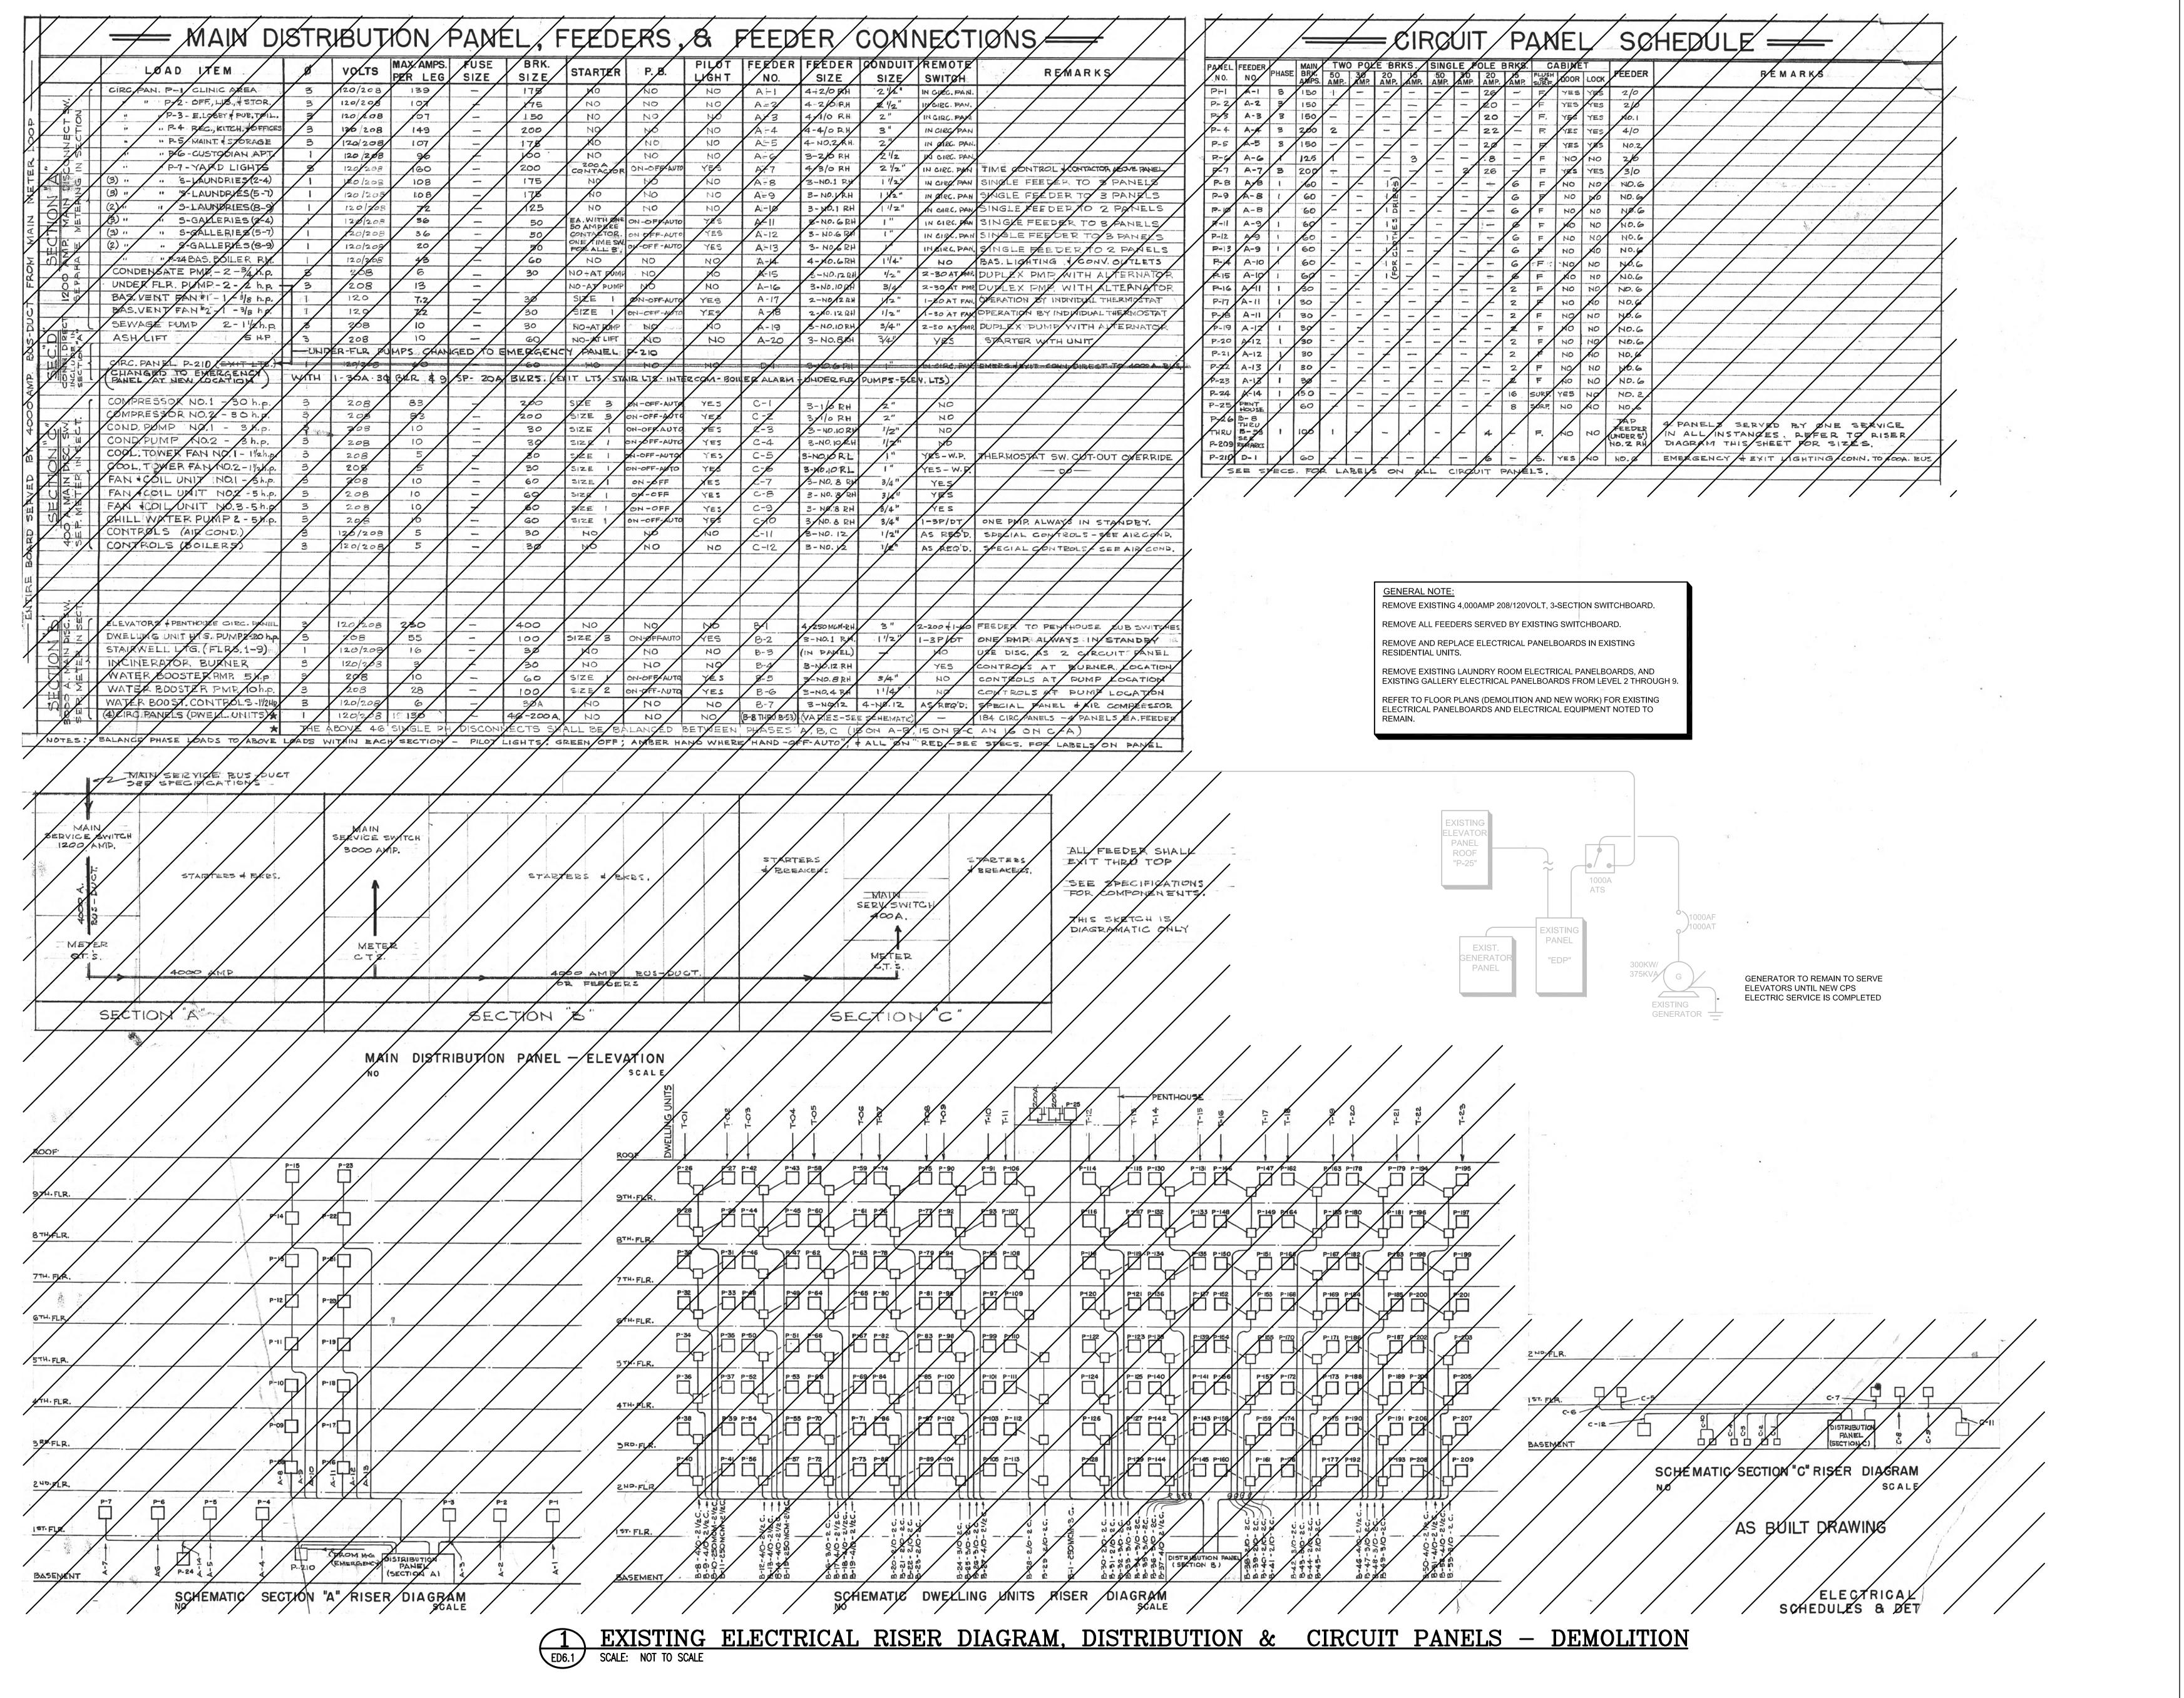




PROJECT ARCHITECT
GABRIEL DURAND-HOLLIS, AIA
TEXAS LICENSE NO. 10-881

roof level -Demolition - Special Systems

ED3.3





ARCHITECTS, INC. 14603 HUEBNER ROAD BUILDING 18 SAN ANTONIO, TEXAS 78230 TEL. 210 308-0080 visionworks 210 524-6572




eMAIL A.TREVINO@DHRARCHITECTS.COM





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REVISIONS ISSUE DESCRIPTION DATE





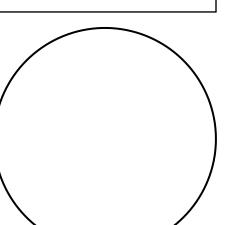
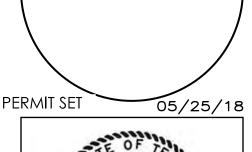
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EXISTING ELECTRICAL RISER DIAGRAM, DISTRIBUTION & CIRCUIT PANELS -DEMOLITION
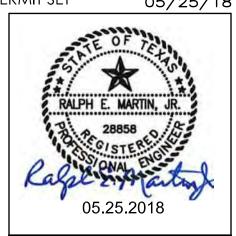
> SHEET NUMBER ED6.