

NORTHWOODS
1402 YUKON ST
HUNTSVILLE, ALABAMA 35816
(114 BUILDINGS - BASE BID)
(9 BUILDINGS - DEDUCT ALT 1)
(1 BUILDING - DEDUCT ALT 2)



LEGEND:

BUILDING - A	BUILDING TYPE
200	BUILDING NUMBER
(A)	UNIT TYPE
---	CONTRACT LIMITS

ROOF AREA CALCULATIONS

BLDG TYPE	QUANTITY*	ESTIMATED ROOF AREA'
A	10	1,716 SF.
B	8	1,716 SF. (1 BLDG ALT #3)
C	23	2,141 SF. (1 BLDG ALT #1)
D	17	2,741 SF. (2 BLDGS ALT #2) (1 BLDG ALT #4)
E	13	2,741 SF. (1 BLDG ALT #4)
F	3	2,321 SF.
G	6	3,330 SF.
H	21	2,729 SF.
I	5	2,876 SF.
J	17	2,691 SF. (1 BLDG ALT #1) (1 BLDG ALT #3) (1 BLDG ALT #4)
ADMIN	1	5,270 SF. (ALT #5)
TOTAL	124	

*EDT-THA CANNOT ATTEST FOR THE ACCURACY IN THESE FIGURES.
 EDT-THA NUMBERS OBTAINED VIA A MIXTURE OF ROUGH FIELD MEASUREMENTS, SATELLITE PHOTOS AND EXISTING RECORD DRAWINGS.



8514 Whitesburg Drive
 Huntsville, AL 35802
 office 256.883.8496

www.edttha.com



REROOFING FOR NORTHWOODS

OWNER
 HUNTSVILLE HOUSING AUTHORITY
 PROJECT ADDRESS
 1402 YUKON STREET
 HUNTSVILLE, AL 35816

ISSUE DATE	3/26/2024
ISSUED	BID DOCUMENTS
ADPH NUMBER	
PROJECT NUMBER	24T-16-00400
REVISIONS	No. Description Date

DRAWING TITLE
NORTHWOODS
ARCHITECTURAL
SITE PLAN

DRAWING NO.
A-101.1


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SITE PLAN
 NORTHWOODS_ARCHITECTURAL SITE PLAN


1" = 100'-0"
 0 25' 50' 100' 200'

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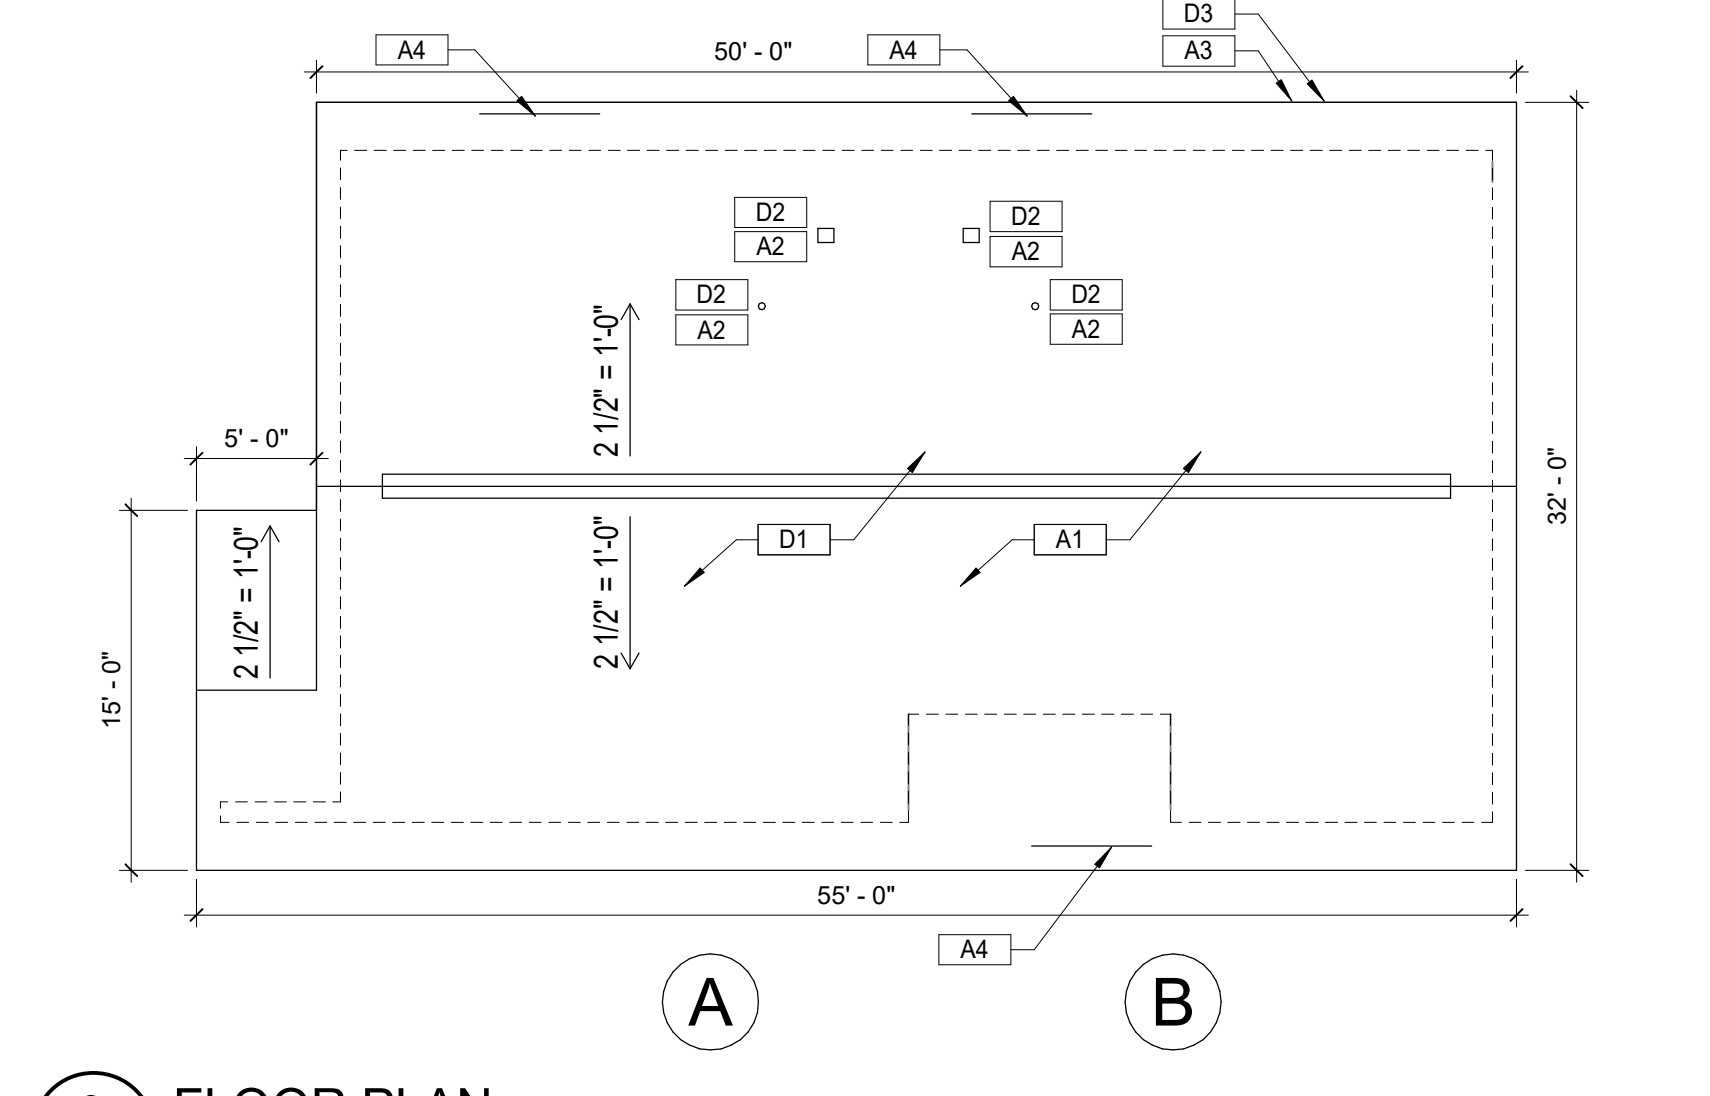
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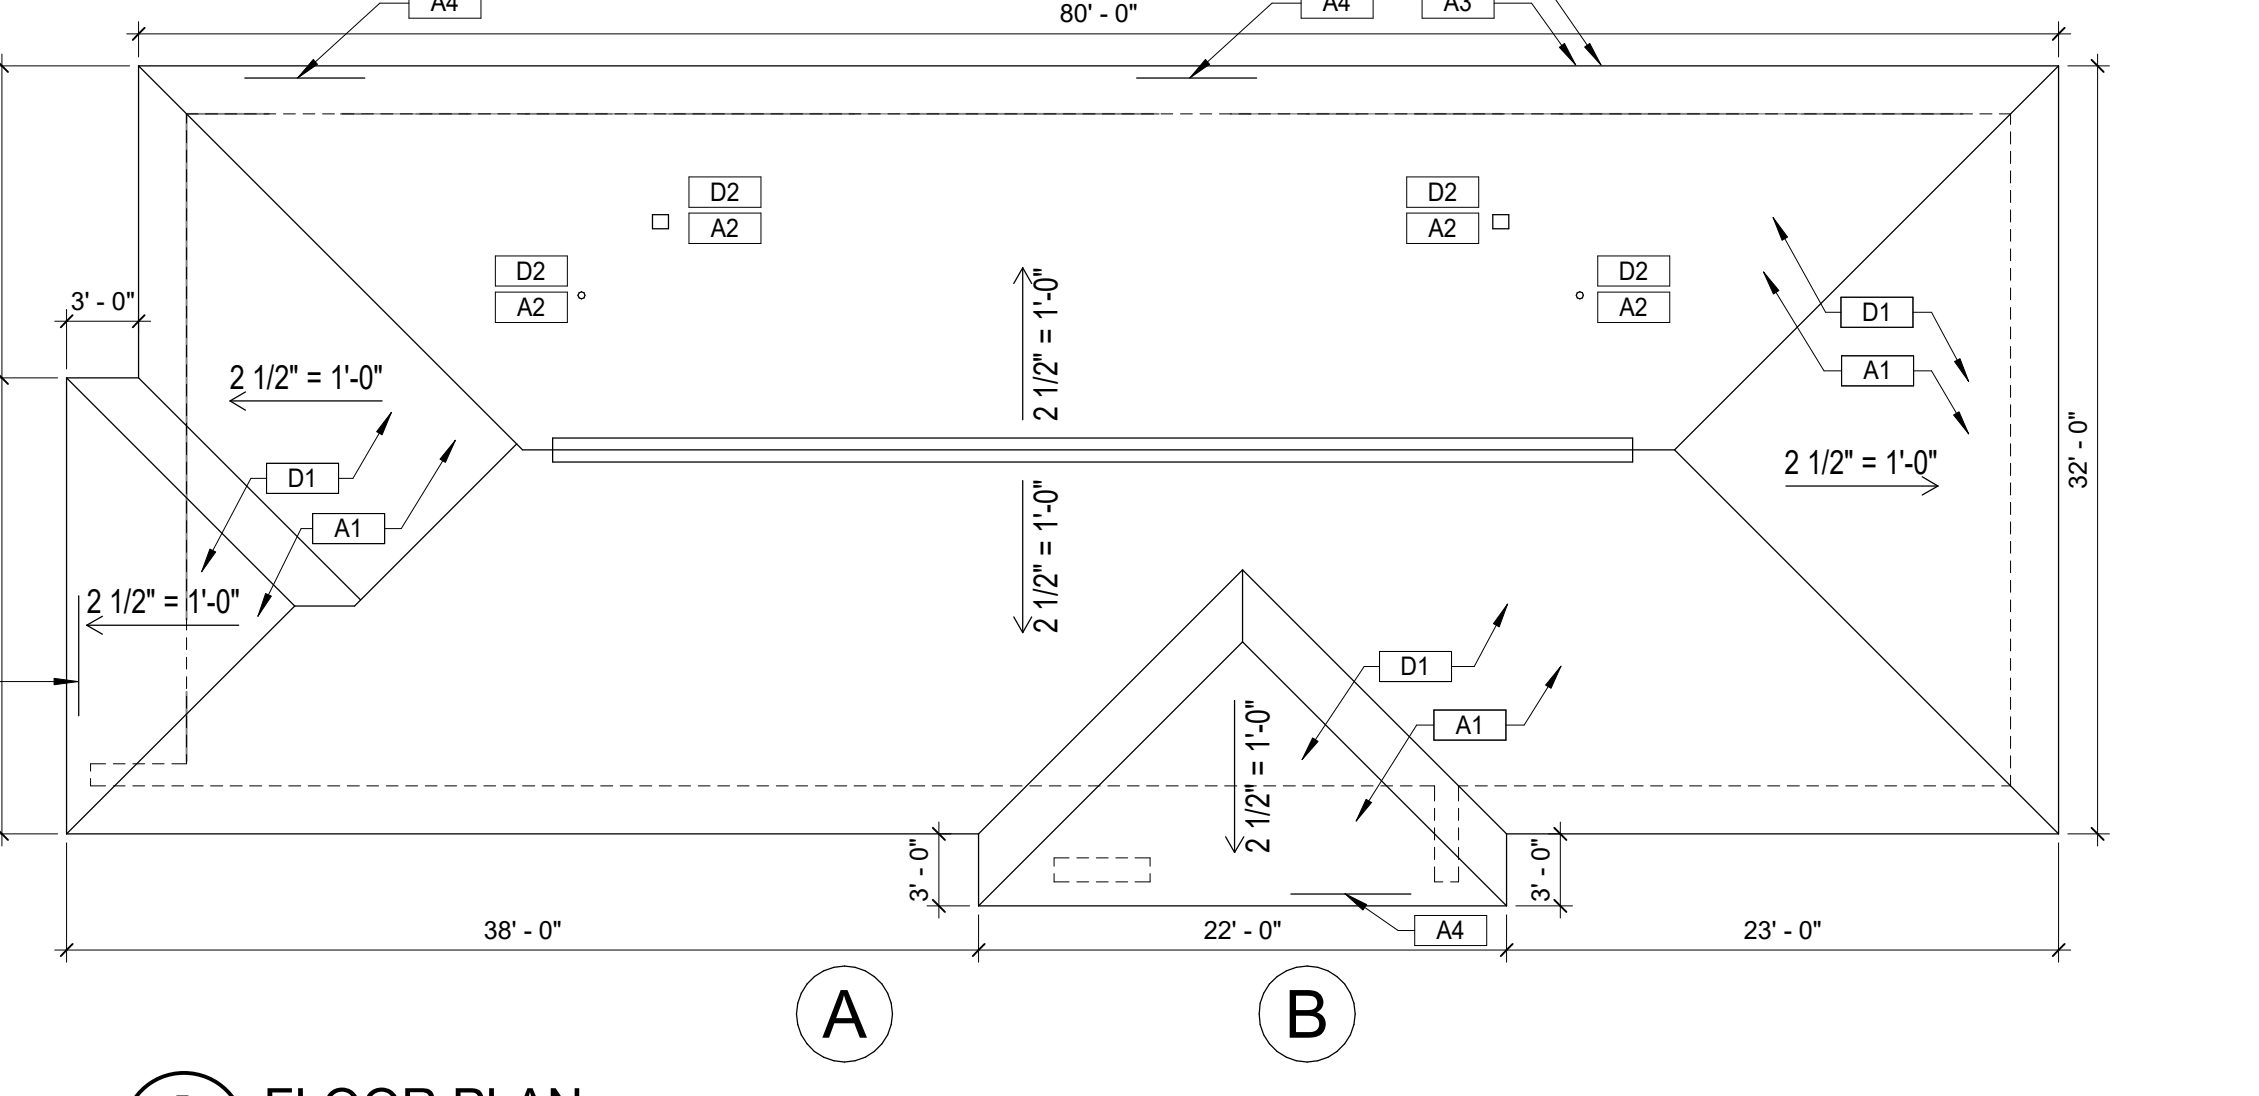
1 FLOOR PLAN
BUILDING A
1/8" = 1'-0"
ESTIMATED ROOF AREA MEASURED ALONG SLOPE = 1,716 SQ. FT.




4 FLOOR PLAN
BUILDING D
1/8" = 1'-0"
ESTIMATED ROOF AREA MEASURED ALONG SLOPE = 2,741 SQ. FT.
NOTE:
(3) BUILDINGS ON ARCTIC STREET ARE DEDUCT ALTERNATE #1.

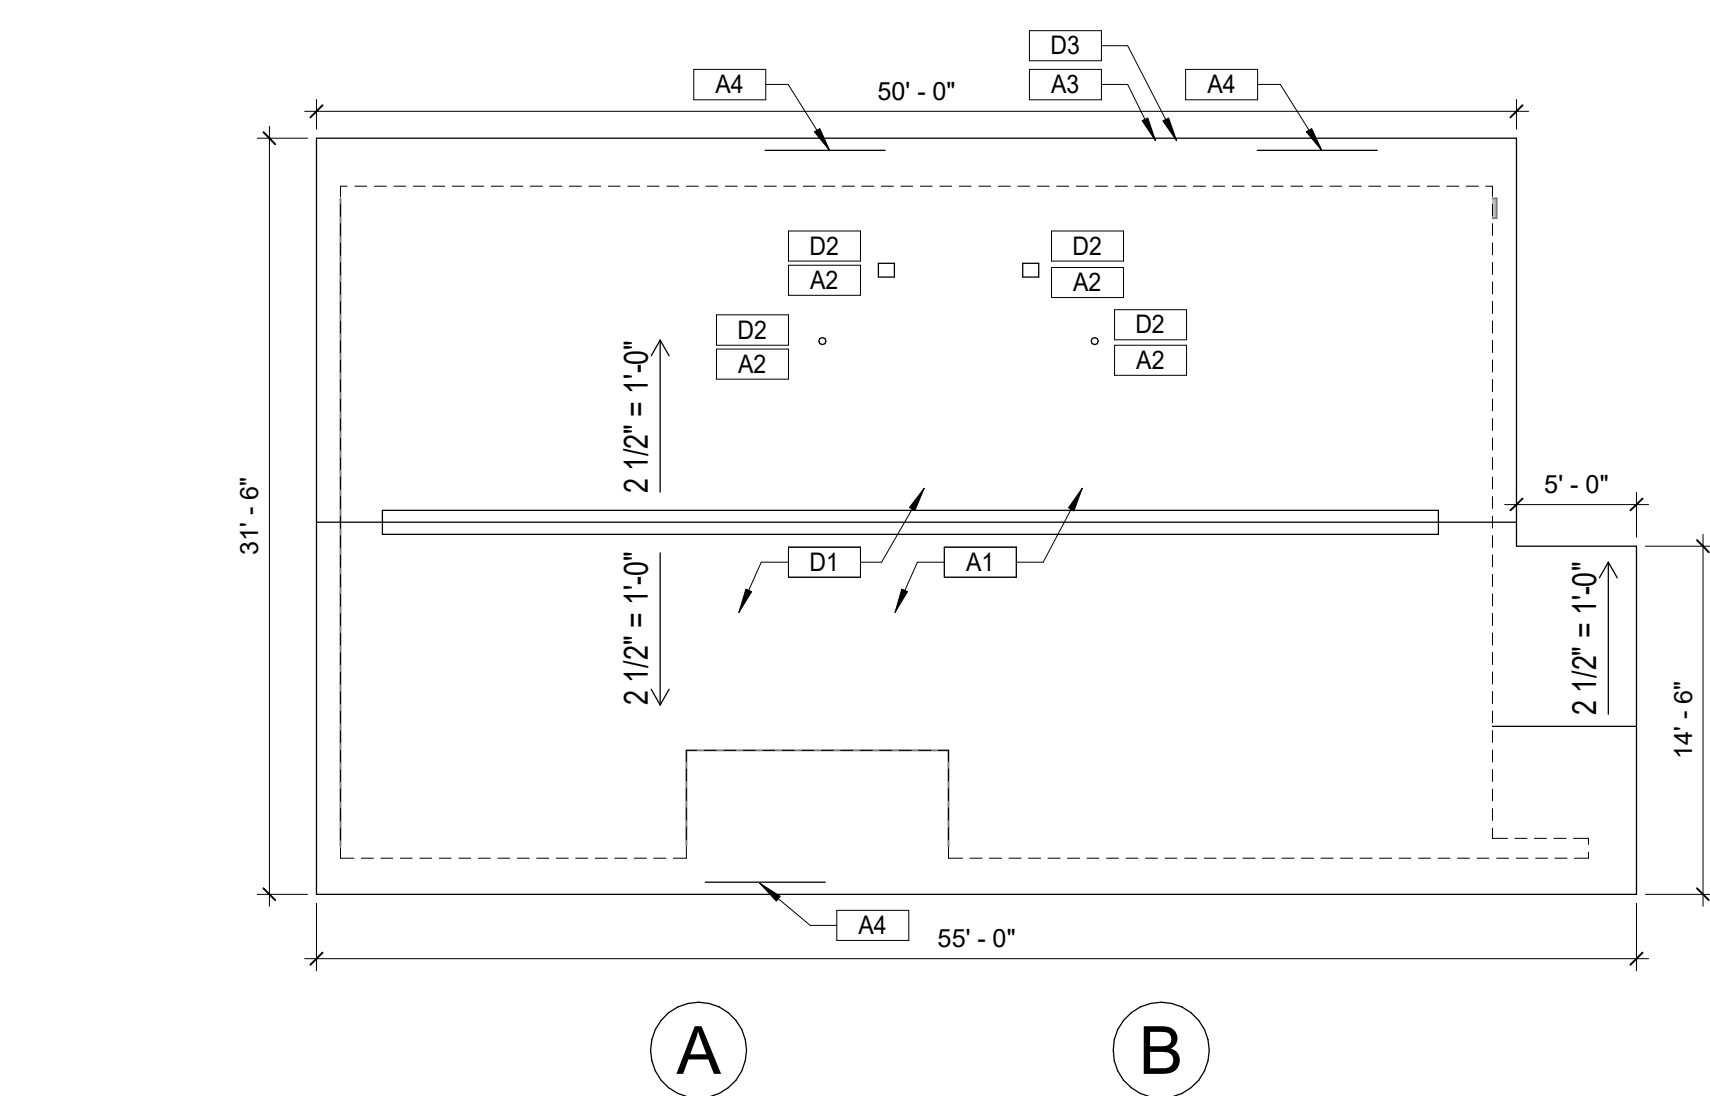

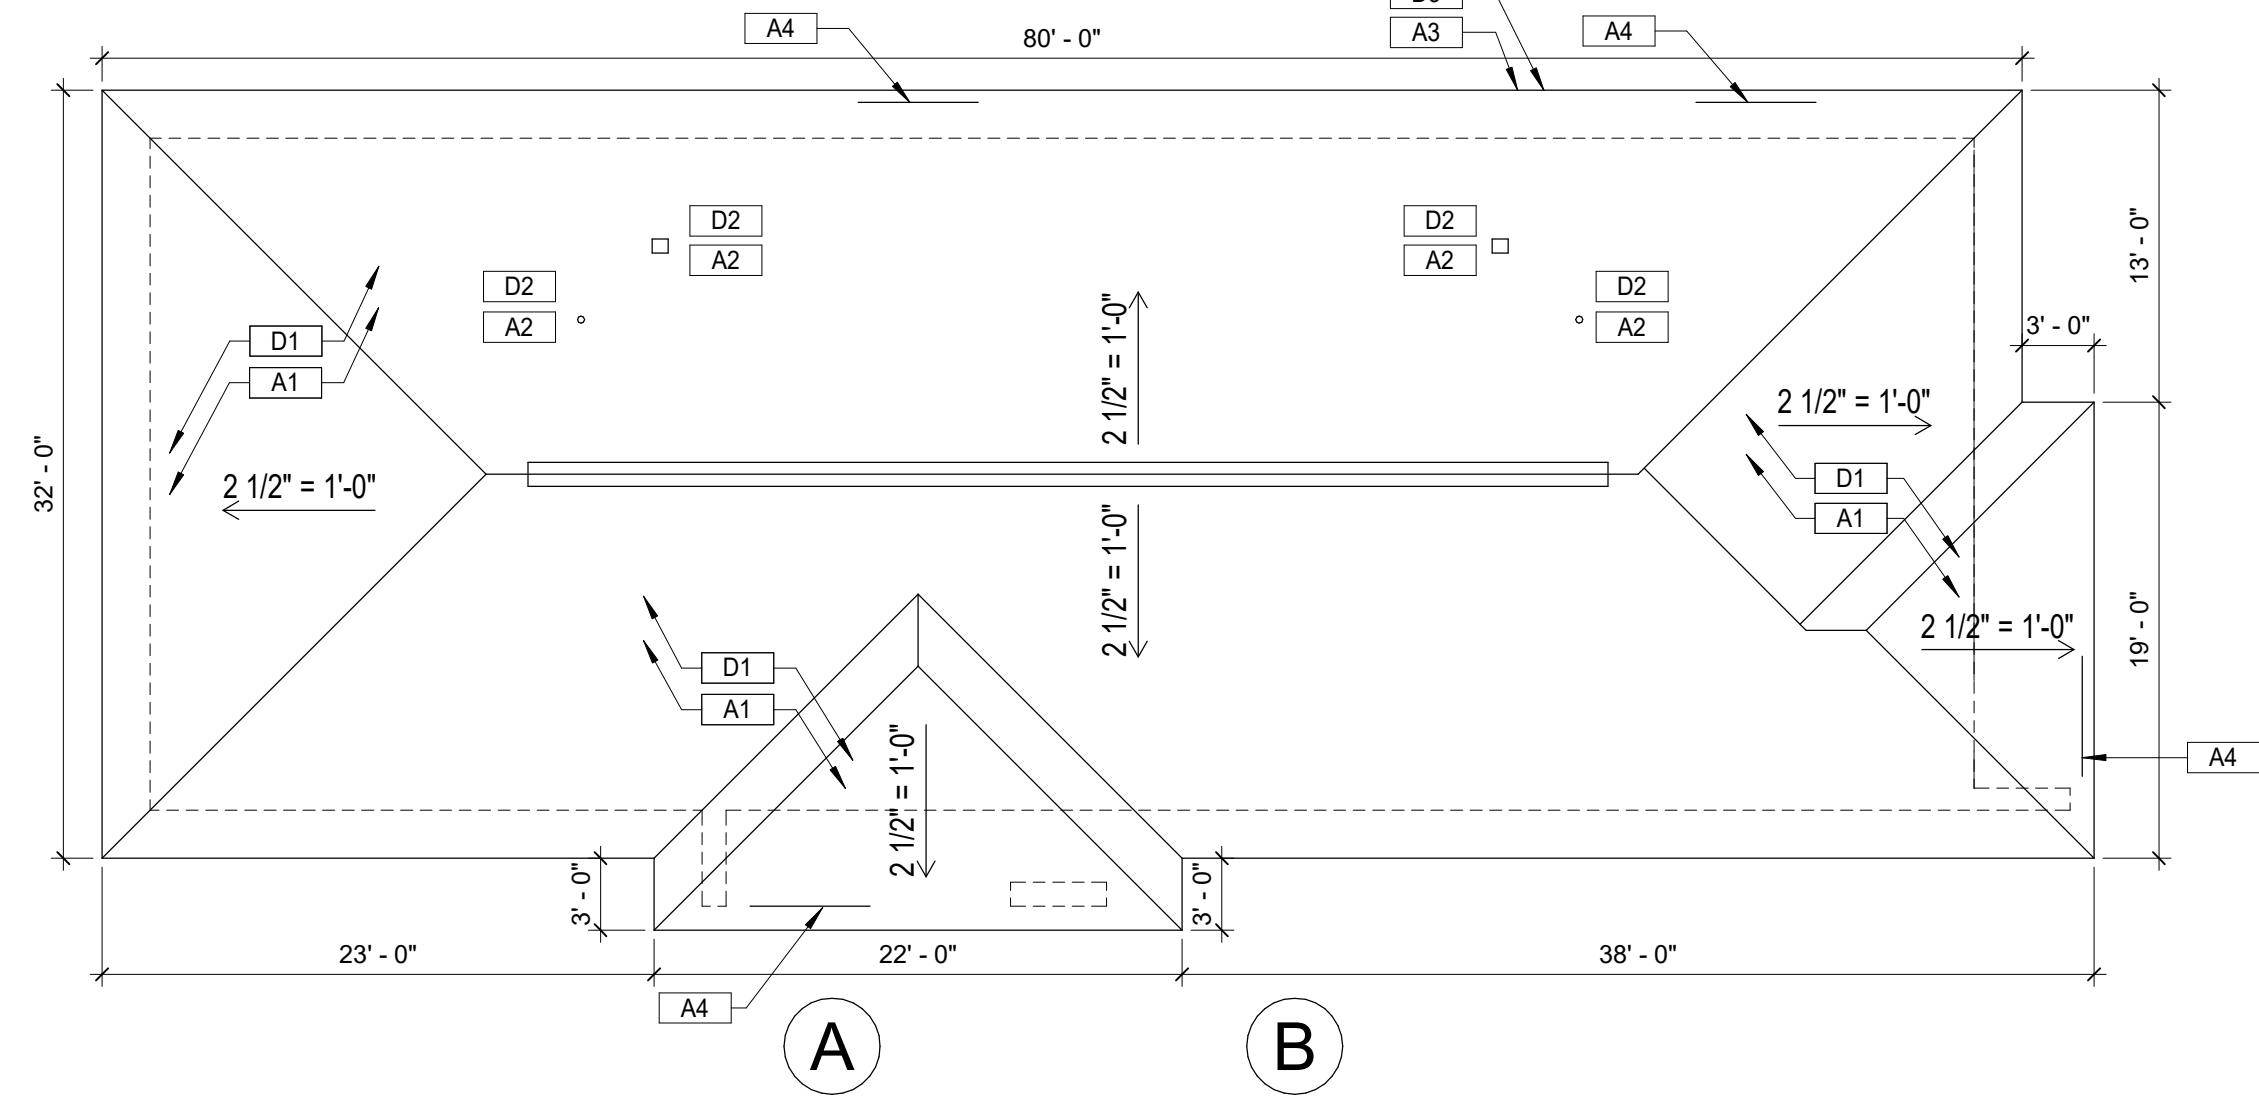2 FLOOR PLAN
BUILDING B
1/8" = 1'-0"
ESTIMATED ROOF AREA MEASURED ALONG SLOPE = 1,716 SQ. FT.
NOTE:
(1) BUILDING ON ARCTIC STREET IS DEDUCT ALTERNATE #1.



5 FLOOR PLAN
BUILDING E
1/8" = 1'-0"
ESTIMATED ROOF AREA MEASURED ALONG SLOPE = 2,741 SQ. FT.
NOTE:
(1) BUILDING ON ARCTIC STREET IS DEDUCT ALTERNATE #1.

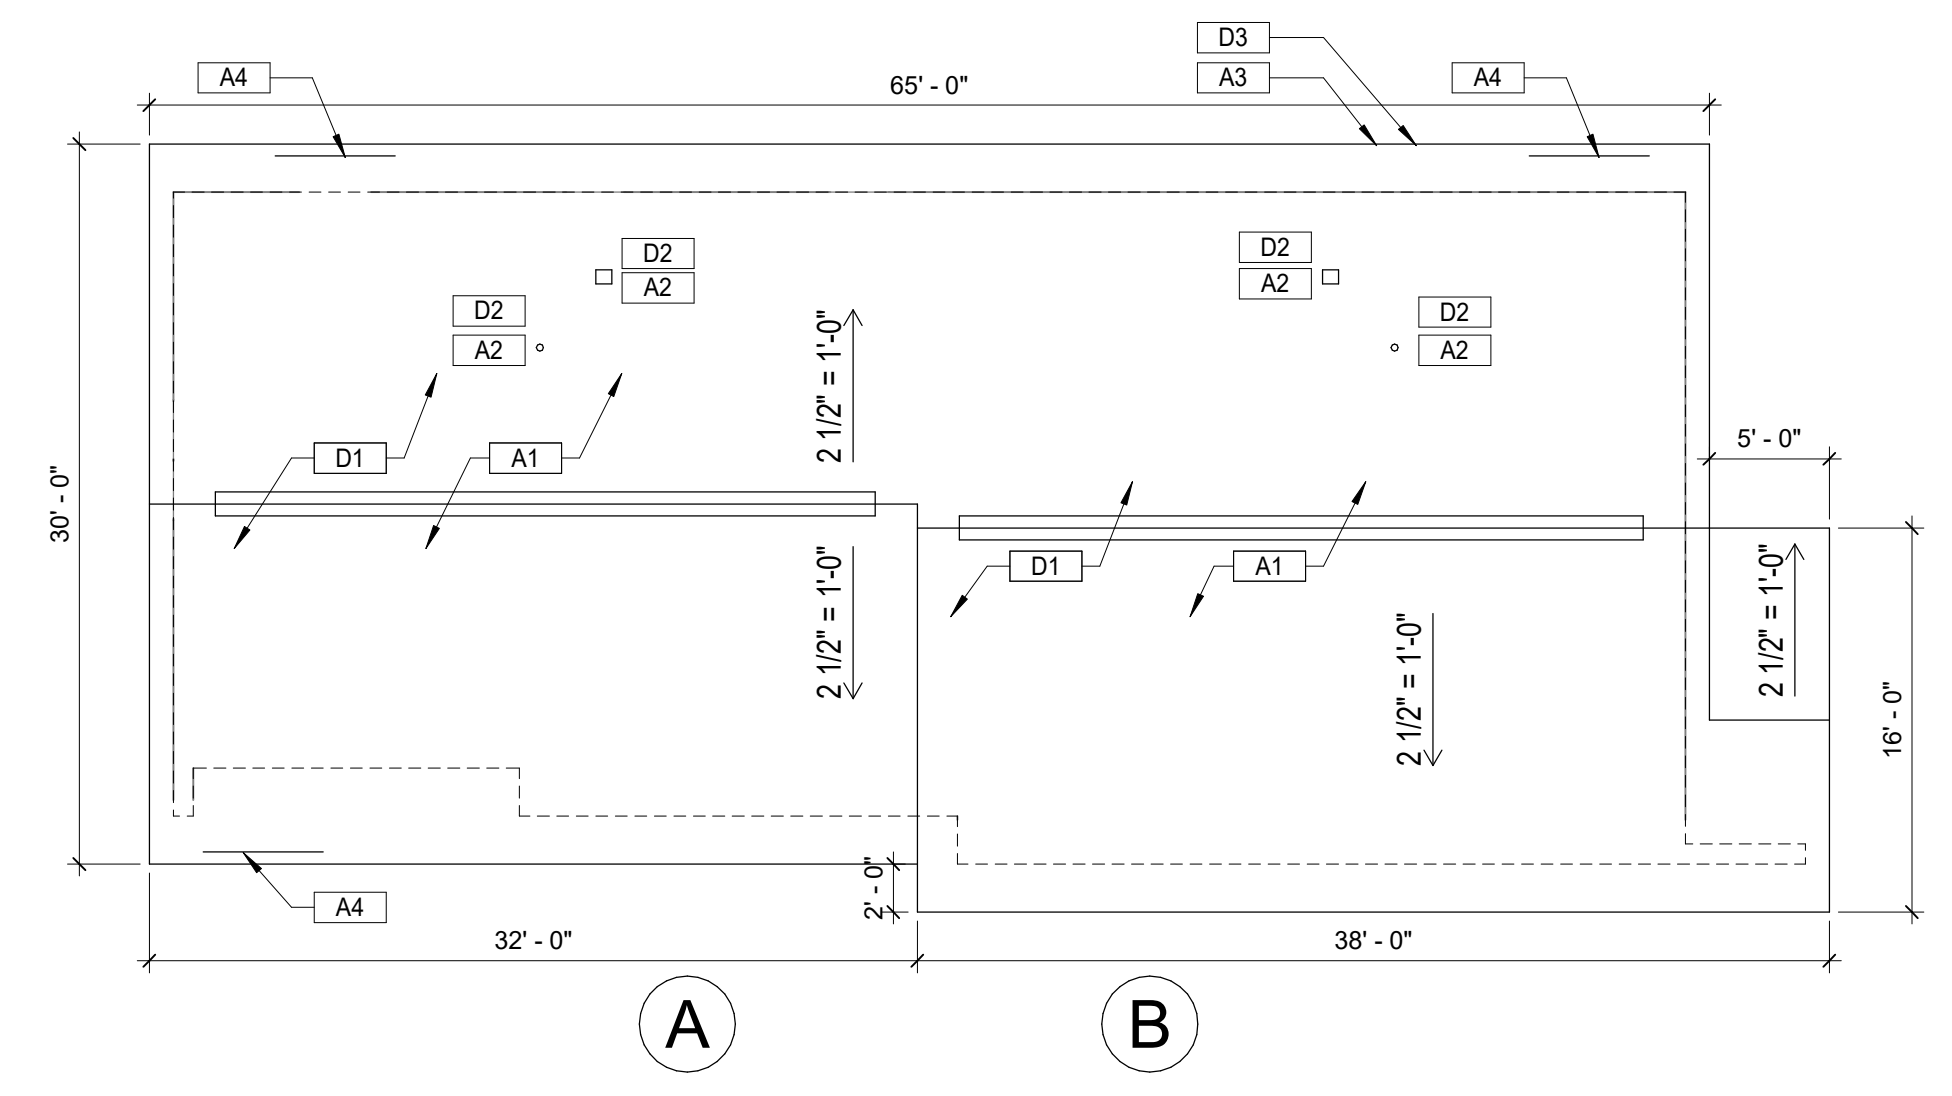

3 FLOOR PLAN
BUILDING C
1/8" = 1'-0"
ESTIMATED ROOF AREA MEASURED ALONG SLOPE = 2,141 SQ. FT.
NOTE:
(1) BUILDING ON ARCTIC STREET IS DEDUCT ALTERNATE #1.

- ROOF DEMOLITION NOTES:**
- ALL INFORMATION SHOWN IS BASED ON FIELD MEASUREMENTS AND EXISTING RECORD DRAWINGS. CONTRACTOR TO VERIFY ALL EXISTING FIELD CONDITIONS PRIOR TO BEGINNING ANY DEMOLITION. NOTIFY ARCHITECT IMMEDIATELY OF ANY DISCREPANCIES BETWEEN DRAWINGS AND ACTUAL FIELD CONDITIONS.
 - REFER TO A-101.1 FOR THE CAMPUS CONFIGURATION OF THE 124 BUILDINGS WITHIN THIS PROJECT SCOPE.
 - COORDINATE WITH OWNER FOR ANY ITEMS TO BE SALVAGED.
 - ALL DEMOLITION WORK SHALL COMPLY WITH ALL FEDERAL, STATE, AND LOCAL REQUIREMENTS, INCLUDING WASTE DISPOSAL.
 - PROTECT FROM WEATHER AND DAMAGE ALL EXISTING ITEMS NOT SHOWN TO BE REMOVED.
 - ALL DEMOLITION & CONSTRUCTION DEBRIS TO BE HAULED OFF SITE AND LEGALLY DISPOSED OF AT A PERMITTED LOCATION.

Keynote Legend Demolition	
Key Value	Keynote Text

D1	REMOVE EXISTING ROOF DOWN TO OSB/PLYWOOD SUBSTRATE. INSPECT AND REPLACE DAMAGED SUBSTRATE WITH NEW OSB/PLYWOOD TO MATCH EXISTING.
D2	ROOF VENT LOCATIONS AND QUANTITY VARY BY BUILDING.
D3	REMOVE DRIP EDGE FLASHING.

- ROOF GENERAL NOTES:**
- ALL INFORMATION SHOWN IS BASED ON FIELD MEASUREMENTS AND EXISTING RECORD DRAWINGS. CONTRACTOR TO VERIFY ALL EXISTING FIELD CONDITIONS PRIOR TO BEGINNING ANY DEMOLITION. NOTIFY ARCHITECT IMMEDIATELY OF ANY DISCREPANCIES BETWEEN DRAWINGS AND ACTUAL FIELD CONDITIONS.
 - REFER TO A-101.1 FOR THE CAMPUS CONFIGURATION OF THE 124 BUILDINGS WITHIN THIS PROJECT SCOPE.
 - ALL ROOFS TO BE ASPHALT SHINGLES UNLESS NOTED OTHERWISE.
 - NEW ROOF VENTS TO BE MANUFACTURER STANDARD.
 - NEW DRIP EDGE AT ALL ROOF EDGES. COLOR TO BE SELECTED BY ARCHITECT.
 - SLOPES TO MAINTAIN EXISTING SLOPES. SEE ROOF PLANS FOR ASSUMED SLOPE.
 - FLASH AND SEAL ALL EXISTING ROOF PENETRATIONS.
 - DO NOT DROP SHINGLE BUNDLES OR OTHER LARGE ITEMS ON TOP OF ROOF. INTERIOR FINISHES SUCH AS PLASTER AND OCCUPANT ITEMS MAY BREAK. CONTRACTOR MAY BE RESPONSIBLE FOR DAMAGES CAUSED.
 - PROVIDE 5' LINEAR ALUMINUM RAIN DIVERTERS IN FRONT OF BUILDING ENTRYWAYS TO DEFLECT RAINWATER AWAY FROM THE PATH OF EGRESS.

Keynote Legend New	
Key Value	Keynote Text

A1	NEW SHINGLE ROOF OVER UNDERLAYMENT. SEE ROOF PLANS FOR ASSUMED SLOPE.
A2	EXISTING ROOF PENETRATIONS TO BE RE-FLASHED AND CAULKED AS REQUIRED. PRECISE LOCATION AND QUANTITY MAY VARY DEPENDING ON BUILDING ORIENTATION AND/OR OTHER FACTORS.
A3	NEW DRIP EDGE AT ALL ROOF EDGES.
A4	5 FOOT LINEAR ALUMINUM RAIN DIVERTER. IN FRONT OF BUILDING ENTRYWAYS TO DEFLECT RAINWATER AWAY FROM PATH OF EGRESS BELOW. ATTACHED PER MANUFACTURER RECOMMENDATIONS. PRECISE LOCATION MAY VARY DEPENDING ON BUILDING ORIENTATION.



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OWNER
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PROJECT ADDRESS
1400 WILKINS STREET
HUNTSVILLE, AL 35816

ISSUE DATE
3/26/2024

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BID DOCUMENTS

ADPH NUMBER


PROJECT NUMBER
24T-16-00400

REVISIONS
No. Description Date


DRAWING TITLE
NORTHWOODS
FLOOR PLANS

DRAWING NO.
A-101.2


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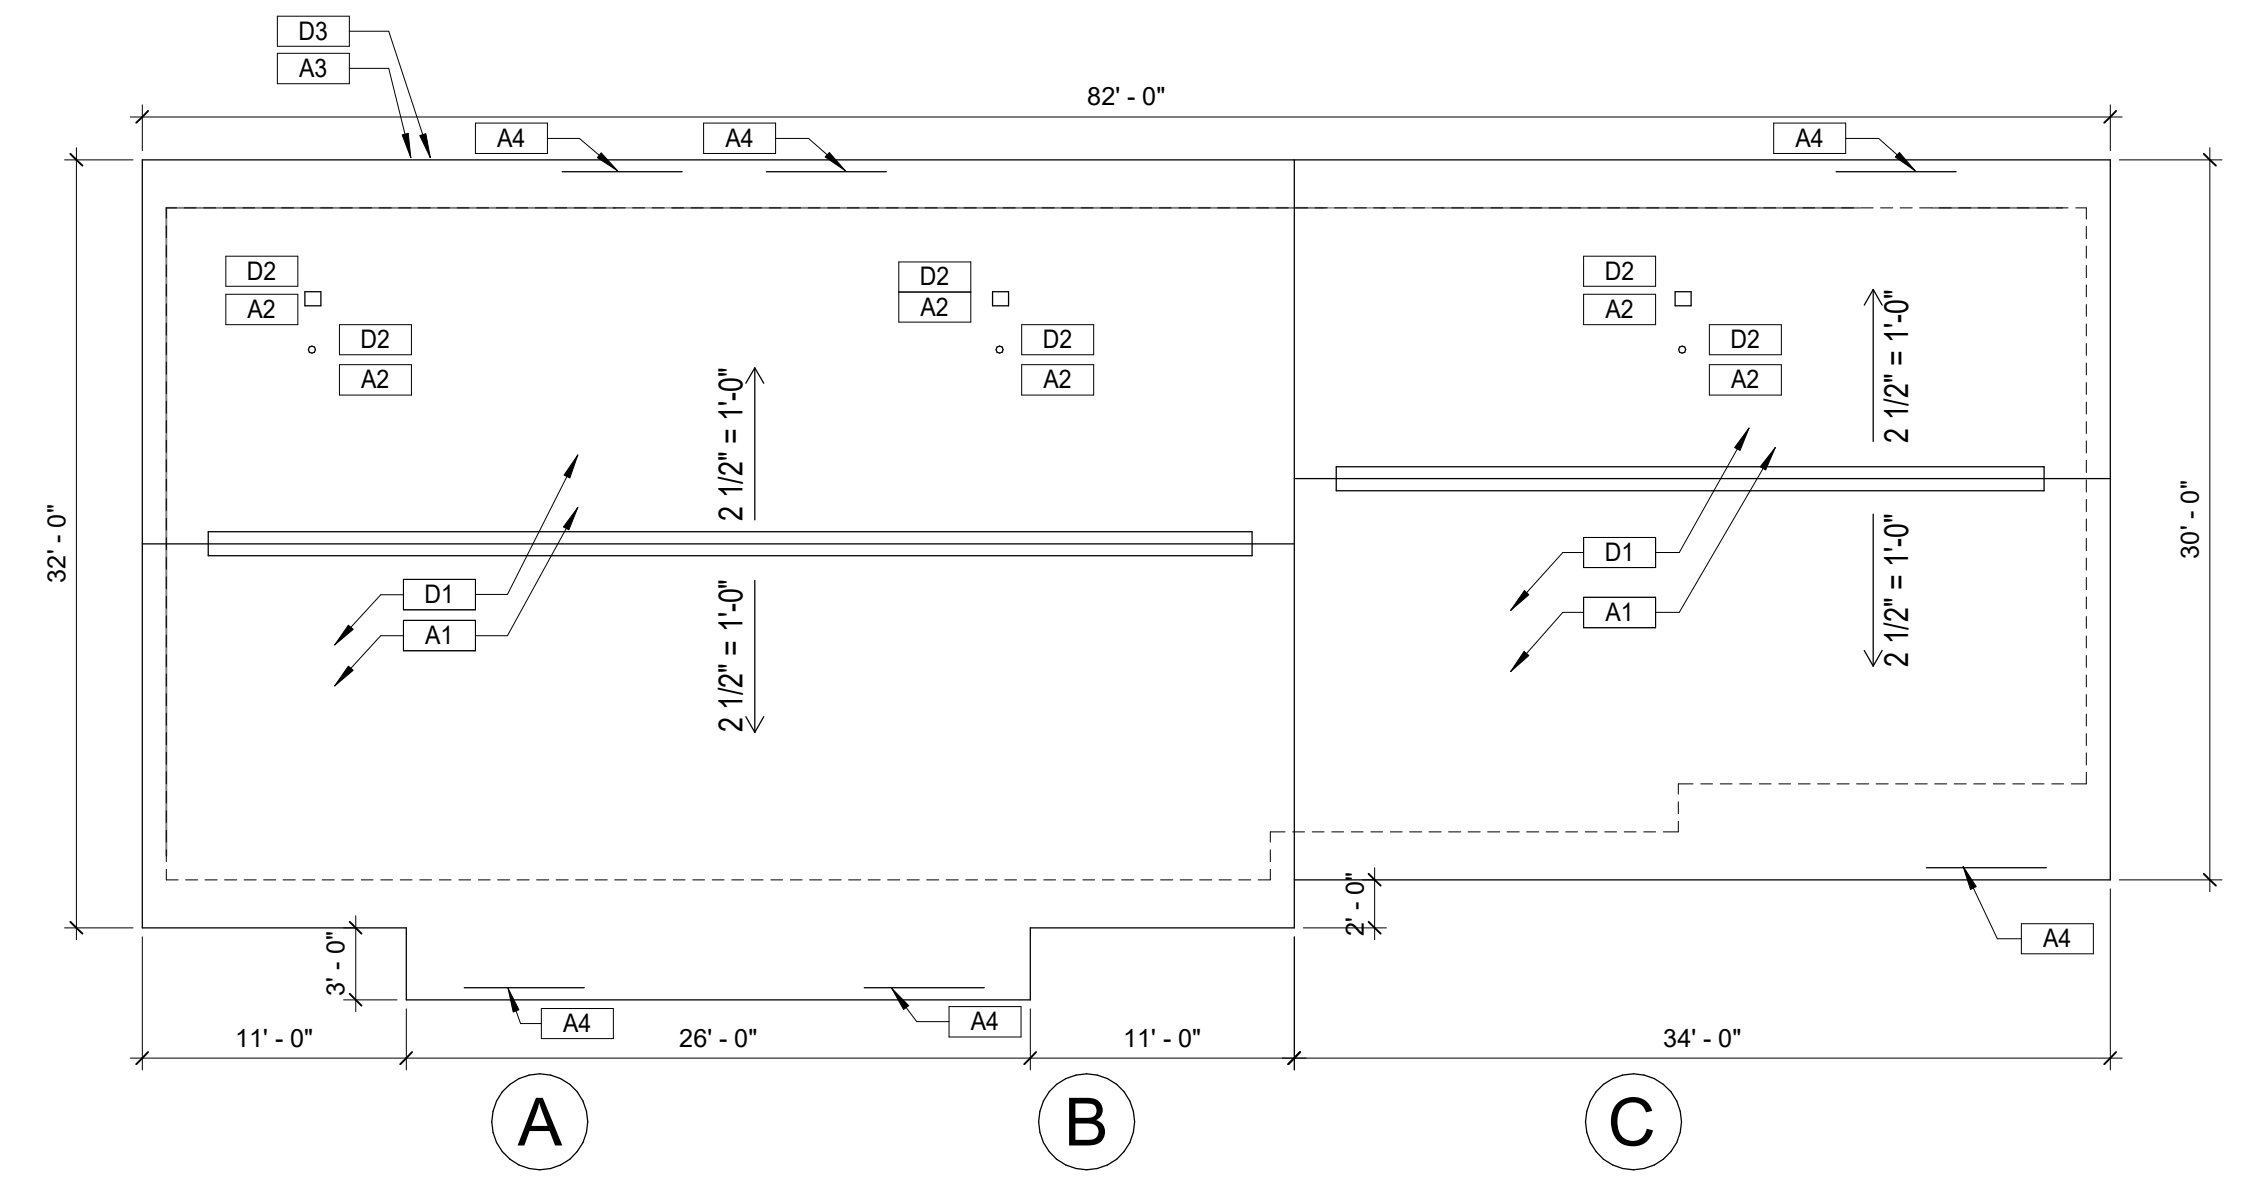
1 FLOOR PLAN
 BUILDING F
 1/8" = 1'-0"
 ESTIMATED ROOF AREA MEASURED ALONG SLOPE = 2,321 SQ. FT.

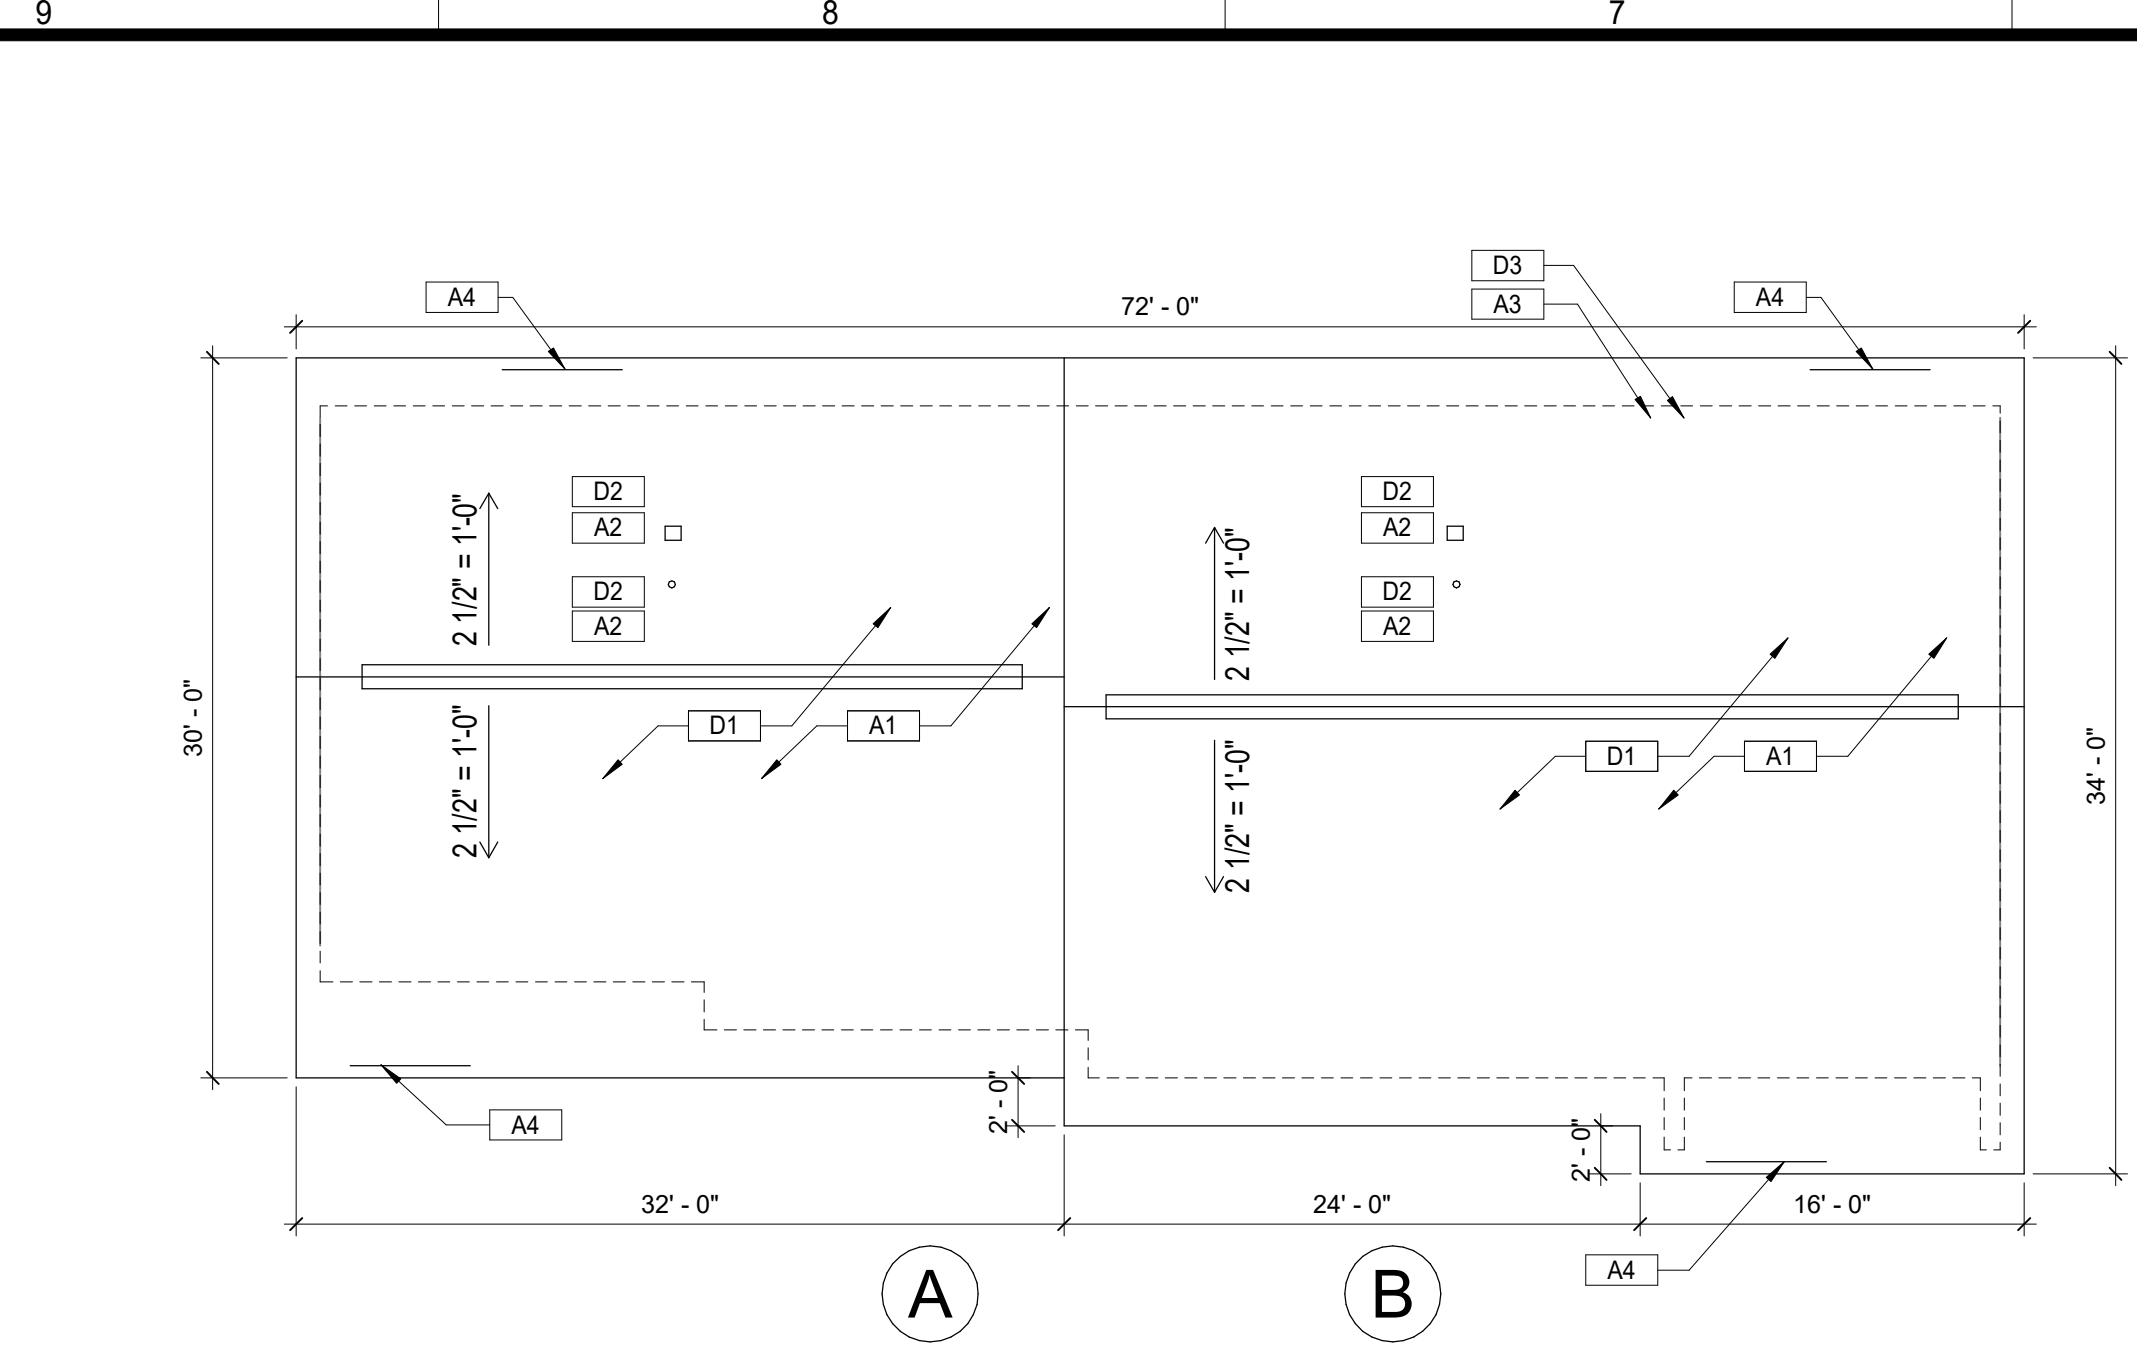


4 FLOOR PLAN
 BUILDING I
 1/8" = 1'-0"
 ESTIMATED ROOF AREA MEASURED ALONG SLOPE = 2,876 SQ. FT.

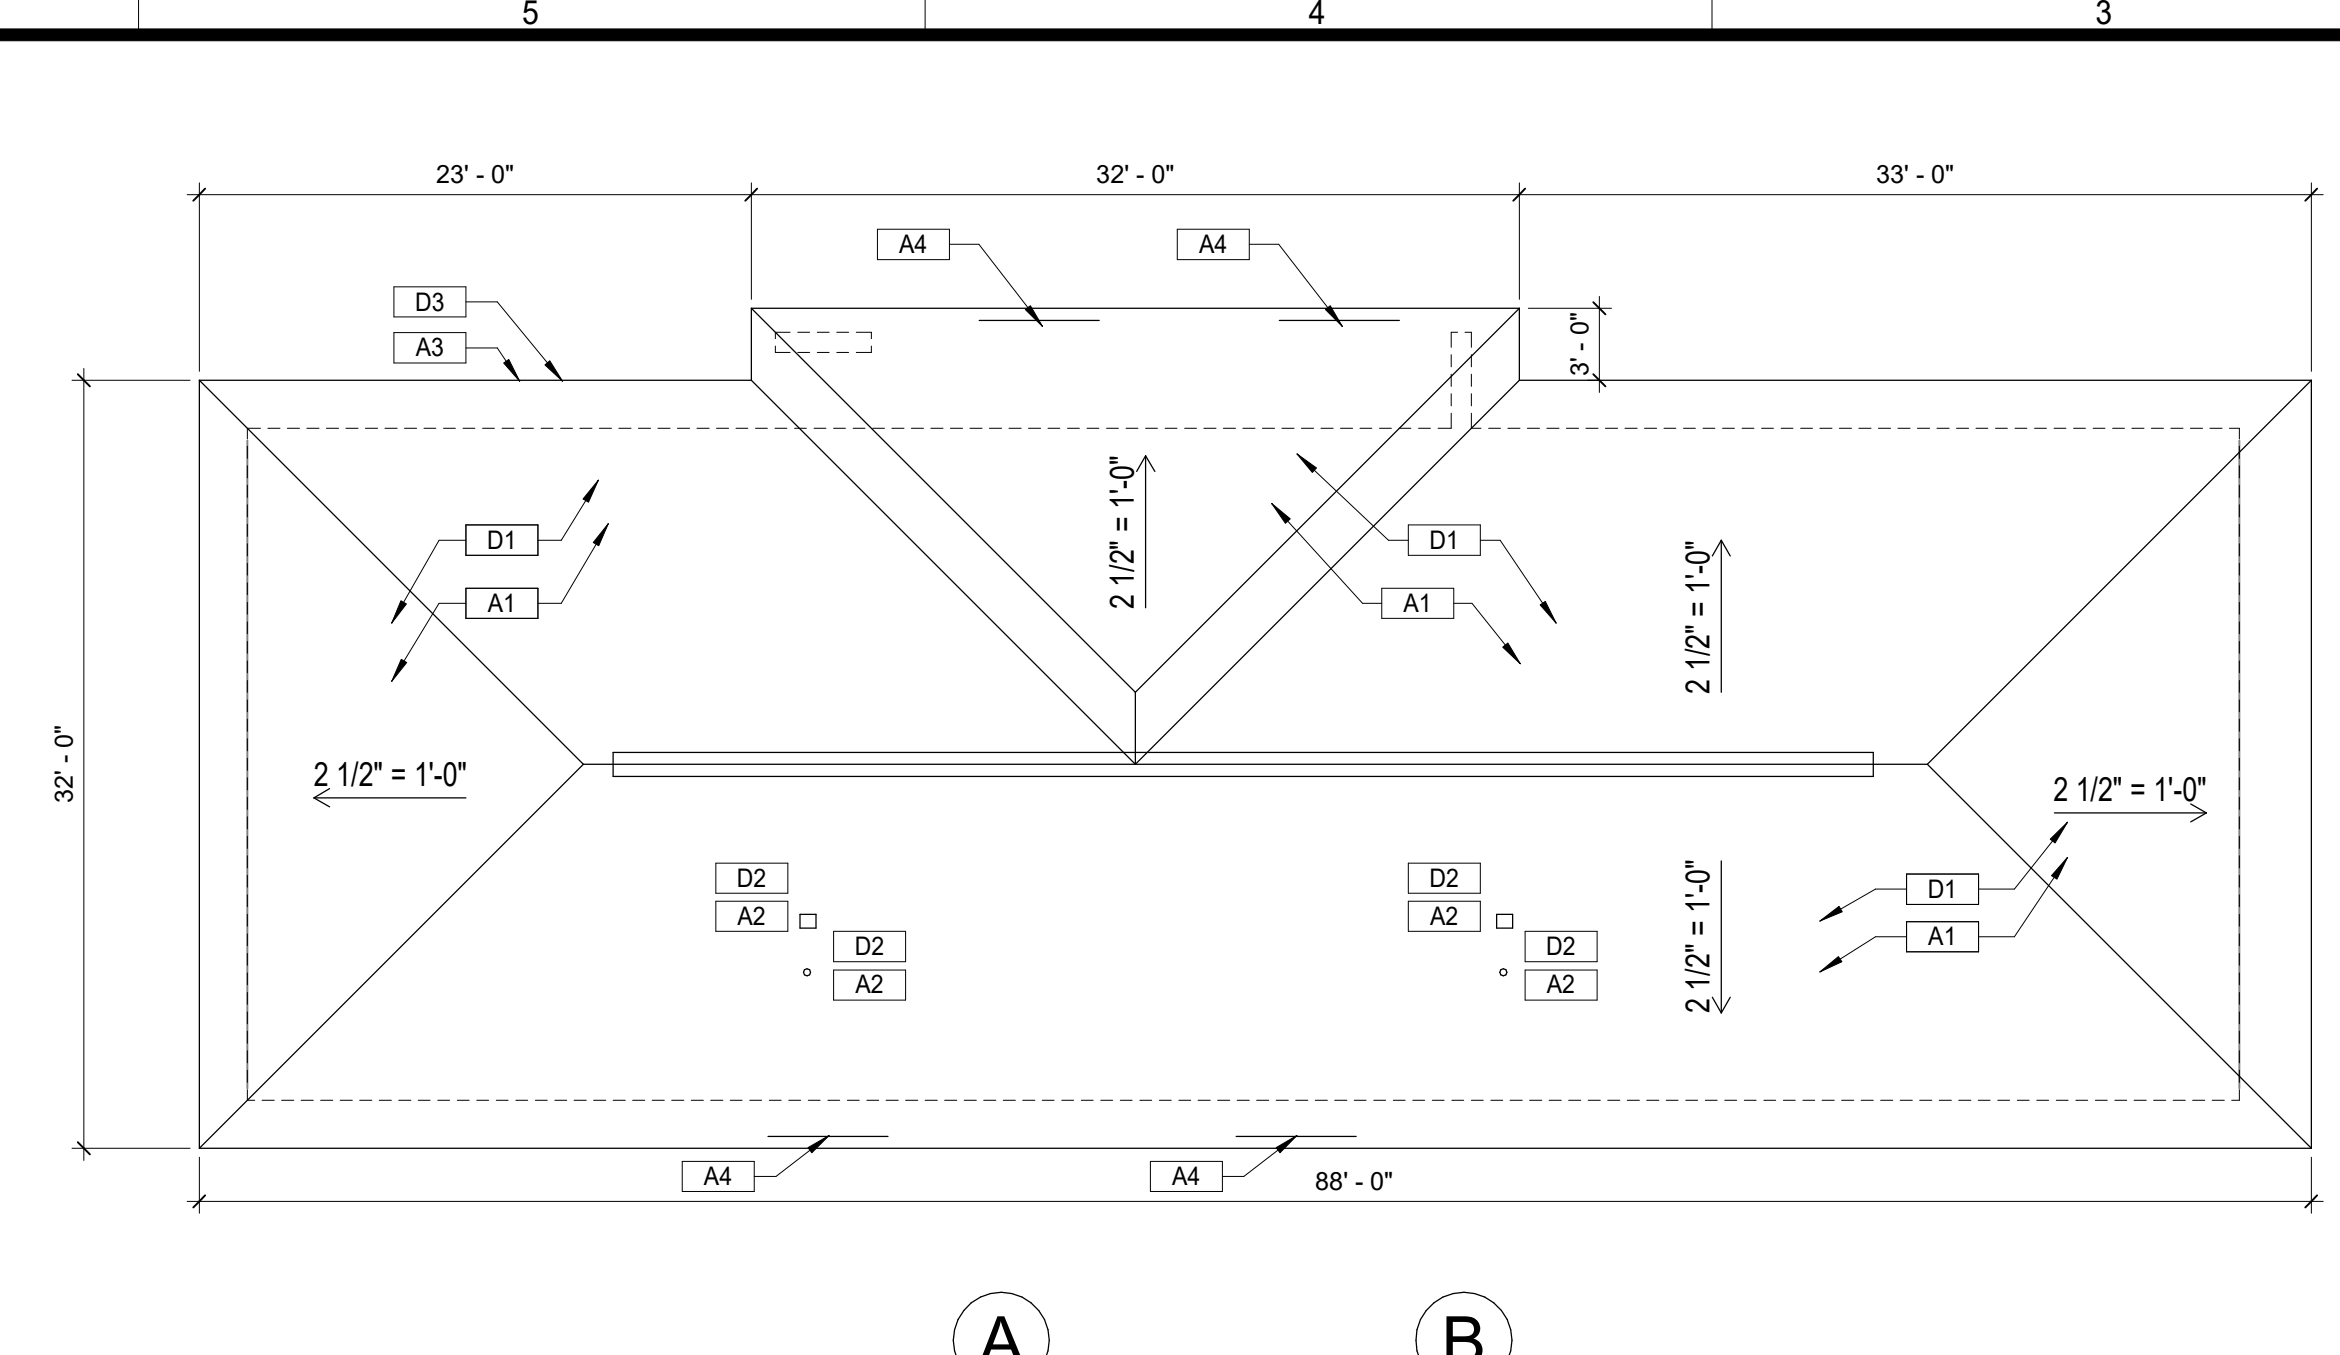


2 FLOOR PLAN
 BUILDING G
 1/8" = 1'-0"
 ESTIMATED ROOF AREA MEASURED ALONG SLOPE = 3,330 SQ. FT.

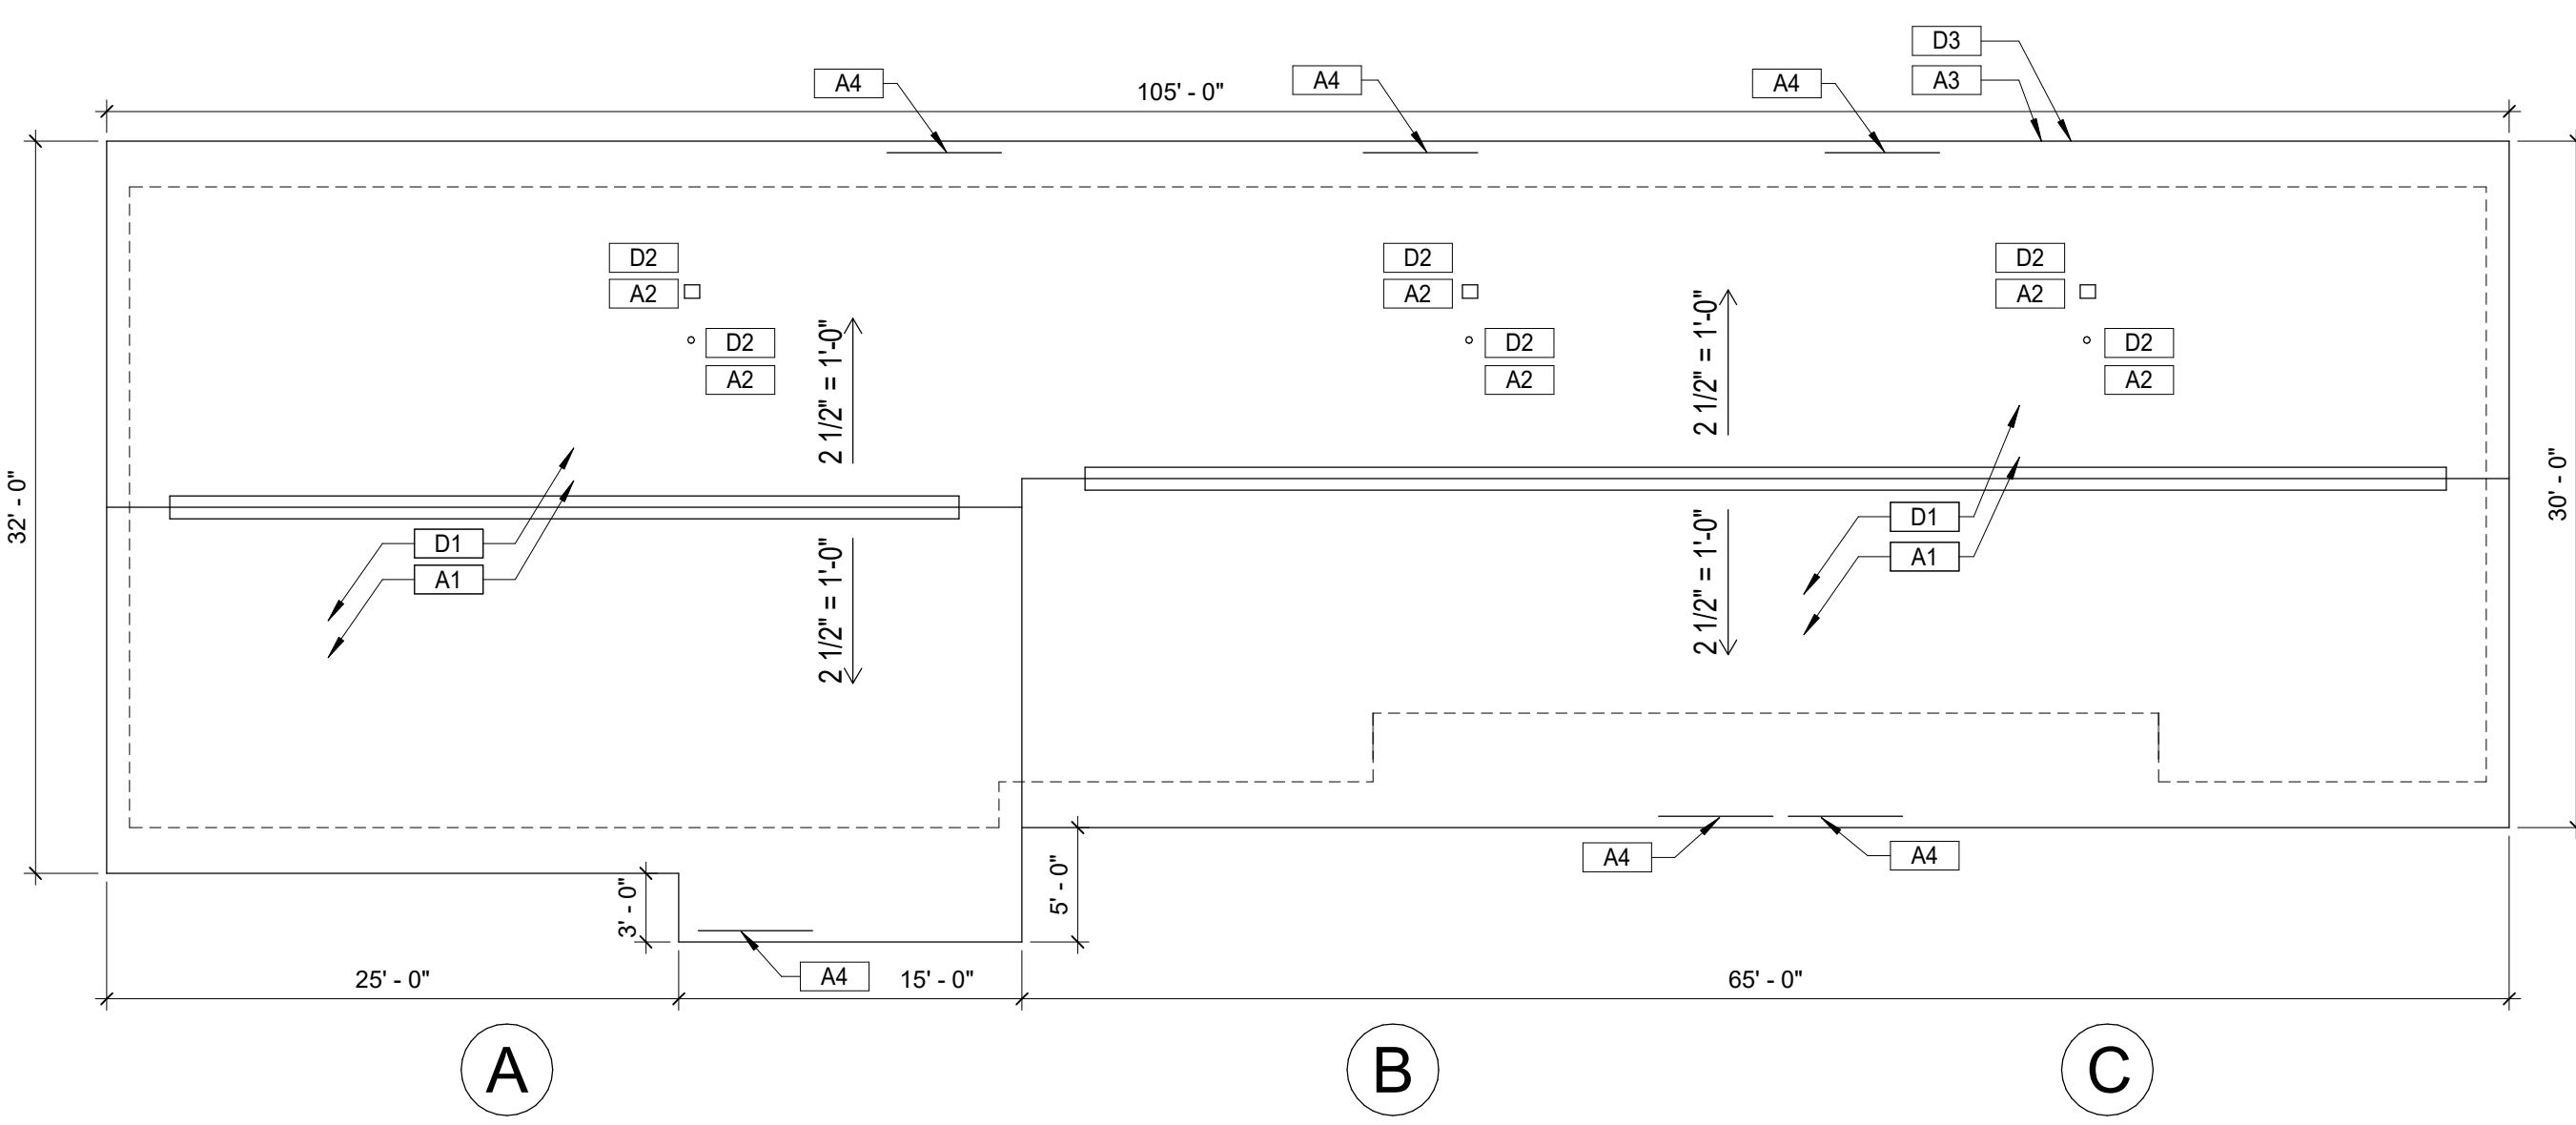

5 FLOOR PLAN
 BUILDING J
 1/8" = 1'-0"
 ESTIMATED ROOF AREA MEASURED ALONG SLOPE = 2,691 SQ. FT.

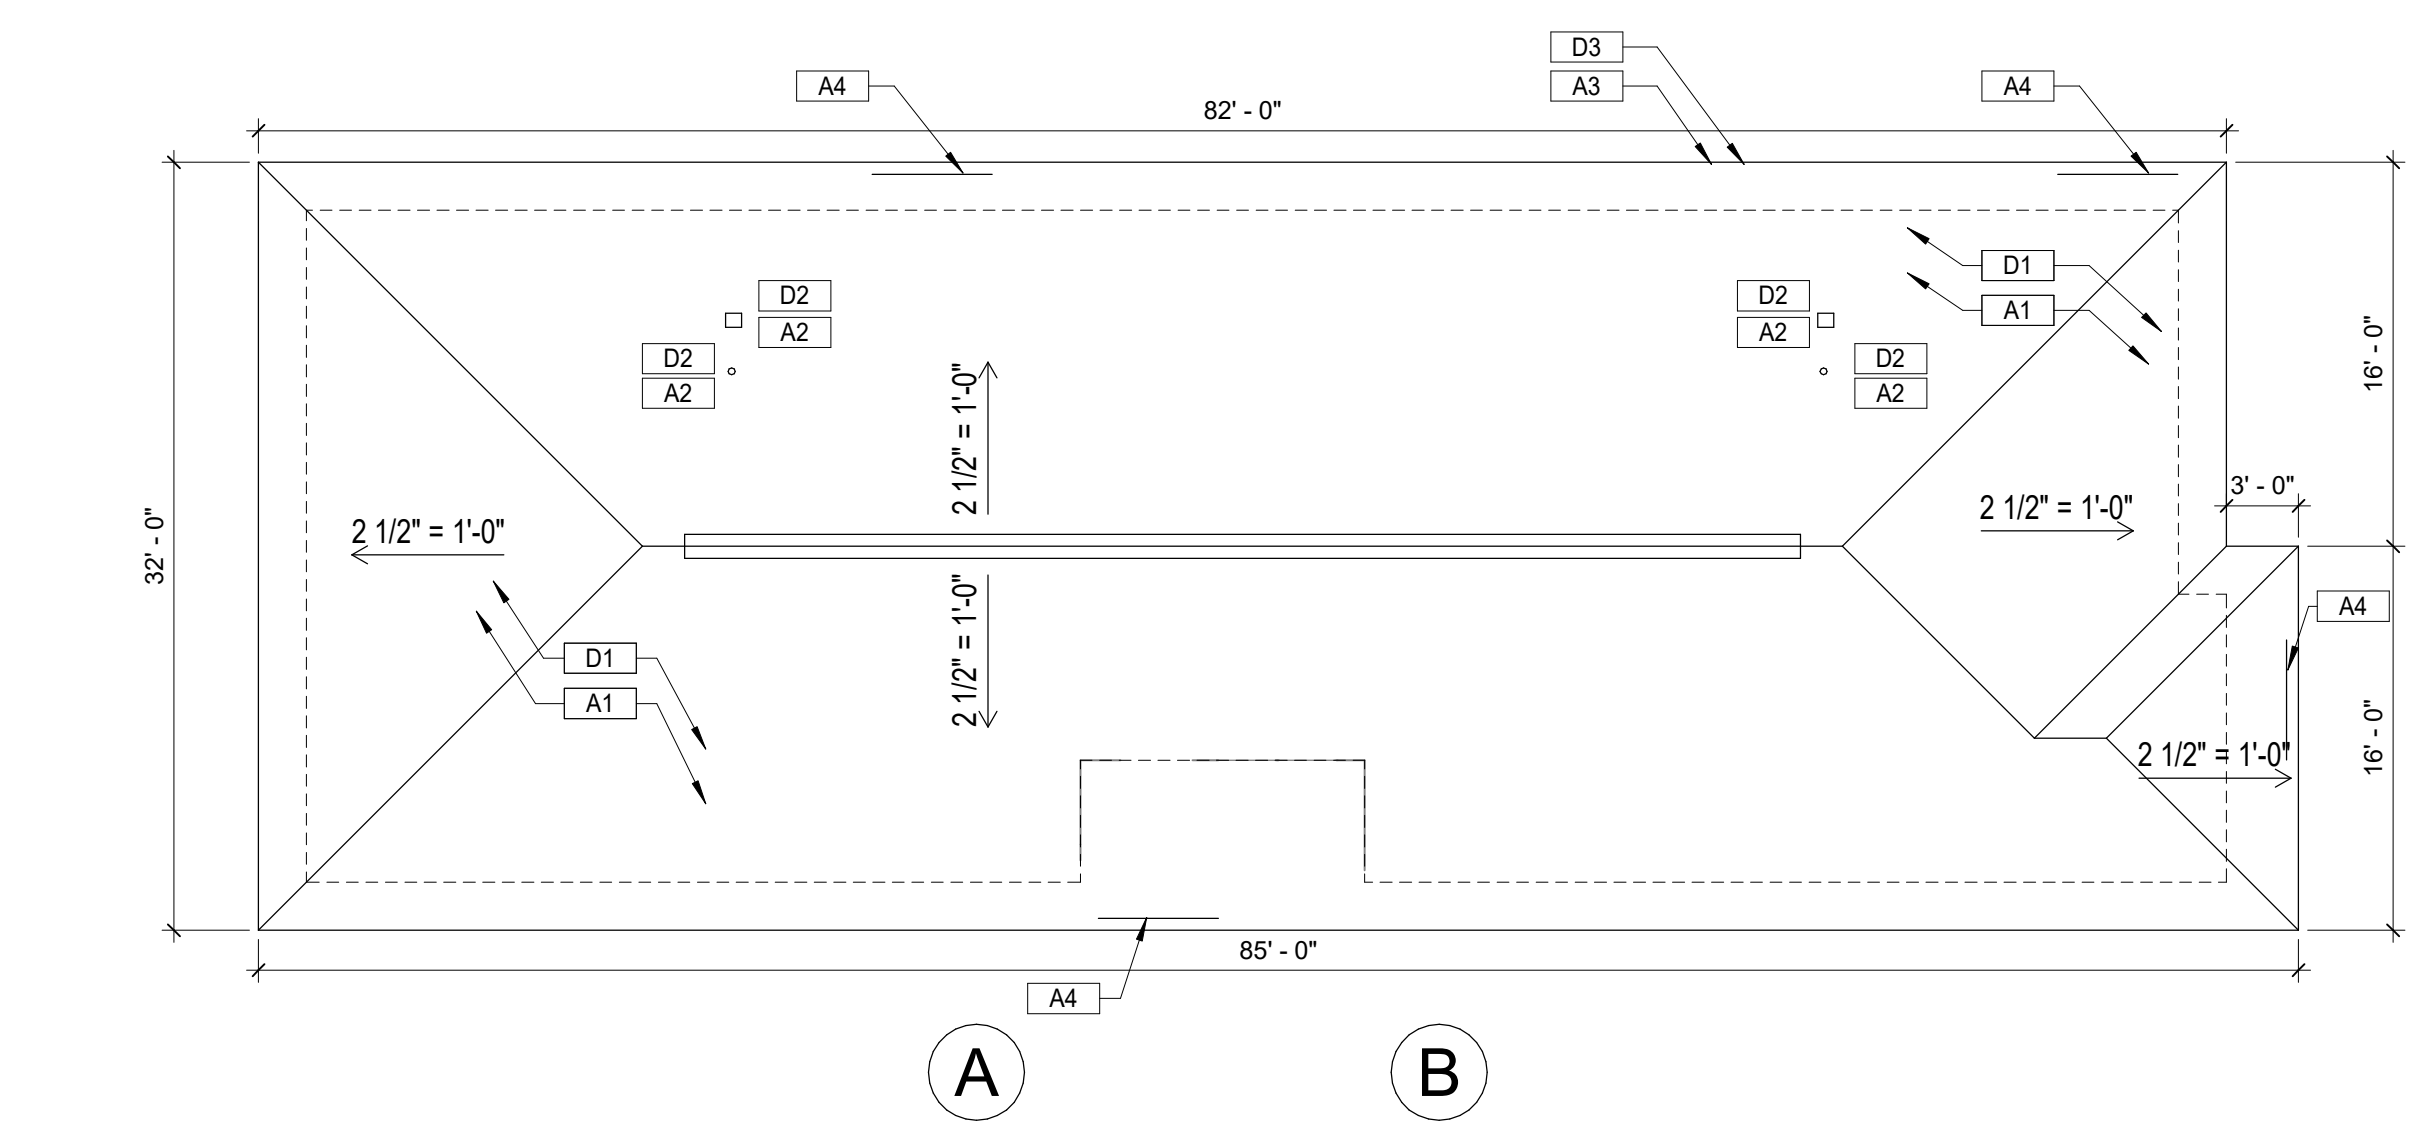

3 FLOOR PLAN
 BUILDING H
 1/8" = 1'-0"
 ESTIMATED ROOF AREA MEASURED ALONG SLOPE = 2,729 SQ. FT.

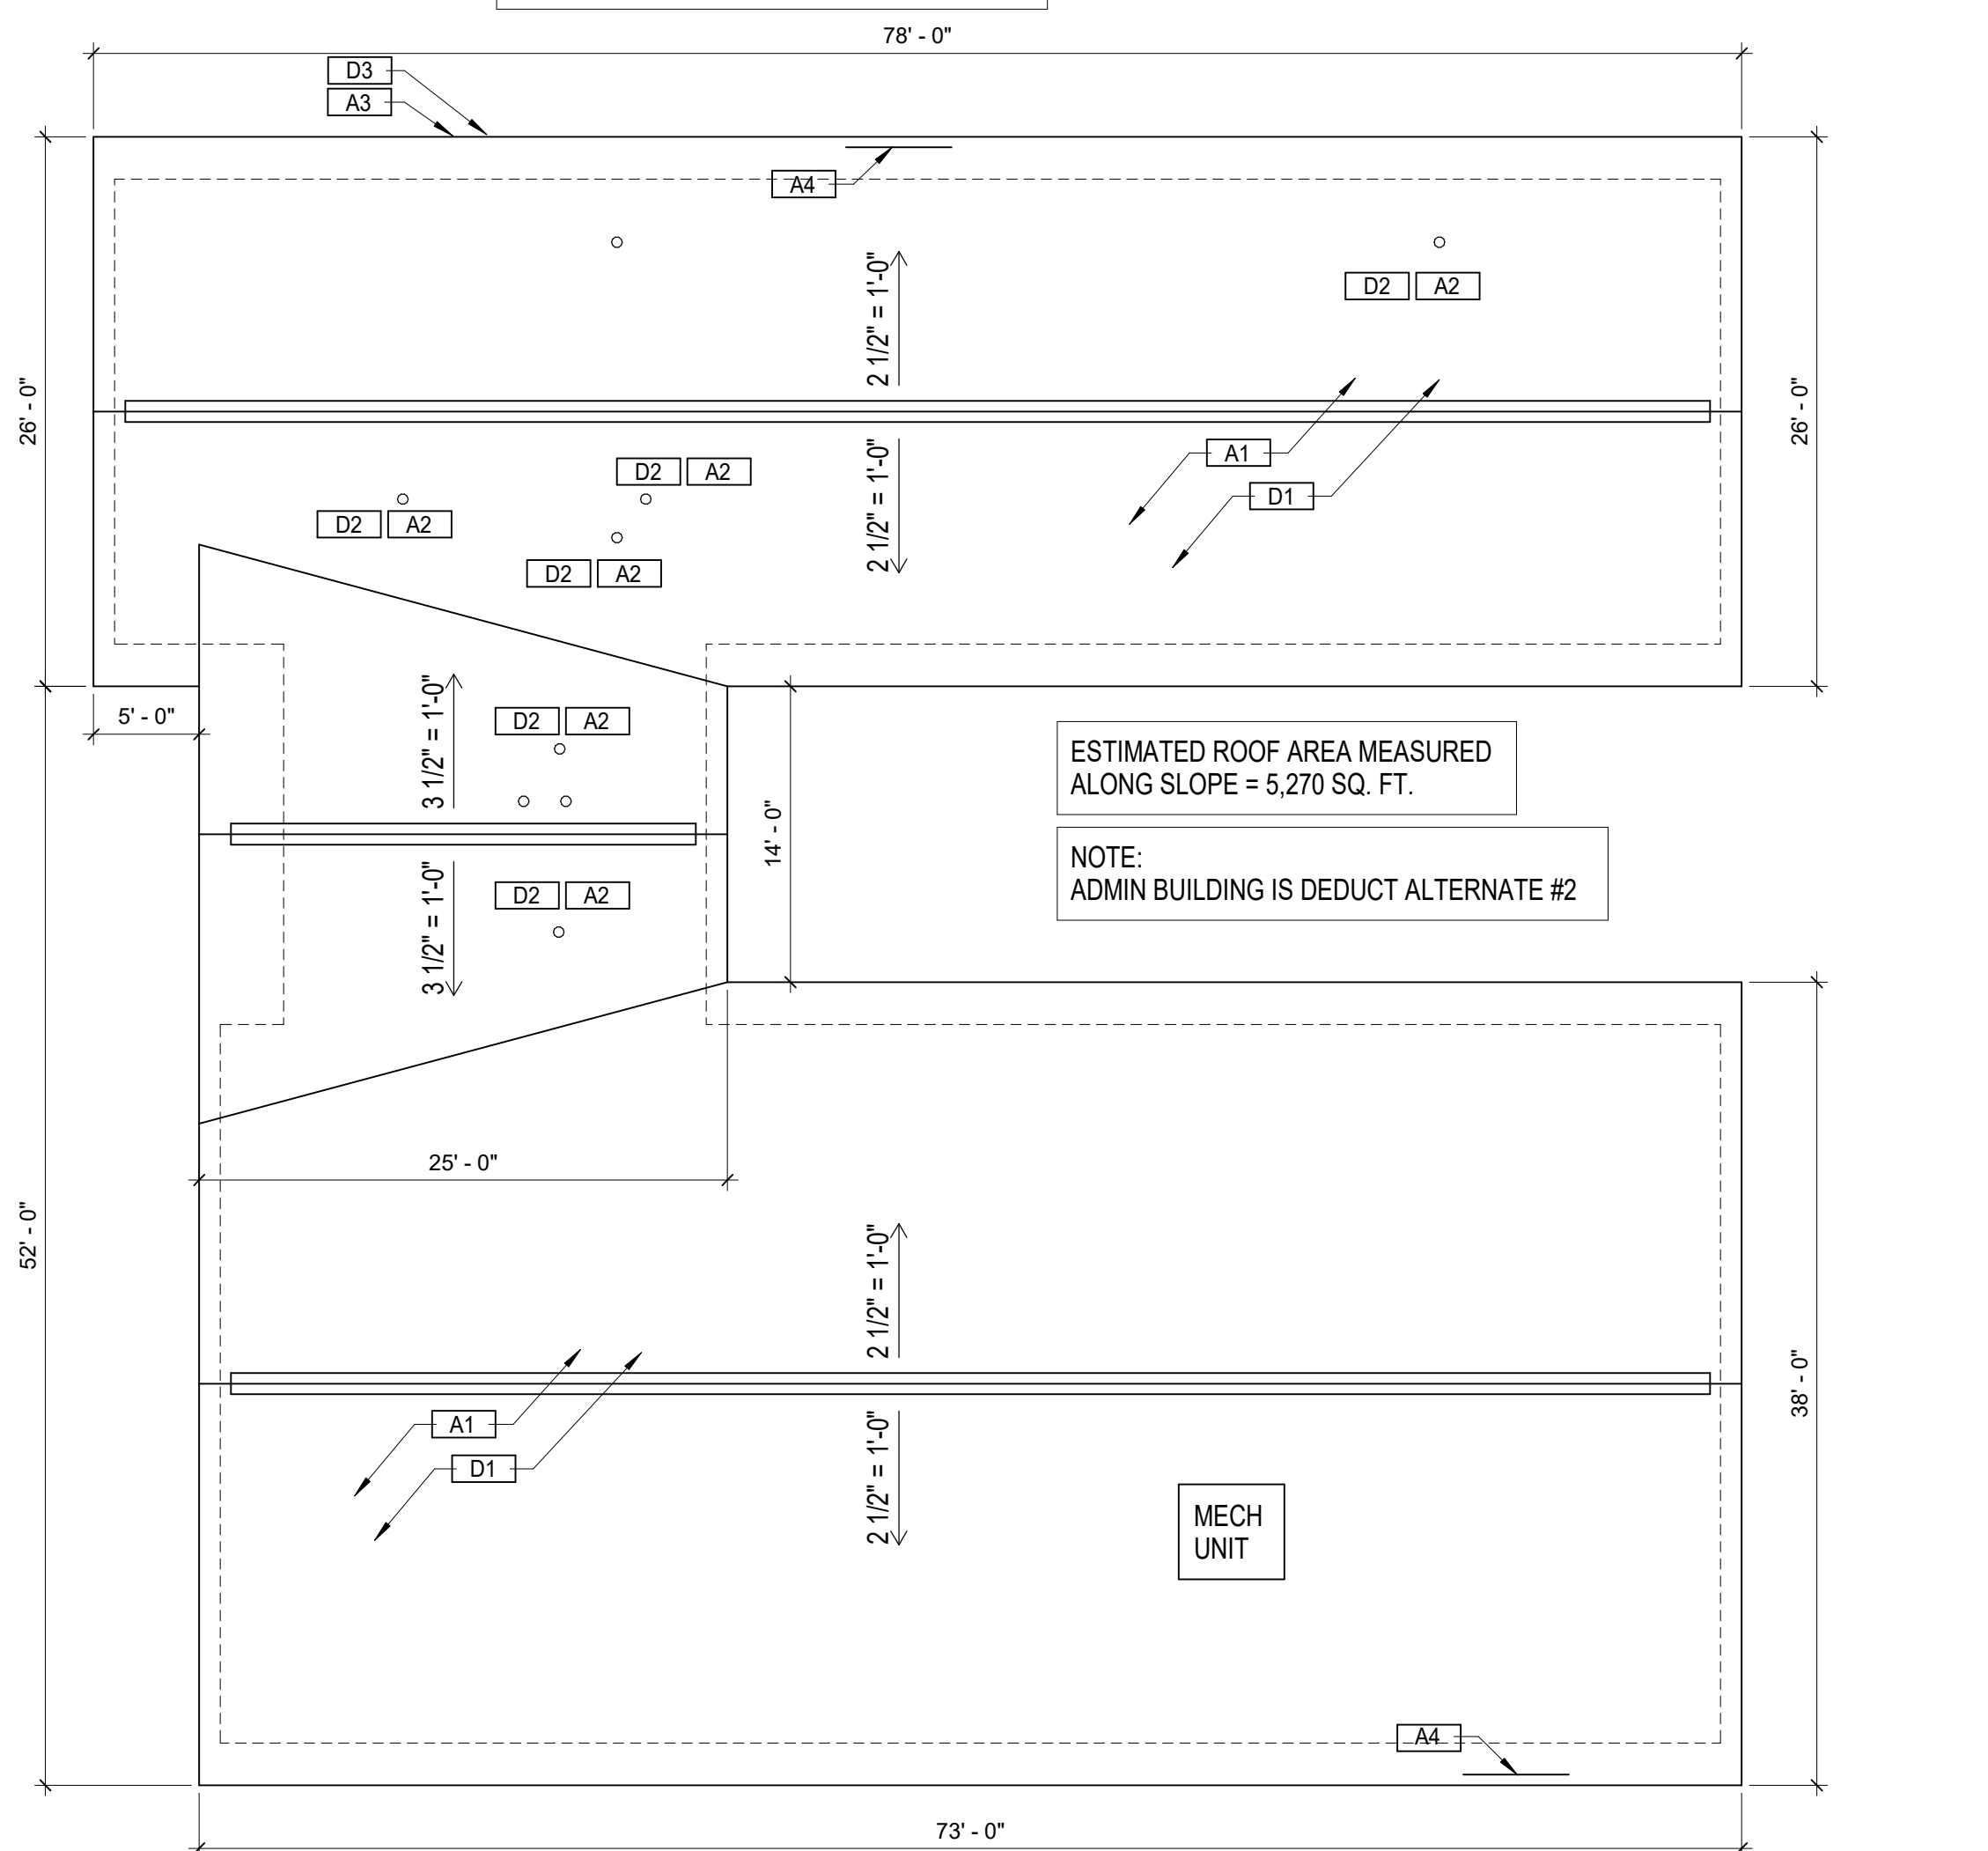

6 FLOOR PLAN
 ADMIN BUILDING
 1/8" = 1'-0"
 ESTIMATED ROOF AREA MEASURED ALONG SLOPE = 5,270 SQ. FT.

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Keynote Legend Demolition

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Keynote Legend New

Key Value	Keynote Text
A1	NEW SHINGLE ROOF OVER UNDERLAYMENT. SEE ROOF PLANS FOR ASSUMED SLOPE.
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A3	NEW DRIP EDGE AT ALL ROOF EDGES.
A4	5 FOOT LINEAR ALUMINUM RAIN DIVERSTER. IN FRONT OF BUILDING ENTRYWAYS TO DEFLECT RAINWATER AWAY FROM PATH OF EGRESS BELOW. ATTACHED PER MANUFACTURER RECOMMENDATIONS. PRECISE LOCATION MAY VARY DEPENDING ON BUILDING ORIENTATION.

THA ARCHITECTURE
 8514 Whitesburg Drive
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 office 256.883.8496
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STATE OF ALABAMA
 JENNIFER THORNTON-HINES
 REG. NO. 7099
 REGISTERED ARCHITECT

REROOFING FOR NORTHWOODS

OWNER: HUNTSVILLE HOUSING AUTHORITY
 PROJECT ADDRESS: 1405 WILKINS STREET
 HUNTSVILLE, AL 35816

ISSUE DATE: 3/26/2024
 ISSUED BID DOCUMENTS
 ADPH NUMBER
 PROJECT NUMBER: 24T-16-00400
 REVISIONS: No. Description Date

DRAWING TITLE: NORTHWOODS FLOOR PLANS
 DRAWING NO. A-101.3

OWNER:

HUNTSVILLE HOUSING AUTHORITY
200 WASHINGTON ST.
HUNTSVILLE, ALABAMA 35801
256.539.0774

ARCHITECT:

EDT-THA ARCHITECTURE
8514 WHITESBURG DRIVE
HUNTSVILLE, ALABAMA 35802
256.883.8496



REROOFING FOR NORTHWOODS

HUNTSVILLE, ALABAMA

INDEX OF DRAWINGS	
Sheet Number	SHEET NAME
00_GENERAL	
G-001	COVER AND INDEX
G-002	STANDARDS
05_ARCHITECTURAL	
A-101.1	NORTHWOODS ARCHITECTURAL SITE PLAN
A-101.2	NORTHWOODS FLOOR PLANS
A-101.3	NORTHWOODS FLOOR PLANS



REROOFING FOR NORTHWOODS

OWNER
HUNTSVILLE HOUSING AUTHORITY
PROJECT ADDRESS
1400 WILSON STREET
HUNTSVILLE, AL 35816

ISSUE DATE
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24T-16-00400


REVISIONS
No. Description Date

DRAWING TITLE
COVER AND
INDEX

DRAWING NO.
G-001

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A	AC	ACRE	H	HB	HOSE BIBB	S	SOUTH
G	ACOUS	ACOUSTICAL	HC	HOLDW CORE	HOLLOW CORE	S	SOLID CORE
	AD	ADJUSTABLE	HDWD	HARDWARE	HARDWOOD	SCHED	SCHEDULE
	ADJ	ADJUSTABLE	HDWR	HARDWARE	HARDWARE	SECT	SECTION
	AGGR	AGGREGATE	HGT	HEIGHT	HEIGHT	SF	SQUARE FOOT
	ALUM	ALUMINUM	HM	HOLLOW METAL	HOLLOW METAL	SHLF	SHELF
	AN	ANOD	HNDRL	HANDRAIL	HANDRAIL	SHT	SHEET
	ANOD	ANODIZED	HORIZ	HORIZONTAL	HORIZONTAL	SHWR	SHOWER
	APPROX	APPROXIMATE	HP	HIGHPOINT	HIGHPOINT	SIM	SIMILAR
	ARCH	ARCHITECTURAL	HR	HOUR	HOUR	SPEC	SPECIFICATION
	ASB	ASBESTOS	HTR	HEATER	HEATER	SQ	SQUARE
	ASPH	ASPHALT	HVAC	HEATING, VENTILATION & AIR CONDITIONING	HEATING, VENTILATION & AIR CONDITIONING	SS	SANITARY SEWER
	ATTEN	ATTENUATION	HW	HOT WATER	HOT WATER	SST	STAINLESS STEEL
						STA	STATION
B	BC	BACK OF CURB	I	INSIDE DIAMETER (DIA)	INSIDE DIAMETER (DIA)	STD	STANDARD
	BD	BOARD	ID	INSIDE FACE	INSIDE FACE (DIA)	STL	STEEL
	BITUM	BITUMINOUS	IF	INSIDE FACE	INSIDE FACE (DIA)	STOR	STORAGE
	BLDG	BUILDING	IN	INCH	INCH	STR	STAIR
	BLK	BLOCK	INCL	INCLUDE	INCLUDE	STRUCT	STRUCTURAL
	BLKG	BLOCKING	INSUL	INSULATION	INSULATION	SUSP	SUSPENDED
	BLKT	BLANKET	INT	INTERIOR	INTERIOR	SY	SQUARE YARD
	BM	BEAM				SYM	SYMMETRICAL
	BOT	BOTTOM	J	JANITOR	JANITOR	T	TONGUE AND GROOVE
	BRG	BEARING	JAN	JANITOR	JANITOR	T&G	TONGUE AND GROOVE
	BRK	BRICK	JST	JOIST	JOIST	TC	TOP OF CURB
	BSMT	BASEMENT	JT	JOINT	JOINT	TEL	TELEPHONE
	BUR	BUILT UP ROOFING				TEMP	TEMPORARY
C	CAB	CABINET	K	KITCHEN	KITCHEN	TER	TERRAZZO
	CB	CATCH BASIN	KO	KNOCKOUT	KNOCKOUT	THK	THICK
	CEM	CEMENT	L	LABORATORY	LABORATORY	TP	TOP OF PAVEMENT
	CER	CERAMIC	LAB	LABORATORY	LABORATORY	TRD	TREAD
	CFM	CUBIC FEET PER MINUTE	LAM	LAMINATE	LAMINATE	TSTAT	THERMOSTAT
	CH	CEILING HEIGHT	LAV	LAVATORY	LAVATORY	TV	TELEVISION
	CI	CAST IRON	LG	LONG	LONG	TW	TOP OF WALL
	CJ	CONTROL JOINT	LH	LEFT HAND	LEFT HAND	TYP	TYPICAL
	CLG	CEILING	LKR	LOCKER	LOCKER		
	CLKG	CAULKING	LOC	LOCATION	LOCATION	U	UNDERWRITERS
	CLO	CLOSET	LP	LOW POINT	LOW POINT	UL	LABORATORIES
	CLR	CLEAR	LT	LIGHT	LIGHT	UNF	UNFINISHED
	CMU	CONCRETE MASONRY UNIT	LTL	LINTEL	LINTEL	UON	UNLESS OTHERWISE NOTED
	CMW	CASEWORK / MILLWORK				V	VINYL COMPOSITION TILE
	CNTR	COUNTER	M	MACHINE	MACHINE	VCT	VINYL COMPOSITION TILE
	CNTR	CENTER	MACH	MACHINE	MACHINE	VERT	VERTICAL
	CO	CLEANOUT	MAINT	MAINTENANCE	MAINTENANCE	VEST	VESTIBULE
	COL	COLUMN	MATL	MATERIAL	MATERIAL	VTR	VENT THRU ROOF
	CONC	CONCRETE	MAX	MAXIMUM	MAXIMUM	WVC	VINYL WALL COVERING
	CONN	CONNECTION	MECH	MECHANICAL	MECHANICAL	W	WEST
	CONSTR	CONSTRUCTION	MEMB	MEMBRANE	MEMBRANE	W/	WITH
	CONT	CONTINUOUS	MFR	MANUFACTURER	MANUFACTURER	WID	WITHOUT
	CORR	CORRIDOR	MH	MANHOLE	MANHOLE	WC	WATER CLOSET
	CPT	CARPET	MIN	MINIMUM	MINIMUM	WD	WOOD
	CSMNT	CASEMENT	MIR	MIRROR	MIRROR	WDW	WINDOW
	CTS	COUNTERSUNK	MISC	MISCELLANEOUS	MISCELLANEOUS	WP	WATERPROOF
	CW	CURTAINWALL	NO	MASONRY OPENING	MASONRY OPENING	WR	WATER RESISTANT
D	DBL	DOUBLE	MTD	MOUNTED	MOUNTED	WSCT	WAINSCOT
	DEPT	DEPARTMENT	MTL	METAL	METAL	WT	WEIGHT
	DESC	DESCRIPTION	MUL	MULLION	MULLION		
	DET	DETAIL	N	NORTH	NORTH		
	DF	DRINKING FOUNTAIN	N/A	NOT APPLICABLE	NOT APPLICABLE		
	DIA	DIAMETER	NIC	NOT IN CONTRACT	NOT IN CONTRACT		
	DIM	DIMENSION	NO	NUMBER	NUMBER		
	DISP	DISPENSER	NOM	NOMINAL	NOMINAL		
	DN	DOWN	NTS	NOT TO SCALE	NOT TO SCALE		
	DR	DOOR	O	OVERALL	OVERALL		
	DS	DOWNSPOUT	OA	OBSOLETE	OBSOLETE		
	DSP	DRY STANDPIPE	OBS	OBSOLETE	OBSOLETE		
	DWG	DRAWING	OC	ON CENTER	ON CENTER		
	DWR	DRAWER	OD	OUTSIDE DIAMETER (DIA)	OUTSIDE DIAMETER (DIA)		
E	E	EAST	OFF	OFFICE	OFFICE		
	EA	EACH	OPNG	OPENING	OPENING		
	EJ	EXPANSION JOINT	OPP	OPPOSITE	OPPOSITE		
	EL	ELEVATION	OZ	OUNCE	OUNCE		
	ELEC	ELECTRICAL	P	PUBLIC ADDRESS	PUBLIC ADDRESS		
	ELEV	ELEVATOR	PA	PUBLIC ADDRESS	PUBLIC ADDRESS		
	EMER	EMERGENCY	PC	PRECAST	PRECAST		
	ENCL	ENCLOSURE	PCF	POUNDS PER CUBIC FOOT	POUNDS PER CUBIC FOOT		
	EP	ELECTRICAL PANELBOARD	PERF	PERFORATED	PERFORATED		
	EQ	EQUAL	PL	PLATE	PLATE		
	EQT	EQUIPMENT	PLAM	PLASTIC LAMINATE	PLASTIC LAMINATE		
	EW	ELECTRIC WATER COOLER	PLAS	PLASTER	PLASTER		
	EXIST	EXISTING	PLMBG	PLUMBING	PLUMBING		
	EXP	EXPANSION	PLYWD	PLYWOOD	PLYWOOD		
	EXPO	EXPOSED	PNL	PANEL	PANEL		
	EXT	EXTERIOR	POL	POLISHED	POLISHED		
F	FA	FIRE ALARM	PR	PAIR	PAIR		
	FB	FLAT BAR	PREFAB	PREFABRICATED	PREFABRICATED		
	FCO	FLOOR CLEAN OUT	PROP	PROPERTY	PROPERTY		
	FD	FLOOR DRAIN	PSF	POUNDS PER SQUARE FOOT	POUNDS PER SQUARE FOOT		
	FDN	FOUNDATION	PSI	POUNDS PER SQUARE INCH	POUNDS PER SQUARE INCH		
	FE	FIRE EXTINGUISHER	PT	POINT	POINT		
	FEC	FIRE EXTINGUISHER CABINET	PTD	PAINTED	PAINTED		
	FHC	FIRE HOSE CABINET	PTN	PARTITION	PARTITION		
	FIN	FINISH	PVC	POLYVINYL CHLORIDE	POLYVINYL CHLORIDE		
	FL	FLOOR	Q	QUARRY TILE	QUARRY TILE		
	FLASH	FLASHING	QTR	QUARTER	QUARTER		
	FLUOR	FLUORESCENT	R	RISER	RISER		
	FOC	FACE OF CONCRETE	RAD	RADIUS	RADIUS		
	FOF	FACE OF FINISH	RD	ROOF DRAIN	ROOF DRAIN		
	FOM	FACE OF MASONRY	REF	REFERENCE	REFERENCE		
	FOS	FACE OF STUDS	REF	REFERENCE	REFERENCE		
	FPRF	FIREPROOF	REF	REFERENCE	REFERENCE		
	FRMG	FRAMING	REIN	REINFORCED	REINFORCED		
	FS	FULL SIZE	REIN	REINFORCED	REINFORCED		
	FT	FOOT OR FEET	REQD	REQUIRED	REQUIRED		
	FTG	FOOTING	RESIL	RESILIENT	RESILIENT		
	FURR	FURRING	RGSTR	REGISTER	REGISTER		
	FUT	FUTURE	RL	RAIN LEADER	RAIN LEADER		
			RM	ROOM	ROOM		
			RND	ROUND	ROUND		
			RO	ROUGH OPENING	ROUGH OPENING		
			RQMT	REQUIREMENT	REQUIREMENT		
G	GA	GAUGE					
	GALV	GALVANIZED					
	GB	GRAB BAR					
	GFI	GROUND FAULT INTERRUPTION					
	GL	GLASS					
	GND	GROUND					
	GR	GRADE					
	GRTG	GRATING					
	GYP	GYPSONUM					

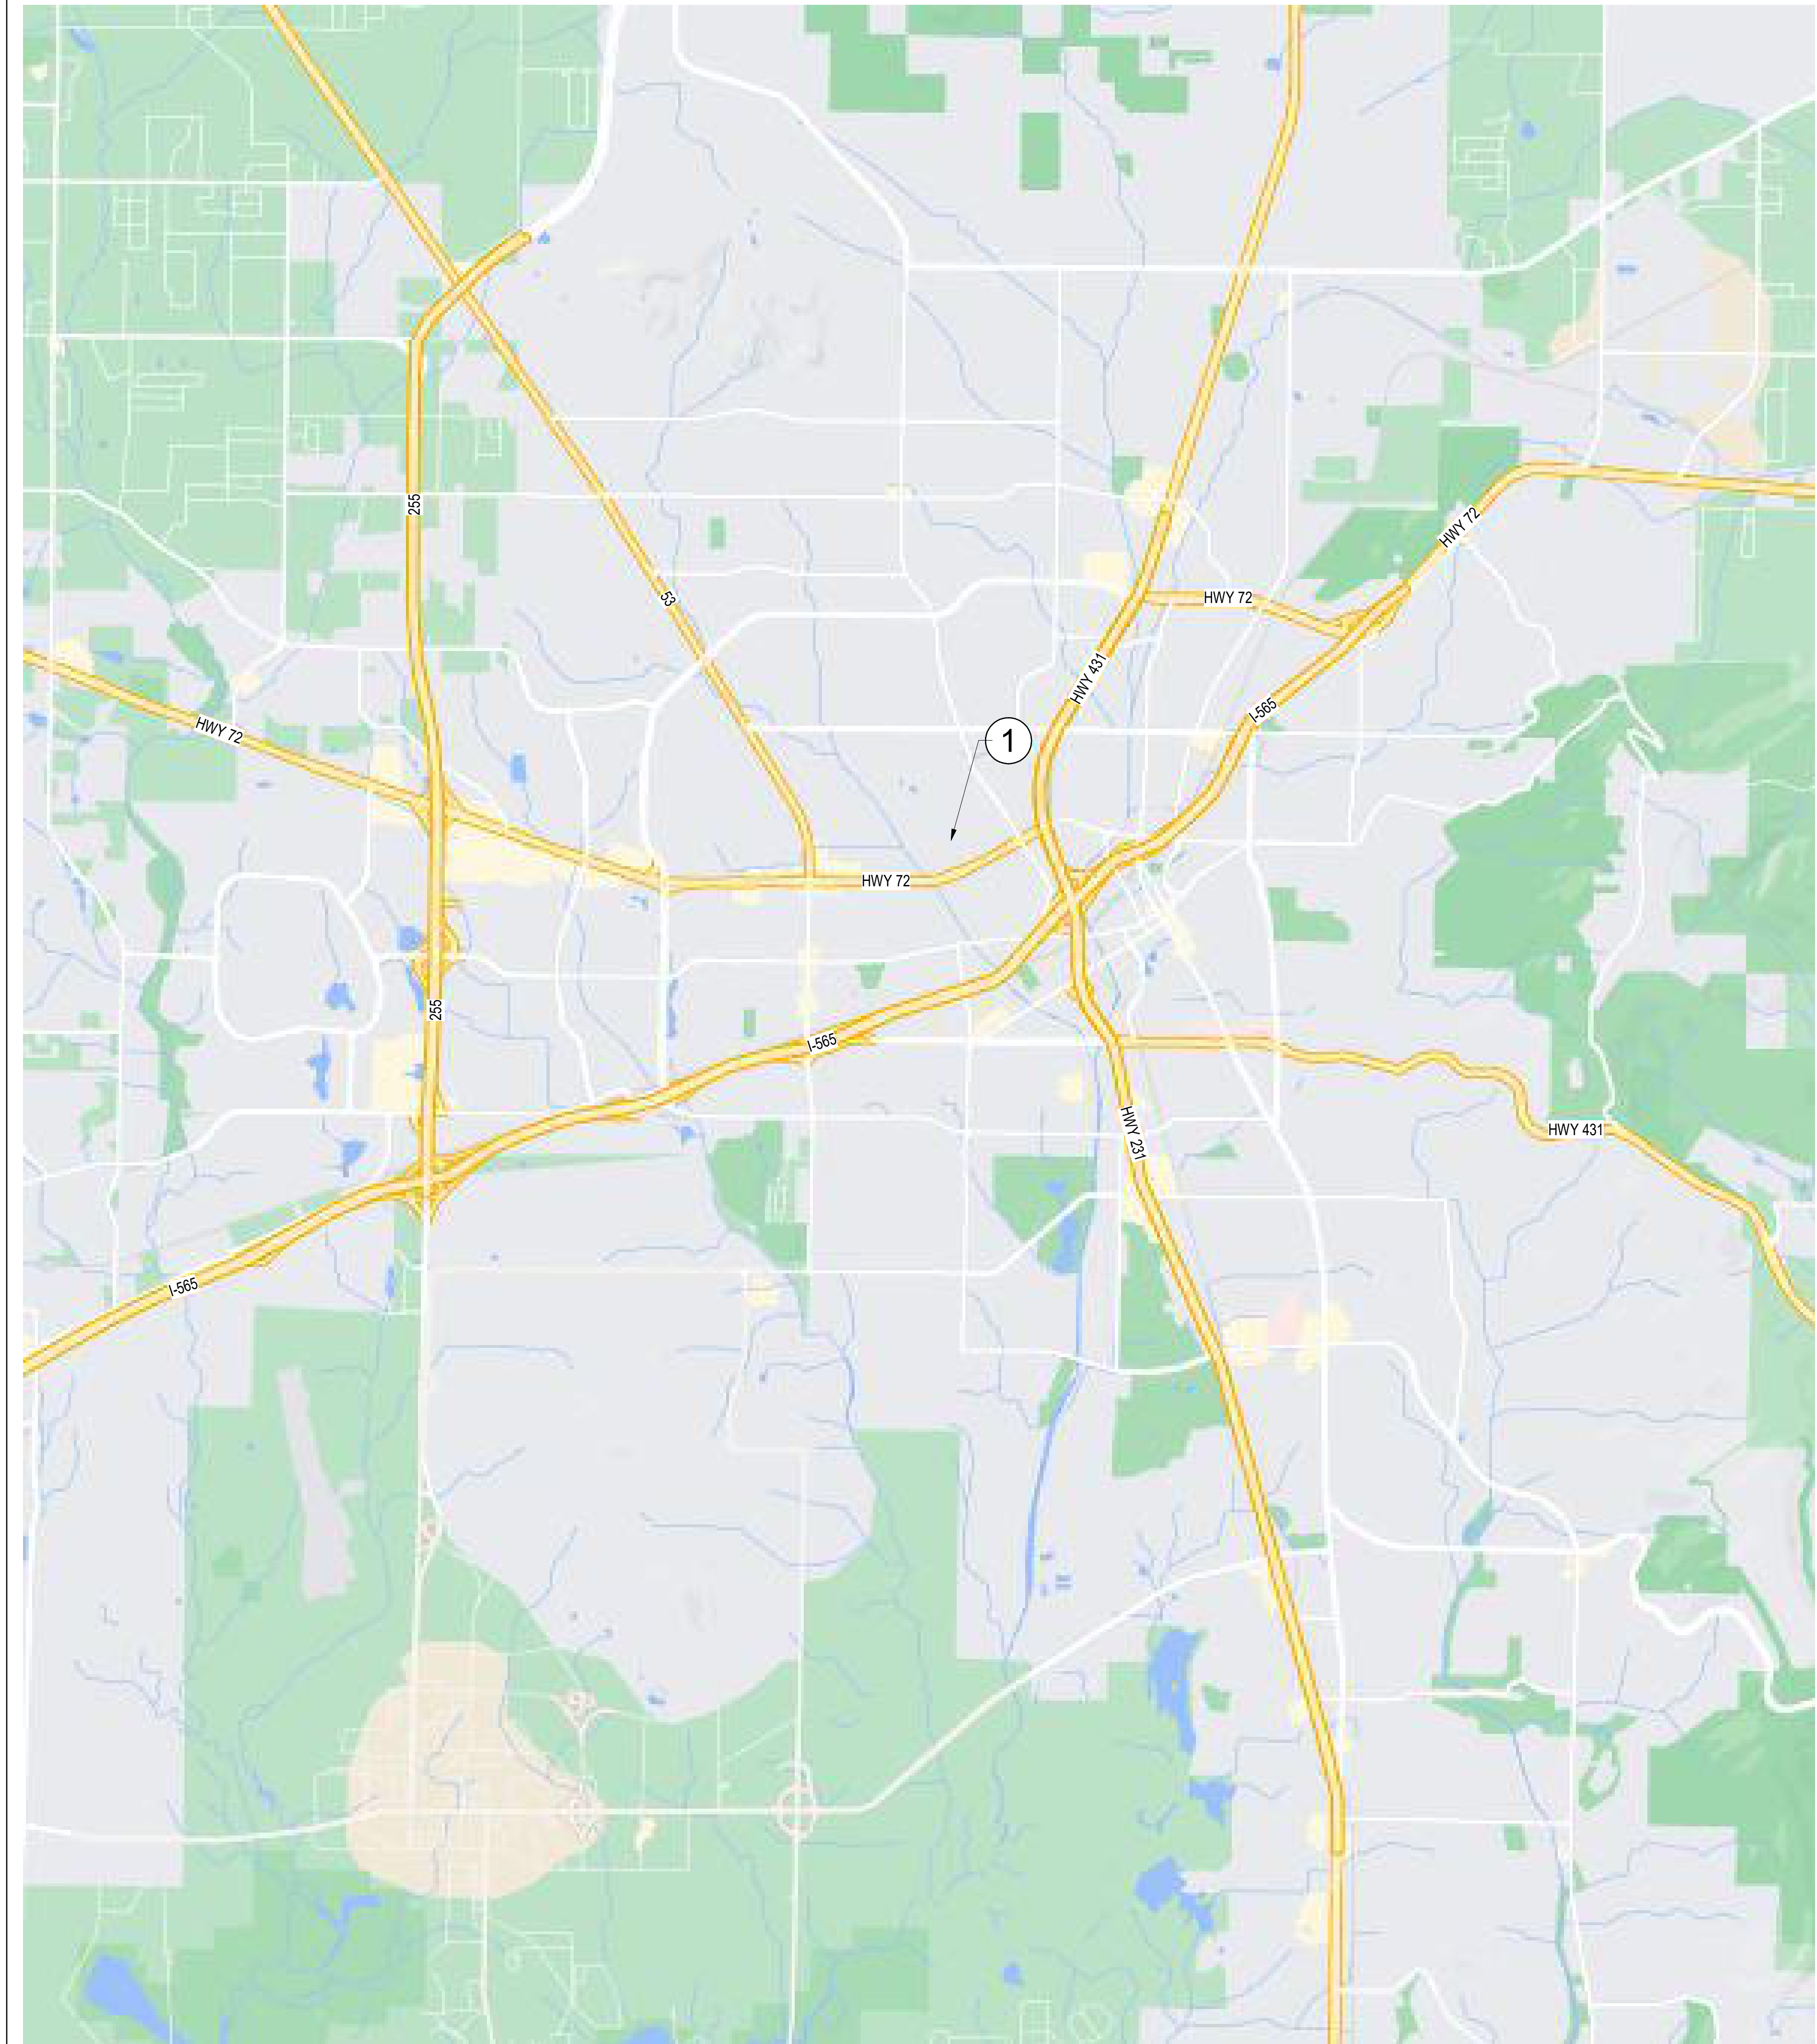

1 OVERALL VICINITY MAP
1" = 100'

DRAFTING CONVENTION NOTES

- 1 LARGE SCALE DRAWINGS TAKE PRECEDENCE OVER SMALL SCALE DRAWINGS, DETAILS TAKE PRECEDENCE OVER ALL. NOTIFY ARCHITECT IN WRITING OF CONFLICTS OR DISCREPANCIES
- 2 ALL DIMENSIONS ARE SHOWN FROM FACE OF STUD TO FACE OF STUD, UNLESS OTHERWISE NOTED.
- 3 DIMENSIONS NOTED "CLR" OR "CLR" MUST BE PRECISELY MAINTAINED ALLOWING FOR THICKNESS OF MATERIALS.
- 4 DIMENSIONS ARE NOT ADJUSTABLE WITHOUT ARCHITECT'S APPROVAL, UNLESS NOTED OTHERWISE.
- 5 DIMENSIONS TO EXTERIOR WINDOW WALL ARE TO INSIDE FINISHED FACE OF THE WALL, UNLESS OTHERWISE NOTED.
- 6 DIMENSIONS TO EXTERIOR GLAZING ARE TO THE INSIDE FACE OF THE EXTERIOR GLAZING.
- 7 VERTICAL DIMENSIONS ARE FROM THE TOP OF THE FINISHED FLOOR, UNLESS OTHERWISE NOTED.
- 8 DO NOT SCALE DRAWINGS. IF ANY ITEM OF WORK CANNOT BE LOCATED, DO NOT PROCEED WITH THE WORK BEFORE CLARIFYING WITH ARCHITECT.
- 9 VERIFY DIMENSIONS MARKED "VIF" PRIOR TO START OF CONSTRUCTION AND REPORT INCONSISTENCIES TO ARCHITECT.
- 10 "TYPICAL" MEANS IDENTICAL FOR ALL CONDITIONS, UNLESS OTHERWISE NOTED.
- 11 "SIMILAR" MEANS COMPARABLE CHARACTERISTICS FOR THE CONDITIONS NOTED. VERIFY DIMENSIONS AND ORIENTATION ON PLANS AND ELEVATIONS.
- 12 "PROVIDE" MEANS FURNISH AND INSTALL, COMPLETE AND IN PLACE.
- 13 "FURNISH" MEANS FURNISH ONLY, INSTALLATION BY GENERAL CONTRACTOR UNLESS OTHERWISE NOTED.
- 14 "INSTALL" MEANS PUT INTO PLACE, SUPPLIED BY GENERAL CONTRACTOR UNLESS OTHERWISE NOTED.
- 15 "ALIGN" MEANS ACCURATELY LOCATE FINISH FACES IN THE SAME PLANE.

PROPERTY LEGEND

1. NORTHWOODS
1402 YUKON STREET
HUNTSVILLE, ALABAMA 35816

ROOM NAME/NUMBER	ROOM NAME 101
DOOR NUMBER	101
WINDOW TYPE	1
INTERIOR/EXTERIOR STOREFRONT	SF-22
WALL TYPE	101
CEILING TYPE	30-0"
EQUIPMENT/ACCESSORIES	PT-1
REVISION NUMBER	1
FIRE EXTINGUISHER CABINET	FEC
FIRE EXTINGUISHER W/ BRACKET (WALL MOUNTED)	FE
MATCHLINE	---
BUILDING / WALL / DETAIL SYMBOL	1 A104
INTERIOR ELEVATION	A1 A104
NEW MASONRY WALL	///
NEW METAL STUD WALL	==
WALL DEMOLISHED IN PHASE	XXXXXX
EXISTING WALL TO REMAIN	==
ELEVATION MARKER	3 A-401

REROOFING FOR NORTHWOODS

8514 Whitesburg Drive
Huntsville, AL 35802
office 256.883.8496

www.edttha.com



OWNER
HUNTSVILLE HOUSING AUTHORITY

PROJECT ADDRESS
1402 YUKON STREET
HUNTSVILLE, AL 35816

ISSUE DATE
3/26/2024

ISSUED
BID DOCUMENTS

ADPH NUMBER

PROJECT NUMBER
24T-16-00400

REVISIONS

No.	Description	Date

DRAWING TITLE
STANDARDS

DRAWING NO.
G-002