

UNDERGROUND SERVICE ALERT



Know what's below.
Call before you dig.

CONSTRUCTION CONTRACTOR AGREES THAT IN ACCORDANCE WITH GENERALLY ACCEPTED CONSTRUCTION PRACTICES, CONSTRUCTION CONTRACTOR WILL BE REQUIRED TO ASSUME SOLE AND COMPLETE RESPONSIBILITY FOR JOB SITE CONDITIONS DURING THE COURSE OF CONSTRUCTION OF THE PROJECT INCLUDING SAFETY OF ALL PERSONS AND PROPERTY; THAT THIS REQUIREMENT SHALL BE MADE TO APPLY CONTINUOUSLY AND NOT BE LIMITED TO NORMAL WORKING HOURS, AND CONSTRUCTION CONTRACTOR FURTHER AGREES TO DEFEND, INDEMNIFY AND HOLD DESIGN PROFESSIONAL HARMLESS FROM ANY AND ALL LIABILITY, REAL OR ALLEGED, IN CONNECTION WITH THE PERFORMANCE OF WORK ON THIS PROJECT, EXCEPTING LIABILITY ARISING FROM THE SOLE NEGLIGENCE OF DESIGN PROFESSIONAL.

SPECIAL NOTE:

WHERE UNDERGROUND AND SURFACE STRUCTURES ARE SHOWN ON THE PLANS, THE LOCATIONS, DEPTH AND DIMENSIONS OF STRUCTURES ARE BELIEVED TO BE REASONABLY CORRECT, BUT ARE NOT GUARANTEED. SUCH STRUCTURES ARE SHOWN FOR THE INFORMATION OF THE CONTRACTOR, BUT INFORMATION SO GIVEN IS NOT TO BE CONSTRUED AS A REPRESENTATION THAT SUCH STRUCTURES WILL, IN ALL CASES, BE FOUND WHERE SHOWN, OR THAT THEY REPRESENT ALL OF THE STRUCTURES WHICH MAY BE ENCOUNTERED.

CONTRACTOR SHALL NOTIFY "USA" (UNDERGROUND SERVICE ALERT) AT 811, TWO WORKING DAYS BEFORE COMMENCING EXCAVATION AND ALL UTILITY AUTHORITIES OR UTILITY COMPANIES HAVING POSSIBLE INTEREST IN THE WORK, OF CONTRACTOR'S INTENTION TO EXCAVATE PROXIMATE TO EXISTING FACILITIES, AND CONTRACTOR SHALL VERIFY THE LOCATION OF ANY UTILITIES WITHIN THE WORK AREA.

GRADING NOTES:

- CONTRACTOR SHALL OBTAIN A GRADING PERMIT AND PAY THE PLAN CHECK FEE FROM THE CITY OF FRESNO BUILDING DIVISION PRIOR TO ANY GRADING.
- ALL CONSTRUCTION SHALL BE PERFORMED IN CONFORMANCE WITH THE CITY OF FRESNO STANDARD SPECIFICATIONS AND THE APPLICABLE PORTIONS OF THE CALIFORNIA BUILDING CODE 2016 (CBC 2016).
- ANY PERSON, CONTRACTOR OR SUBCONTRACTOR PLANNING TO CONDUCT ANY EXCAVATION SHALL CONTACT USA NORTH AT 811 AT LEAST TWO (2) DAYS, BUT NO MORE THAN 14 CALENDAR DAYS, PRIOR TO COMMENCING THAT EXCAVATION.
- PERMITS FOR ALL REQUIRED WALLS SHALL BE OBTAINED PRIOR TO APPROVAL OF AS-GRADED PLANS. PERMITS FOR RETAINING WALLS SHALL BE OBTAINED WITHIN 30 DAYS OF GRADING PERMIT ISSUANCE.
- THE CONTRACTOR SHALL MAKE ADEQUATE PROVISION FOR DUST CONTROL FOR THE DURATION OF THE WORK. DUST CONTROL MEASURES SHALL BE FULLY AND ADEQUATELY CARRIED OUT ON WEEKDAYS, WEEKENDS AND HOLIDAYS, AND WHEN NECESSARY, BEFORE OR AFTER NORMAL WORKING HOURS.
- ALL SIDEWALKS SHALL MAINTAIN A MAXIMUM SLOPE OF 5% IN THE DIRECTION OF TRAVEL AND A MAXIMUM CROSS SLOPE OF 2% TO ADHERE TO ADA REQUIREMENTS.
- THE GROUND IMMEDIATELY ADJACENT TO ALL FOUNDATIONS SHALL BE SLOPED AWAY FROM THE BUILDING AT A MINIMUM OF NOT LESS THAN 2% FOR A MINIMUM DISTANCE OF 10 FEET MEASURED PERPENDICULAR TO THE FACE OF THE WALL. IF PHYSICAL OBSTRUCTIONS OR LOT LINES PROHIBIT 10 FEET OF HORIZONTAL DISTANCE FROM THE FOUNDATION, THEN A SWALE THAT RUNS PARALLEL TO THE FOUNDATION MAY BE USED AND WILL BE REQUIRED TO BE A MINIMUM SLOPE 2% WITHIN 10 FEET OF THE BUILDING FOUNDATION. ALL OTHER SITE GRADING OUTSIDE OF THE BUILDING ENVELOPE IS REQUIRED TO BE A MINIMUM OF 0.5% IN ADDITION, THE CITY OF FRESNO PERMITS CONCRETE CHANNELS WITH 0.2% MIN. SLOPE WITHIN 10' OF THE BUILDING ENVELOPE AS AN ALTERNATIVE TO THE 2% MIN. SLOPE REQUIREMENT WHEN LOT LINES OR PHYSICAL OBSTRUCTIONS EXIST.
- THE SITE SHALL HAVE AN OVERALL MINIMUM SLOPE OF 0.5% TO AN APPROVED DRAINAGE FACILITY.
- NO PERMANENT ON-SITE WATER RETENTION IS ALLOWED.
- NO SURFACE DRAINAGE SHALL BE PERMITTED ONTO ADJACENT PROPERTIES.
- ANY SURVEY MONUMENTS WITHIN THE AREA OF WORK SHALL BE PRESERVED OR RESET BY A REGISTERED CIVIL ENGINEER OR A LICENSED LAND SURVEYOR.
- GRADING NEXT TO ADJACENT PROPERTIES, WHERE DIFFERENCES EXCEED ONE (1) FOOT IN ELEVATION, SHALL CONFORM TO CITY STANDARD OR A RECORDED SLOPE EASEMENT FROM ADJOINING PROPERTY OWNERS AFFECTED SHALL BE PROVIDED. DIFFERENCES IN ELEVATION LESS THAN ONE (1) FOOT SHALL REQUIRE, AT A MINIMUM, A RETAINING BOARD (1"x12") MADE OF REDWOOD OR APPROVED EQUAL, TO BE USED TO RETAIN ALL SOIL ON THE PROPERTY BEING DEVELOPED OR ADJACENT TO THE DEVELOPMENT DEPENDING ON WHICH PROPERTY HAS HIGHER GRADES.
- ANY RETAINING WALL AND/OR FENCE CONSTRUCTED WITHIN THE PUBLIC RIGHT-OF-WAY SHALL BE OF A MASONRY DESIGN AND CONSTRUCTION. A BUILDING PERMIT WILL BE REQUIRED FOR ANY RETAINING WALL/FENCE, BLOCK WALL OR WOOD FENCE TO BE CONSTRUCTED.
- THE GRADING CONTRACTOR SHALL REMOVE ALL ORGANIC MATTER, DEBRIS, AND OTHER DELETERIOUS MATERIAL FROM THE SITE.
- ESTIMATED EARTHWORK QUANTITIES:
EXCAVATION 2,000 C.Y.
ENBANKMENT 250 C.Y.
FOR PERMIT PURPOSES ONLY

- ALL FILL TO BE COMPACTED TO A MINIMUM OF 90% RELATIVE COMPACTION, INCLUDING UNDER SIDEWALKS, PAVEMENT AREAS, CURBS AND VALLEY GUTTERS SHALL BE COMPACTED TO A MINIMUM OF 95% RELATIVE COMPACTION, PER ASTM-D1557-91.
- PROVIDE COMPACTION REPORTS PREPARED BY AN APPROVED TESTING AGENCY FOR ALL LOOSE FILLS, PAVEMENT SECTIONS, TRENCH BACKFILL, AND RETAINING WALL BACKFILLS.
- THE OWNER ACKNOWLEDGES THE CITY'S APPROVAL OF THIS GRADING PLAN DOES NOT EXPRESS OR IMPLY THE SITE IS FREE OF CONTAMINANTS OR HAZARDOUS MATERIALS OR THAT THE CITY IS RESPONSIBLE OR LIABLE, IN ANY WAY, FOR THE CLEANUP OF THIS SITE.
- THE CITY SHALL BE PROVIDED WITH AN "AS-GRADED" PLAN, CERTIFIED BY A REGISTERED ENGINEER PRIOR TO ISSUANCE OF AN OCCUPANCY PERMIT. A "HOLD ON OCCUPANCY" WILL BE IN EFFECT UNTIL SUCH TIME AS THIS DEVELOPMENT IS CERTIFIED "AS GRADED" BY THE ENGINEER OF RECORD.
- THIS GRADING PLAN IS FOR APPROVAL OF ON-SITE ELEVATIONS ONLY. THE ELEVATIONS SHOWN WITHIN THE PUBLIC RIGHT-OF-WAY REQUIRE SEPARATE PUBLIC WORKS DEPARTMENT APPROVAL & PERMIT. ANY NOTES THAT APPLY TO THE PUBLIC RIGHT-OF-WAY ARE FOR REFERENCE ONLY. IF ON-SITE ELEVATIONS SHOWN DO NOT COINCIDE WITH APPROVED STREET PLANS, AN APPROVED AMENDMENT IS REQUIRED.
- REPAIR ALL DAMAGED AND/OR OFF-GRADE CONCRETE STREET IMPROVEMENTS AS DETERMINED BY THE CONSTRUCTION MANAGEMENT ENGINEER PRIOR TO OCCUPANCY.
- GRADING AND FILLING WILL NOT ALTER OR DIVERT EXISTING DRAINAGE PATTERNS ON ADJACENT PROPERTY AND WILL NOT CAUSE DRAINAGE TO OCCUR TOWARD ANY EXISTING BUILDING (S). ALL SITE GRADING SHALL COMPLY WITH THE 2013 CALIFORNIA BUILDING CODE.
- ALL EXISTING OVERHEAD AND/OR ANY NEW UTILITY FACILITIES LOCATED ON-SITE OR WITHIN THE PUBLIC RIGHT-OF-WAY SHALL BE UNDERGROUND UNLESS OTHERWISE APPROVED BY THE CIVIL ENGINEER IN WRITING.
- ALL REQUIRED RETAINING WALLS AND BLOCK WALLS WILL NEED TO BE FINALED BEFORE AS-GRADE CAN BE APPROVED.
- RECOMMENDATIONS AS OUTLINED IN SOILS REPORT PREPARED BY _____ REPORT NO. XXX-XXXX, DATED _____ SHALL BECOME REQUIREMENT FOR SITE PREPARATION, GRADING AND DEVELOPMENT.
- A SEPARATE GRADING PERMIT WILL BE REQUIRED FOR PHASED PROJECTS. IF GRADING IS NOT COMPLETED PER APPROVED GRADING PLAN, ANY BUILDINGS NOT GRANTED A "SAFE-TO-OCCUPY" WILL REQUIRE A SEPARATE SUBMITTAL AND APPROVAL.
- ALL ON-SITE UTILITY IMPROVEMENTS ARE TO BE PRIVATE.
- A POST-CONSTRUCTION ELEVATION CERTIFICATION IS REQUIRED TO BE REVIEWED AND APPROVED PRIOR TO OCCUPANCY.

SHEET INDEX:

SHEET NO.	DESCRIPTION
1	COVER SHEET
2	GRADING PLAN
3	DETAIL SHEET
4	EROSION CONTROL SHEET

NOTES:

THE SITE IS LOCATED IN FEMA FLOOD ZONE "X" "SHADED" (0.2% FLOOD HAZARD CHANCE) PER THE COMMUNITY MAP 060048 06019C1570H, EFFECTIVE ON 02/18/2009


STORM DRAIN NOTES:

- CONTRACTOR SHALL NOTIFY FMFCO CONSTRUCTION MANAGER AT (559)456-3292 PRIOR TO CONNECTING TO ANY STORM DRAIN FACILITY.
- ALL WORK SHALL BE DONE IN ACCORDANCE WITH THE STANDARD PLANS AND SPECIFICATIONS OF THE FRESNO METROPOLITAN FLOOD CONTROL DISTRICT, DATED APRIL 1, 2011 AND REVISIONS THERETO.


CITY OF FRESNO

PLANS FOR VETERANS PARKING LOT

P18-02655

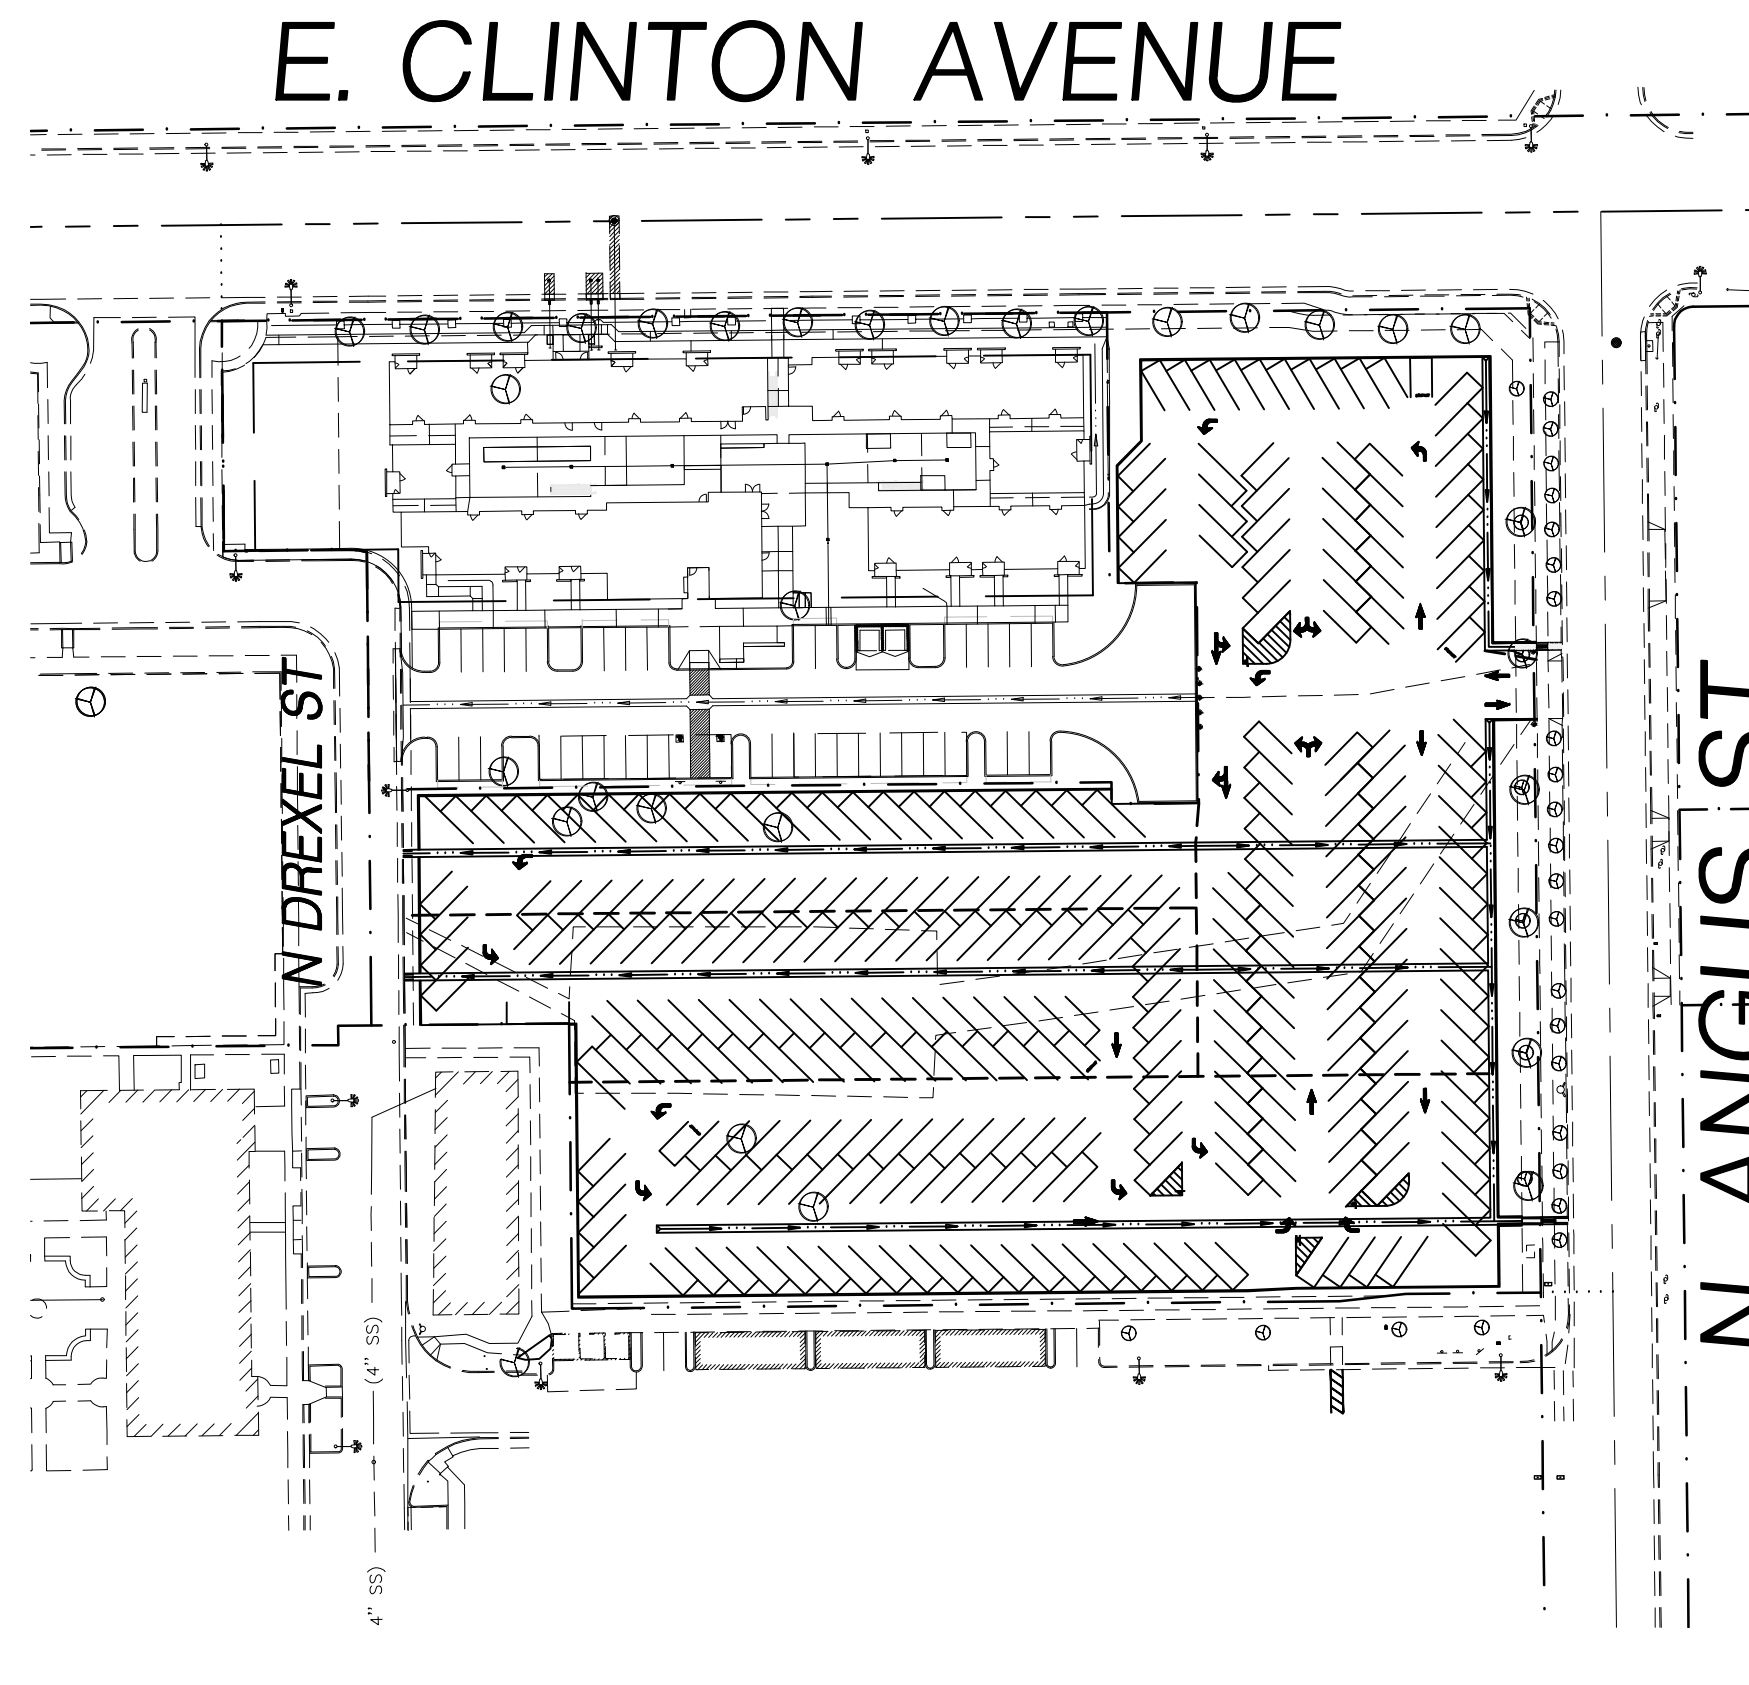

VICINITY MAP:

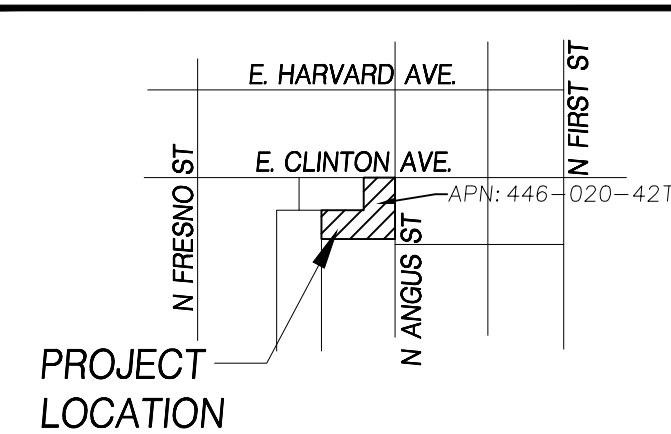

LEGEND:

---	EXISTING SECTION LINE	AP	ANGLE POINT
---	EXISTING CENTER LINE	BLDG	BUILDING
---	EXISTING PROPERTY LINE	C	CONCRETE
---	EXISTING RIGHT-OF-WAY LINE	CATV	CABLE TELEVISION
=====	EXISTING CURB & GUTTER	CL	CENTER LINE
=====	PROPOSED CURB & GUTTER	ELB	ELECTRIC BOX
---	EXISTING EDGE OF PAVEMENT	EP	EDGE OF PAVEMENT
---	EXISTING WATER LINE	FD	FINISH DIRT
---	EXISTING STORM DRAIN LINE	FF	FINISH FLOOR
---	PROPOSED STORM DRAIN LINE	FH	FIRE HYDRANT
---	EXISTING SEWER LINE	FL	FLOWLINE
---	EXISTING IRRIGATION LINE	FNC	FENCE
---	SAWCUT LINE	GB	GRADE BREAK
---	GRADE BREAK	GW	GUY WIRE
---	EXISTING WATER VALVE	HP	HINGE POINT
---	EXISTING FIRE HYDRANT	LIP	LIP OF GUTTER
---	EXISTING WATER METER	OG	ORIGINAL GROUND
---	EXISTING SANITARY SEWER MANHOLE	P	PAVEMENT
---	EXISTING STORM DRAIN MANHOLE	PL	PROPERTY LINE
---	PROPOSED STORM DRAIN MANHOLE	PP	POWER POLE
---	EXISTING STORM DRAIN INLET	RET	RETURN
---	PROPOSED STORM DRAIN INLET	R/W	RIGHT-OF-WAY LINE
---	EXISTING STREET LIGHT	S	SLOPE
---	PROPOSED STREET LIGHT	SDMH	STORM DRAIN MANHOLE
---	EXISTING UTILITY POLE	SL	SECTION LINE
---	EXISTING TRANSFORMER POLE	SSMH	SANITARY SEWER MANHOLE
---	EXISTING POWER POLE	SW	SIDEWALK
---	EXISTING ANCHOR POLE	TC	TOP OF CURB
---	EXISTING TREE	TELB	TELEPHONE BOX
---	EXISTING DRIVE APPROACH	TELR	TELEPHONE RISER
---		TOE	TOE OF SLOPE
---		TOP	TOP OF SLOPE
---		TP	TELEPHONE POLE
---		VP	VENT PIPE/STAND PIPE
---		WM	WATER METER
---		WV	WATER VALVE

BENCHMARK:

FRESNO CITY BM 970
BRASS CAP ON CURB, WEST RETURN, SOUTHWEST CORNER OF PERRIN & WILLOW
ELEVATION = 373.203 FEET

SITE ADDRESS:

2243 N ANGUS ST
FRESNO, CA 93703
APN: 446-020-42T

PROPERTY OWNER:

FRESNO HOUSING AUTHORITY
1331 FULTON MALL
FRESNO, CA 93721

SITE AREA:

±2.75 AC

WDID:



APPROVED
FRESNO METROPOLITAN FLOOD CONTROL DISTRICT FMFCO APPROVAL IS LIMITED TO:
1. ON-SITE DRAINAGE AREA BOUNDARIES
2. LOCATION OF DRAINAGE ENTRY INTO PUBLIC STREETS

NOTE:

AS-GRADE PLANS, FINAL SOILS REPORT (IF APPLICABLE) AND COMPACTION REPORTS ARE REQUIRED TO BE SUBMITTED AND APPROVED PRIOR TO RECEIVING A "FINAL". A "SAFE-TO-OCCUPY" CAN BE GRANTED BUT WILL REQUIRE A \$15,000.00 CASH DEPOSIT. THE DEPOSIT WILL BE FULLY REFUNDED ONCE THE "AS-GRADE" HAS BEEN APPROVED AND ALL OTHER HOLDS HAVE BEEN CLEARED FOR THE ENTIRE PROJECT. DEPOSITS ARE TYPICALLY REFUNDED FROM THE FINANCE DEPARTMENT IN THE FORM OF A CHECK APPROXIMATELY 1 WEEK AFTER THE REFUND IS REQUESTED. THERE WILL BE A ONE-TIME \$60.00 HANDLING FEE FOR THE "SAFE-TO-OCCUPY" TRANSACTION SHOULD IT BE REQUESTED.

Ref. & Rev.

Yamabe & Horn
Engineering, Inc.
CIVIL ENGINEERS • LAND SURVEYORS
2985 N. BURL AVENUE SUITE 101 FRESNO, CA 93727
TEL (559) 244-3123 WEBSITE: YANDHORN.COM

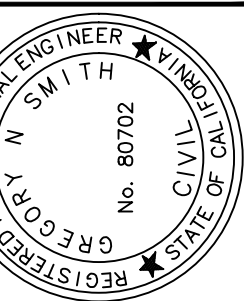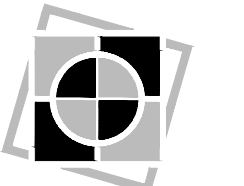

VA HOSPITAL - TEMPORARY PARKING LOT
CLINTON AVENUE - APN: 446-020-42T

COVER SHEET

P18-02655 - PLAN CHECK # B18-07378

PROJECT TITLE

DR. BY: KR

CH. BY: GS

DATE: 12/11/2018

SCALE: AS NOTED

YH JOB NO. 18-267

SHEET NO. 1

OF 4 SHEETS



PAVEMENT SECTION:

PAVEMENT SECTION (T.I.=5.0, R-VALUE=56)
2" ASPHALT CONCRETE TYPE A
4" AGGREGATE BASE CLASS II WITH 95% REL. COMP.
12" SUBGRADE COMPACTED TO 95% REL. COMP.
SEE SECTION DETAIL THIS SHEET.

EXISTING CONCRETE IMPROVEMENTS

KEYNOTES:


- (A) CONSTRUCT 2' WIDE CONC. CHANNEL PER DETAIL D1-3
- (B) CONSTRUCT 3' WIDE CONC. VALLEY GUTTER PER DETAIL D2-3
- (C) CONSTRUCT 24" CURB TRANSITION PER DETAIL D3-3
- (D) CONSTRUCT 6" CURB CUT OUT PER DETAIL D4-3
- (E) INSTALL CONCRETE SIDEWALK DRAINS (CHANNEL) PER CITY STD. P-23
- (F) PROPOSED PARKING SIGNAGE
- (G) PROPOSED 6" TYPE 'A' AC DIKE PER DETAIL D5-3
- (PC) EXISTING CURB AND GUTTER TO REMAIN
- (P) EXISTING CURB TO REMAIN
- (PA) EXISTING DRIVE APPROACH TO REMAIN
- (RT) EXISTING TREE TO BE REMOVED
- (RT) EXISTING TREE TO REMAIN
- (PS) EXISTING SIDEWALK TO REMAIN
- (RC) EXISTING GRAVEL ROAD & PARKING LOT TO BE REMOVED
- (RB) EXISTING BOLLARDS AND CURB TO BE REMOVED FOR PROPOSED FIRE LANE

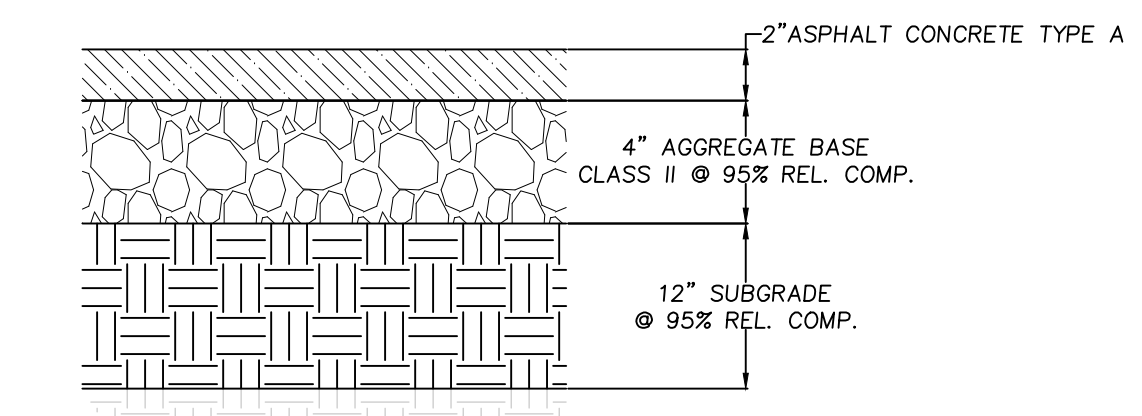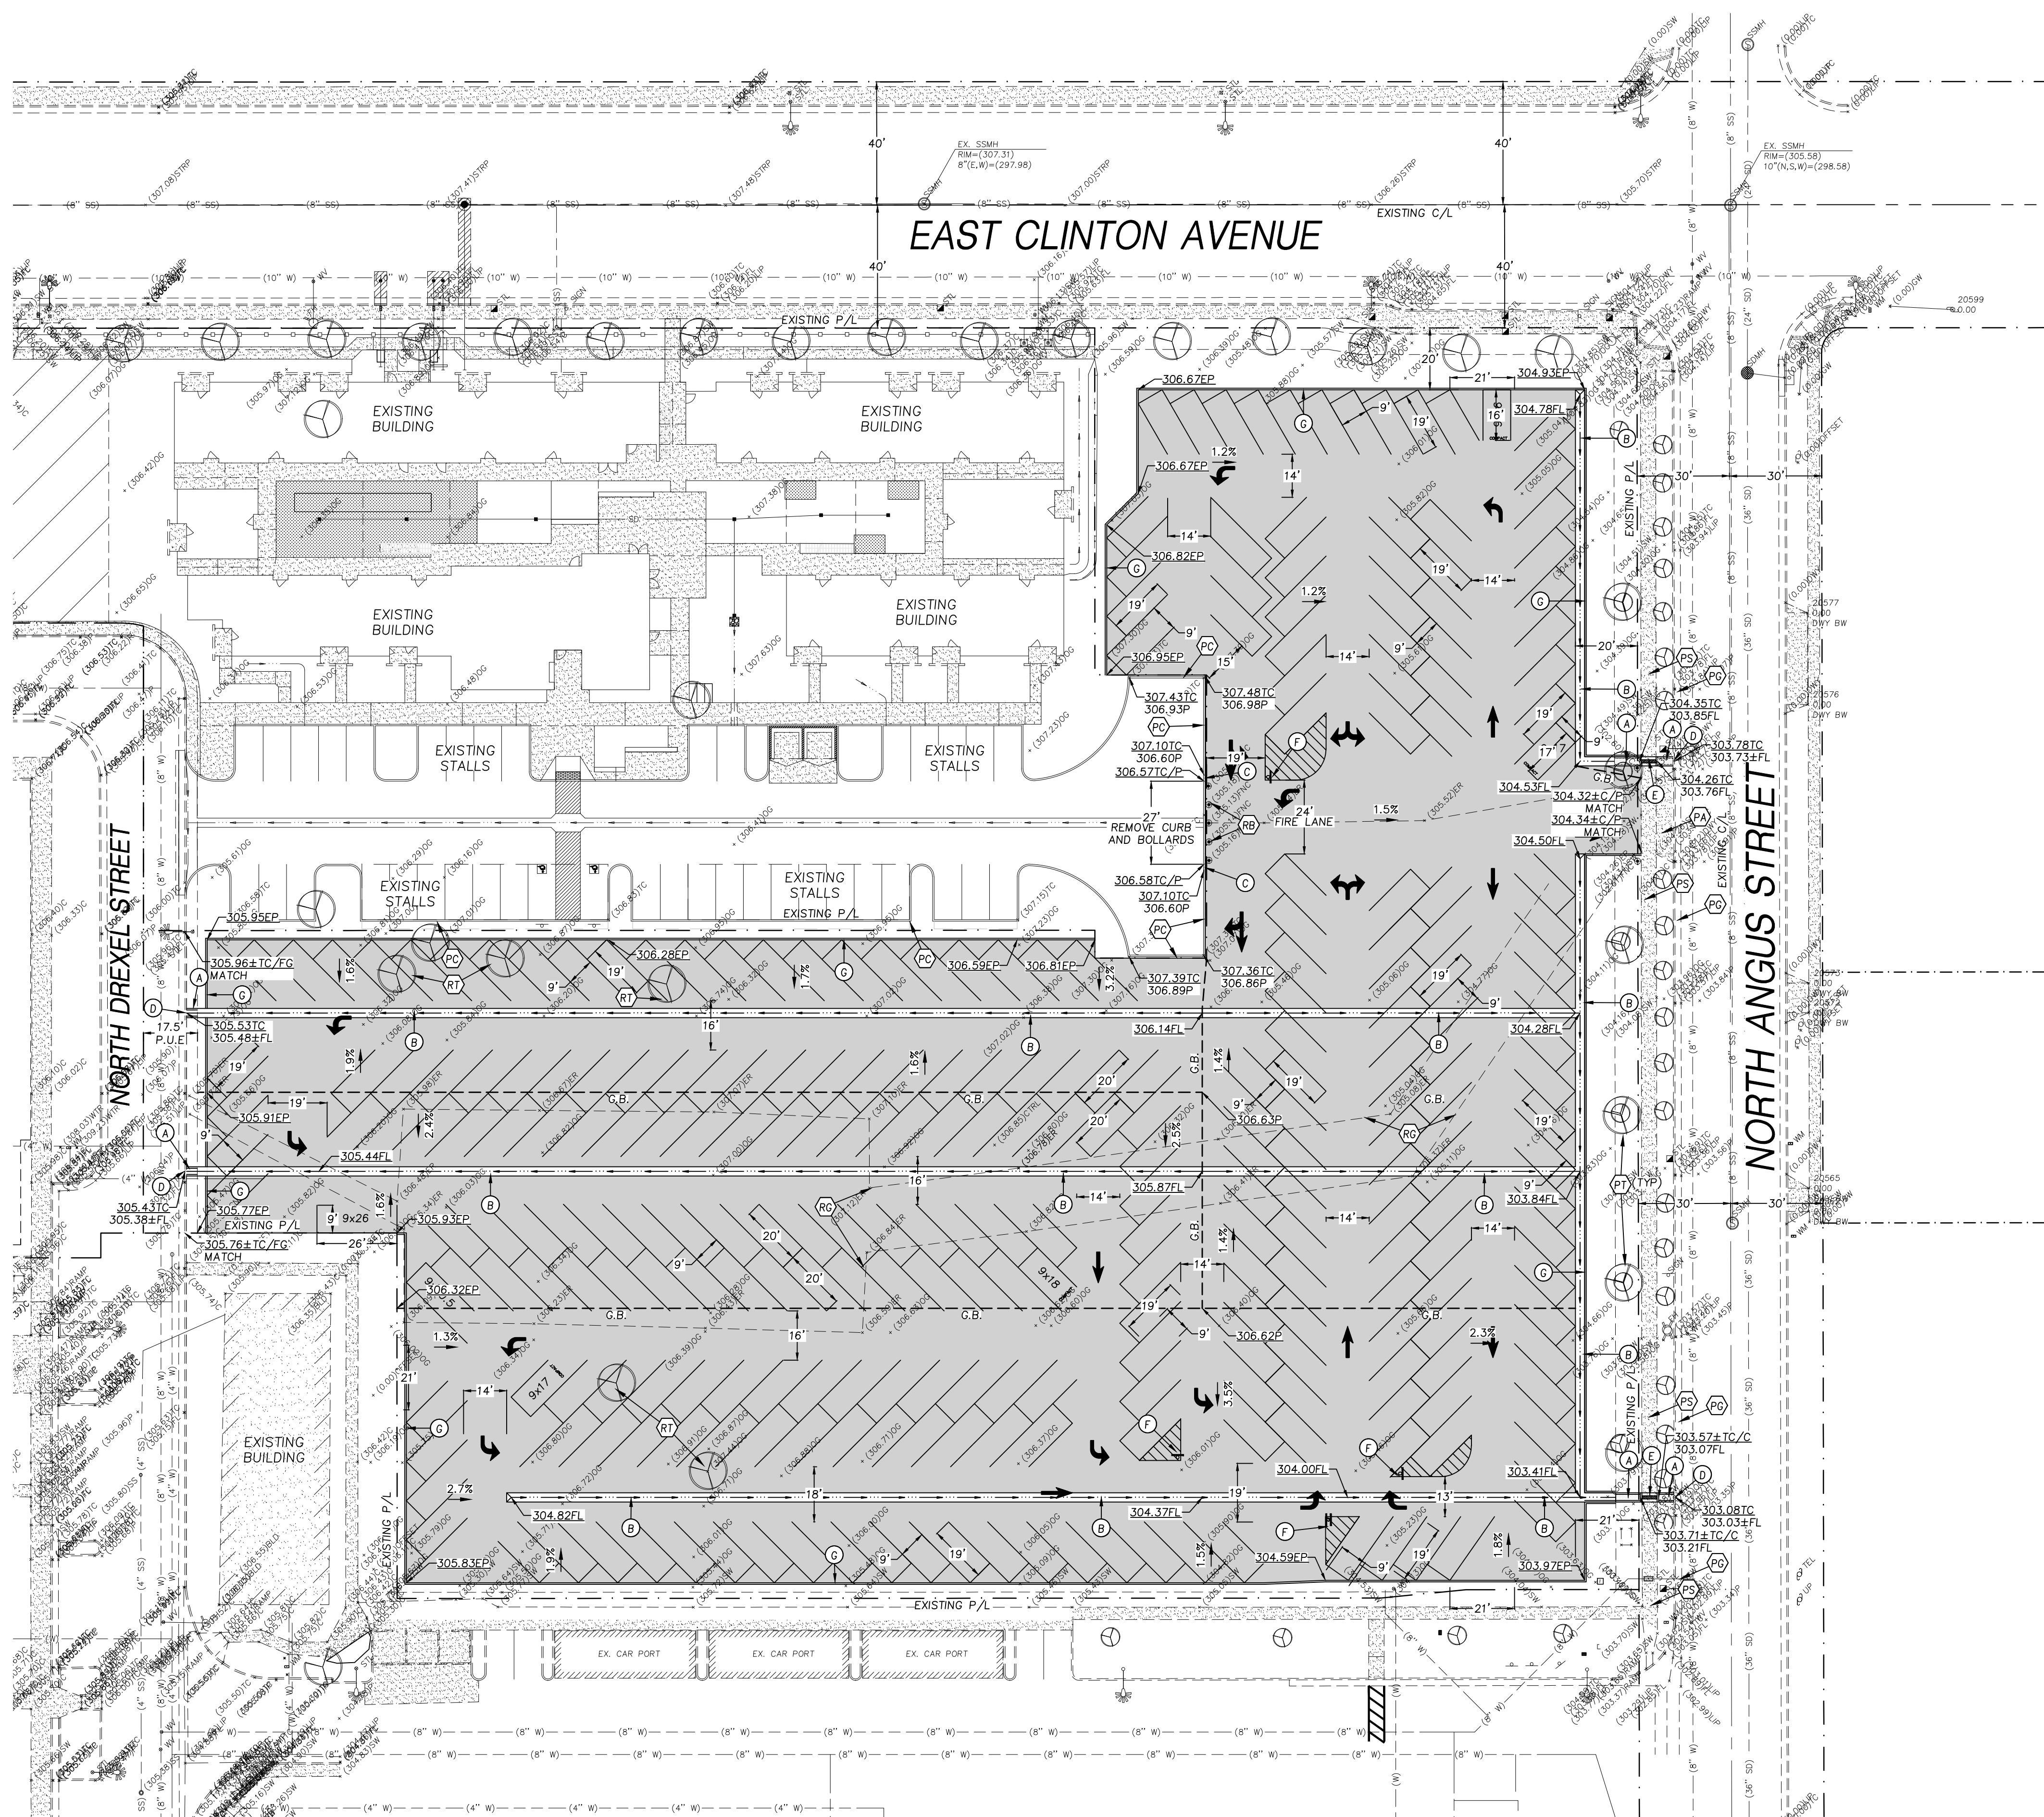

PAVEMENT SECTION SECTION (T.I.=5.0, R-VALUE=56) DETAIL

SCALE: 1" = 30'

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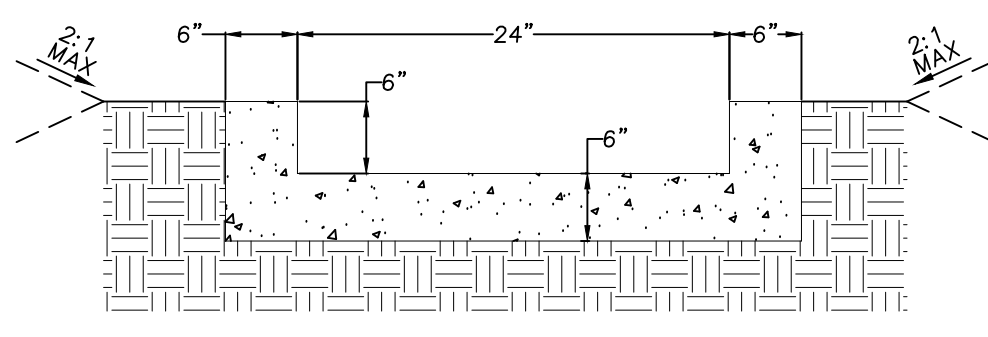
PROJECT TITLE
VA HOSPITAL - TEMPORARY PARKING LOT
CLINTON AVENUE - APN: 446-020-42T

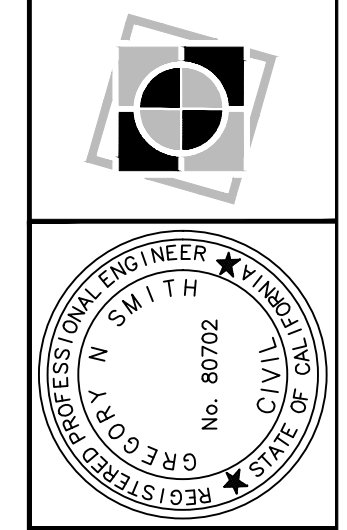SHEET DESCRIPTION
GRADING PLAN


P18-02655 - PLAN CHECK # B18-07378

Dr. By:	KR
Ch. By:	GS
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Scale:	As Noted
YH Job No.:	18-267
Sheet No.:	2
of	4 Sheets


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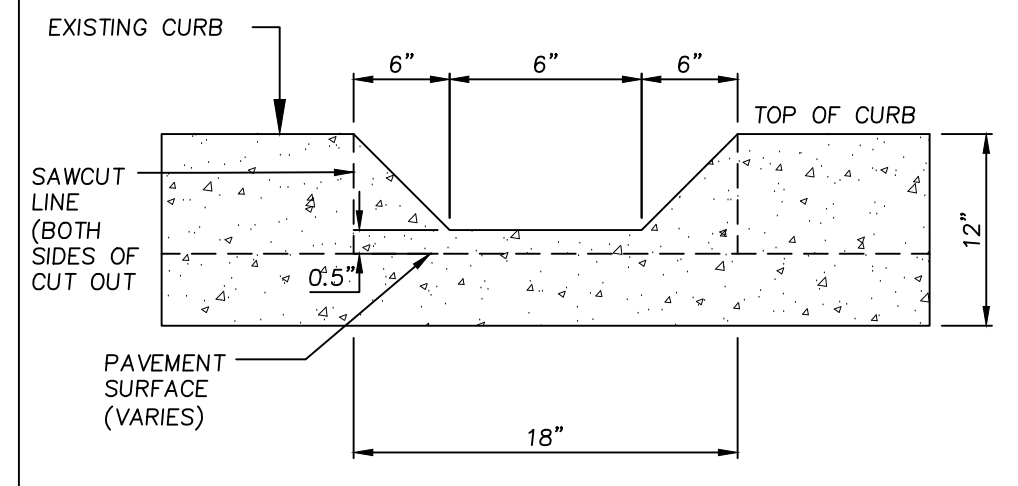
D1
3 **24" WIDE CONCRETE CHANNEL DETAIL**
N.T.S.




D2
3 **36" WIDE VALLEY GUTTER DETAIL**
NO SCALE

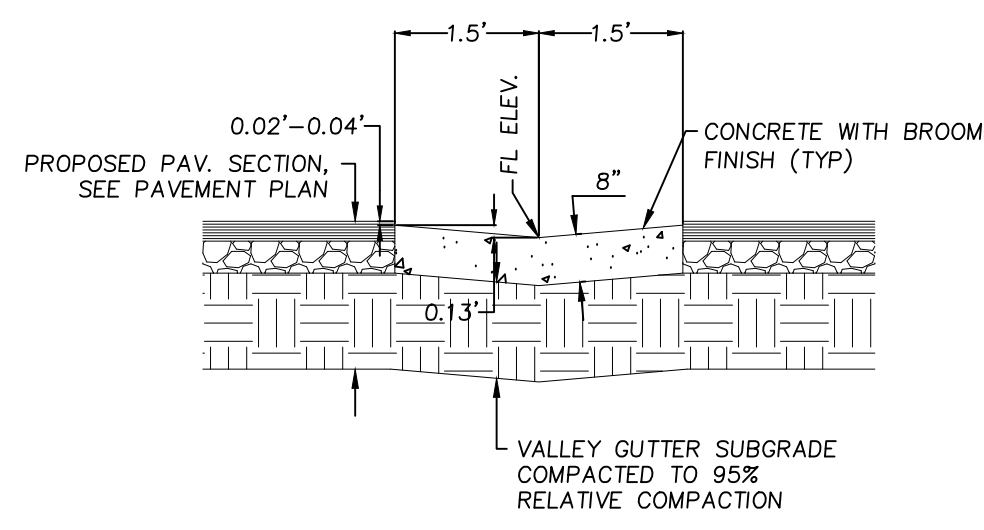

D3
3 **24" CURB TRANSITION DETAIL**
NO SCALE

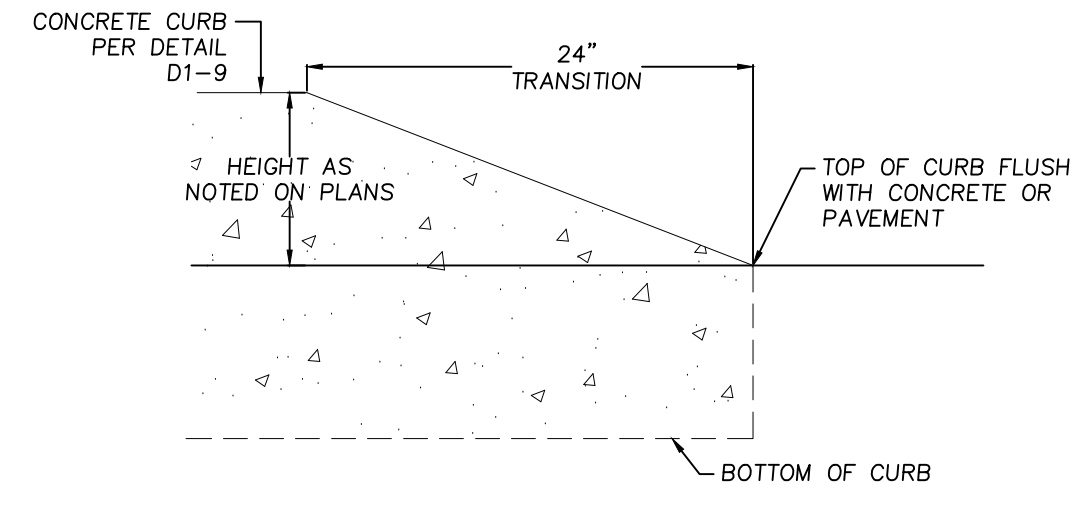



D4
3 **6" CURB CUT-OUT DETAIL**
NO SCALE

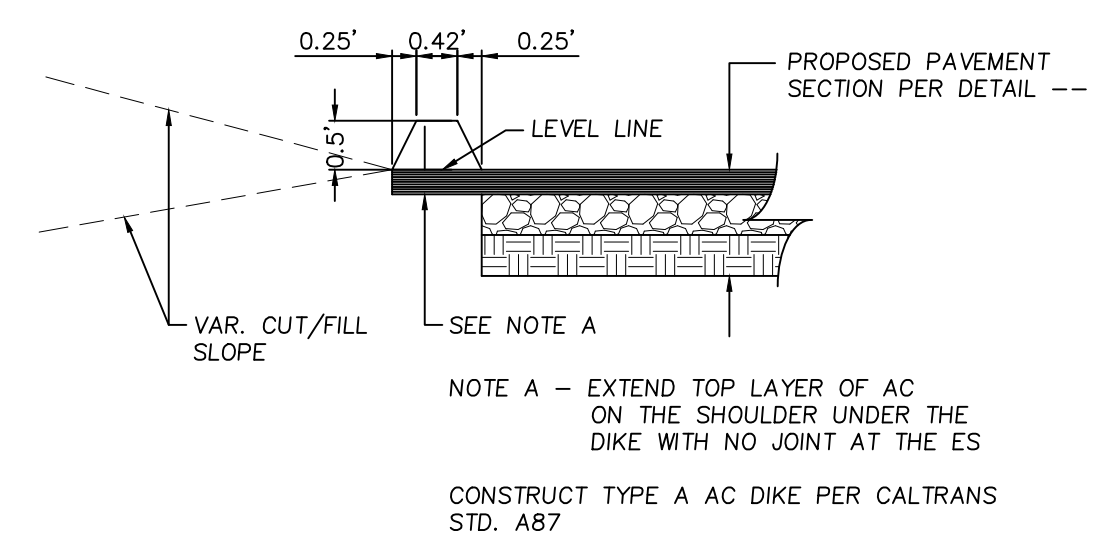

D5
3 **6" TYPE 'A' AC DIKE DETAIL**
NO SCALE

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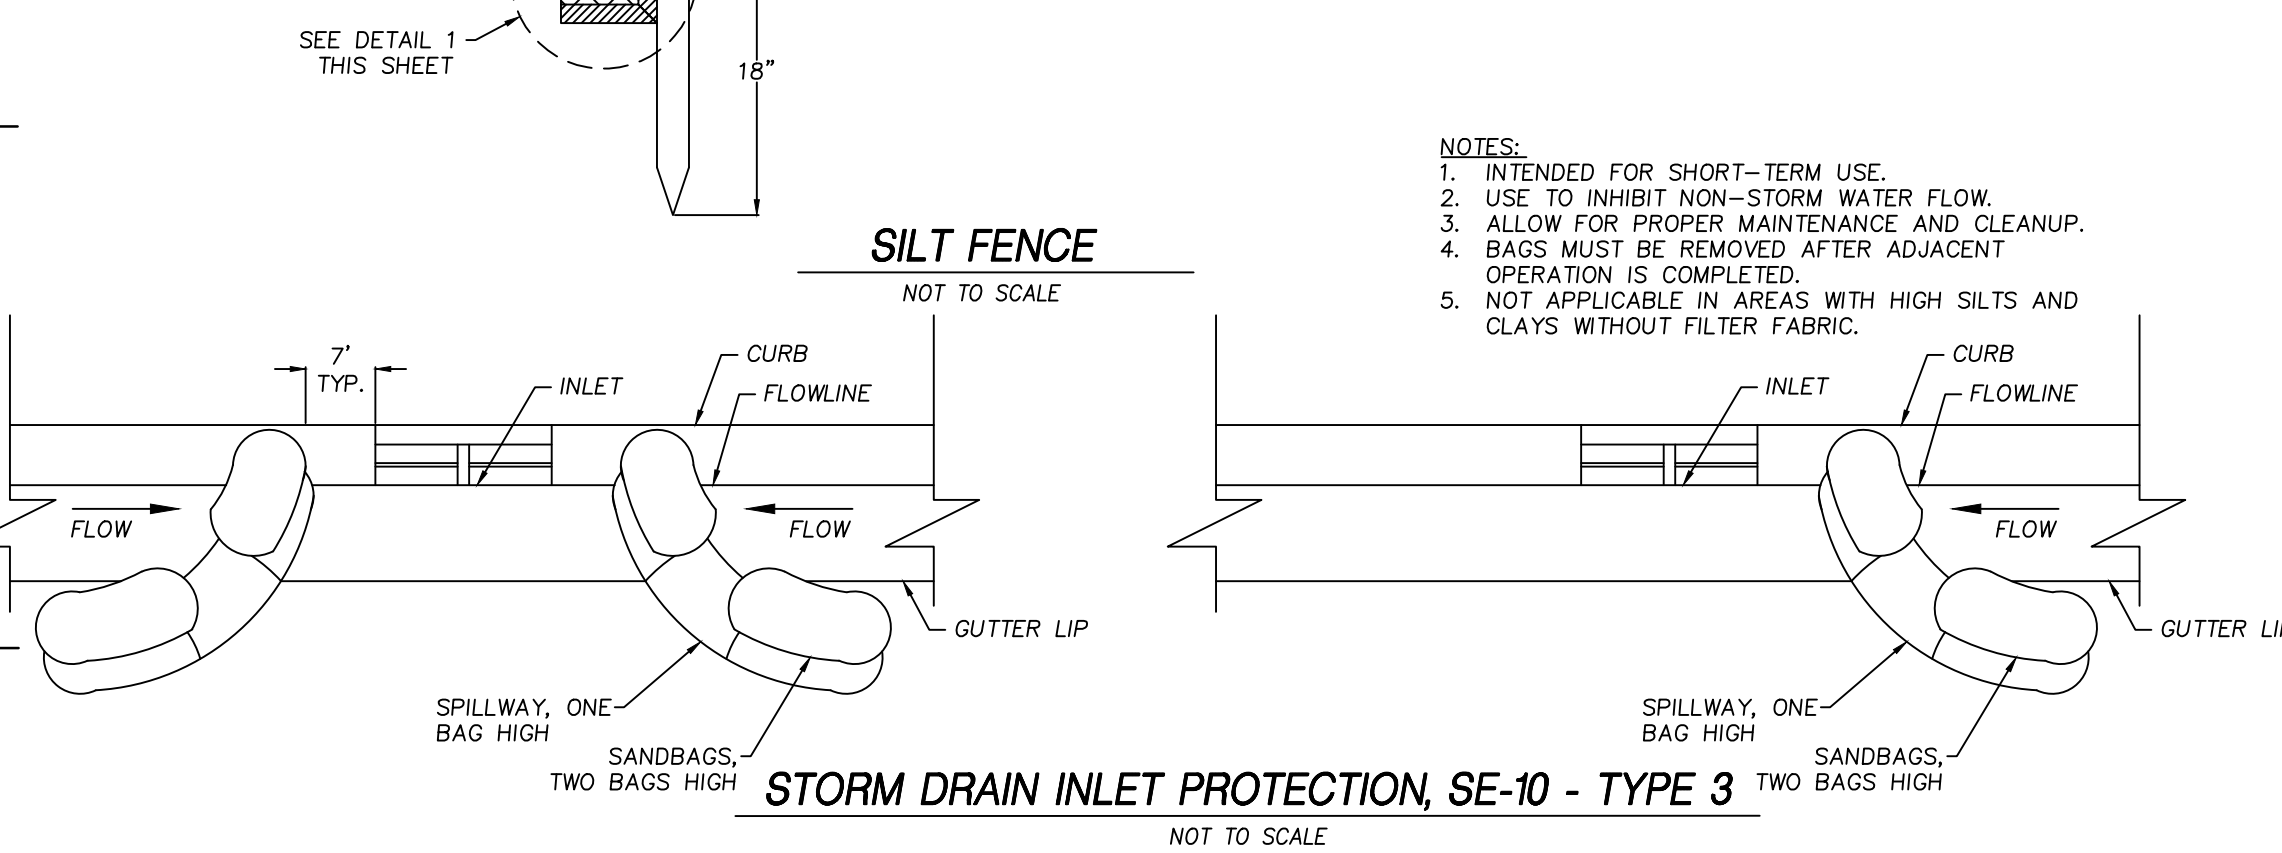
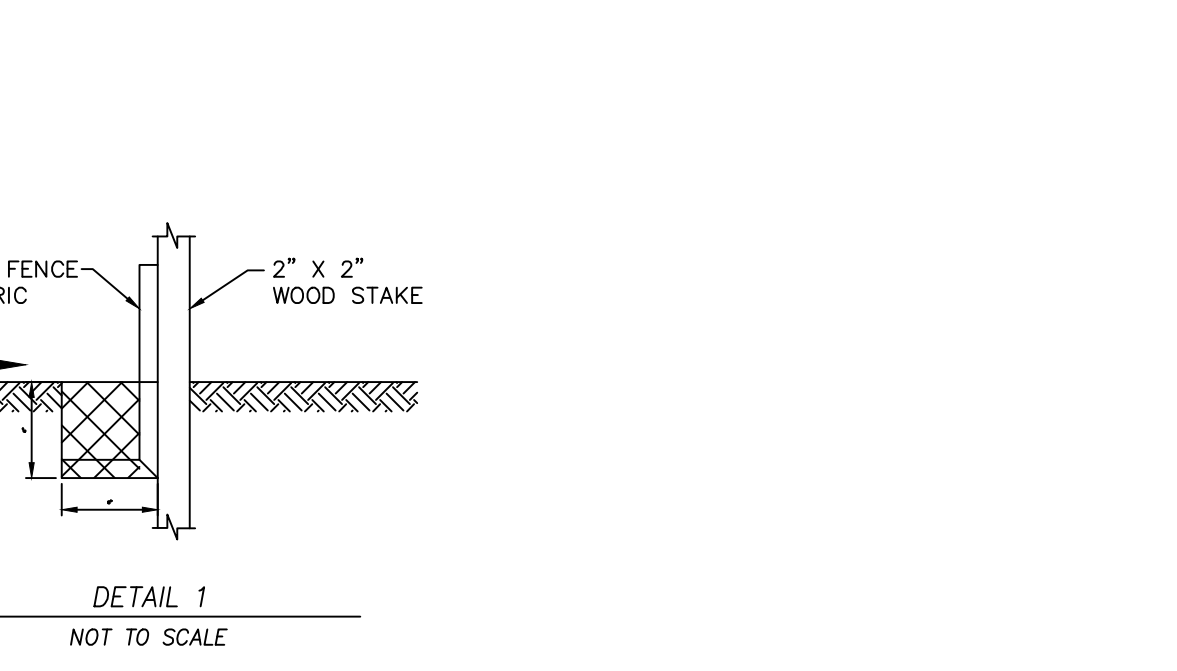
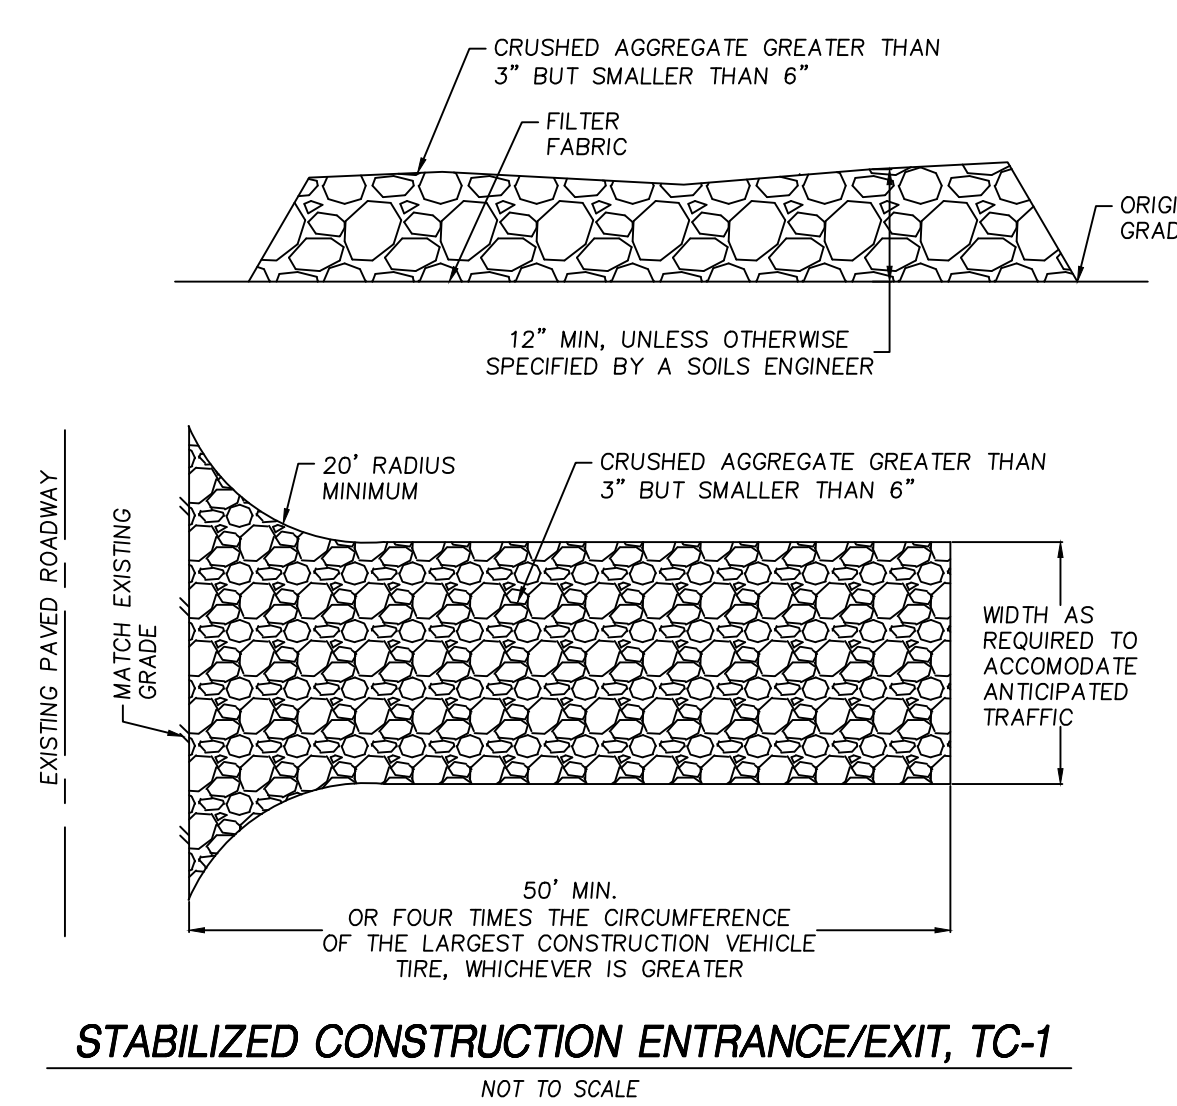
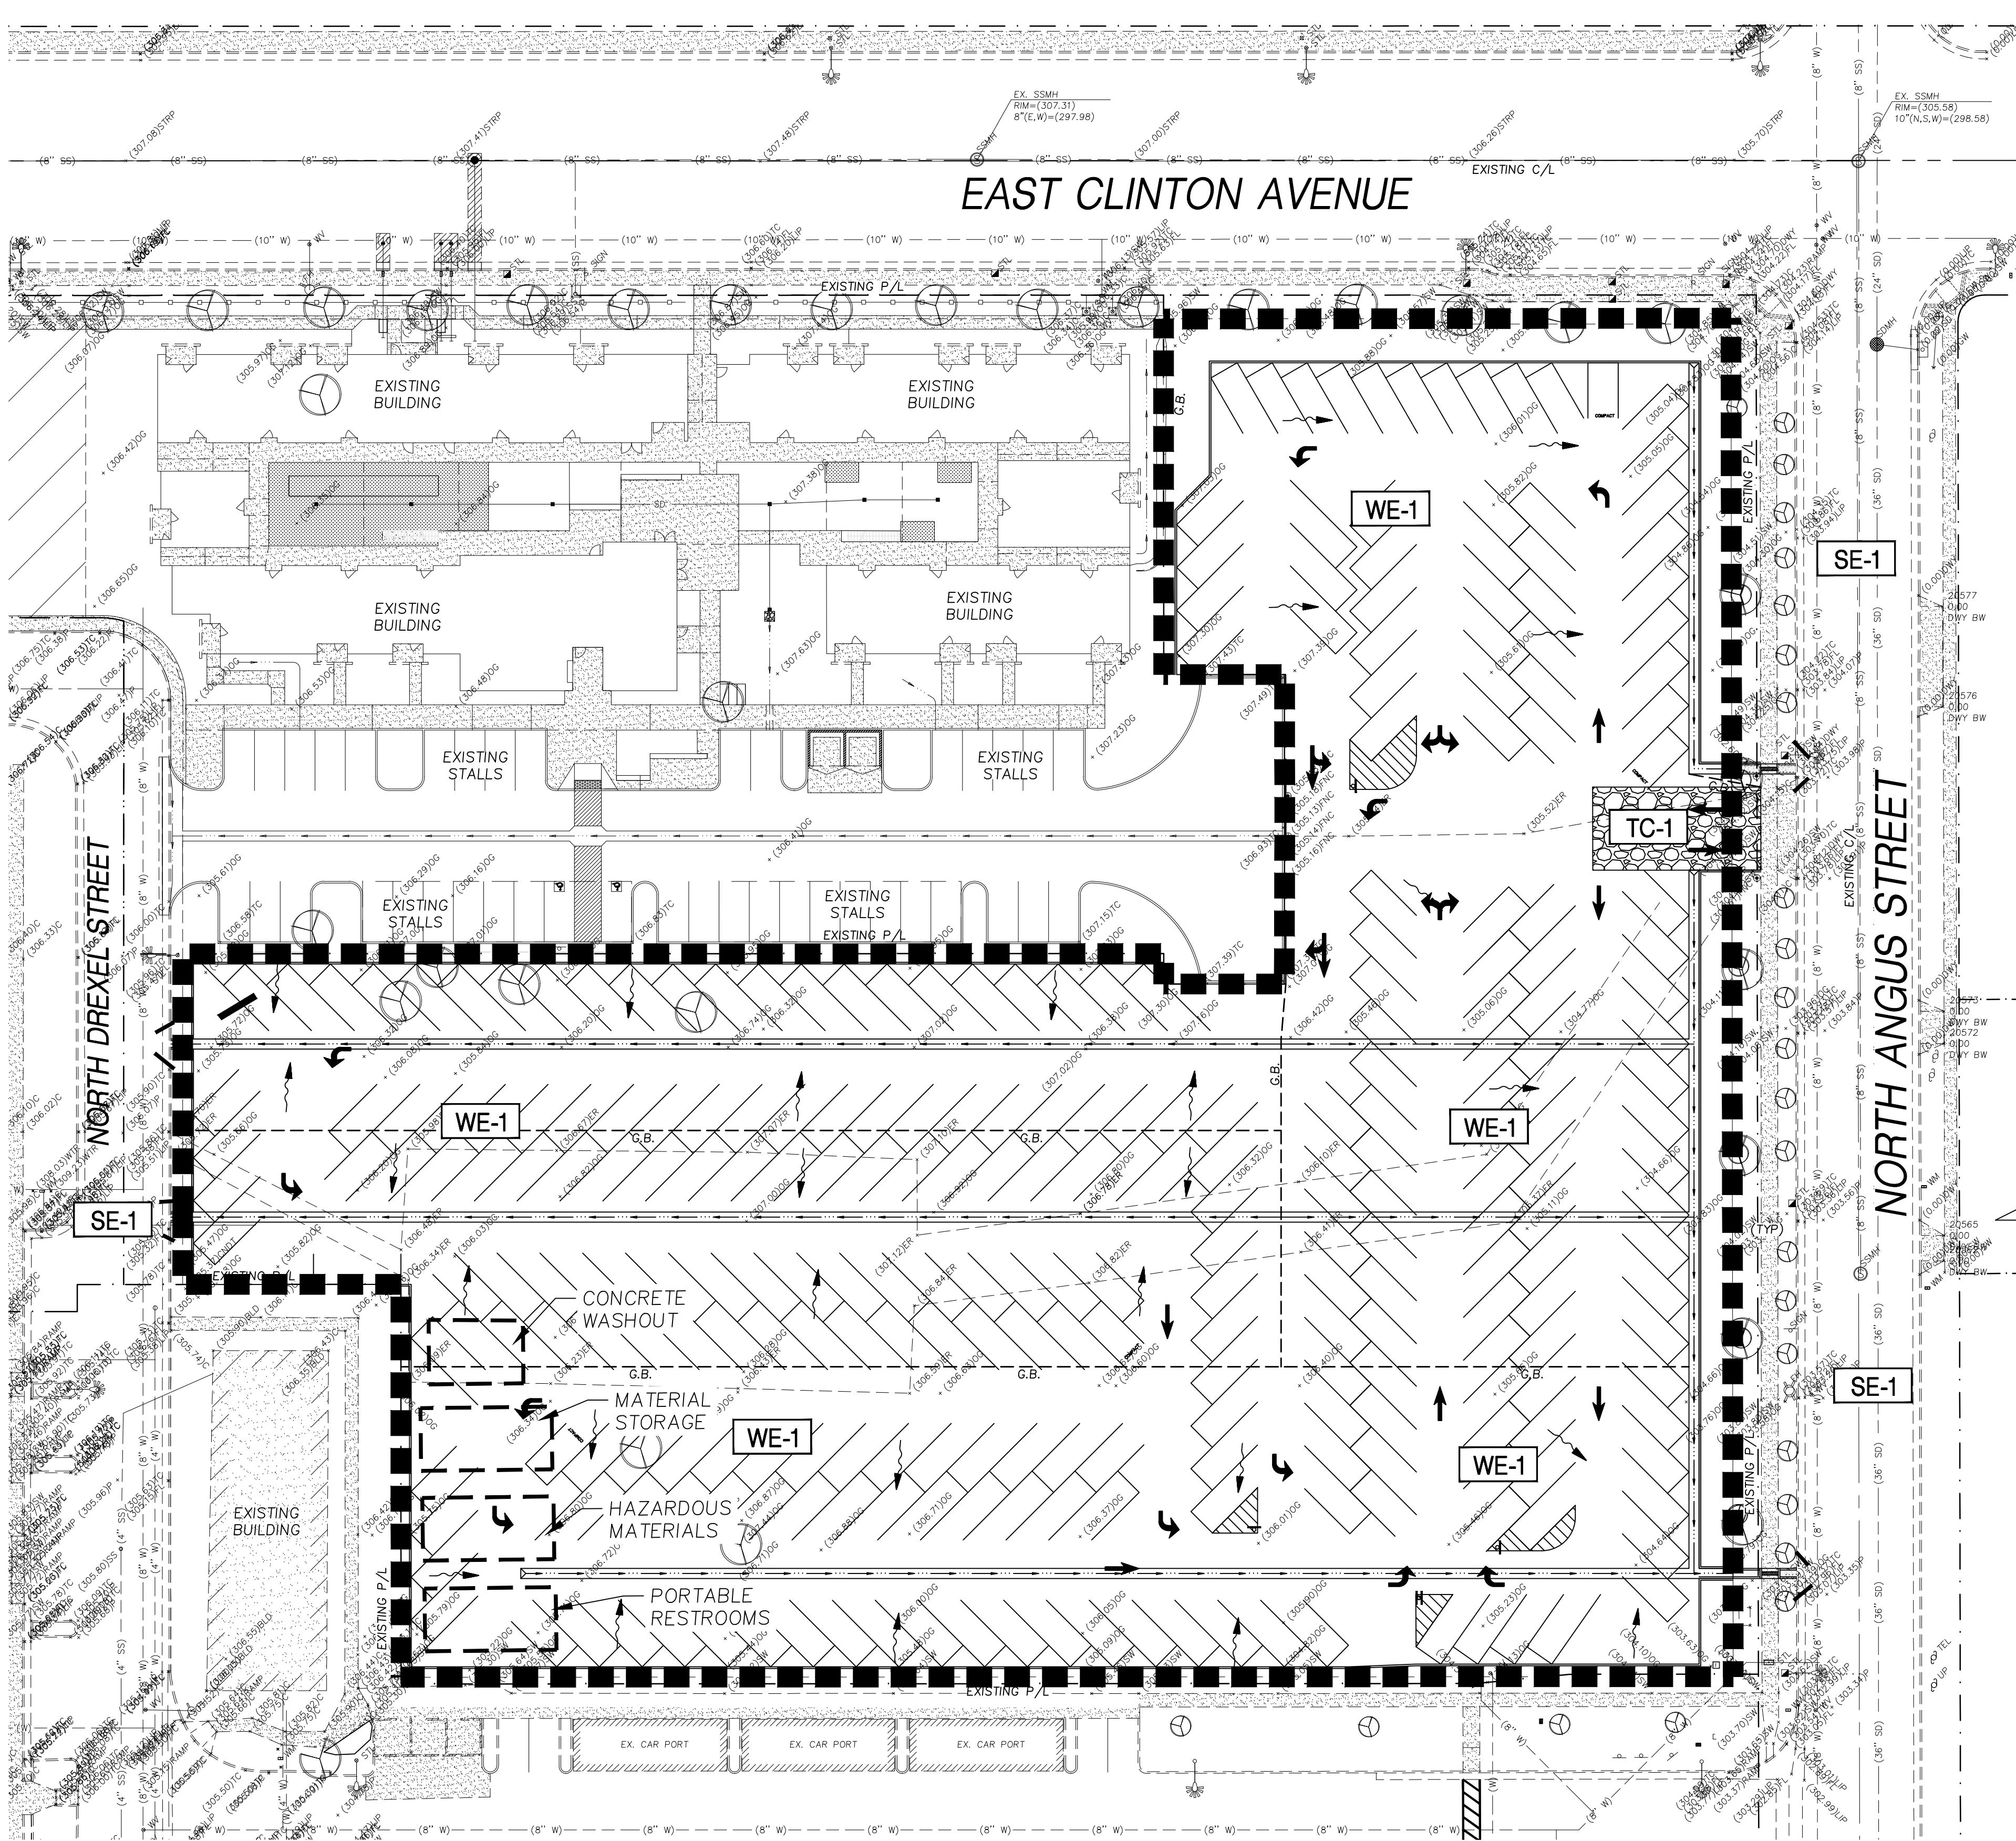
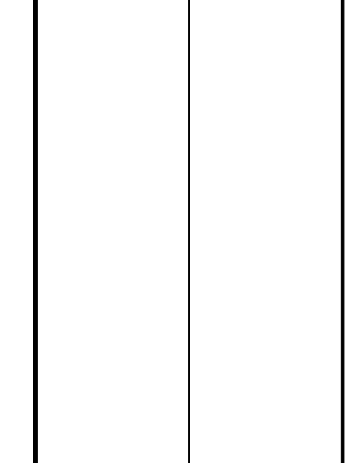
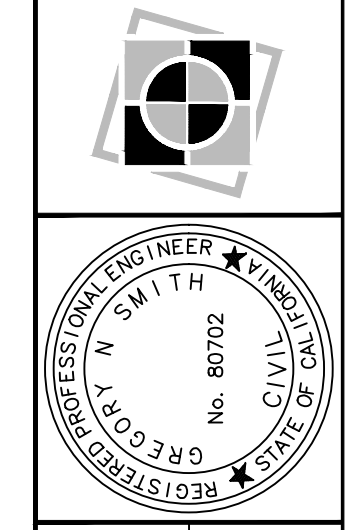
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PROJECT TITLE
VA HOSPITAL - TEMPORARY PARKING LOT
CLINTON AVENUE - APN: 446-020-42T


SHEET DESCRIPTION
DETAIL SHEET

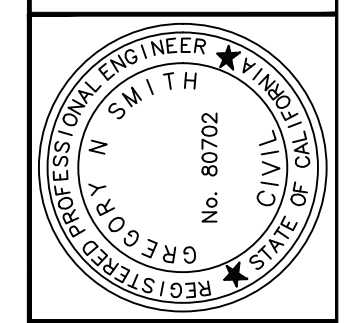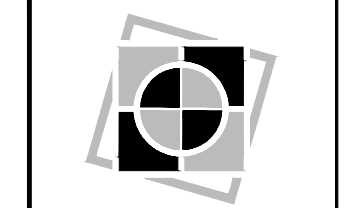Dr. By: KR
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Date: 12/11/2018
Scale: As Noted
YH Job No. 18-267
Sheet No. 3
of 4 Sheets

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- NOTES:
- 1. INTENDED FOR SHORT-TERM USE.
 - 2. USE TO INHIBIT NON-STORM WATER FLOW.
 - 3. ALLOW FOR PROPER MAINTENANCE AND CLEANUP.
 - 4. BAGS MUST BE REMOVED AFTER ADJACENT OPERATION IS COMPLETED.
 - 5. NOT APPLICABLE IN AREAS WITH HIGH SILTS AND CLAYS WITHOUT FILTER FABRIC.



LEGEND:

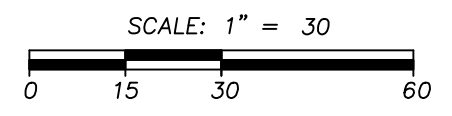	DRAINAGE DIRECTION
	STABILIZED CONSTRUCTION SITE ENTRANCE/EXIT
	SILT FENCE, SEE DETAIL THIS SHEET
	STORM DRAIN INLET PROTECTION, TYPE AS NOTED
	STREET SWEEPING & VACUUMING
	LIMITS OF WORK
	INSTALL AND MAINTAIN SILT FENCE
	INSTALL AND MAINTAIN WEIGHTED STRAW WADDLE OR EQUIVALENT CURB PROTECTION

- CONTRACTOR NOTES:**
1. CONTRACTOR WILL BE RESPONSIBLE FOR COMPLYING WITH THE STORM WATER DISCHARGE GENERAL PERMIT AND SHALL IMPLEMENT BMP'S AS INDICATED ON THIS PLAN, AT A MINIMUM.
 2. CONTRACTOR TAKES FULL RESPONSIBILITY FOR IMPLEMENTING, MONITORING, REPORTING, AND ADDING ANY ADDITIONAL BMP'S DURING CONSTRUCTION FOR COMPLIANCE WITH THE GENERAL PERMIT AT THEIR SOLE EXPENSE.
 3. CONTRACTOR SHALL BE RESPONSIBLE FOR PROVIDING A QUALIFIED SWPPP PRACTITIONER (OSP) FOR THE DURATION OF THE PROJECT AND UNTIL THE NOTICE OF TERMINATION IS APPROVED.
 4. CONTRACTOR WILL BE RESPONSIBLE FOR PREPARING THE NOTICE OF TERMINATION AND ANNUAL REPORT ON THE STATE WATER BOARD'S SMARTS WEBSITE. THE OWNER (LRP) WILL BE RESPONSIBLE FOR REVIEWING AND SUBMITTING THE NOTICE OF TERMINATION AND ANNUAL REPORT WITHIN SAID WEBSITE.

BMP LEGEND:

EC-1	SCHEDULING	NS-12	CONCRETE CURING
EC-2	PRESERVATION OF EXISTING VEGETATION	NS-13	CONCRETE FINISHING
SE-1	SILT FENCE	TC-1	STABILIZED CONSTRUCTION ENTRANCE/EXIT
SE-5	FIBER ROLLS	WM-1	MATERIAL DELIVERY AND STORAGE
SE-7	STREET SWEEPING AND VACUUMING	WM-2	MATERIAL USE
WE-1	WIND EROSION CONTROL	WM-3	STOCKPILE MANAGEMENT
NS-1	WATER CONSERVATION PRACTICES	WM-4	SPILL PREVENTION AND CONTROL
NS-3	PAVING AND GRINDING OPERATIONS	WM-5	SOLID WASTE MANAGEMENT
NS-6	ILLICIT CONNECTION/DISCHARGE	WM-6	HAZARDOUS WASTE MANAGEMENT
NS-7	POTABLE WATER/IRRIGATION	WM-8	CONCRETE WASTE MANAGEMENT
NS-8	VEHICLE AND EQUIPMENT CLEANING	WM-9	SANITARY/SEPTIC WASTE MANAGEMENT
NS-9	VEHICLE AND EQUIPMENT FUELING		

- NOTES:**
1. ALL EROSION CONTROL MEASURES AND TECHNIQUES SHALL BE INSTALLED AND MAINTAINED PER THE CALIFORNIA STORMWATER BEST MANAGEMENT PRACTICES HANDBOOK, LATEST EDITION.
 2. DUST CONTROL SHALL BE PROVIDED FOR ALL AREAS AFFECTED BY CONSTRUCTION.
 3. CONTRACTOR SHALL SEQUENCE WORK TO REDUCE SOIL EROSION BY WIND, RAIN AND RUNOFF.
 4. REFER TO THE SWPPP BOOKLET FOR DETAILS ON THE BMP'S USED FOR THE SITE. IT SHALL BE KEPT ON THE SITE AT ALL TIMES AND BE MADE AVAILABLE FOR THE OSP AND OTHERS INSPECTING THE SITE. A DIGITAL COPY CAN BE FOUND AT [HTTPS://SMARTS.WATERBOARDS.CA.GOV/SMARTS/FACES/PUBLICDATAACCESS/](https://smarts.waterboards.ca.gov/smarts/faces/publicdataaccess/)
 5. THE CONTRACTOR, OWNER & SUB-CONTRACTORS (BUT NOT LIMITED TO) ARE RESPONSIBLE FOR SWPPP (STORM WATER POLLUTION PREVENTION PROGRAM), THE IMPLEMENTATION AND VIOLATIONS. THEY SHOULD BE TRAINED AS NEEDED BY THE OSP (QUALIFIED SWPPP PRACTITIONER) AND OR HIS DESIGNATED REPRESENTATIVE.
 6. ALL MATERIALS FOR THE PROJECT, INCLUDING THE NATIVE SOIL (SEDIMENT) ARE CONSIDERED POLLUTANTS. THE POLLUTANTS SHALL NOT LEAVE THE SITE VIA DRAINAGE, WHEEL TRACKING AND/OR BY WIND. ALL MATERIALS INCLUDING WASTE ARE TO LEAVE THE SITE IN ADEQUATELY CONTAINED CONTAINERS.
 7. ALL SITE SWPPP CHANGES ARE TO BE COORDINATED WITH THE OSP. THE PRACTITIONER WILL PROVIDE WEEKLY INSPECTIONS AND AT LEAST ONE FOR EACH 24-HR PERIOD DURING EXTENDED STORM EVENTS, TO CHECK MAINTENANCE AND REPAIRS. ALL REPAIRS AND MAINTENANCE FOR BMP'S ARE TO BE DONE SOON AS POSSIBLE.
 8. ALL WASTE AND STORAGE CONTAINERS SHALL BE KEPT COVERED AT ALL TIMES TO PREVENT LEACHING OF THE WASTE & MATERIALS FROM ESCAPING THEIR CONTAINER AND ONTO THE SITE. HAZARDOUS WASTE (PAINTS, STAINS, GLUES, ADHESIVES, ETC) SHALL BE STORED IN COVERED AREAS WITH SECONDARY CONTAINMENT FOR LIQUID MATERIALS IN CASE OF ACCIDENTAL EAKAGE/SPILLAGE.