GENERAL NOTES- SITE ELECTRICAL

1. THE COMPLETE INSTALLATION SHALL CONFORM WITH ALL APPLICABLE FEDERAL, STATE AND LOCAL LAWS, CODES AND ORDINANCES, INCLUDED BUT NOT LIMITED TO APPROVED EDITIONS OF THE FOLLOWING: NATIONAL ELECTRICAL SAFETY CODE (ANSI C2): NATIONAL ELECTRICAL CODE (NFPA 70): OCCUPATIONAL SAFETY AND HEALTH ACT (OSHA) AND ALL AMENDMENTS THERETO. NOTHING CONTAINED IN THE DRAWINGS AND SPECIFICATIONS SHALL BE CONSTRUED TO CONFLICT WITH THESE LAWS, CODES, AND ORDINANCES, AND THEY ARE THEREBY INCLUDED IN THESE SPECÍFICATIONS. OBTAIN PERMITS AND REQUEST INSPECTIONS FROM ALL AUTHORITIES HAVING JURISDICTION. COMPLY WITH ALL POWER, TELEPHONE, CABLE TELEVISION PROVIDER REGULATIONS AND STANDARDS.

2. ELECTRICAL UTILITY SHALL PROVIDE ALL ASSOCIATED OVERHEAD AND UNDERGROUND PRIMARY WIRING, PRIMARY TERMINATIONS, TRANSFORMERS, AND CONNECTIONS TO EXISTING OVERHEAD LINES. CONTRACTOR SHALL PROVIDE UNDERGROUND CONDUIT.

3. PROVIDE UNDERGROUND ELECTRICAL WARNING TAPE: 6" WIDE PLASTIC TAPE, COLORED RED WITH SUITABLE LEGEND DESCRIBING BURIED ELECTRICAL LINES FOR ALL UNDERGROUND CONDUITS. LOCATE 6 INCHES BELOW FINISHED GRADE. 4. REFER TO CIVIL DRAWINGS FOR EXCAVATION AND BACKFILL OF ALL UNDERGROUND WORK.

5. EXISTING UTILITY LOCATIONS ARE APPROXIMATE AND SHALL BE FIELD VERIFIED. CONTRACTORS SHALL CONTACT DIG SAFE BEFORE BEGINNING ANY EXCAVATIONS. 6. FINAL LOCATION OF NEW UTILITIES MAY VARY FROM PLANS PENDING UTILITY COMPANY FIELD COORDINATION.

7. UNDERGROUND CONDUIT SHALL BE SCHED 40 PVC. ABOVE GRADE CONDUIT SHALL BE RGS. ALL CONDUIT SWEEPS SHALL BE RGS LONG SWEEPS. 8. PROVIDE EXPANSION FITTINGS FOR ALL UNDERGROUND CONDUIT CONNECTED TO FIXED ABOVE GROUND STRUCTURES.

9. PROVIDE A LISTED INTERSYSTEM BONDING TERMINAL AT THE SERVICE ENTRANCE. INSTALL IN ACCORDANCE WITH NFPA 70,250.94

10. REFER TO ONE-LINE DIAGRAM FOR ADDITIONAL INFORMATION.

SYMBOL LEGEND

 S_3S_4 SINGLE POLE SWITCH, 120V, 20A, SPEC GRADE, GROUNDING TYPE, MOUNT 48" AFF, 3=3-WAY,


GROUND FAULT DUPLEX RECEPTACLE 20A, 125V, TAMPER PROOF WITH MATCHING PLATE FURNISHED W/ OUTLET FLUSH MOUNTED 45" AFE EVERD AS NOTED W/ OUTLET. FLUSH MOUNTED 45" AFF EXCEPT AS NOTED.

ELECTRICAL FLOOR PLAN - NEW

MH FIRE ALARM AUDIO/VISUAL, MOUNT 6'-8"AFF, NUMBER DENOTES CANDELA RATING. "MH" DENOTES MINIHORN, "CL" DENOTED CEILING MOUNTED. NO DESIGNATION EQUALS 15cd

F FIRE ALARM PULL STATION, MOUNT 48"AFF


SUFRACE MOUNT 4' LED STRIPLIGHT FIXTURE. COLUMBIA LIGHTING: LCL4-35ML-EU

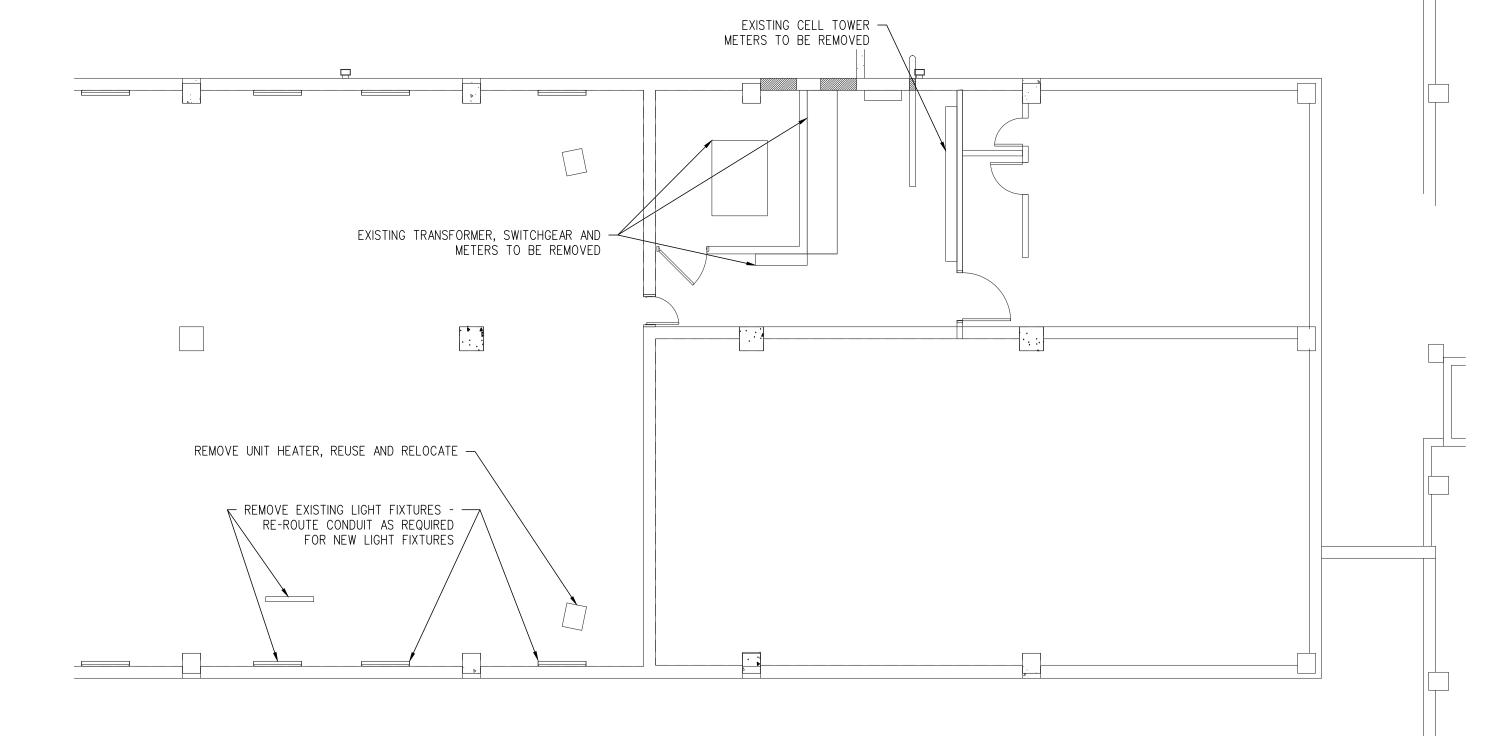



SCALE: 1/8" = 1'-0" (SERVER ROOM DIRECTLY BELOW) LAUNDRY ROOM ─ CRAWL SPACE OPENING IN WALL FOR POSSIBLE CABLE ROUTING TWO STORY SERVER ROOM BELOW OPEN SPACE NEW ELECTRICAL ROOM BELOW -BOILER ROOM

SECOND FLOOR STORAGE ROOM

SCALE: 1/8" = 1'-0"

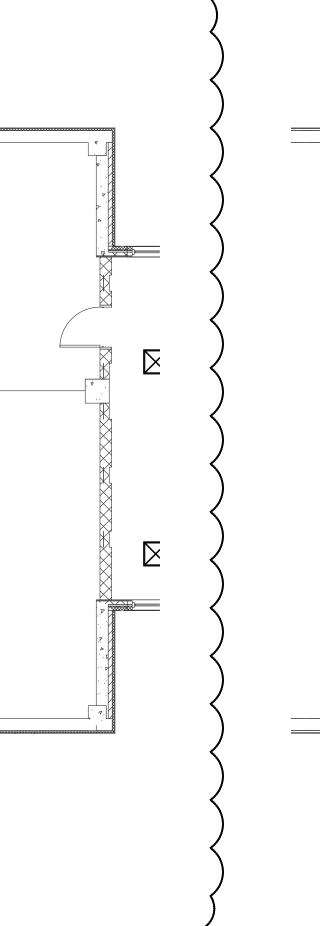

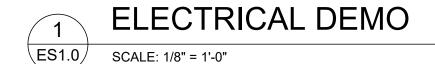

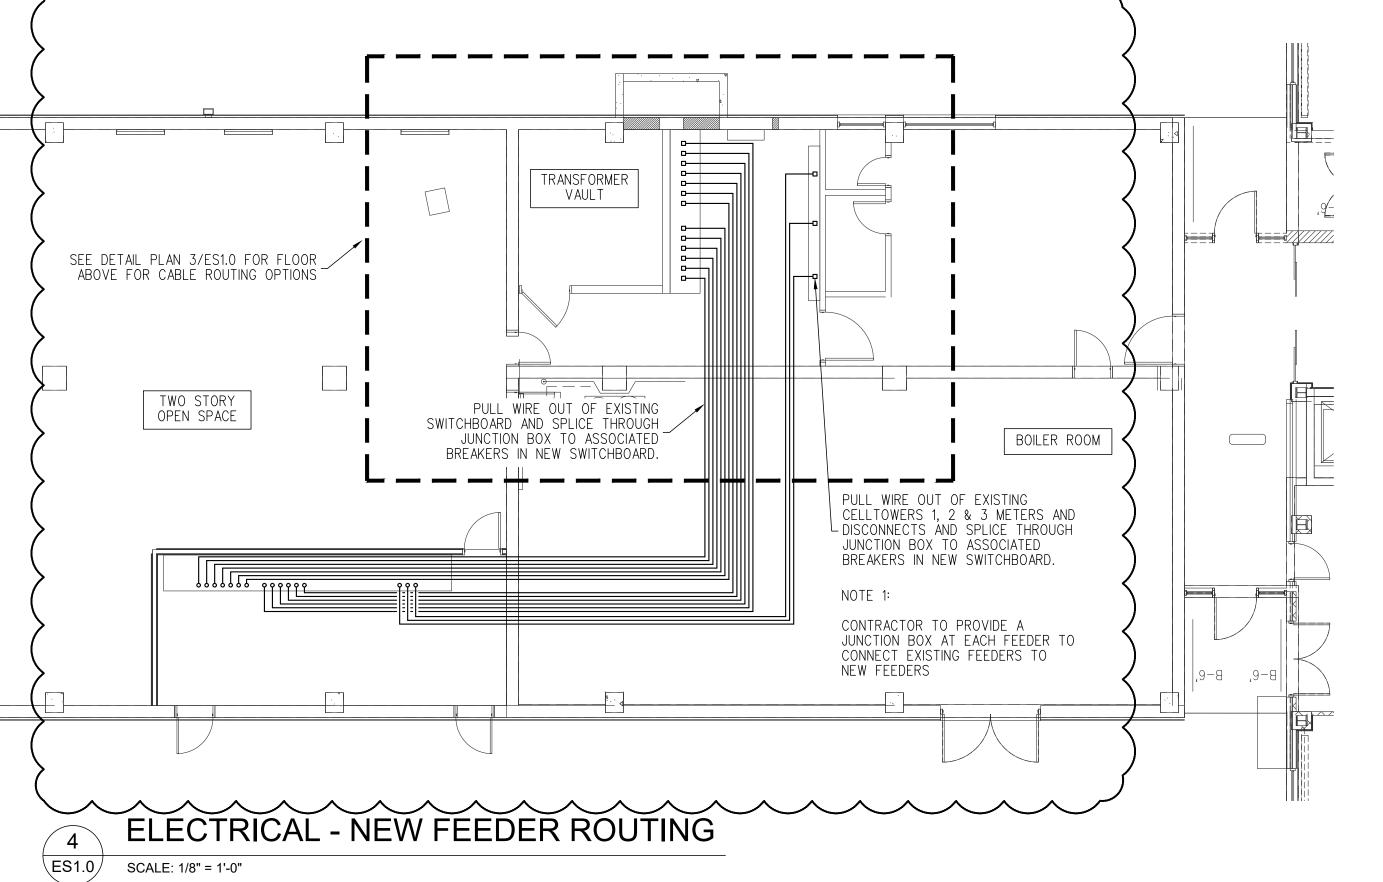

PROJECT NORTH DRAWING NUMBER

DATE: 08/23/2021

CWS ARCHITECTS ARCHITECTURE | INTERIOR DESIGN

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